

PAGE SUMMARY COVER PAGE A00 A01 SITE PLAN A02 SITE ANALYSIS PLAN A03 **WASTE MANAGEMENT PLAN** A03 SEDIMENT CONTROL PLAN A04 LANDSCAPE PLAN A05 GROUND FLOOR PLAN EXISTING A06 GROUND FLOOR PLAN PROPOSED A07 FIRST FLOOR PLAN EXISTING 80A FIRST FLOOR PLAN PROPOSED A09 NORTH ELEVATION EXISTING & PROPOSED A10 EAST ELEVATION EXISTING EAST ELEVATION PROPOSED A11 A12 SOUTH ELEVATION EXISTING & PROPOSED A13 WEST ELEVATION EXISTING A14 WEST ELEVATION PROPOSED SECTION A-A A15 SECTION B-B & C-C A16 A17 SHADOW DIAGRAM 9.00am SHADOW DIAGRAM 12.00noon A18 A19 SHADOW DIAGRAM 3.00pm

1 COTENTIN ROAD BELROSE



NOTES:

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DRAWING TITLE: **COVER PAGE** SHOWING: 3D VIEW AND PAGE LIST

PROJECT: 1 COTENTIN ROAD BELROSE LOT 1 DP237435


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A00

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24/02/2020





SITE FENCING

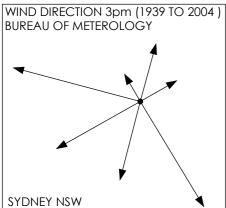Temporary fencing to be maintained throughout

at building line SITE SIGNAGE

BUILDERS SIGN

To be in place for the duration of works

CERIFIERS SIGN

To be in place for the duration of works

ALL RELEVANT SAFETY SIGNS

To be in place for the duration of works

BIN


Bin to be placed on driveway

DEMOLITION

Rear of building to be hand demolition sorted in year yard and placed in appropriate recycling bins

CONCRETE

A small trailor pump will be placed on the drive and small concrete truck used on drive. All works will be within the property boundaries.

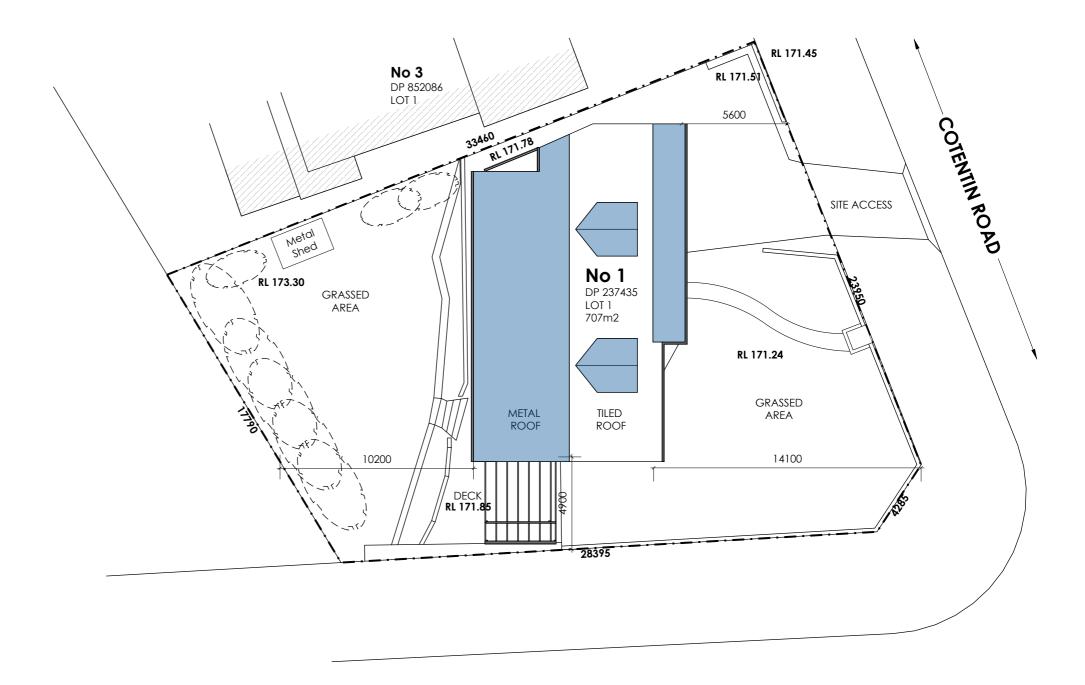

RALSTON AVENUE —

SITE PLAN



PROPOSED EXTENSION

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DRAWING TITLE: SITE PLAN SHOWING: ALTERATIONS AND ADDITIONS

SEDIMENT CONTROL

DIRECTION

OF FLOW

ENTERS AND LEAVES PROPERTY

FROM EROSION.

PROJECT: 1 COTENTIN ROAD BELROSE

INSTALL SEDIMENT CONTROL MEASURES AS INDICATED ON PLAN. DURING ALL EXCAVTION UNTIL AREAS AFFECTED ARE PROTECTED

SEDIMENT BAGS TO BE PLACED IN KERB BEFORE ECAVATION MACHINE

GEOTEXTILE FILTER

A01

POSTS 600mm ABOVE G.L.

FABRIC

UNDISTURBED AREA


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LOT 1 DP237435

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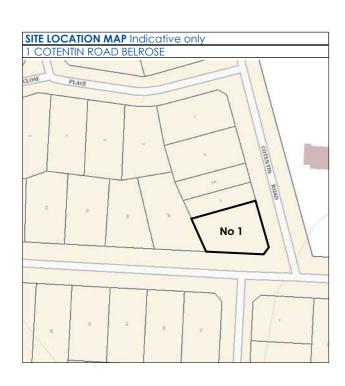
24/02/2020


ON SITE.



COTENTIN ROAD

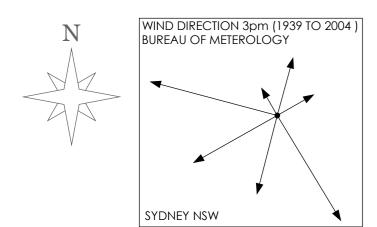This is a quite residential street running North South with some through traffic.
The block is a corner block with the secondary frontage being Ralston Avenue.



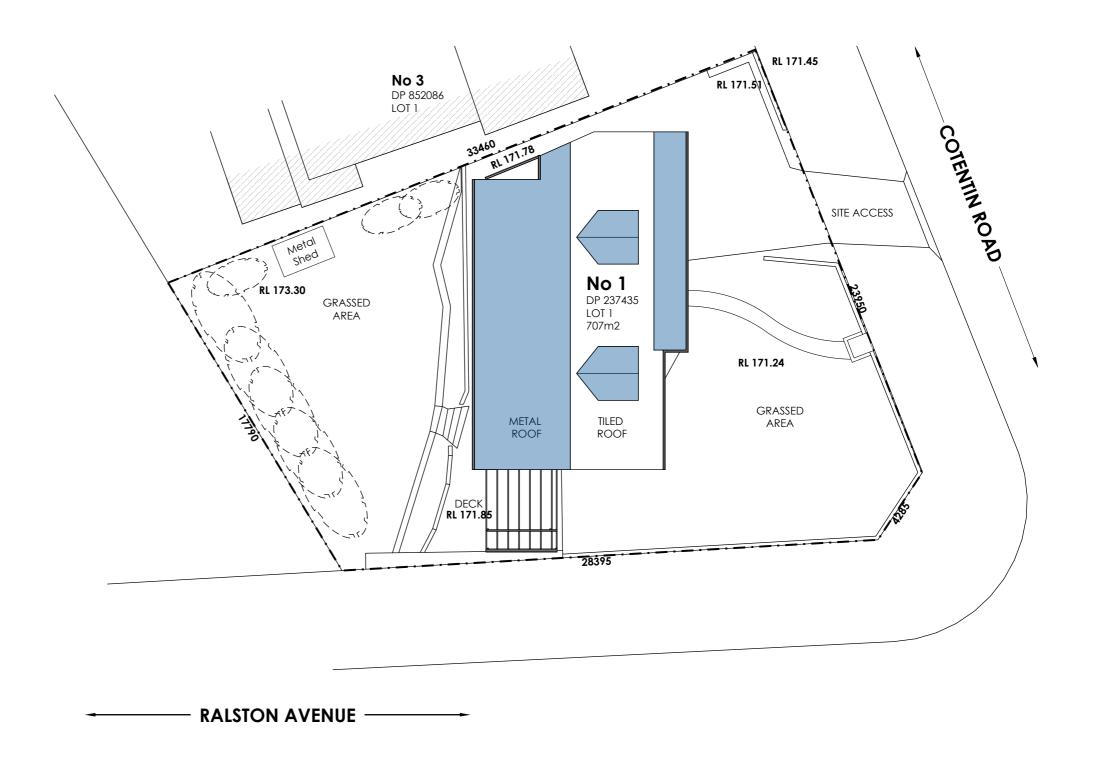

SITE ANALYSIS PLAN: 1 COTENTIN ROAD BELROSE



PROPOSED EXTENSION

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NOTES:

DRAWING TITLE: **SITE ANALYSIS PLAN** SHOWING: SITE INFORMATION

PROJECT: 1 COTENTIN ROAD BELROSE LOT 1 DP237435


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A02

OT SCALE DRAWING.

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RALSTON AVENUE —

WASTE MANAGEMENT PLAN: 1 COTENTIN ROAD BELROSE **SEDIMENT CONTROL PLAN: 1 COTENTIN ROAD BELROSE**

PROPOSED EXTENSION

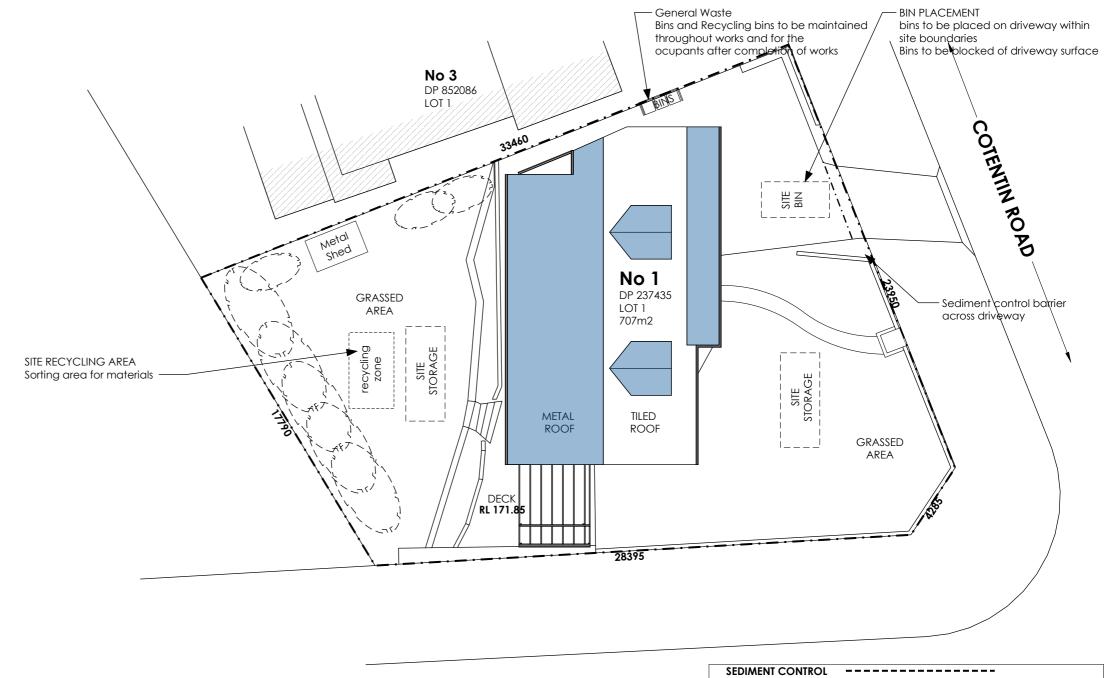

NOTES:

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INSTALL SEDIMENT CONTROL MEASURES AS INDICATED ON PLAN. DURING ALL EXCAVTION UNTIL AREAS AFFECTED ARE PROTECTED FROM EROSION. SEDIMENT BAGS TO BE PLACED IN KERB BEFORE ECAVATION MACHINE ENTERS AND LEAVES PROPERTY DIRECTION GEOTEXTILE FILTER OF FLOW FABRIC POSTS 600mm ABOVE G.L. UNDISTURBED AREA FILTER BAGS ------PLACED ACROSS DRIVEWAY DURING EXCAVTION TILL PLACEMENT OF CONCRETE

DRAWING TITLE: WASTE MANAGEMENT PLAN SHOWING: SITE INFORMATION


PROJECT: 1 COTENTIN ROAD BELROSE LOT 1 DP237435

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A03

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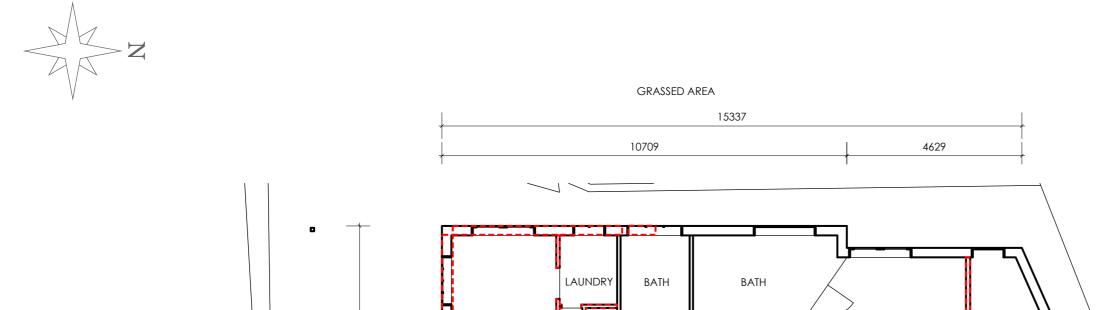


SCHEDULE OF AREAS	EXISTING	PROPOSED	COMPLIES
SITE AREA	707.00		YES
Landscaping garden		373.3	YES

LANDSCAPE PLAN: 1 COTENTIN ROAD BELROSE

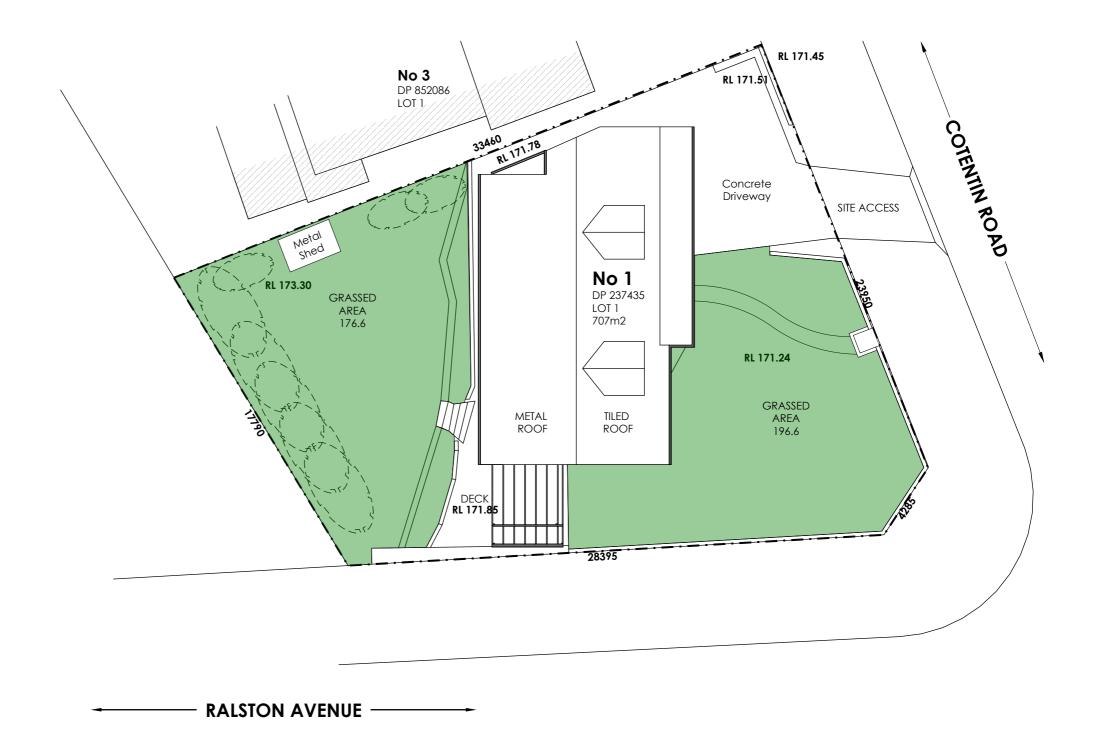





KITCHEN

DININGROOM

HALL

RL 171.95

PATIO

GRASSED & GARDEN AREA 17618 PLAN VIEW EXISTING DEMOLITION PLAN



DEMOLITION PLAN

IN ACCORDANCE WITH AS 2601-2001 THE DEMOLITION OF STRUCTURES

REMOVE WALLS, ROOF AND FLOOR AS INDICATED ON PLAN CUT NEW DOOR OPENING POSITION FOR STAIRWELL TRIM LEVELS FOR NEW LOWER DECK SLAB DIG FOOTINGS TO ENGINEERS DESIGN CUT NEW DOOR OPENINGS AS MARKED INFILL WINDOW OPENINGS AS MARKED

PROPOSED DEMOLITION

BED1

LIVINGROOM

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GARAGE

RL 171.50

DRAWING TITLE: PLAN VIEW


SHOWING: EXISTING & PROPOSED DEMOLITION

PROJECT: 1 COTENTIN ROAD BELROSE LOT 1 DP237435

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A05

SCALE 1:100 24/02/2020

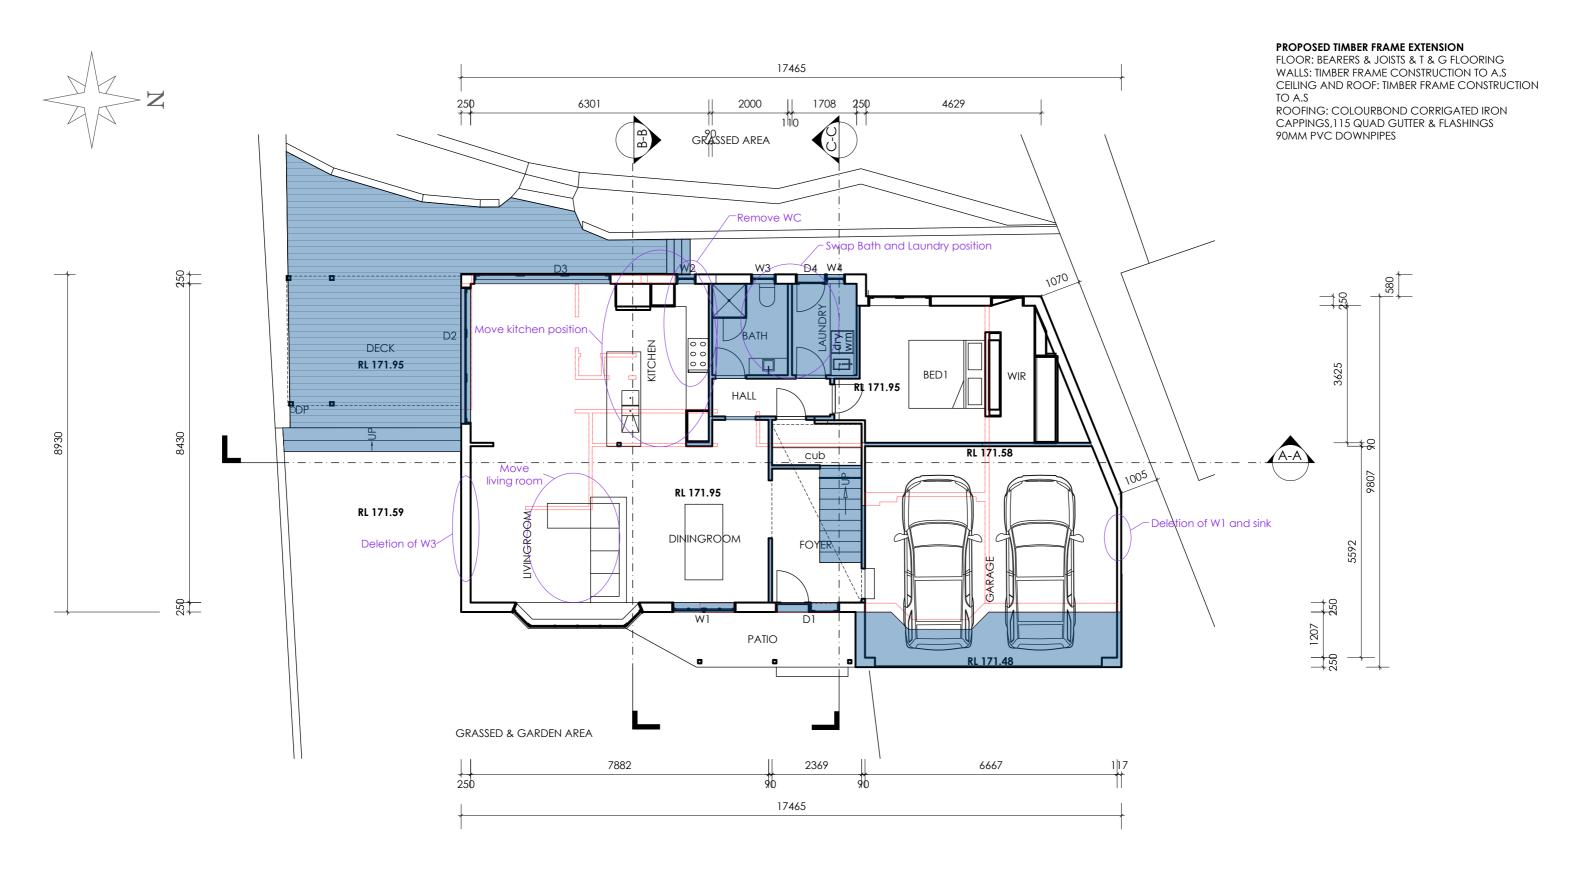

PLAN VIEW PROPOSED GROUND FLOOR EXTENSION



GENERAL:

BUILD NEW TIMBER FRAME WALLS IN 90 BY 45 H2 MPG10 PINE TO A.S LINE WALLS IN 10mm GYPROCK & VILLABOARD TO BATHROOM AND LAUNDRY WALLS WATER PROOF BATHROOM AND LAUNDRY TO A.S

 $_{\oplus}^{\mathsf{SA}}$ smoke alarm to as

HW INSTATANIOUS HOT WATER SYSTEM

NOTES:

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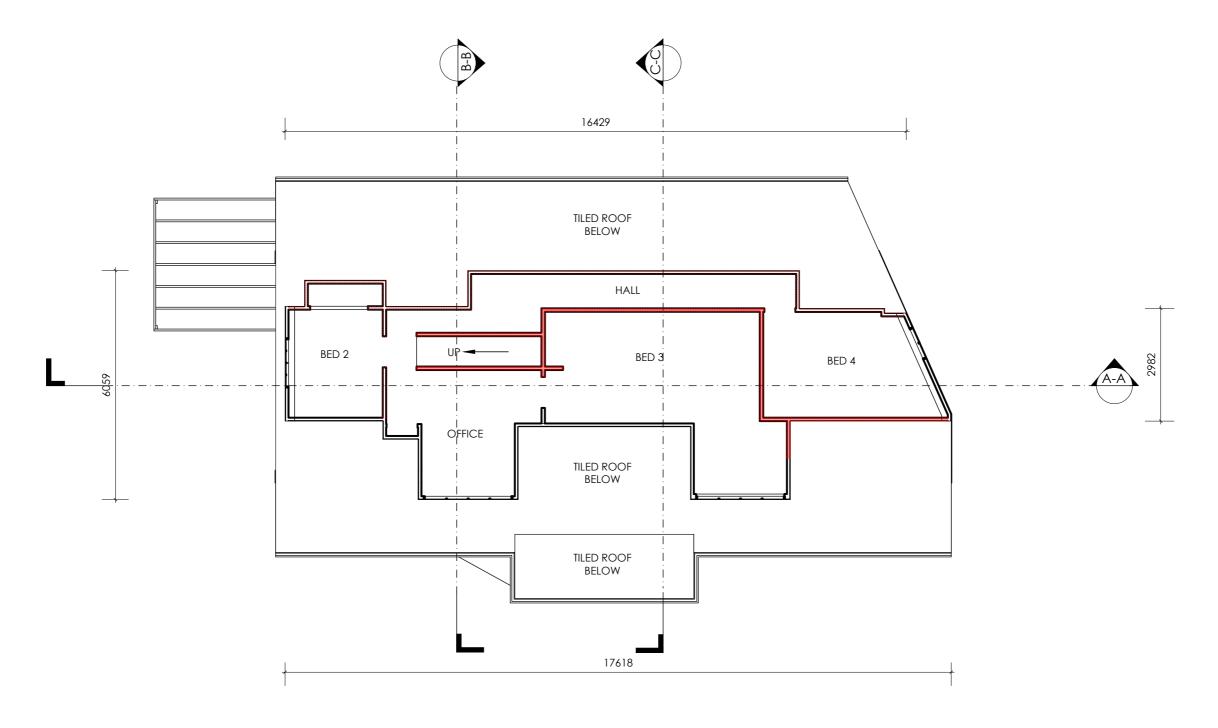
DRAWING TITLE: PLAN VIEW SHOWING: PROPOSED GROUND FLOOR

PROJECT: 1 COTENTIN ROAD BELROSE LOT 1 DP237435

A06

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PLAN VIEW EXISTING



GENERAL:

BUILD NEW TIMBER FRAME WALLS
IN 90 BY 45 H2 MPG 10 PINE
TO A.S
LINE IN 10mm GYPROCK & VILLABOARD
TO BATHROOMAND LAUNDRY WALLS
WATER PROOF BATHROOM AND LAUNDRY TO A.S

 $^{\mathsf{SA}}_{\oplus}$ hardwired interconnected smoke alarm to as

NOTES:

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DRAWING TITLE: PLAN VIEW

SHOWING: EXISTING FIRST FLOOR EXTENSION


PROJECT: 1 COTENTIN ROAD BELROSE
LOT 1 DP237435

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A07

24/02/2020 SCALE:1:100



PLAN VIEW PROPOSED

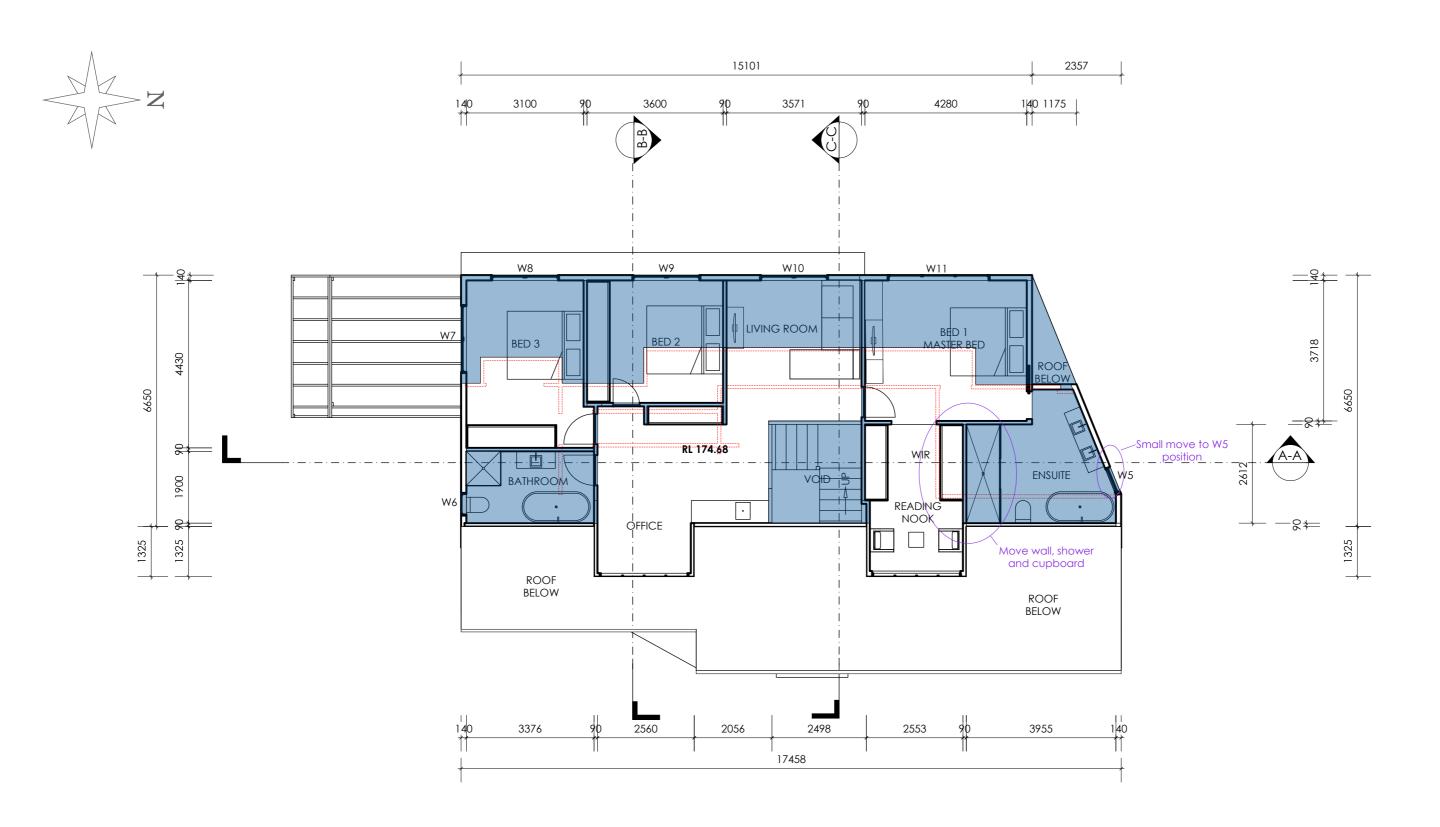

GENERAL:

BUILD NEW TIMBER FRAME WALLS
IN 90 BY 45 H2 MPG 10 PINE
TO A.S
LINE IN 10mm GYPROCK & VILLABOARD
TO BATHROOMAND LAUNDRY WALLS
WATER PROOF BATHROOM AND LAUNDRY TO A.S

 $^{\mathsf{SA}}_{\oplus}$ hardwired interconnected smoke alarm to as

NOTES:

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DRAWING TITLE: **PLAN VIEW** SHOWING: PROPOSED FIRST FLOOR EXTENSION


SHOWING. FROM GSED FIRST FEGOR EXTENSION

PROJECT: 1 COTENTIN ROAD BELROSE LOT 1 DP237435

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80A

24/02/2020 SCALE:1:100

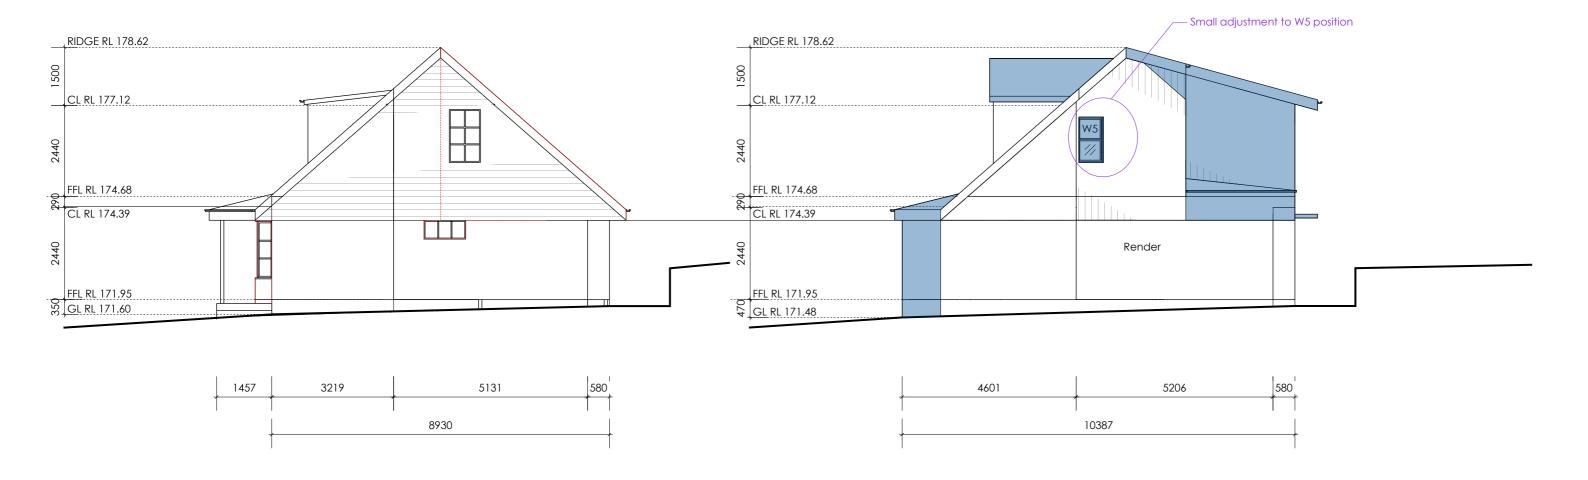

NORTH ELEVATION EXISTING IN ACCORDANCE WITH AS 2601-2001 THE DEMOLITION OF STRUCTURES

NORTH ELEVATION PROPOSED



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SHOWING, EXISTING AND I KOLOSED		RAWING TITLE: NORTH ELEVATION OWING: EXISTING AND PROPOSED
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PROJECT: 1 COTENTIN ROAD BELROSE LOT 1 DP237435

A09

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SCALE:1:100



EAST ELEVATION EXISTING DEMOLITION PLAN



HW: instantanious hot water unit

NOTES:

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DRAWING TITLE: **EAST ELEVATION** SHOWING: EXISTING BUILDING & SCOPE OF DEMOLITION PROJECT: 1 COTENTIN ROAD BELROSE

LOT 1 DP237435


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24/02/2020

SCALE:1:100

BASIX CERTIFICATE	CERTIFICATE NUMBER A332237_03	
LIGHTING		
40% OF NEW OR ALTERED LIGHT FIXTURES ARE FLUORESCENT, COMPACT FLUORESCENT, OR LED		
FIXTURES		
NEW OR ALTERED SHOWERHEADS: 9L PER MINUTE OR 3 STAR RATING		
NEW OR ALTERED TOILETS: 4L PER FLUSH OR 3 STAR RATING		
NEW OR ALTERED TAPS: 9L PER MINUTE OR 3 STAR RATING		
CONSTRUCTION	ADDITIONAL INSULATION REQUIRED (R-VALUE)	OTHER SPECIFICATIONS
Concrete slab on ground	Nil	
Suspended floor above garage:framed (R0.7)	Nil	
Floor above existing dwelling	Nil	
External wall: framed weatherboard	R1.30 (or R1.70 including construction)	
Flat ceiling, pitched roof	Ceiling: R1.45 (up), roof: 55mm foil blanket	dark (solar absorptance > 0.70)



EAST ELEVATION PROPOSED

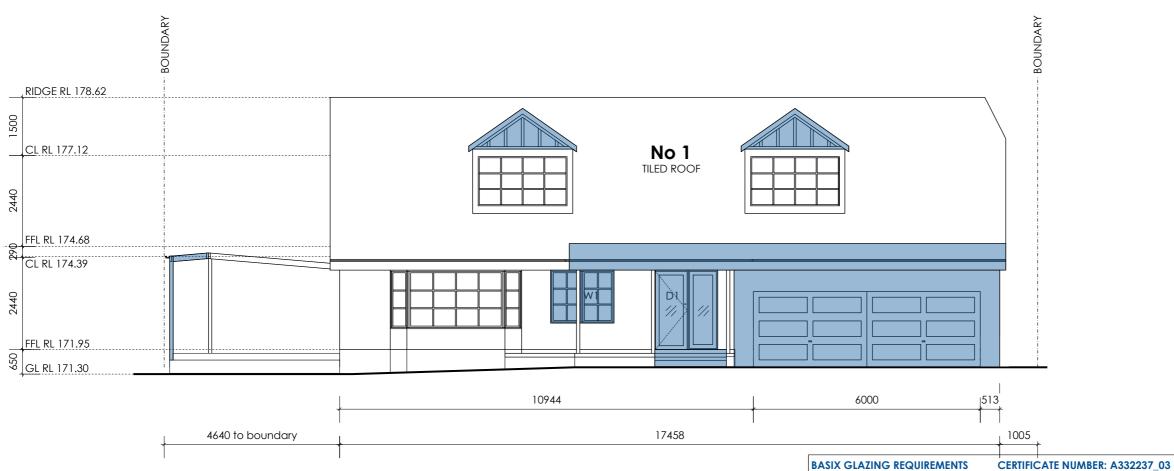

N	OT	ES:
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W & D ORIENT m2

W

W

W

W1

W2

W3

W4

W5

W6

W8

W11

W10 W

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SHADING

2.34 Eave/>=900mm

P/H >= 0.43

2.16 Eave/>=750mm

2.16 Eave/>=750mm

3.24 | Eave/>=750mm

Eave/>=750mm

Eave/>=900mm

0.42 P/H >=0.43

0.84 None

2.16 None

6.93 None

9.45 P/H >=0.43

1.68 P/H >=0.43

P/H >=0.43

DRAWING TITLE: **EAST ELEVATION** SHOWING: ALTERATIONS AND ADDITIONS

OVERSHADOWING FRAME AND GLASS TYPE

PROJECT: 1 COTENTIN ROAD BELROSE LOT 1 DP237435

A11

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Improved aluminium, clear/airgap/clear or (U4.12, SHGC 0.66)

Timber or uPVC, clear/air/clear, (U3.67, SHGC 0.59)

Improved aluminium, single clear or (U6.44, SHGC 0.75)

Timber or uPVC, clear/air/clear, (U3.67, SHGC 0.59)

DEMOLITION

IN ACCORDANCE WITH AS 2601-2001 THE DEMOLITION OF STRUCTURES


Machine only needed for minor trim and edge thicknings to slab area


Bin to be placed after entry for spoil

DEMOLITION

Rear of building to be hand demolition sorted in rear yard and placed in appropriate recycling bins

A small trailor pump will be placed on the drive and small concrete truck used on drive. All works will be within the property boundaries.

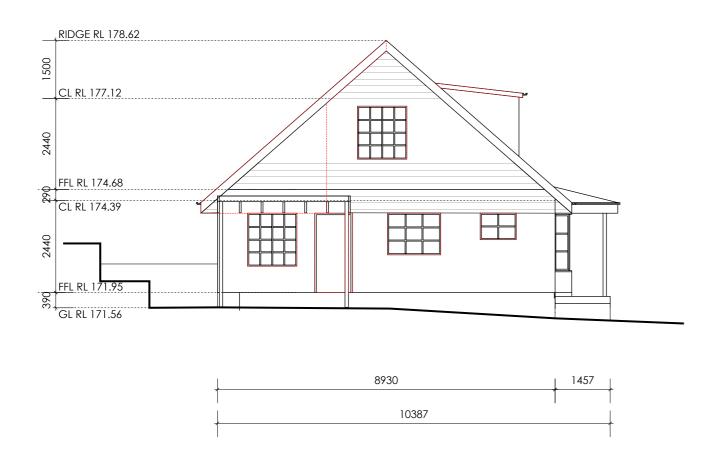

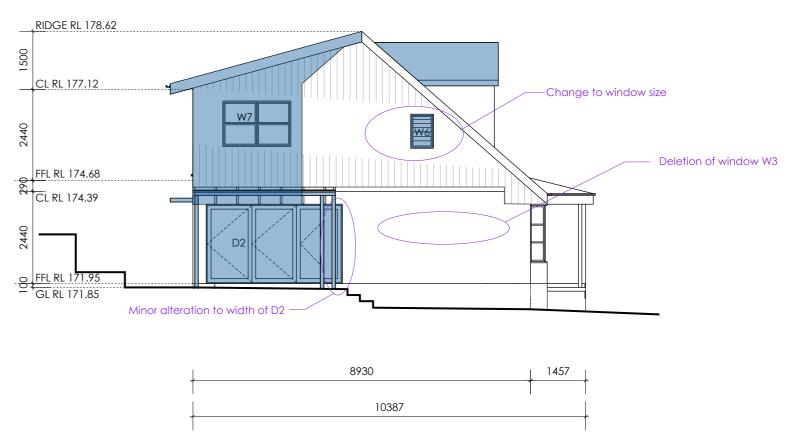

SOUTH ELEVATION EXISTING DEMOLITION PLAN

SOUTH ELEVATION PROPOSED



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DRAWING TITLE: SOUTH ELEVATION SHOWING: EXISTING WITH DEMOLITION & PROPOSED PROJECT: 1 COTENTIN ROAD BELROSE

LOT 1 DP237435

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A12

DEMOLITION

IN ACCORDANCE WITH AS 2601-2001

THE DEMOLITION OF STRUCTURES

BIN

Machine only needed for minor trim and edge thicknings to slab area


Bin to be placed after entry for spoil

DEMOLITION

Rear of building to be hand demolition sorted in year yard and placed in appropriate recycling bins

CONCRETE

A small trailor pump will be placed on the drive and small concrete truck used on drive. All works will be within the property boundaries.

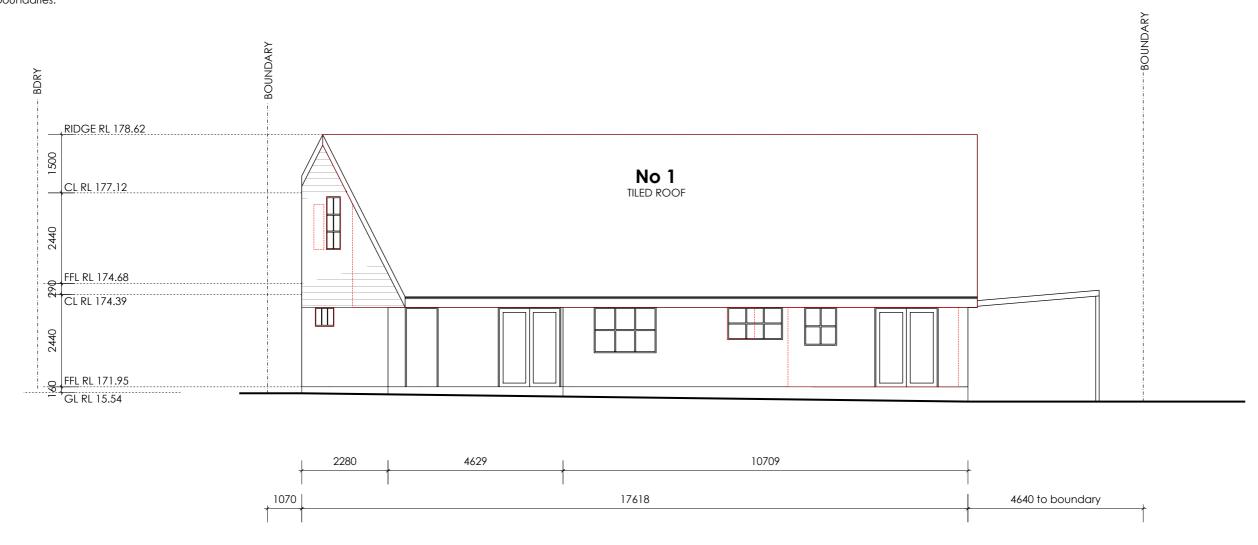

WEST ELEVATION EXISTING DEMOLITION PLAN



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DRAWING TITLE:	WEST ELEVATION
SHOWING: EXISTIN	NG & DEMOLITION

PROJECT: 1 COTENTIN ROAD BELROSE LOT 1 DP237435

A13

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ROOFING

'COLOURBOND' METAL ROOFING, CAPPINGS AND FLASHINGS STANDARD 115 QUAD GUTTER 90mm PVC DOWNPIPE

PROPOSED EXTENSION FRAMING

TIMBER FRAME TO A.S 1684.2-2010
RESIDENTIAL TIMBER FRAMED
CONSTRUCTION
WALL FRAME
H2/T2 90 BY 45 MPG10 STUDS NOGGINS AND PLATES
ROOF FRAME
H2/T2 200 BY 45 LVL RAFTERS & CEILING JOISTS
22mm LSOP FASCIA BOARD



WEST ELEVATION PROPOSED



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DRAWING TITLE: **WEST ELEVATION** SHOWING: ALTERATIONS AND ADDITIONS

PROJECT: 1 COTENTIN ROAD BELROSE
LOT 1 DP237435

A14

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SCALE:1:100



SECTION A-A SCALE1:100



TIMBER FRAME TO A.S 1684.2 -2010 RESIDENTIAL TIMBER FRAMED CONSTRUCTION TIMBER FRAME H2 MINIMUM TREATMENT CONCRETE TO ENGINEERS DESIGN LVL BEAMS, RAFTERS & LINTEL SPANS TO BE PROVIDED

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DRAWING TITLE: SECTION A-A

WALL FRAMES

Concrete

90 BY 45 H2 STUDS @ 600c

Eaves 4.5mm fibro, H mold 19 LOSP fascia board

Raft slab to engineers design

90 BY 45 H2 NOGGINS @ 1.200c MAX 90 BY 45 H2 PLATES/ 2 TOP 1 BOTTOM **EXTERIOR WALLS CLAD IN Weathertex**

Insulation and sarking to BASIX requirements

Blob and strip footing to engineers design

T2 pine 19 by 45 wall batten between sarking and cladding

Tie down and bracing to AS NCC and BCA requirements

SHOWING: SECTION CUT OF PROPOSED EXTENSION


PROJECT: 1 COTENTIN ROAD BELROSE


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SECTION B-B SCALE1:100





TIMBER FRAME TO A.S 1684.2 -2010 RESIDENTIAL TIMBER FRAMED CONSTRUCTION TIMBER FRAME H2 MINIMUM TREATMENT CONCRETE TO ENGINEERS DESIGN LVL BEAMS, RAFTERS & LINTEL SPANS TO BE PROVIDED
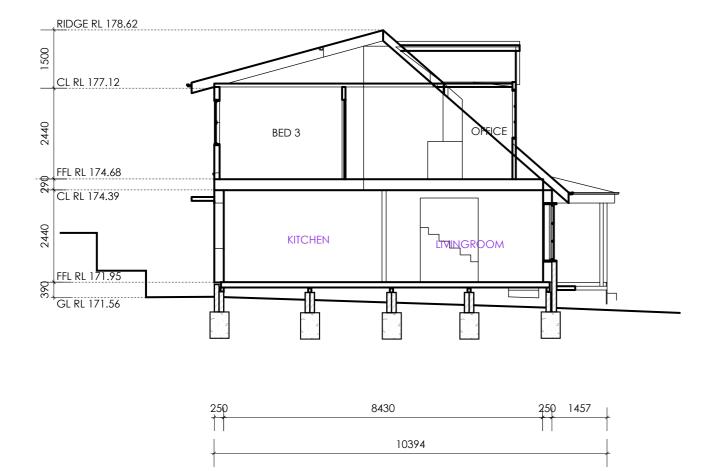
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DRAWING TITLE: SECTION B-B, C-C SHOWING: SECTION CUT OF PROPOSED EXTENSION

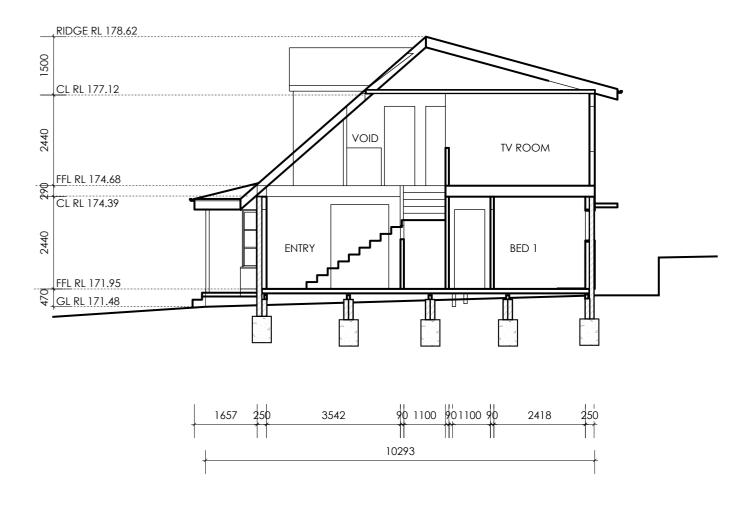
PROJECT: 1 COTENTIN ROAD BELROSE


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A16

SCALE:1:100 & 1:50 24/02/2020



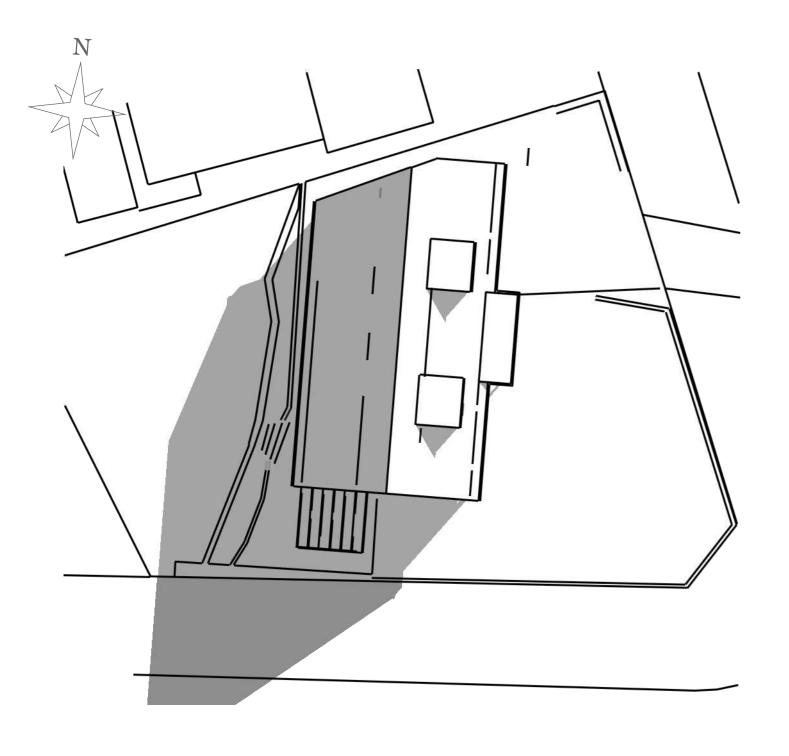

EXISTING 9.00am

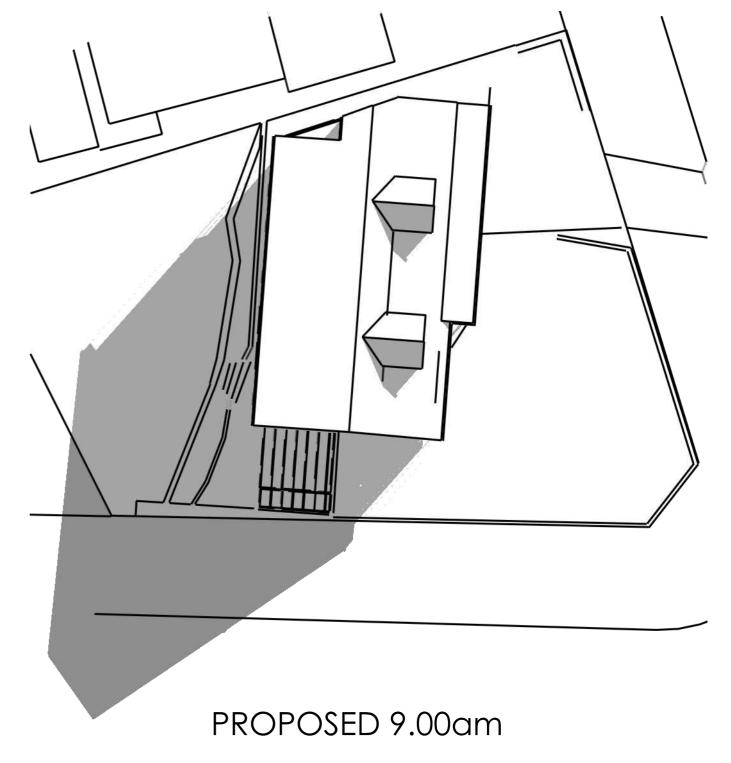SHADOW DIAGRAM A: June 22nd 9.00am



TIMBER FRAME TO A.S 1684.2-2010
RESIDENTIAL TIMBER FRAMED CONSTRUCTION TIMBER FRAME H2 MINIMUM TREATMENT CONCRETE TO ENGINEERS DESIGN LVL BEAMS, RAFTERS & LINTEL SPANS TO BE PROVIDED


NOTES:
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DRAWING TITLE:	SHADOW DIAGRAM
SHOWING: 9.00A	m existing & proposed

PROJECT: 1 COTENTIN ROAD BELROSE LOT 1 DP237435

A17

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24/02/2020	SCALE:1:100 & 1:50

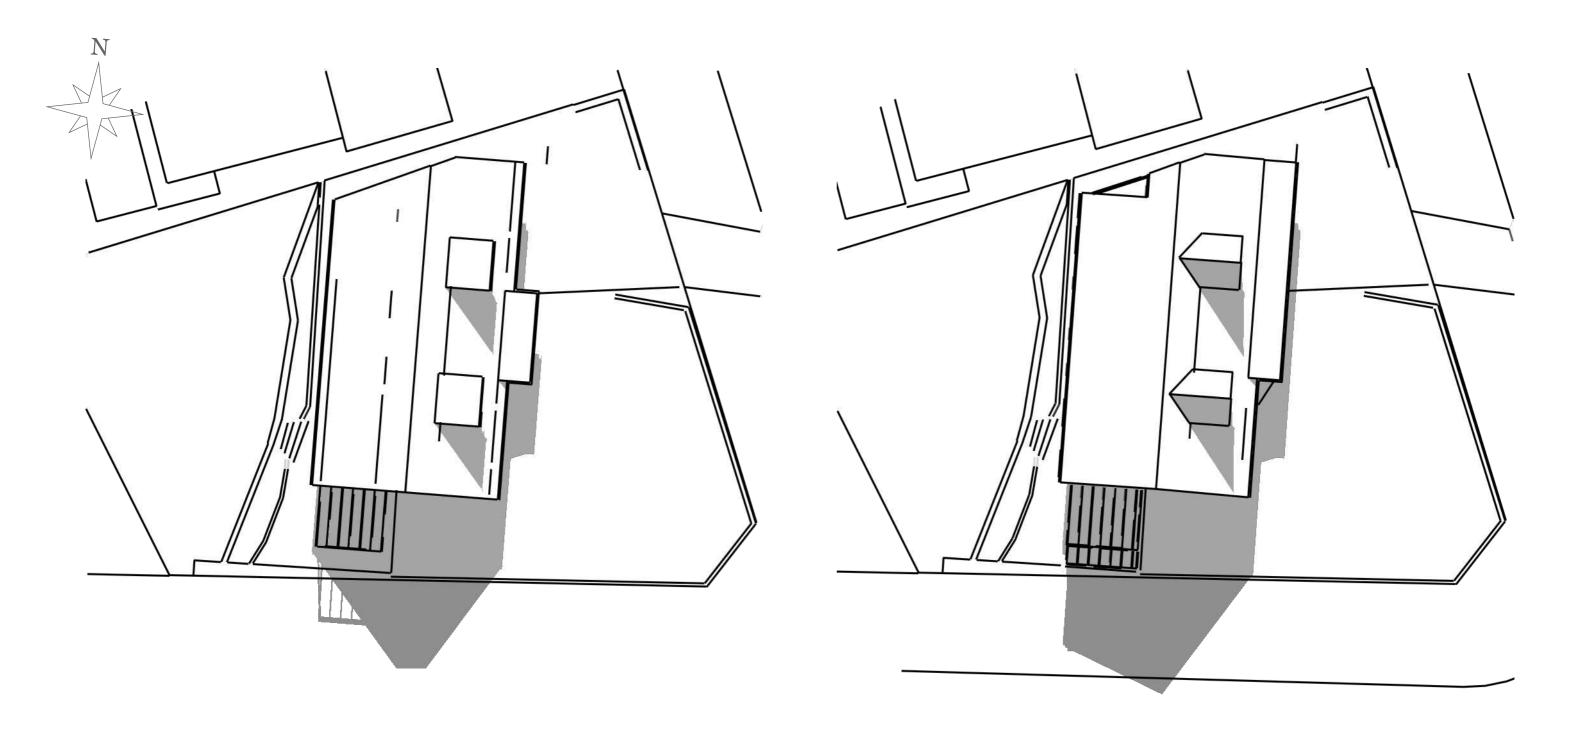

EXISTING 12.00 noon

PROPOSED 12.00 noon

SHADOW DIAGRAM B: June 22nd 12.00 noon



GENERAL

TIMBER FRAME TO A.S 1684.2 - 2010
RESIDENTIAL TIMBER FRAMED CONSTRUCTION
TIMBER FRAME H2 MINIMUM TREATMENT
CONCRETE TO ENGINEERS DESIGN
LVL BEAMS, RAFTERS & LINTEL SPANS TO BE PROVIDED

NOTES:

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DRAWING TITLE: **SHADOW DIAGRAM** SHOWING: 12.00 NOON EXISTING & PROPOSED

PROJECT: 1 COTENTIN ROAD BELROSE LOT 1 DP237435


KATHERINE & STUART ARDLIE


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A18

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24/02/2020 SCALE:1:100 & 1:50



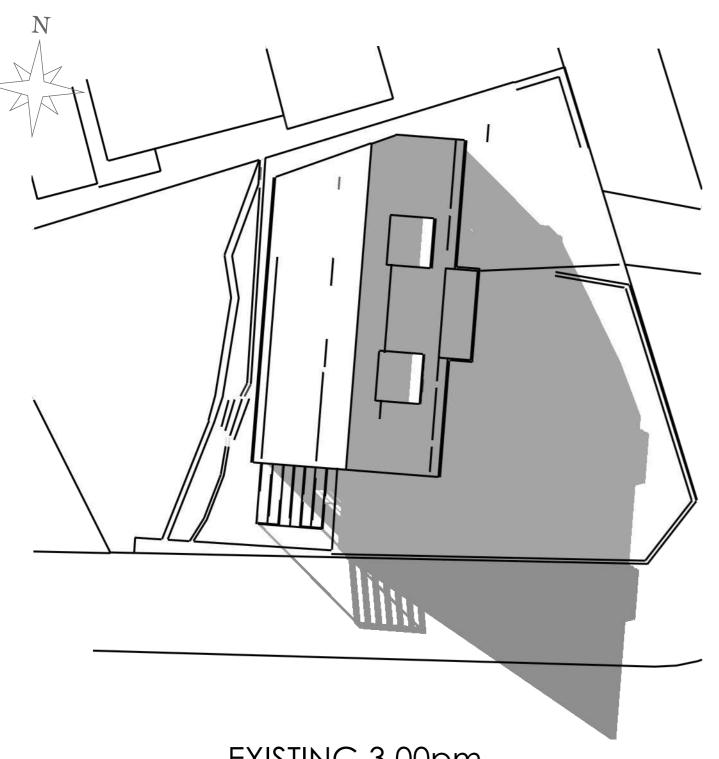

EXISTING 3.00pm

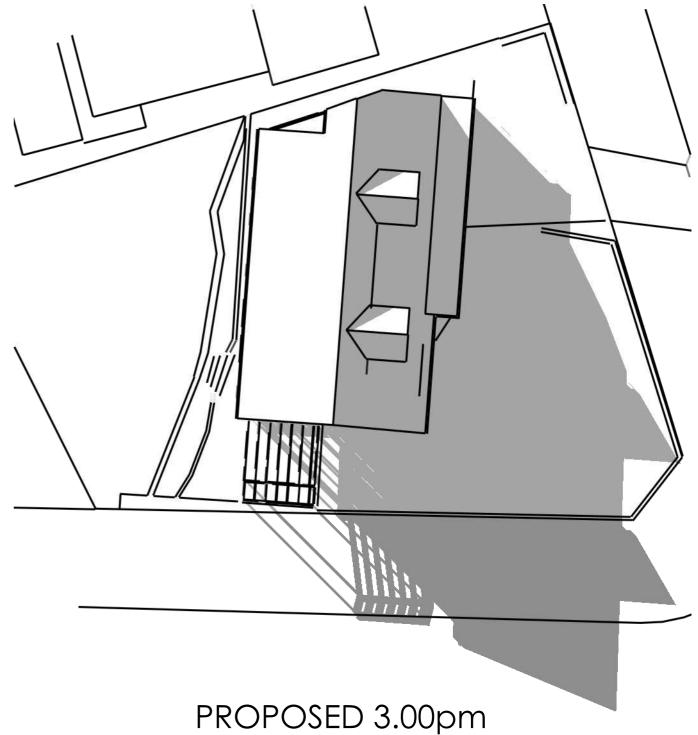SHADOW DIAGRAM C: June 22nd 3.00pm



TIMBER FRAME TO A.S 1684.2 -2010
RESIDENTIAL TIMBER FRAMED CONSTRUCTION TIMBER FRAME H2 MINIMUM TREATMENT CONCRETE TO ENGINEERS DESIGN LVL BEAMS, RAFTERS & LINTEL SPANS TO BE PROVIDED

NOTES:
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DRAWING TITLE:	SHADOW DIAGRAM
SHOWING: 3.00P/	M EXISTING & PROPOSED

PROJECT: 1 COTENTIN ROAD BELROSE LOT 1 DP237435

A19

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SCALE:1:100 & 1:50 24/02/2020