ITEM DETAILS	DEVELOPMENT APPLICATION					
ADDRESS	14 ERNEST STREET BALGOWLAH HEIGHTS NSW 2093					
LOT & DP	LOT 15A DP31138					
LOCAL GOVERNMENT AREA	NORTHERN BEACHES COUNCIL (MANLY)					
SITE AREA	875.3m ²					
FRONTAGE	15.24m					
CONTROLS	PERMISSABLE / REQUIRED	EXISTING	PROPOSED	COMPLIANCE		
LEP						
LAND ZONING	R2-LOW DENSITY RESIDENTIAL	R2	R2	YES		
MINIMUM LOT SIZE	500m ²	875.3m ²	UNCHANGED	YES		
FLOOR SPACE RATIO	0.45 : 1 (393.9m ²)	0.16 : 1 (142.4m ²)		YES		
MAXIMUM BUILDING HEIGHT	8.5m	6.1m		YES		
HAZARDS						
	NOT IDENTIFIED					
DCP						
RESIDENTIAL OPEN SPACE	AREA OS3					
TOTAL OPEN SPACE (TOS)	55% (481.4m ²)	50.4% (441.5m ²)		YES		
LANDSCAPE AREA	35% OF TOS (168.5m ²)	84.1% (405.1m ²)		YES		
OPEN SPACE ABOVE GROUND	MAX. 40% OF TOS (192.6m ²)	6.4% (30.9m ²)		YES		
PRINCIPAL PRIVATE OPEN SPACE	18m ²	28.9m ²		YES		
FRONT SETBACK	PREVAILING BUILDING LINE 12.8m	10.6m		YES		
REAR SETBACK	8.0m	28.8m		YES		
SIDE SETBACKS	1/3 WALL HEIGHT (SEE DRAWINGS)			YES		
PARKING SPACES	REQUIRED: 1	1	2	YES		



DEVELOPMENT APPLICATION MARTIN RESIDENCE

		DRAWING SCHEDULE		
	DRG #	DRAWING NAME	REVISION	SCALE
000 P	reliminaries			
DA	000	COVER PAGE	02	
DA	001	SITE ANALYSIS	03	
DA	002	SITE PLAN	03	1:10
010 D	emolition Pla	ins		
DA	011	DEMOLITION PLAN - LOWER GROUND FLOOR	01	1:5
DA	012	DEMOLITION PLAN - GROUND FLOOR	01	1:5
DA	013	DEMOLITION PLAN - EXISTING ROOF	01	1:5
100 G	A Plans			
DA	101	FLOOR PLAN - LOWER GROUND FLOOR	01	1:5
DA	102	FLOOR PLAN - GROUND FLOOR	01	1:5
DA	103	FLOOR PLAN - FIRST FLOOR	01	1:5
DA	104	FLOOR PLAN - ROOF	01	1:5
300 E	levations			
DA	301	ELEVATIONS - SHEET 1	01	1:5
DA	302	ELEVATIONS - SHEET 2	01	1:5
350 S	ections			
DA	351	SECTIONS - SHEET 1	01	1:5
DA	352	SECTIONS - SHEET 2	01	1:5
DA	353	SECTIONS - SHEET 3	01	1:5
750 N	liscellaneous	Drawings		
DA	751	SUN SHADOW DIAGRAMS - SHEET 1	02	1:10
DA	752	SUN SHADOW DIAGRAMS - SHEET 2	02	1:10
DA	753	SUN SHADOW DIAGRAMS - SHEET 3	02	1:10
DA	754	SUN SHADOW DIAGRAM - NEIGHBOURS	02	
DA	755	FINISHES SAMPLE BOARD	01	
DA	756	BASIX COMMITMENTS	01	
DA	757	3D BUILDING CONTROL VIEWS	01	
DA	758	NOTIFICATION	01	



COVER PAGE
Status
SKETCH DESIGN


Drawing Title





STREETSCAPE VIEW OF 14 ERNEST STREET FROM THE WEST

GENERAL NOTES:				DRAWING NOTES:
Do not scale from this drawing. Use figured				
dimensions only.				
For any discrepancies in documentation contact 3D				
Habitat for clarifications if required.	——		<u> </u>	
3D Habitat holds no liability for any loss, damage,			<u> </u>	
claim or cost demand as a result of the use or	——		<u> </u>	
receipt of drawings issued in DWG or PDF format.	——		<u> </u>	
PRIOR TO USE FOR BUILDING CONSTRUCTION	03	DA REVISION	14/03/22	
THE BUILDER MUST ENSURE THEY ARE IN	02	ADDRESSES ON STREETSCAPE CORRECTED	31/01/22	
POSSESSION OF A CC AND ALL OTHER	01	DEVELOPMENT APPLICATION	03/12/21	
REQUIRED COUNCIL APPROVALS	Rev	Change Name	Date	

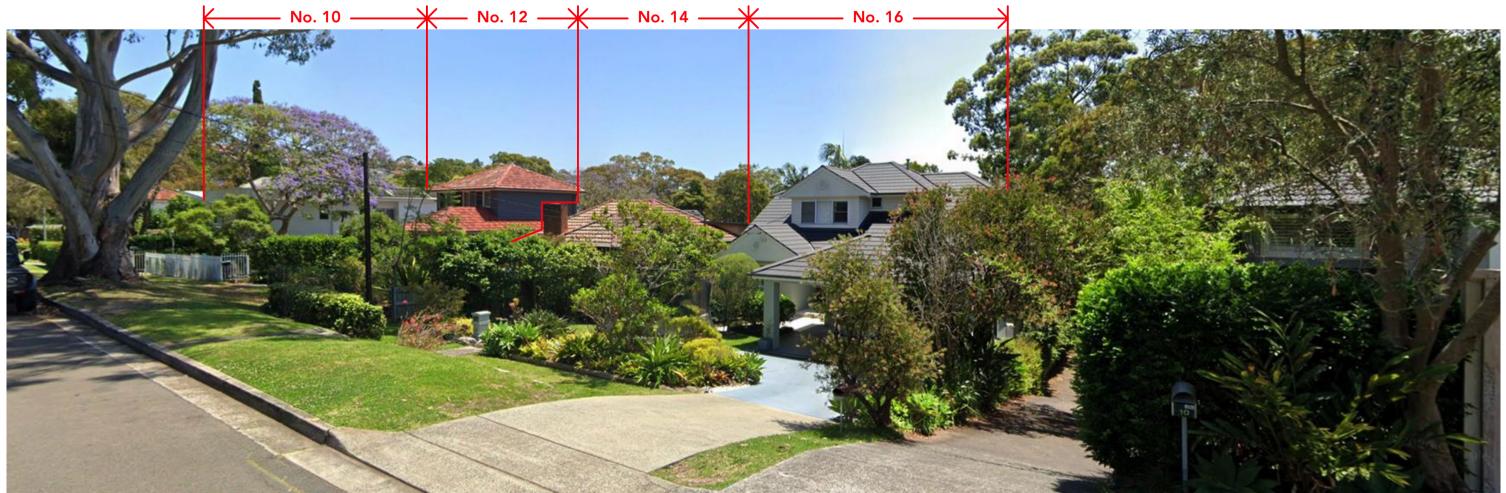

STREETSCAPE VIEW OF 14 ERNEST STREET FROM THE EAST




Client 14 ERNEST STREET BALGOWLAH HEIGHTS, NSW 2093

ct No MARTIN RESIDENCE 2102 14 ERNEST STREET, BALGOWLAH HEIGHTS, NSW 2093 Status SKETCH DESIGN Published: Monday, 14 March 2022 Drawing Title Drawing No SITE ANALYSIS DA001 03

lssue

^{Scale} @A1

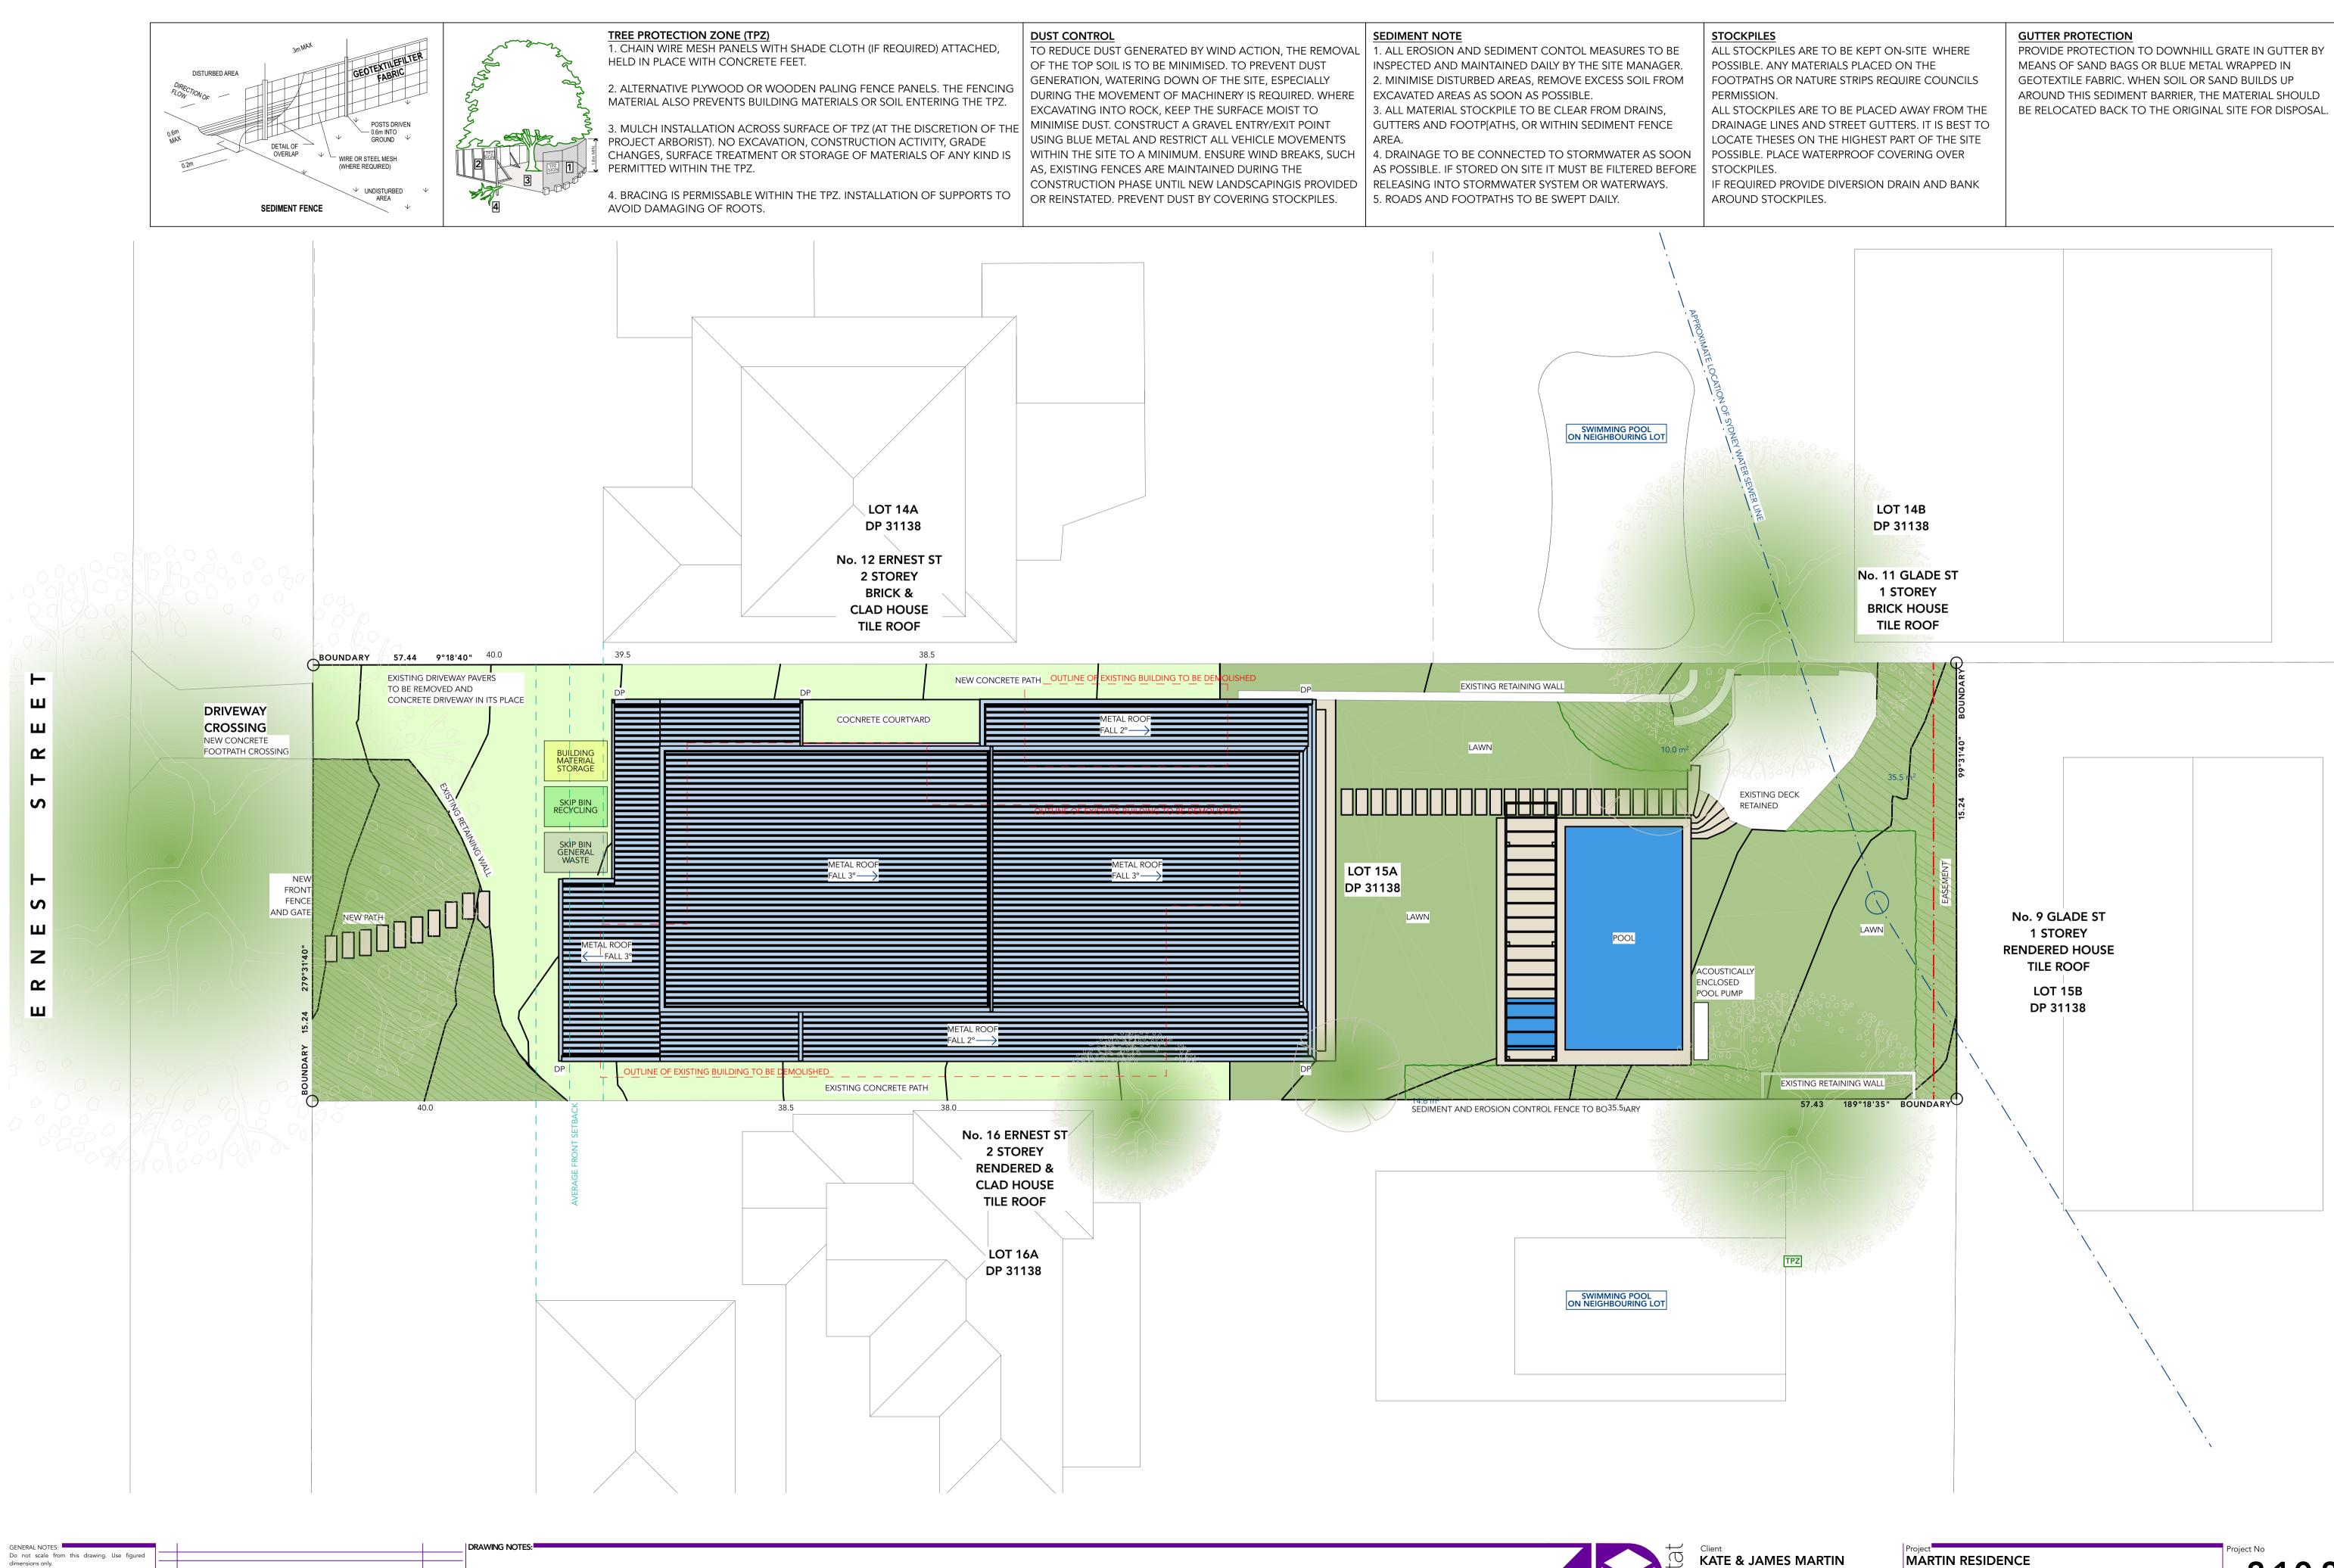

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PRIOR TO USE FOR BUILDING CONSTRUCTION THE BUILDER MUST ENSURE THEY ARE IN POSSESSION OF A CC AND ALL OTHER				

For any discrepancies in documentation contact 3D

Habitat for clarifications if required

REQUIRED COUNCIL APPROVALS

03	DA REVISION	14/03/22
02	FRONT SETBACK LINES, DEMOLISHED BUILDING ADDED	31/01/22
01	DEVELOPMENT APPLICATION	03/12/21
Rev	Change Name	Date




14 ERNEST STREET BALGOWLAH HEIGHTS, NSW 2093

14 ERNEST STREET, BALGOWLAH HEIGHTS, NSW 2093 Status SKETCH DESIGN Drawing Title SITE PLAN




^{Scale} **1:100** @A1

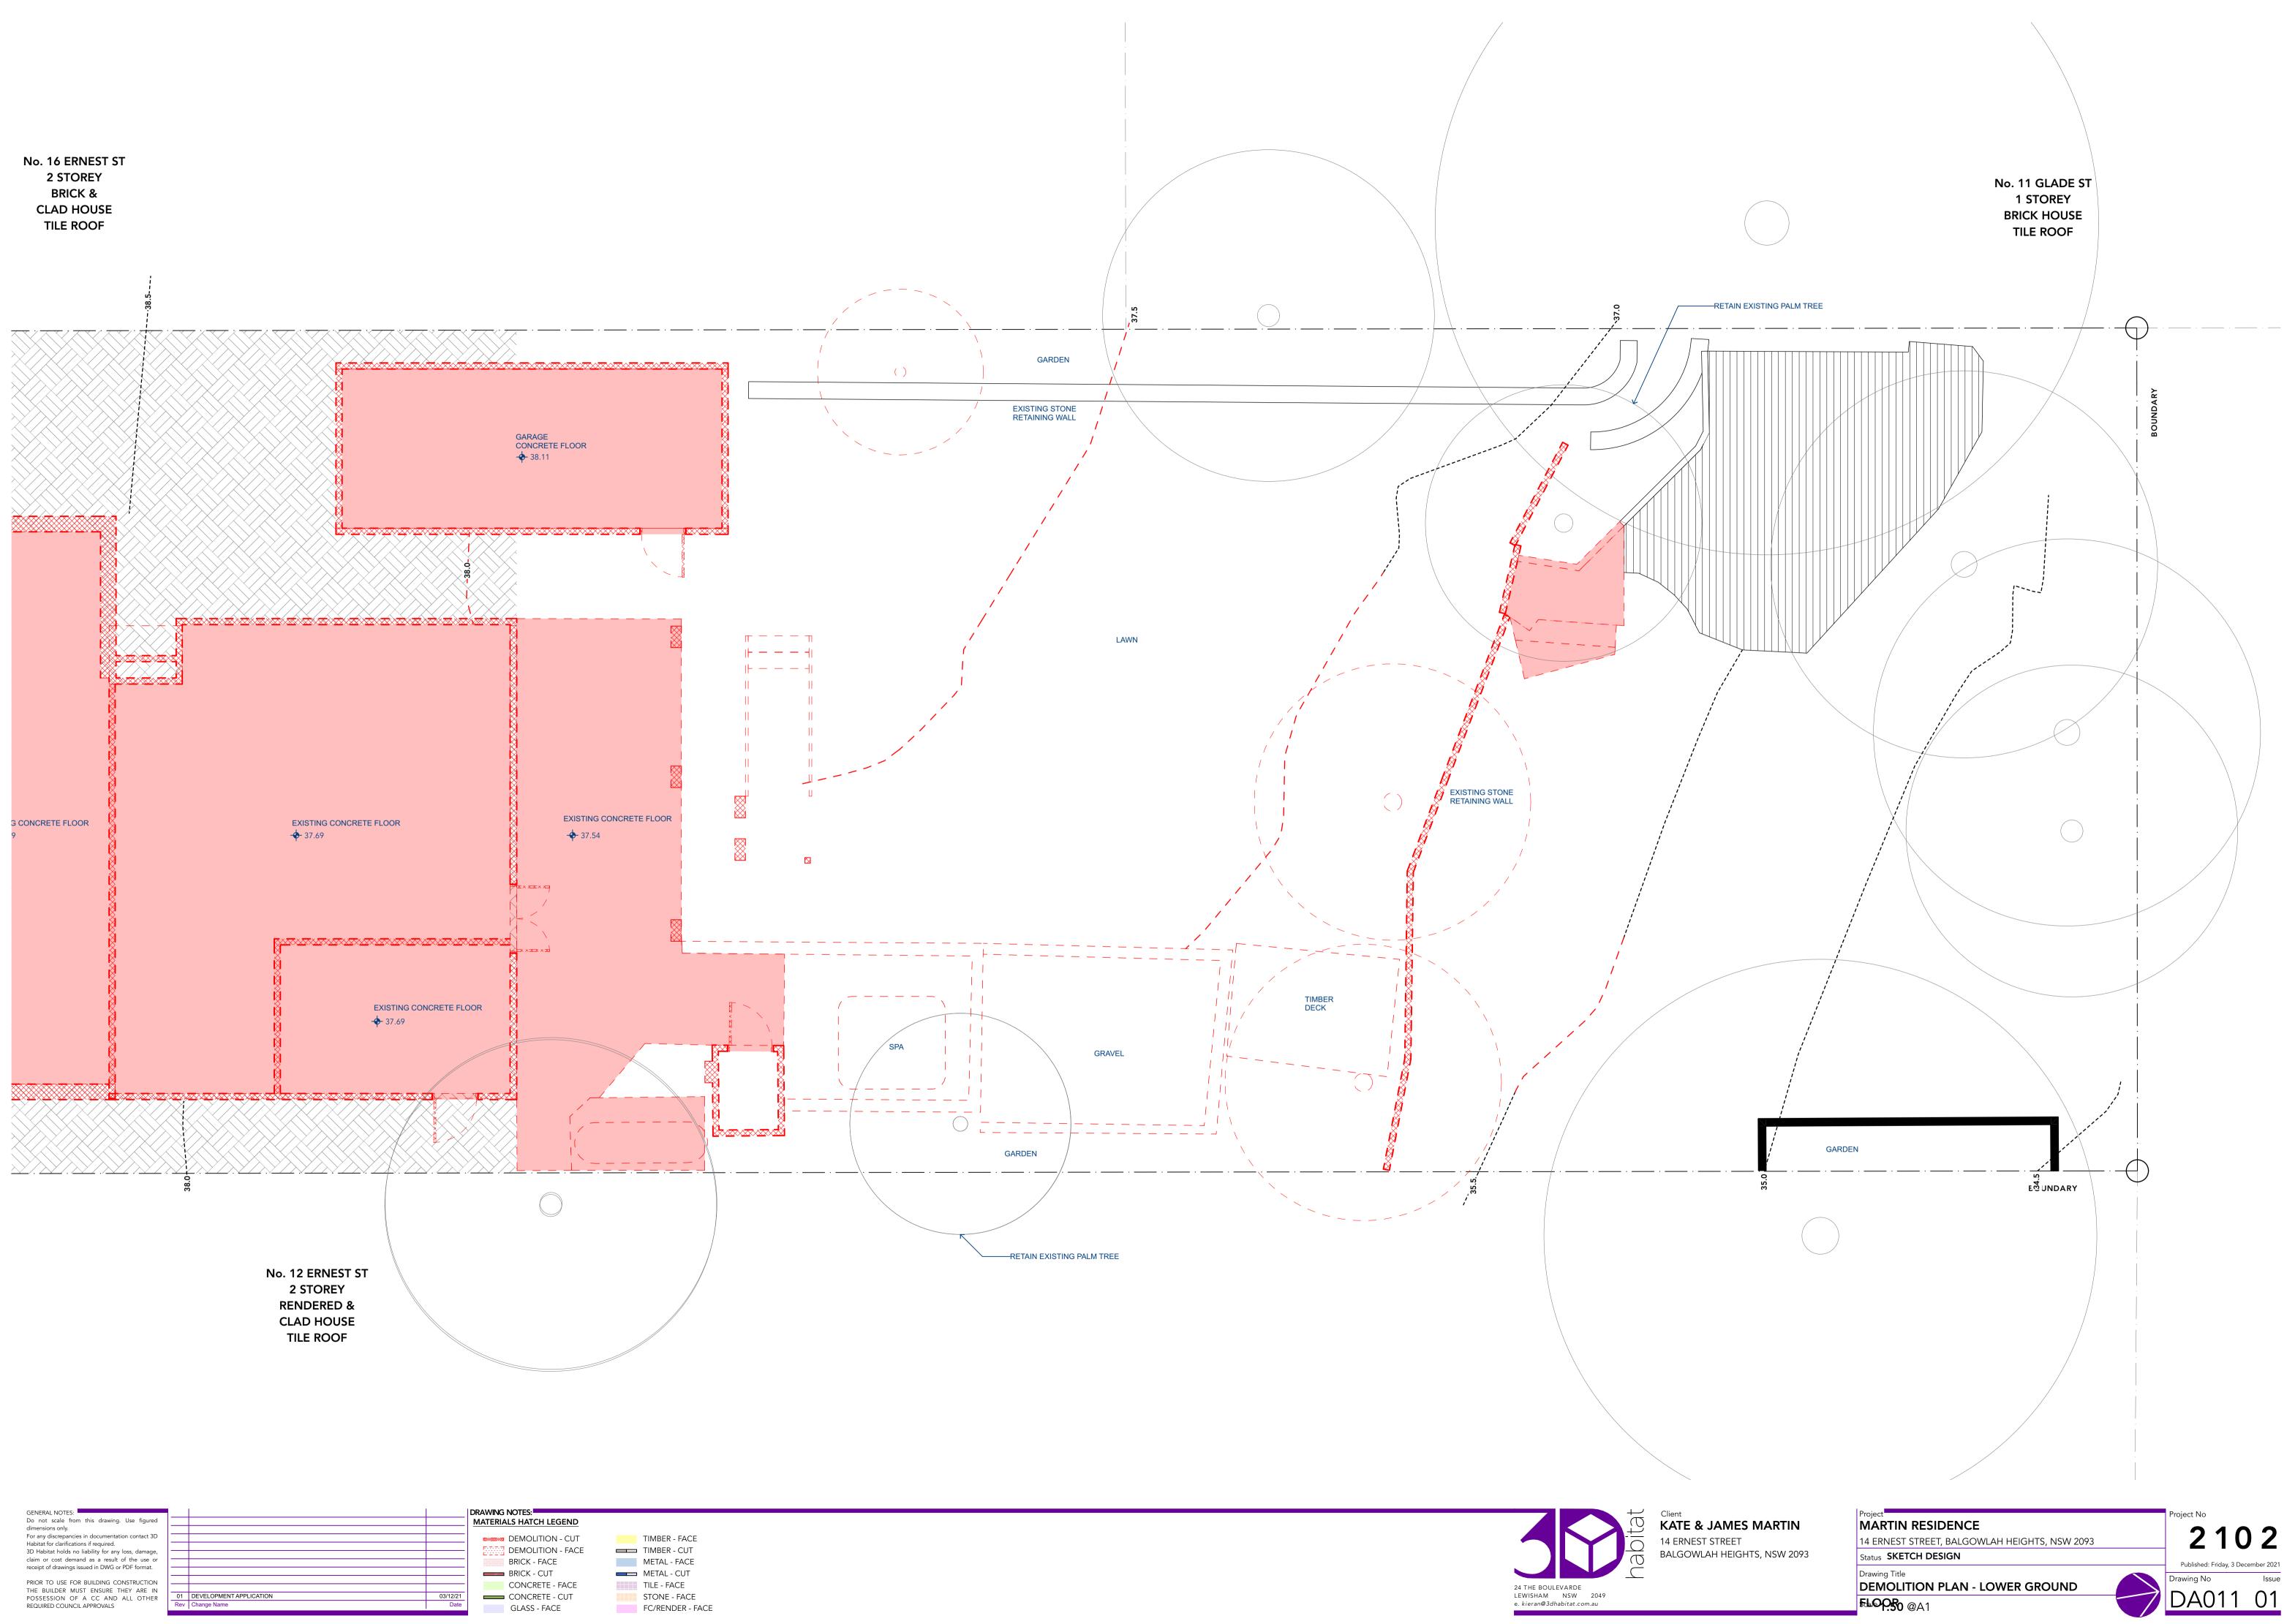



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R TO USE FOR BUILDING CONSTRUCTION				
BUILDER MUST ENSURE THEY ARE IN				
SESSION OF A CC AND ALL OTHER				




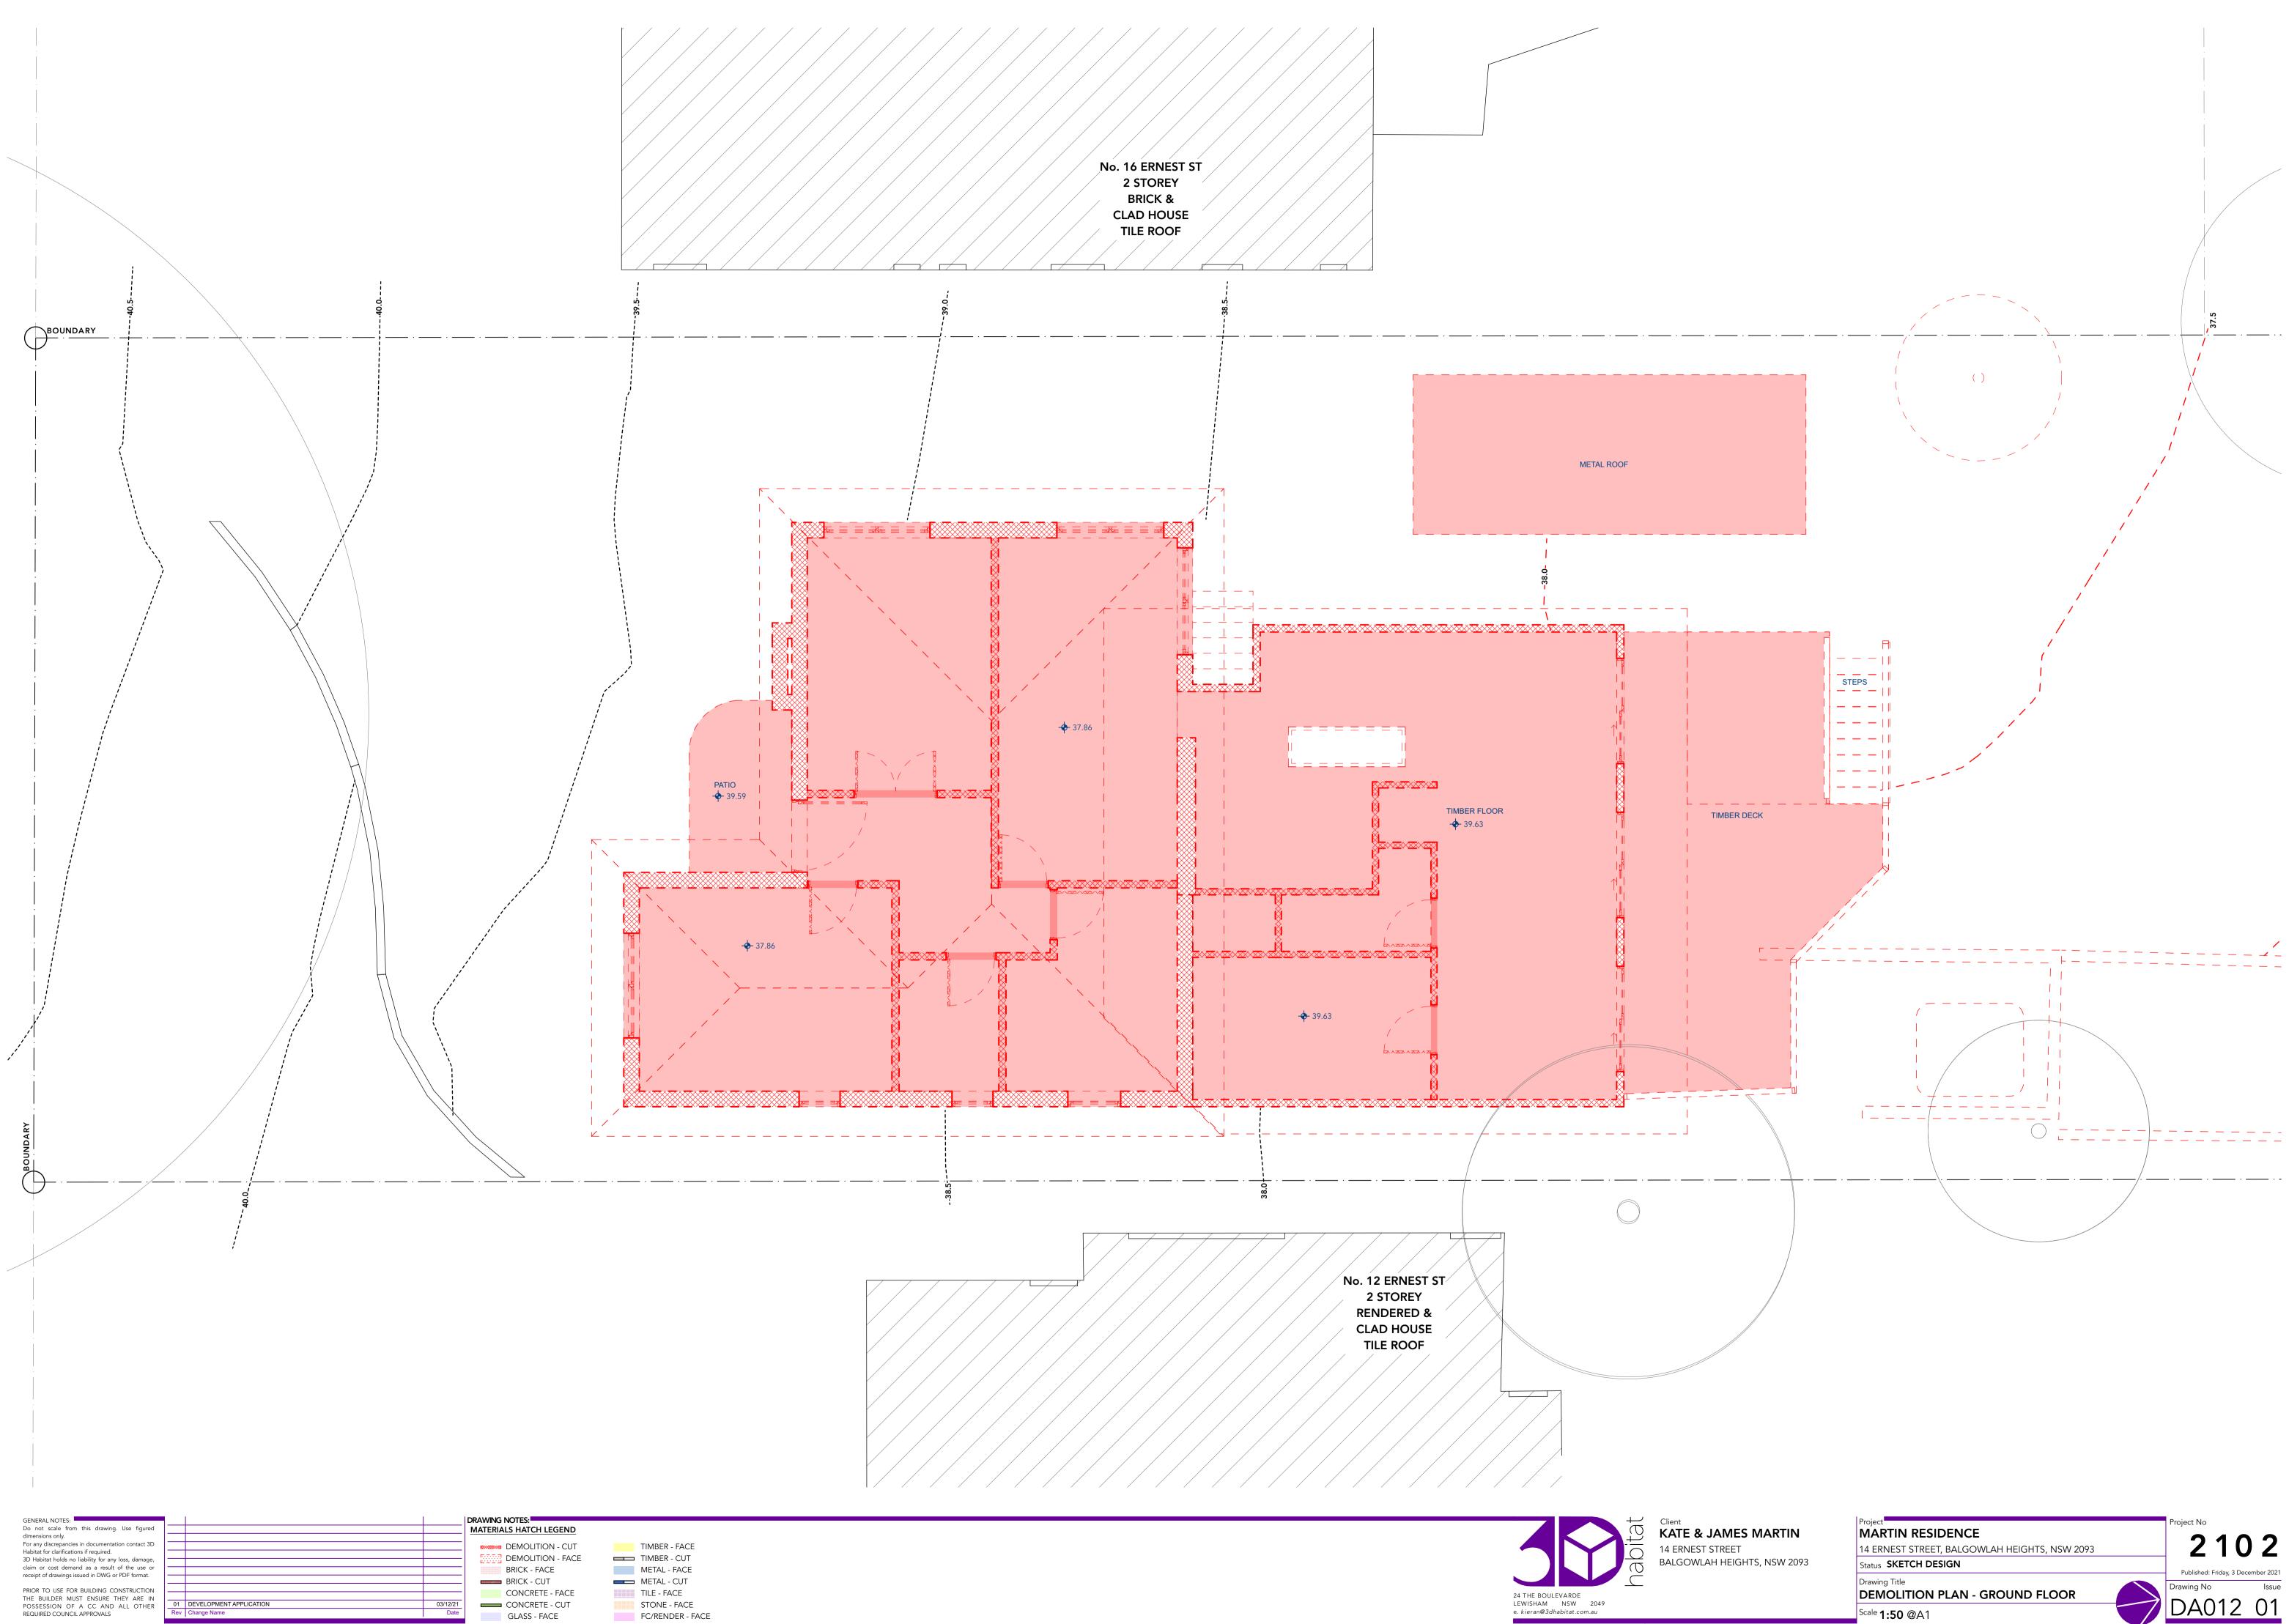

OPMENT APPLICATION	03/12/21
Name	Date

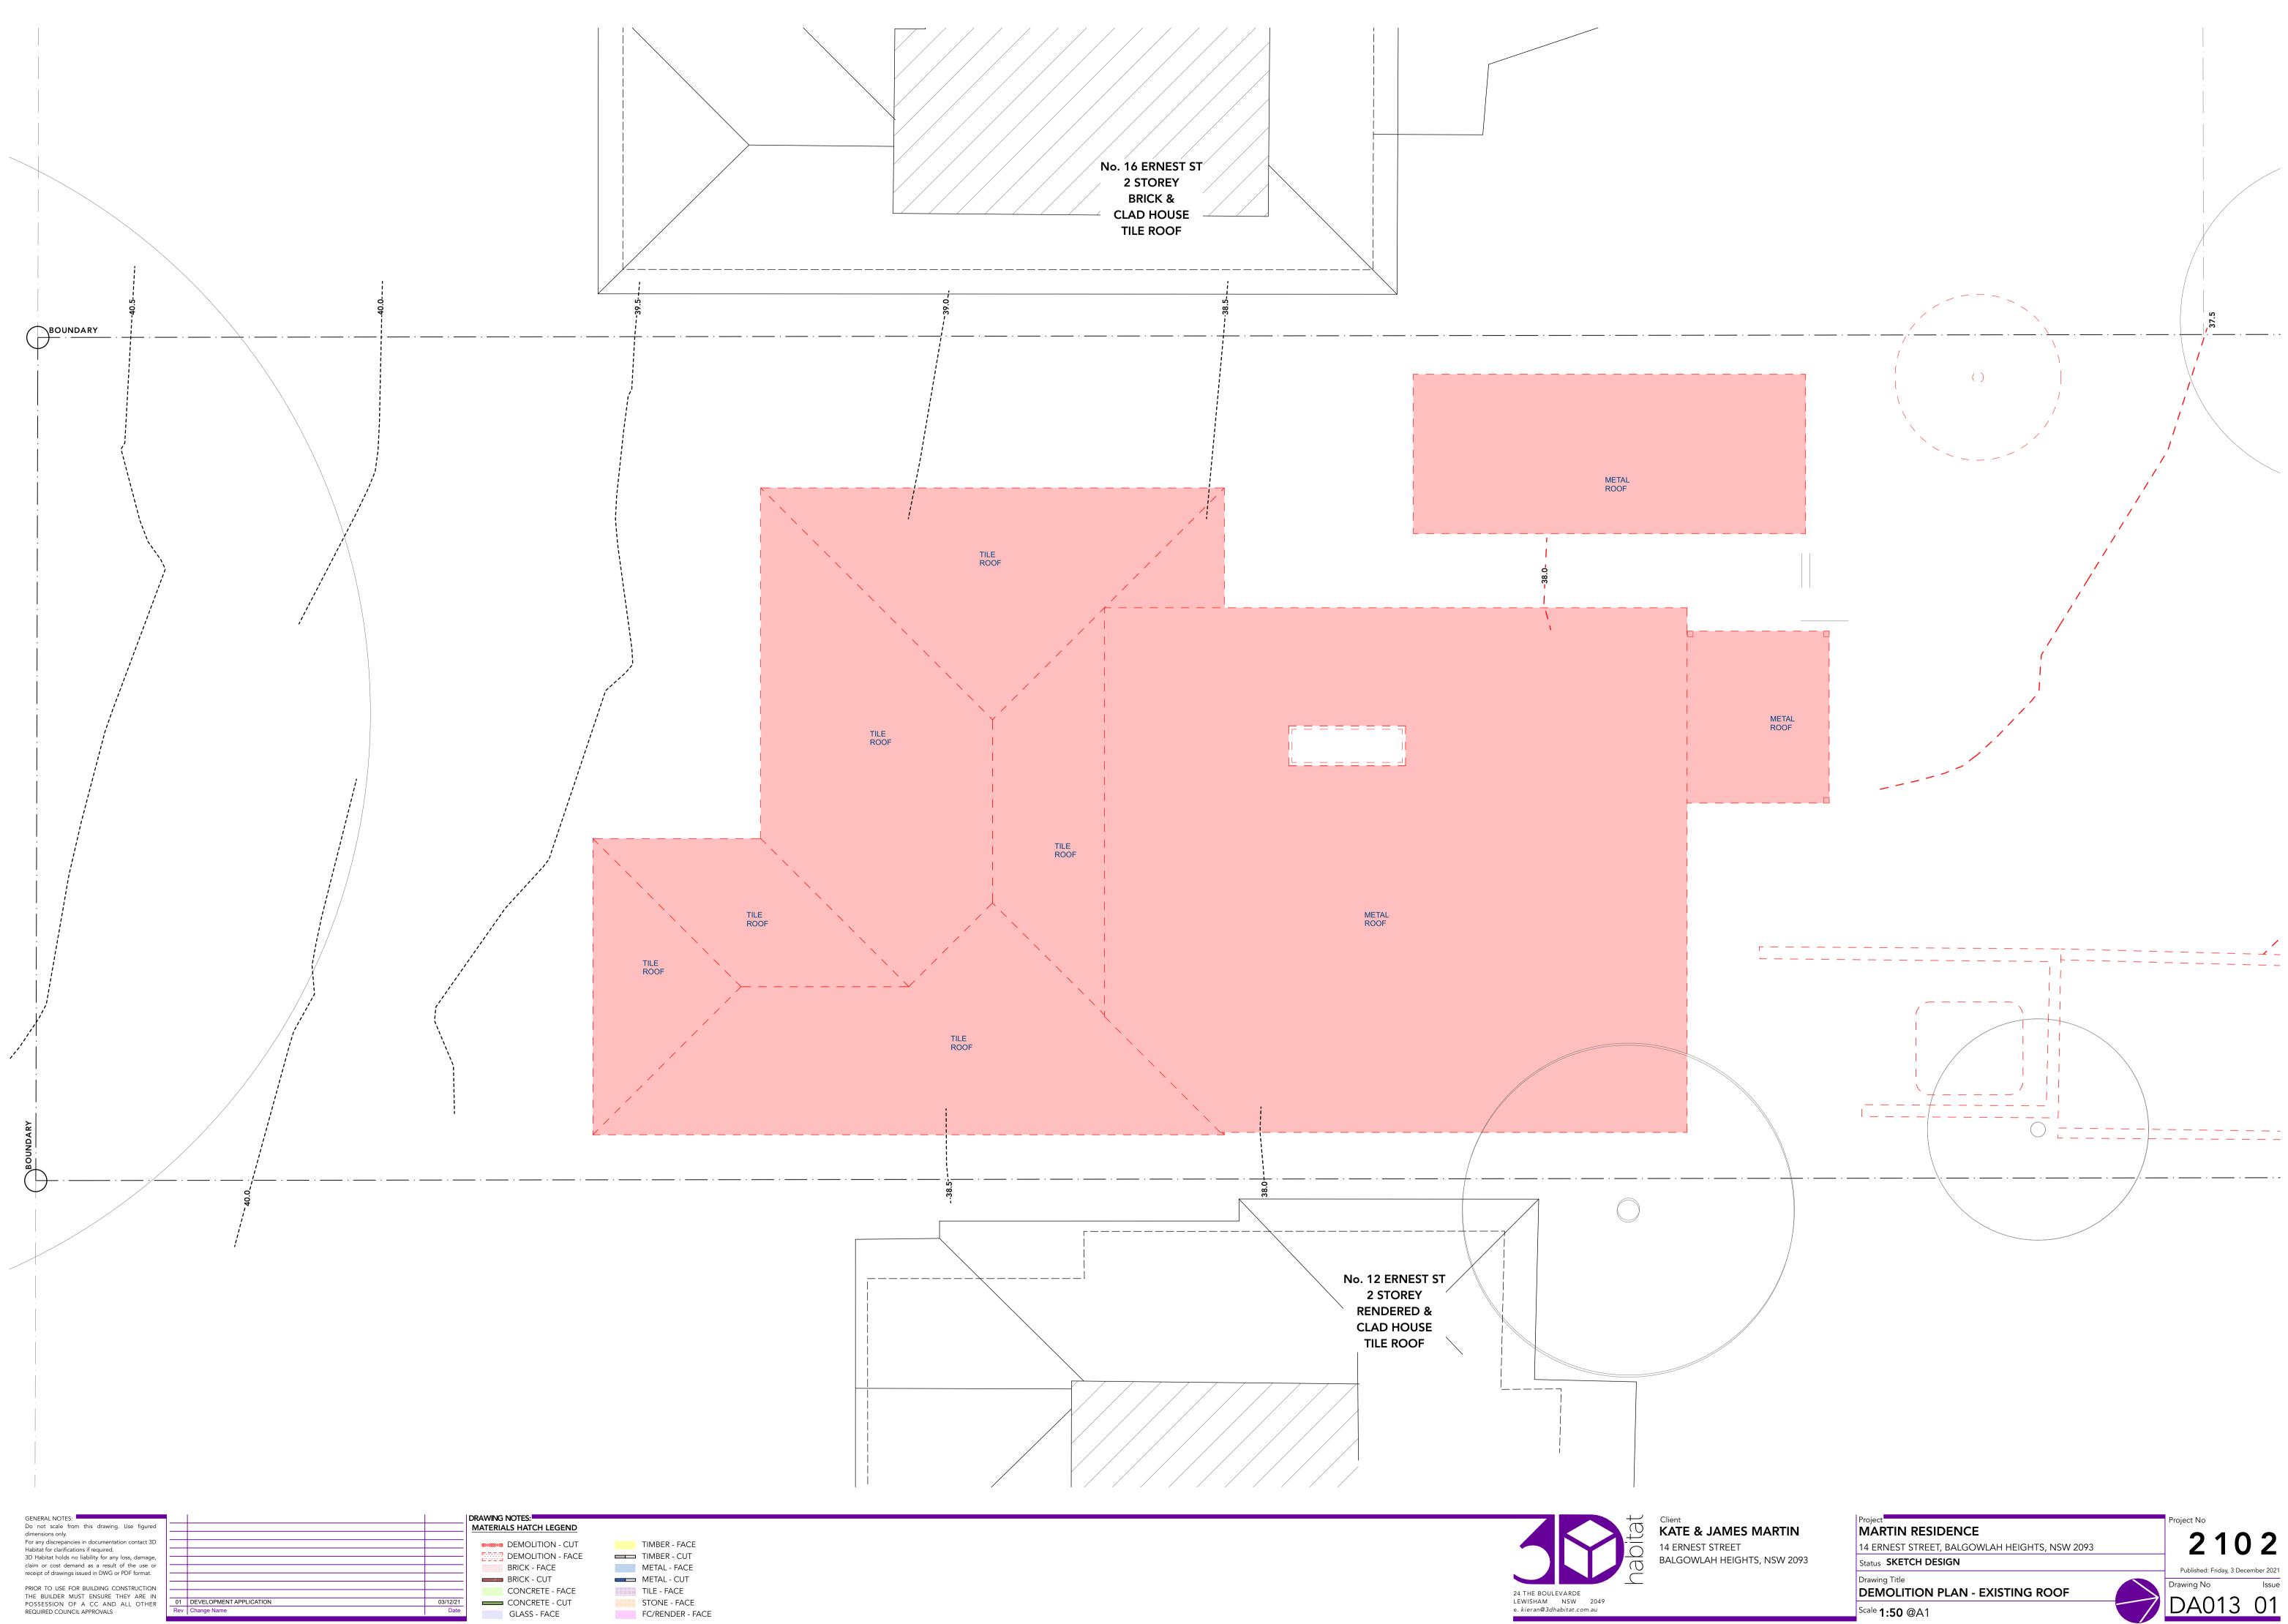

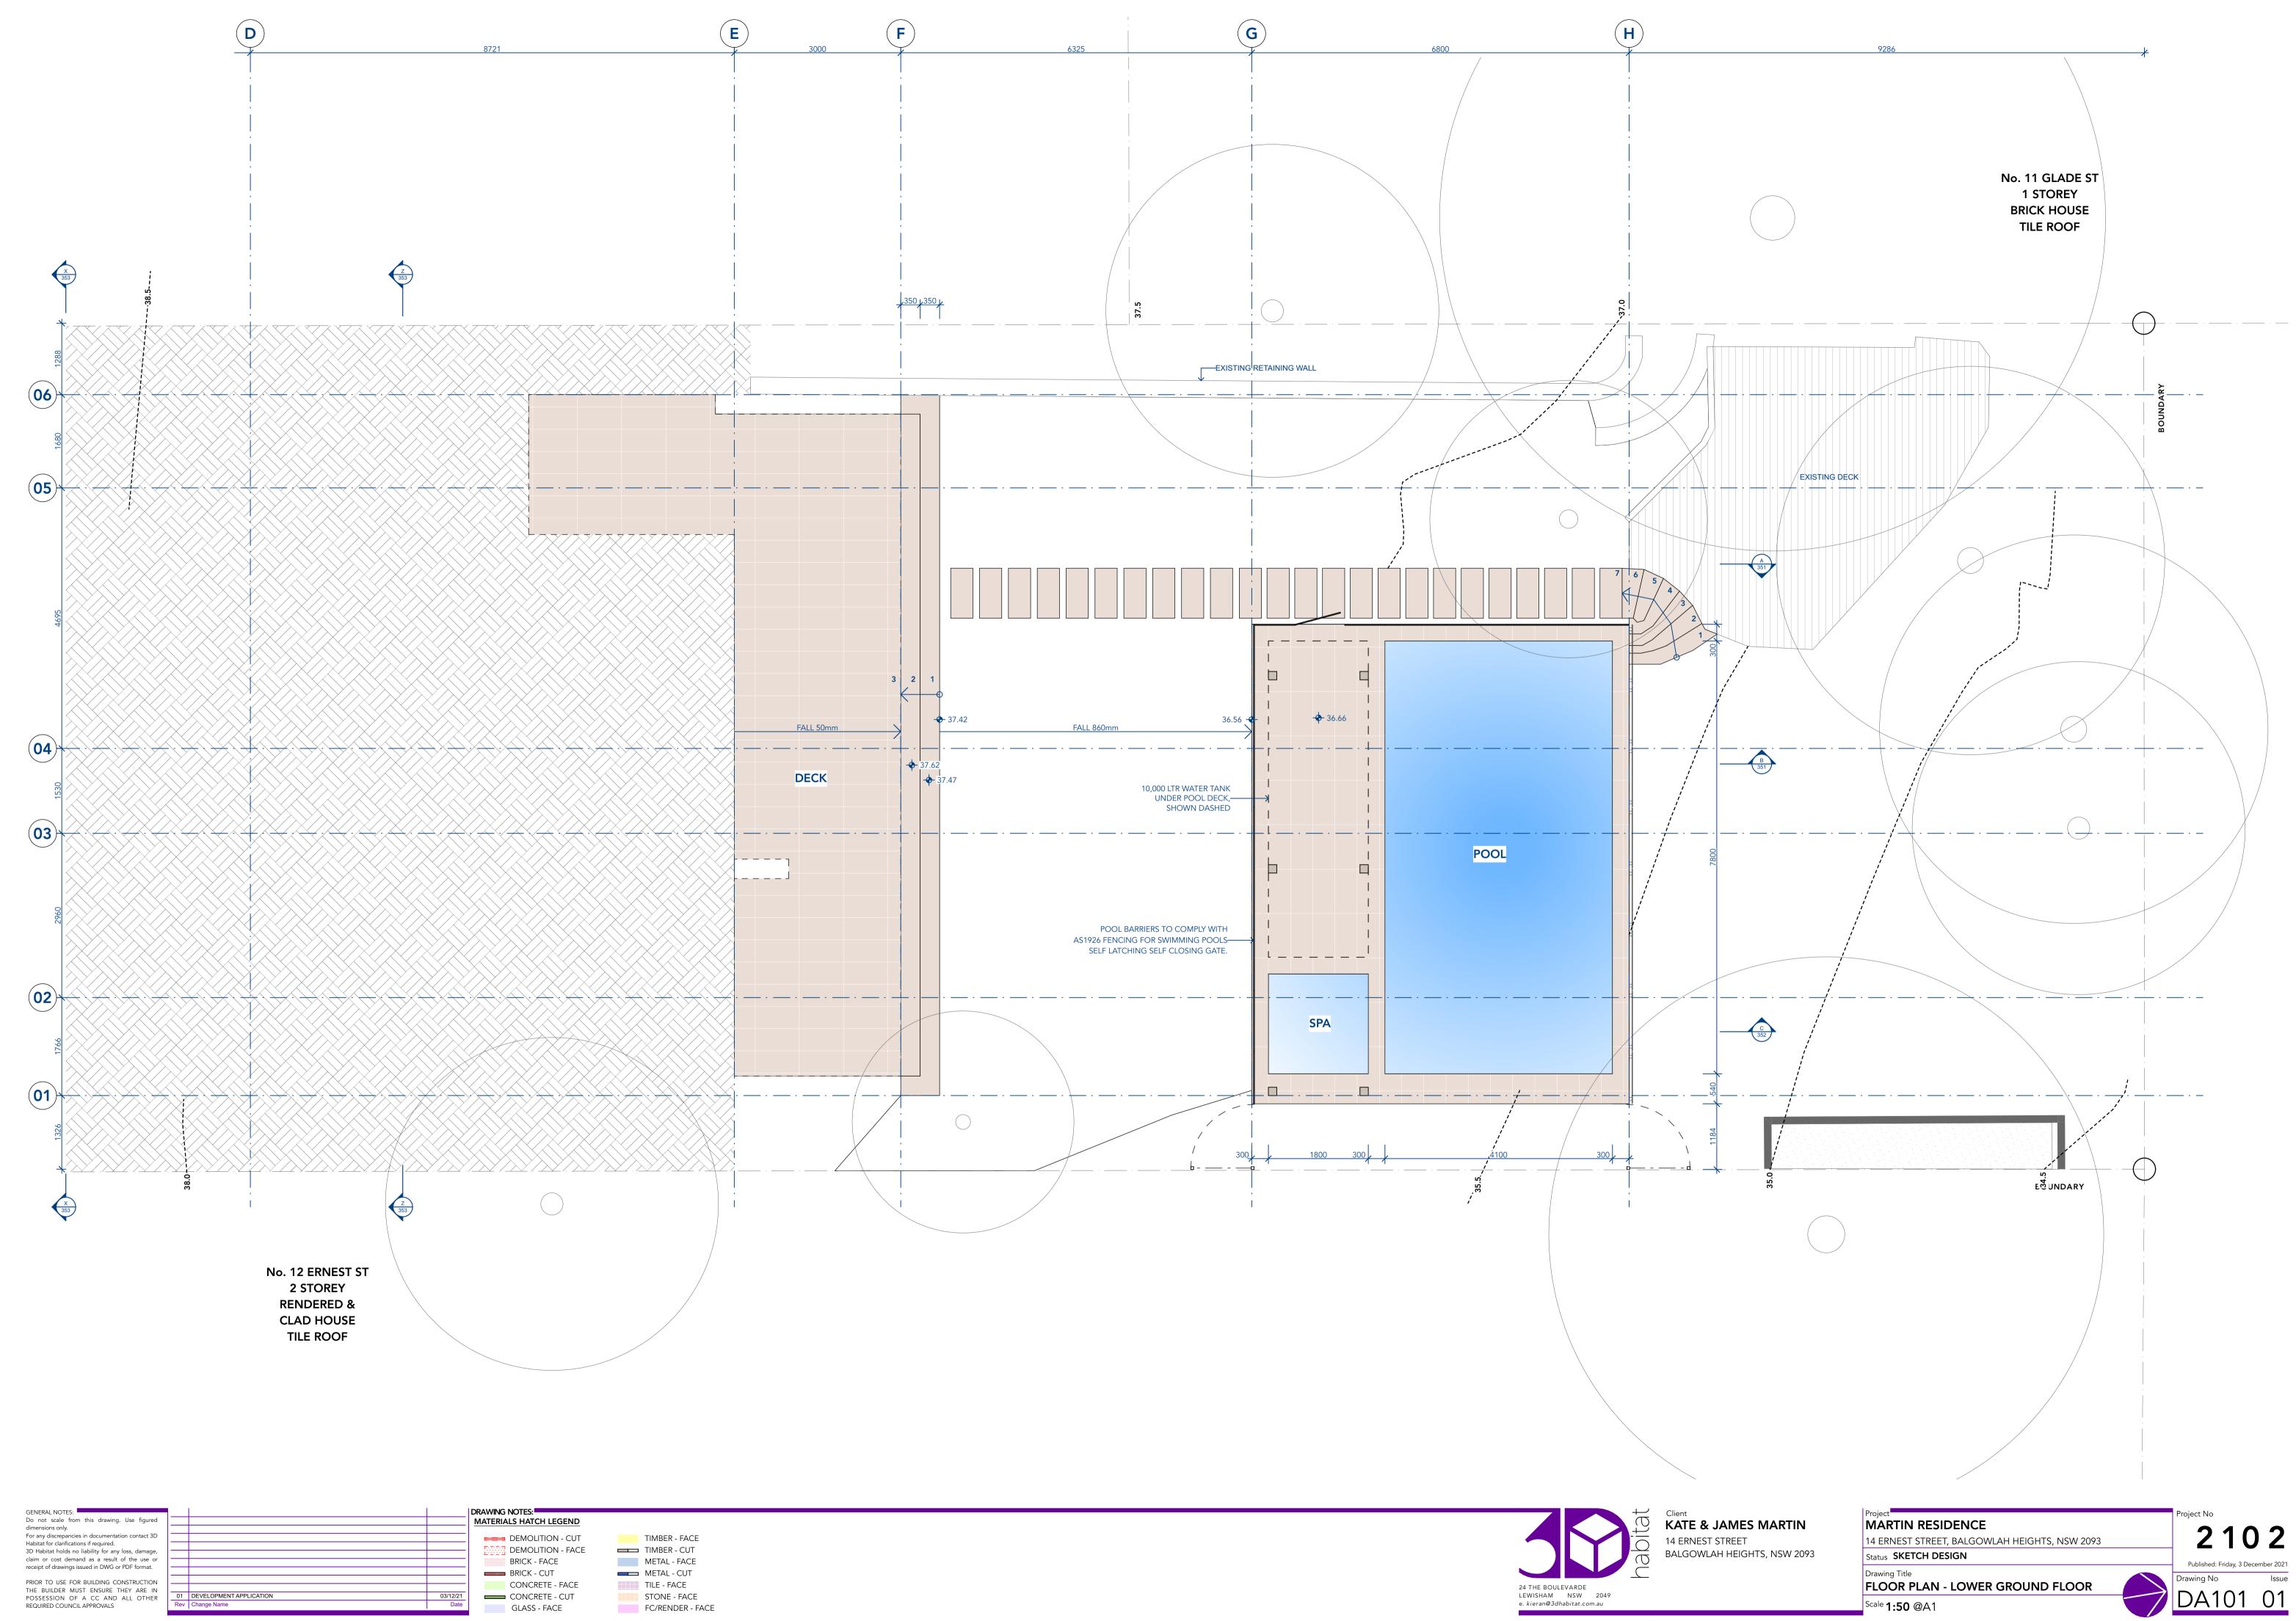

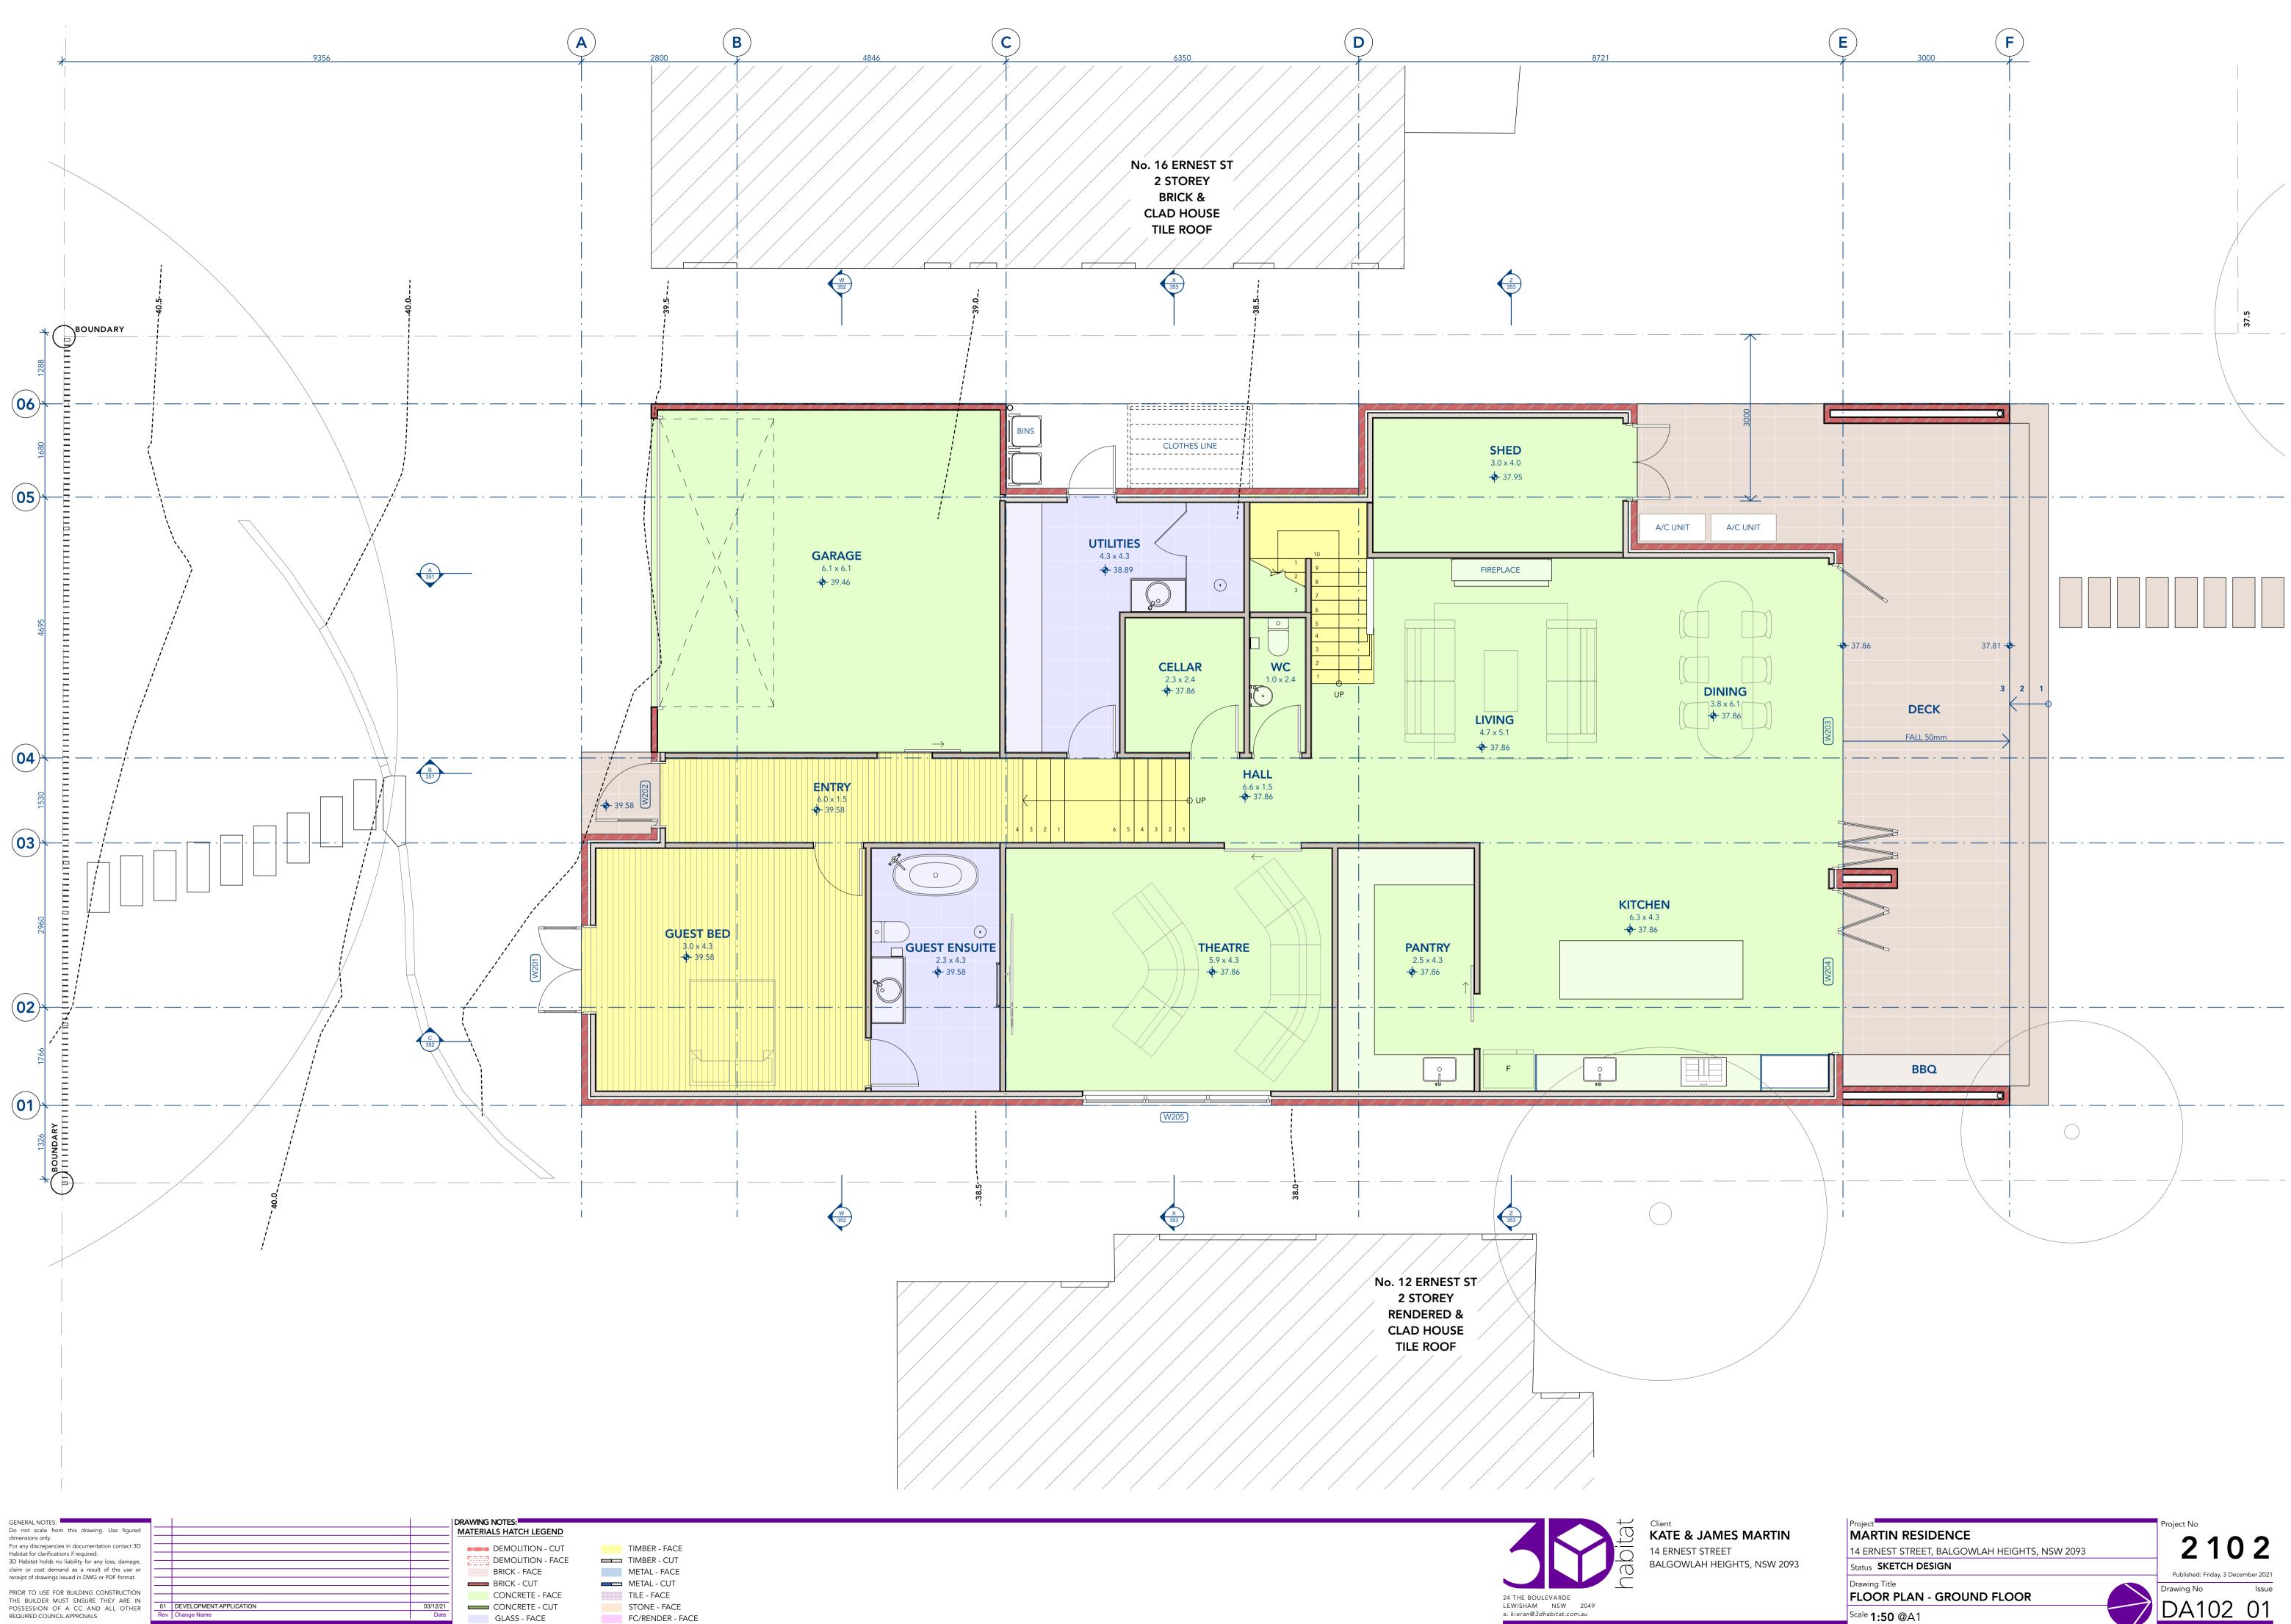

PRIOR TO USE FOR BUILDING CONSTRUCTION THE BUILDER MUST ENSURE THEY ARE IN POSSESSION OF A CC AND ALL OTHER REQUIRED COUNCIL APPROVALS

03/12/21 Date

CONCRETE - FACE CONCRETE - CUT GLASS - FACE

TILE - FACE STONE - FACE FC/RENDER - FACE


24 THE BOULEVARDE

LEWISHAM NSW 2049

e. kieran@3dhabitat.com.au

FLOOR PLAN - GROUND FLOOR

^{Scale} **1:50** @A1

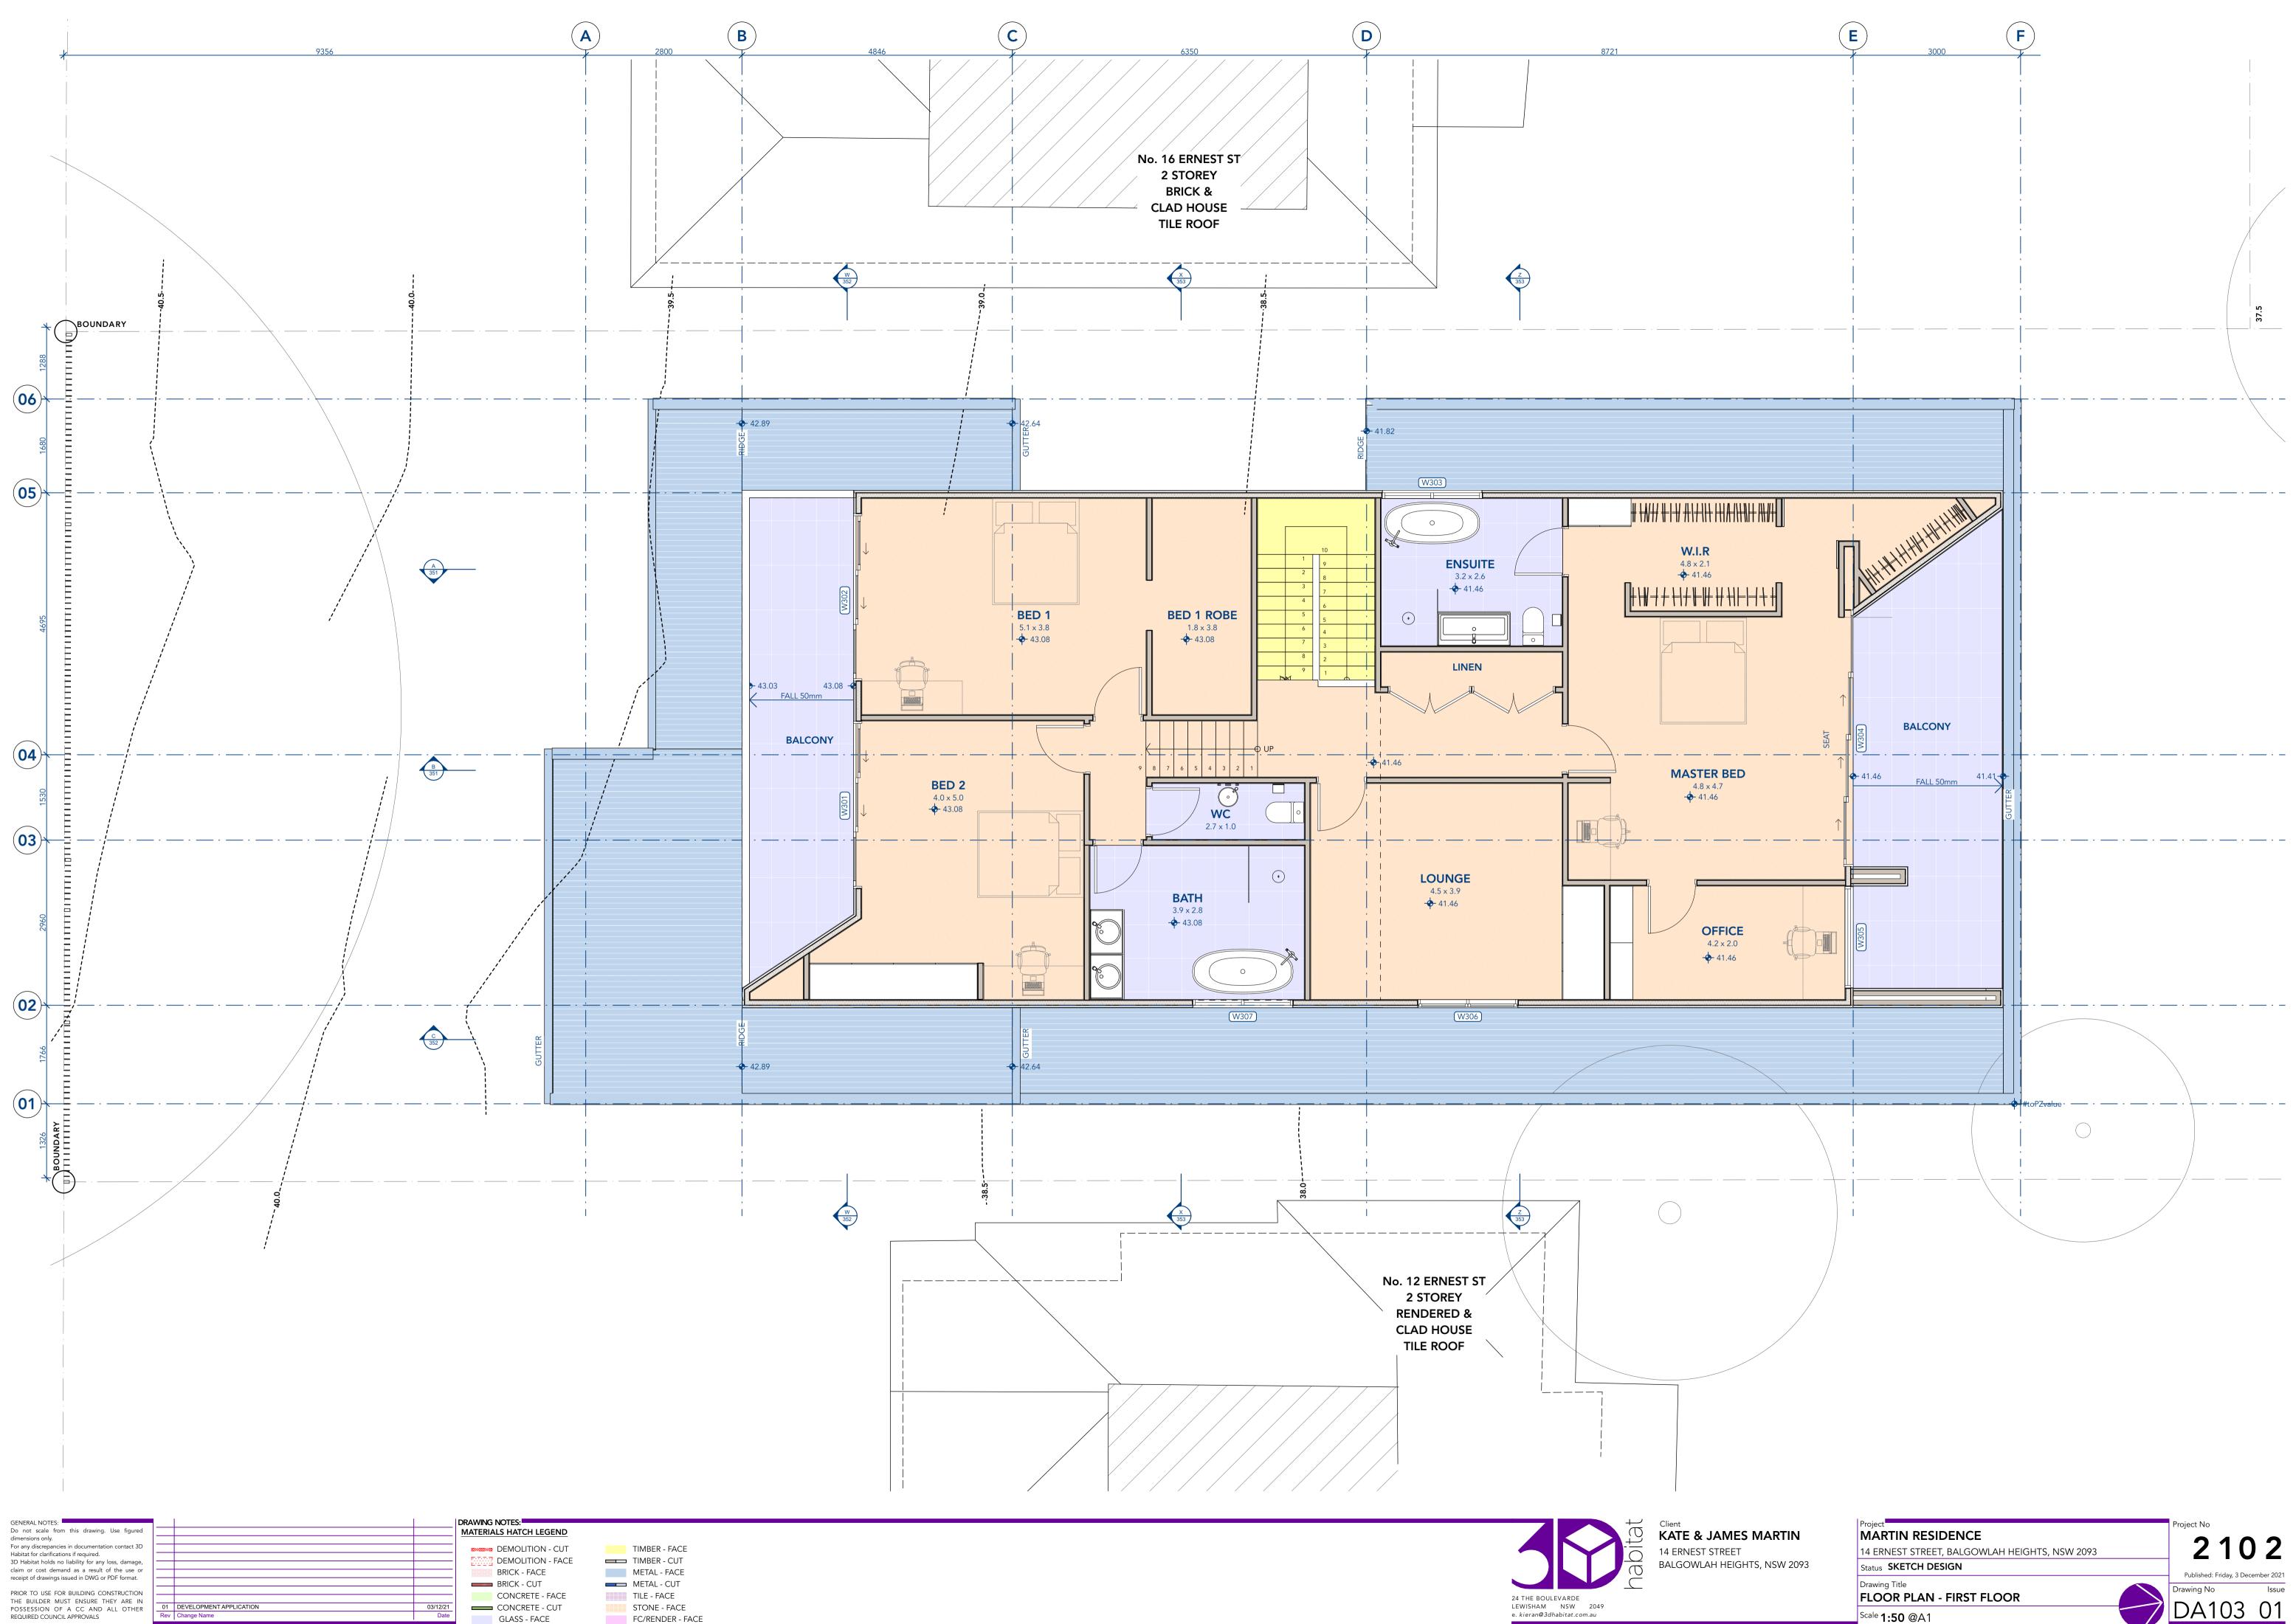

03/12/21 Date

CONCRETE - CUT GLASS - FACE

STONE - FACE FC/RENDER - FACE


LEWISHAM NSW 2049

e. kieran@3dhabitat.com.au

FLOOR PLAN - FIRST FLOOR

Drawing No Issue

^{Scale} **1:50** @A1

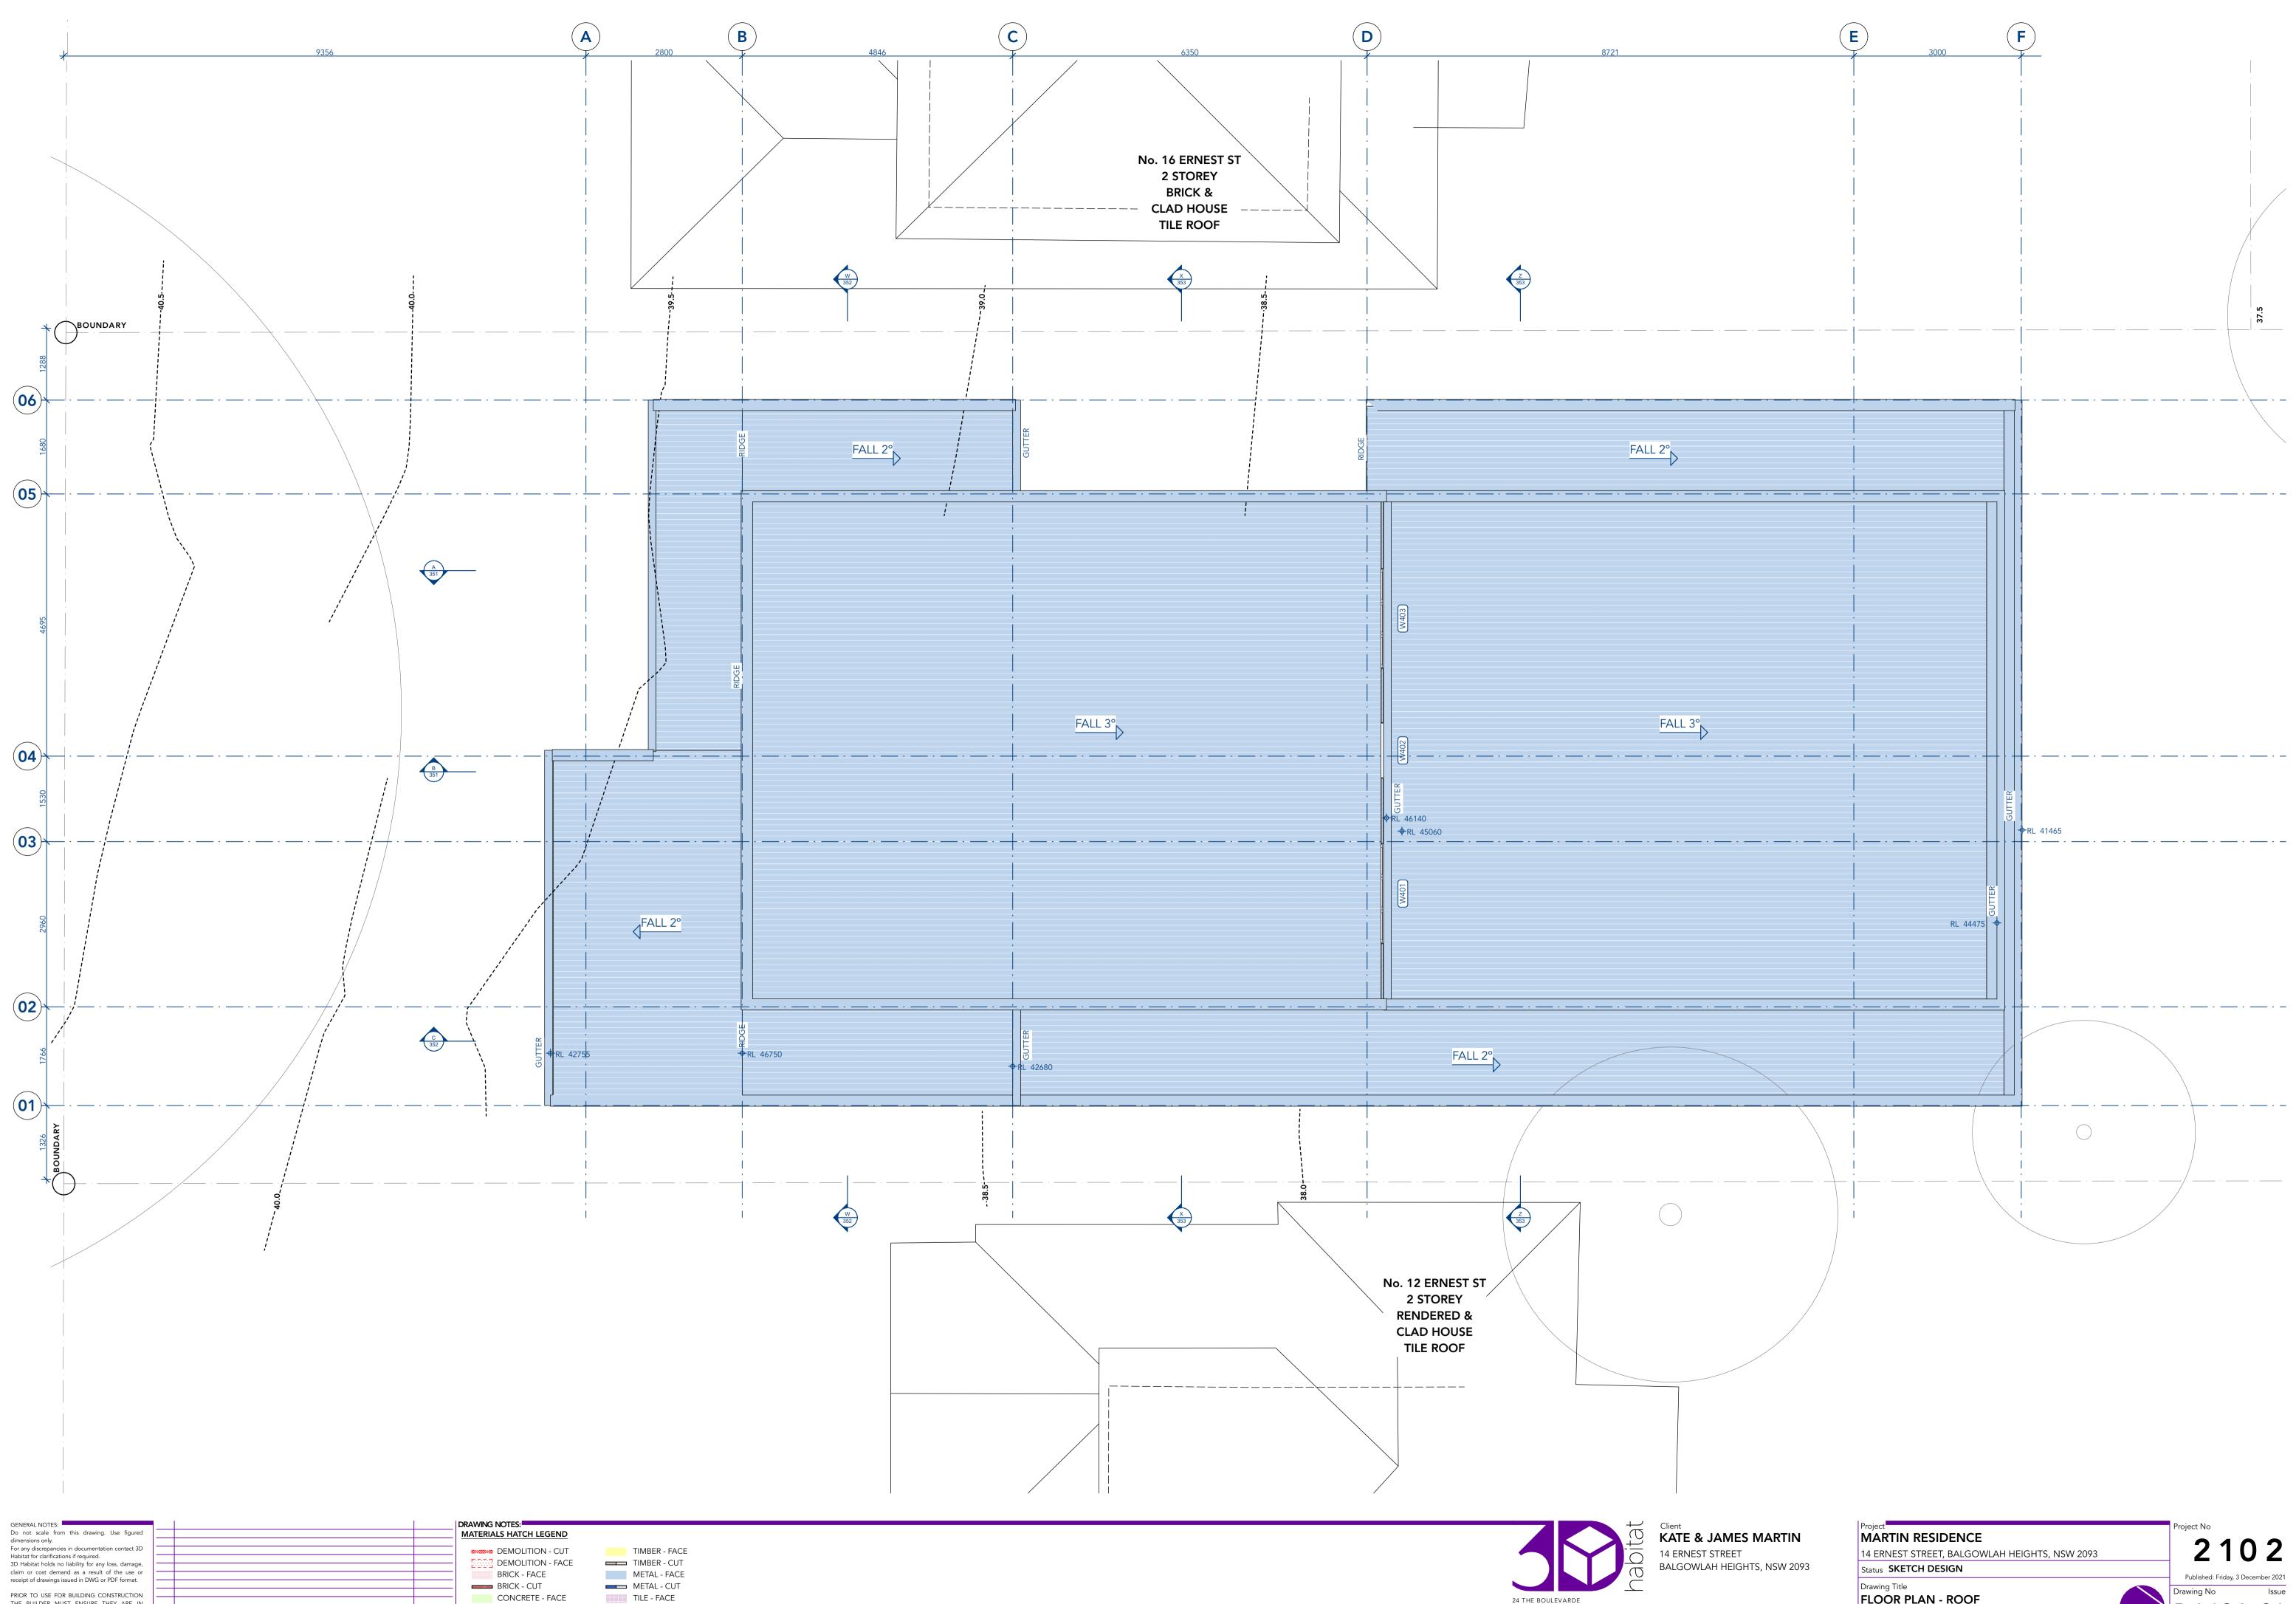

PRIOR TO USE FOR BUILDING CONSTRUCTION THE BUILDER MUST ENSURE THEY ARE IN POSSESSION OF A CC AND ALL OTHER REQUIRED COUNCIL APPROVALS REV Change Name

03/12/21 Date

TILE - FACE STONE - FACE FC/RENDER - FACE

CONCRETE - CUT

GLASS - FACE

LEWISHAM NSW 2049 e. kieran@3dhabitat.com.au

Drawing Title FLOOR PLAN - ROOF

Drawing No Issue

^{Scale} **1:50** @A1



PRIOR TO USE FOR BUILDING CONSTRUCTION THE BUILDER MUST ENSURE THEY ARE IN POSSESSION OF A CC AND ALL OTHER REQUIRED COUNCIL APPROVALS

03/12/21 Date

BRICK - CUT CONCRETE - FACE CONCRETE - CUT GLASS - FACE

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16 ERNEST ST	

S	Μ	ART	IN
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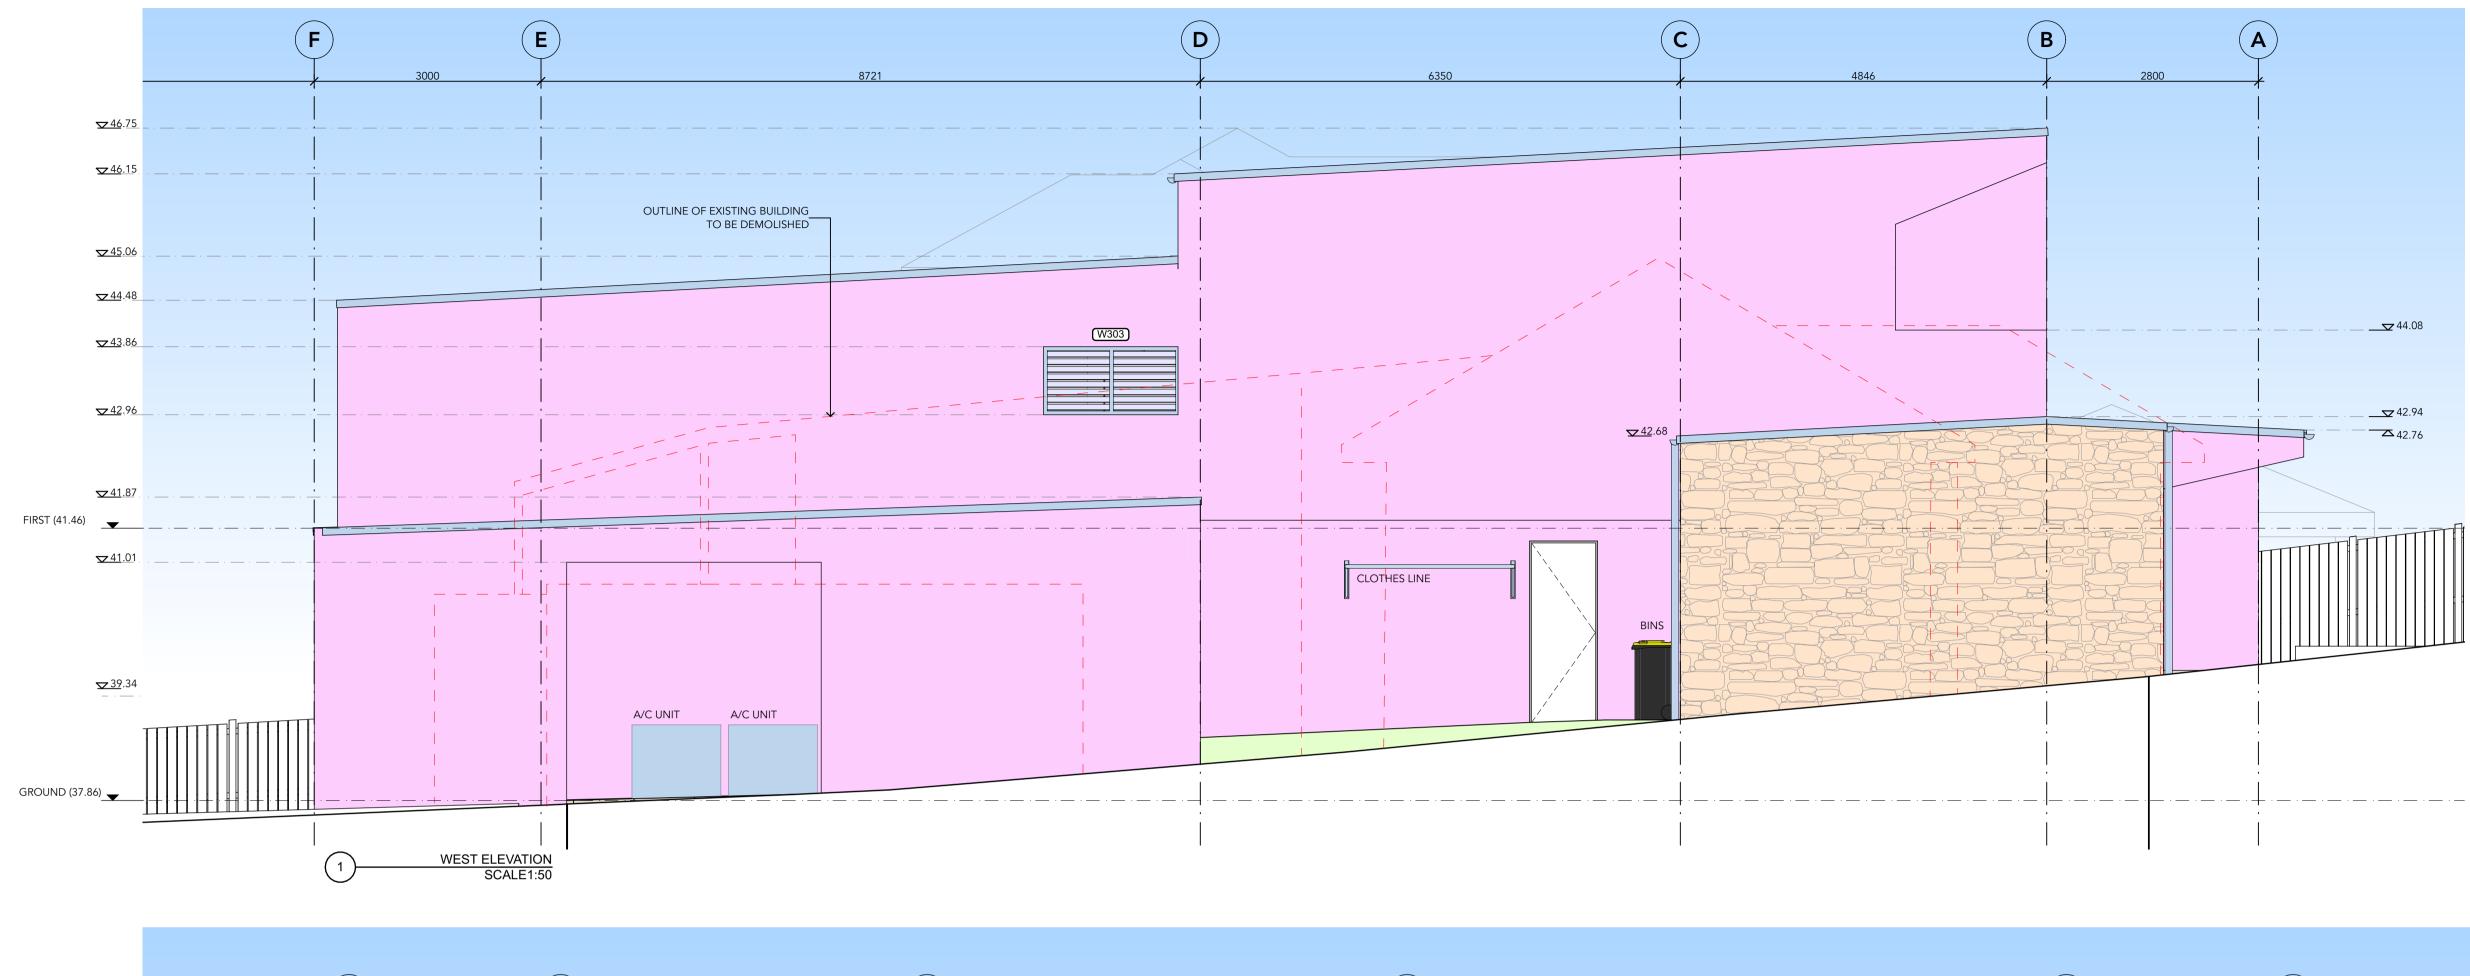
24 THE BOULEVARDE


LEWISHAM NSW 2049

e. kieran@3dhabitat.com.au

Project
MARTIN RESIDENCE
14 ERNEST STREET, BALGOWLAH HEIGHTS, NSW 2093
Status SKETCH DESIGN
Drawing Title
ELEVATIONS - SHEET 1
Scale @A1





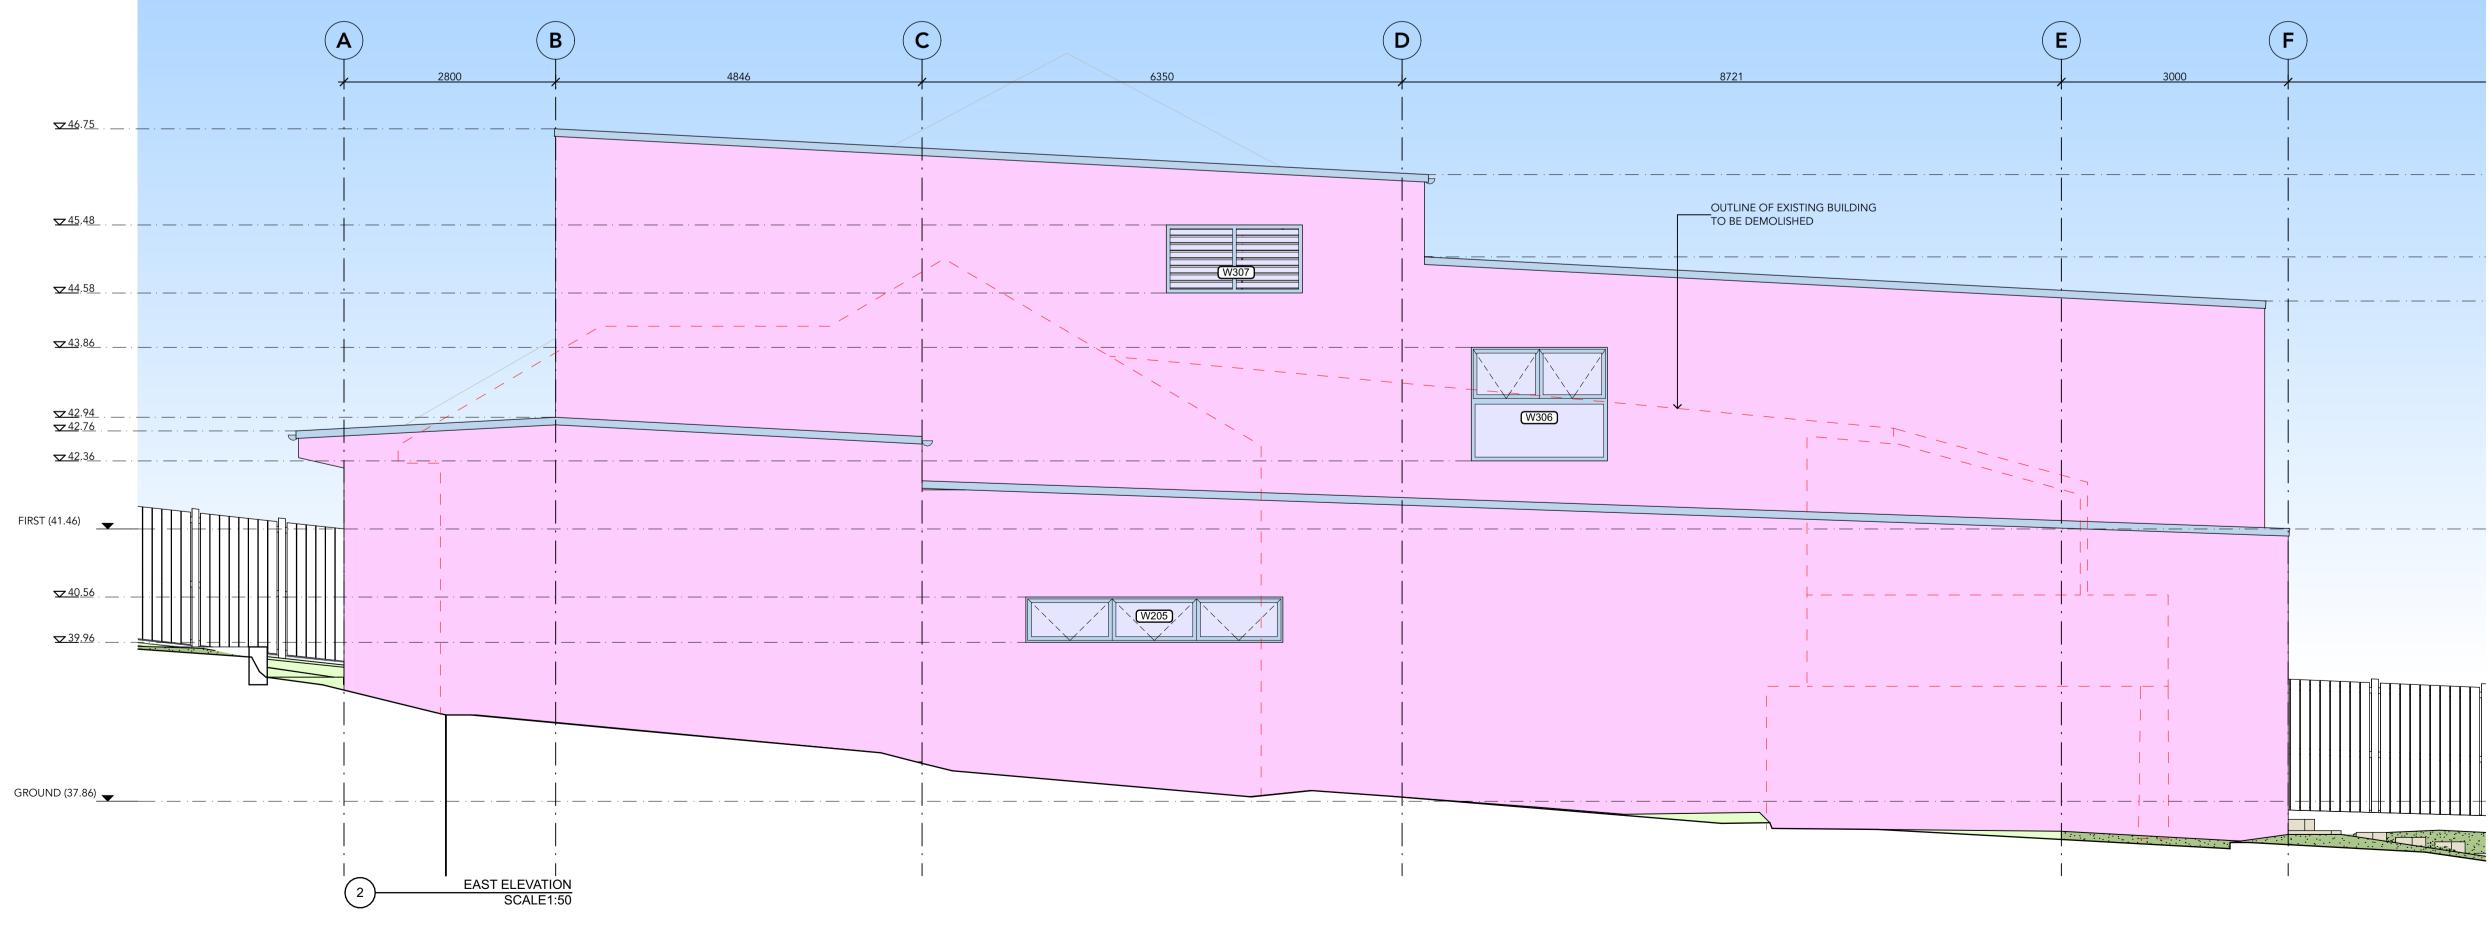

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For any discrepancies in documentation contact 3D Habitat for clarifications if required. 3D Habitat holds no liability for any loss, damage, claim or cost demand as a result of the use or			DEMOLITION - CUT	TIMBER - FACE TIMBER - CUT METAL - FACE
receipt of drawings issued in DWG or PDF format. PRIOR TO USE FOR BUILDING CONSTRUCTION THE BUILDER MUST ENSURE THEY ARE IN POSSESSION OF A CC AND ALL OTHER REQUIRED COUNCIL APPROVALS	01 DEVELOPMENT APPLICATION Rev Change Name	03/12/21 Date	BRICK - CUT CONCRETE - FACE CONCRETE - CUT GLASS - FACE	METAL - CUT TILE - FACE STONE - FACE FC/RENDER - FACE







MARTIN RESIDENCE 14 ERNEST STREET, BALGOWLAH HEIGHTS, NSW 2093 Status SKETCH DESIGN Drawing Title ELEVATIONS - SHEET 2


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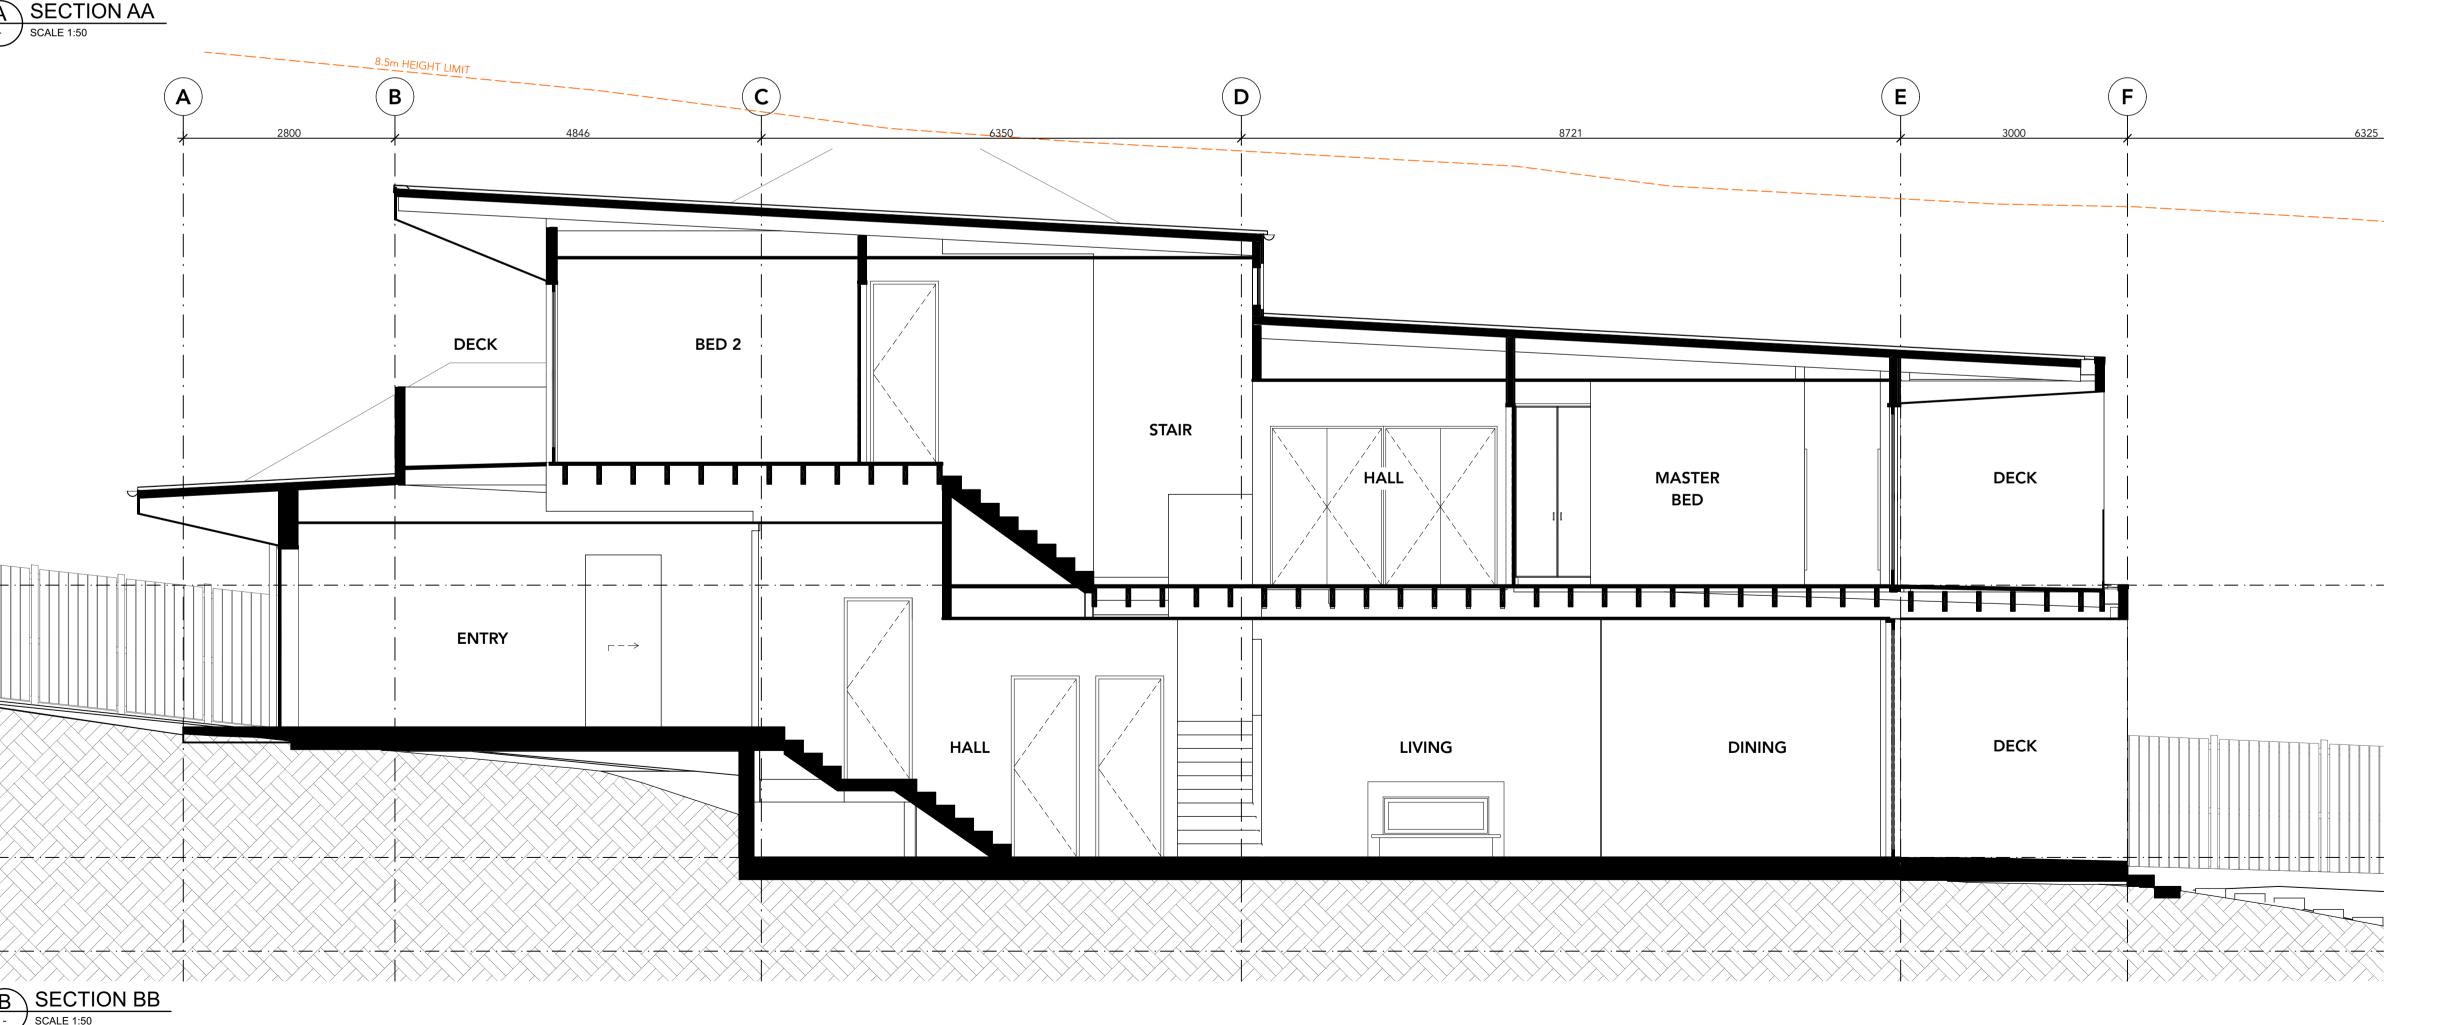




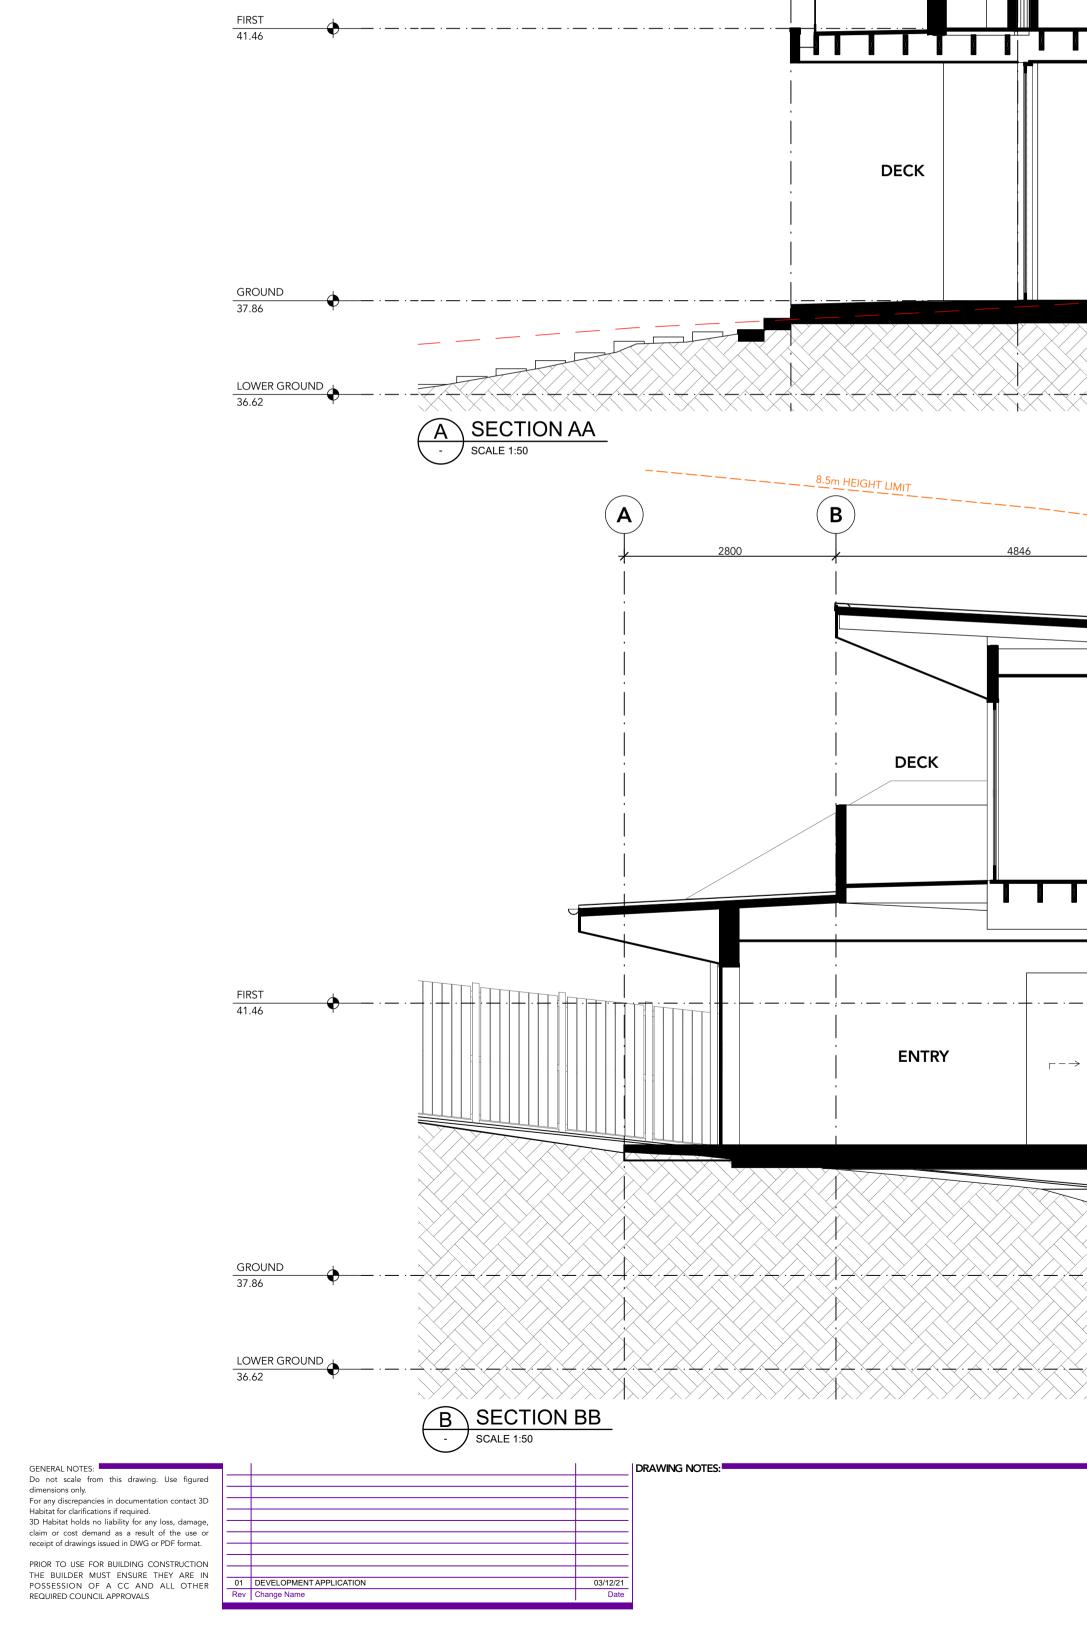

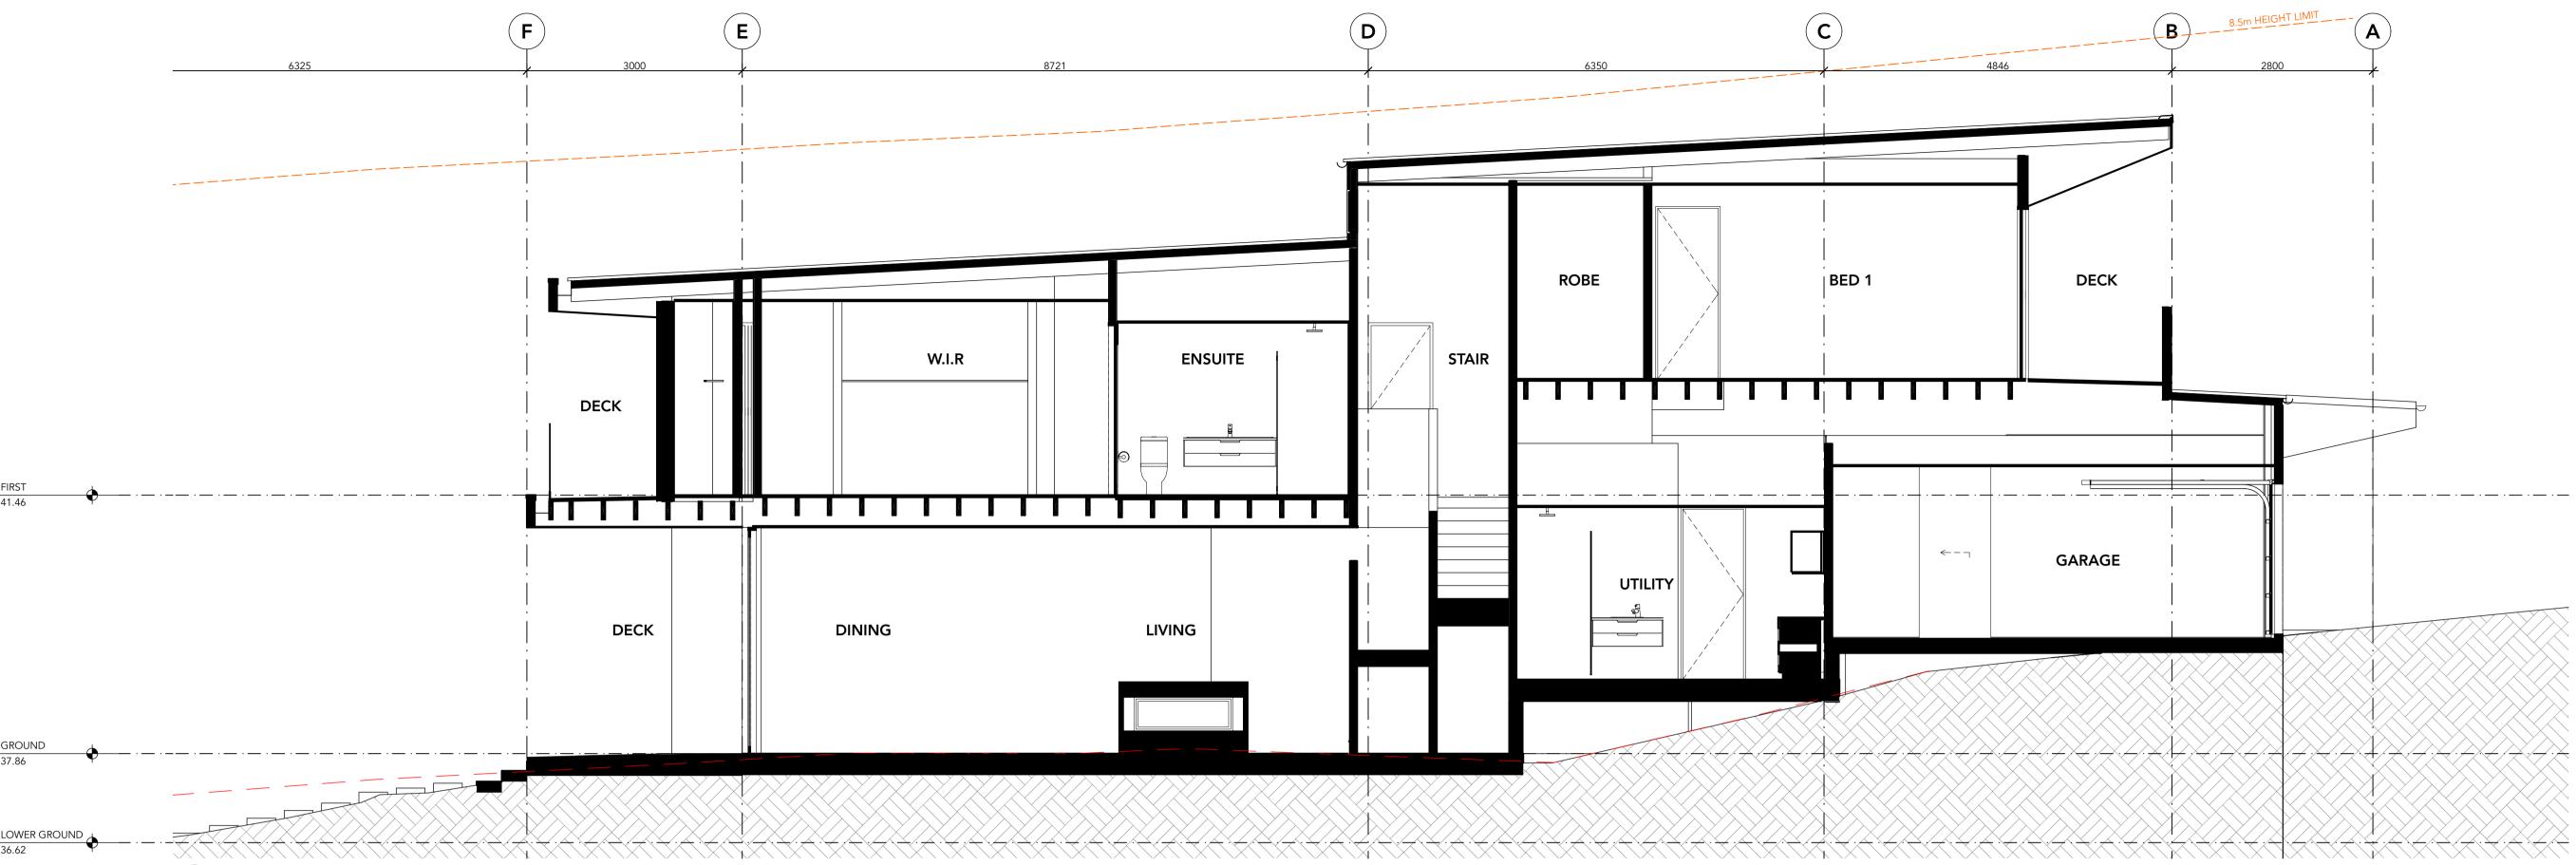




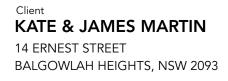

Project MARTIN RESIDENCE 14 ERNEST STREET, BALGOWLAH HEIGHTS, NSW 2093 Status SKETCH DESIGN Drawing Title SECTIONS - SHEET 1 Scale 1:50 @A1



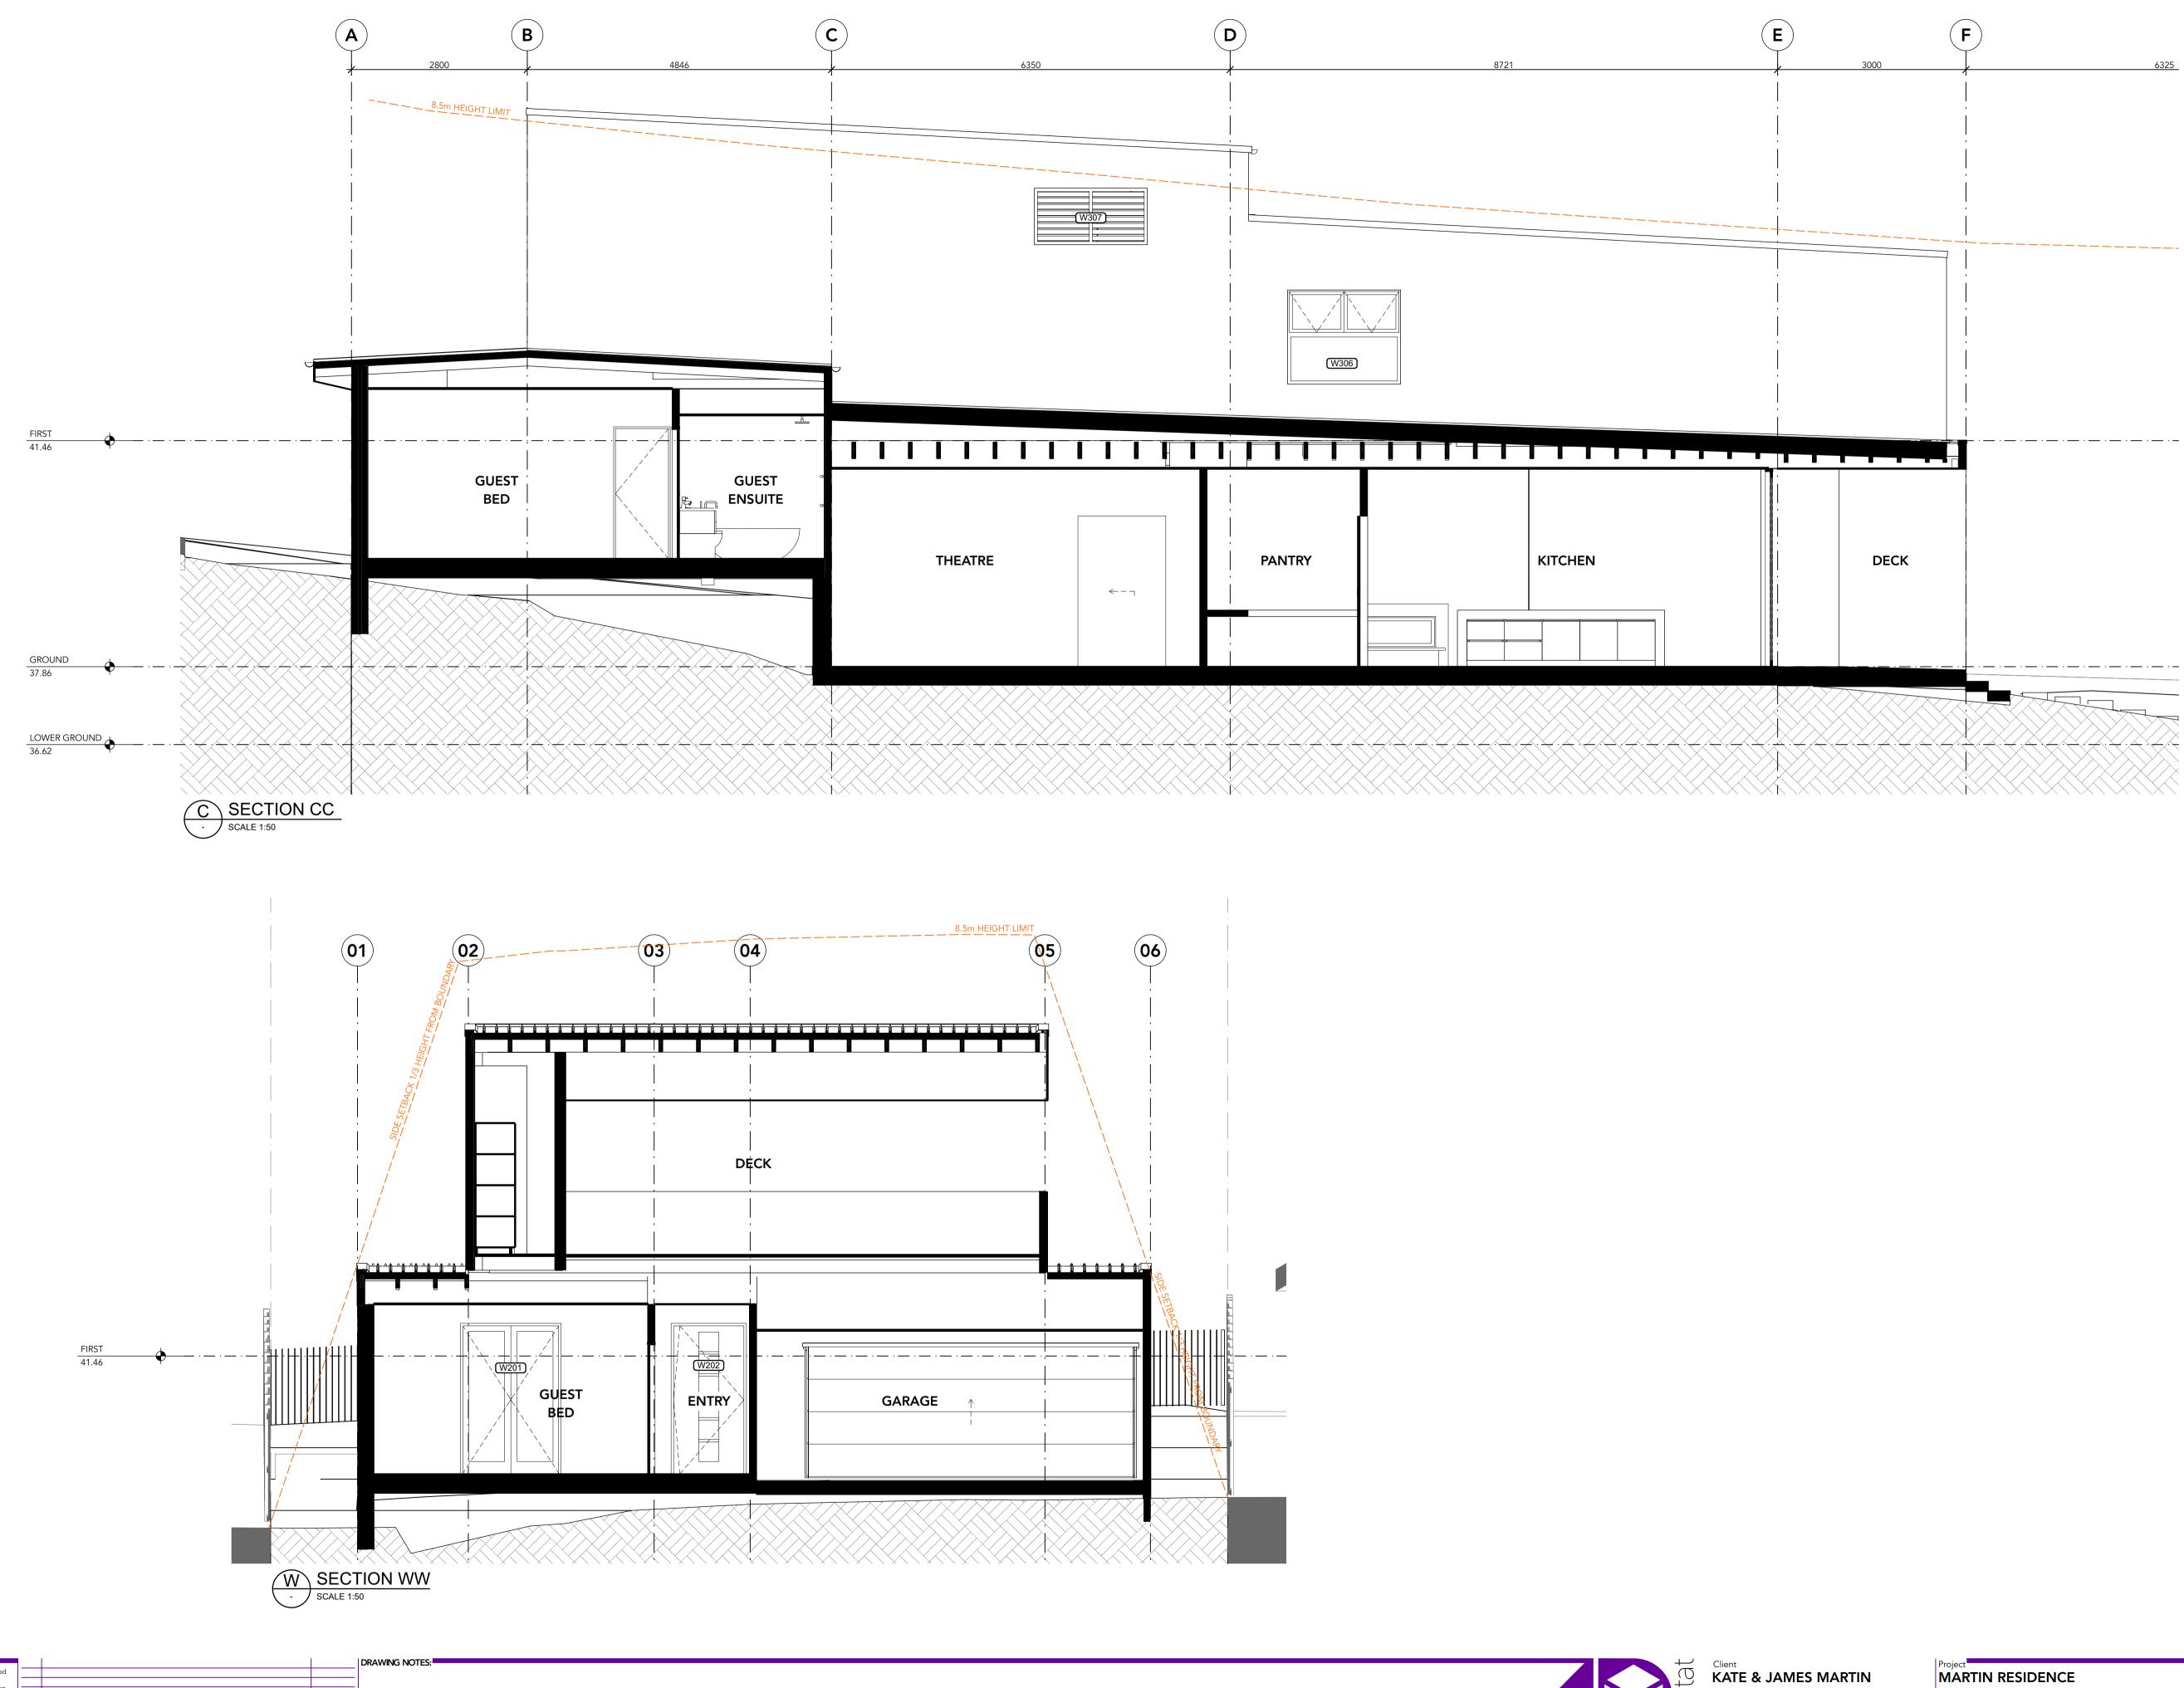

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PRIOR TO USE FOR BUILDING CONSTRUCTION		
THE BUILDER MUST ENSURE THEY ARE IN		
POSSESSION OF A CC AND ALL OTHER	01	DEVELOPMENT APF
REQUIRED COUNCIL APPROVALS	Rev	Change Name

GENERAL NOTES:

PLICATION 03/12/21 Date



14 ERNEST STREET BALGOWLAH HEIGHTS, NSW 2093

14 ERNEST STREET, BALGOWLAH HEIGHTS, NSW 2093 Status SKETCH DESIGN Drawing Title SECTIONS - SHEET 2 ^{Scale} **1:50** @A1





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GENERAL NOTES:

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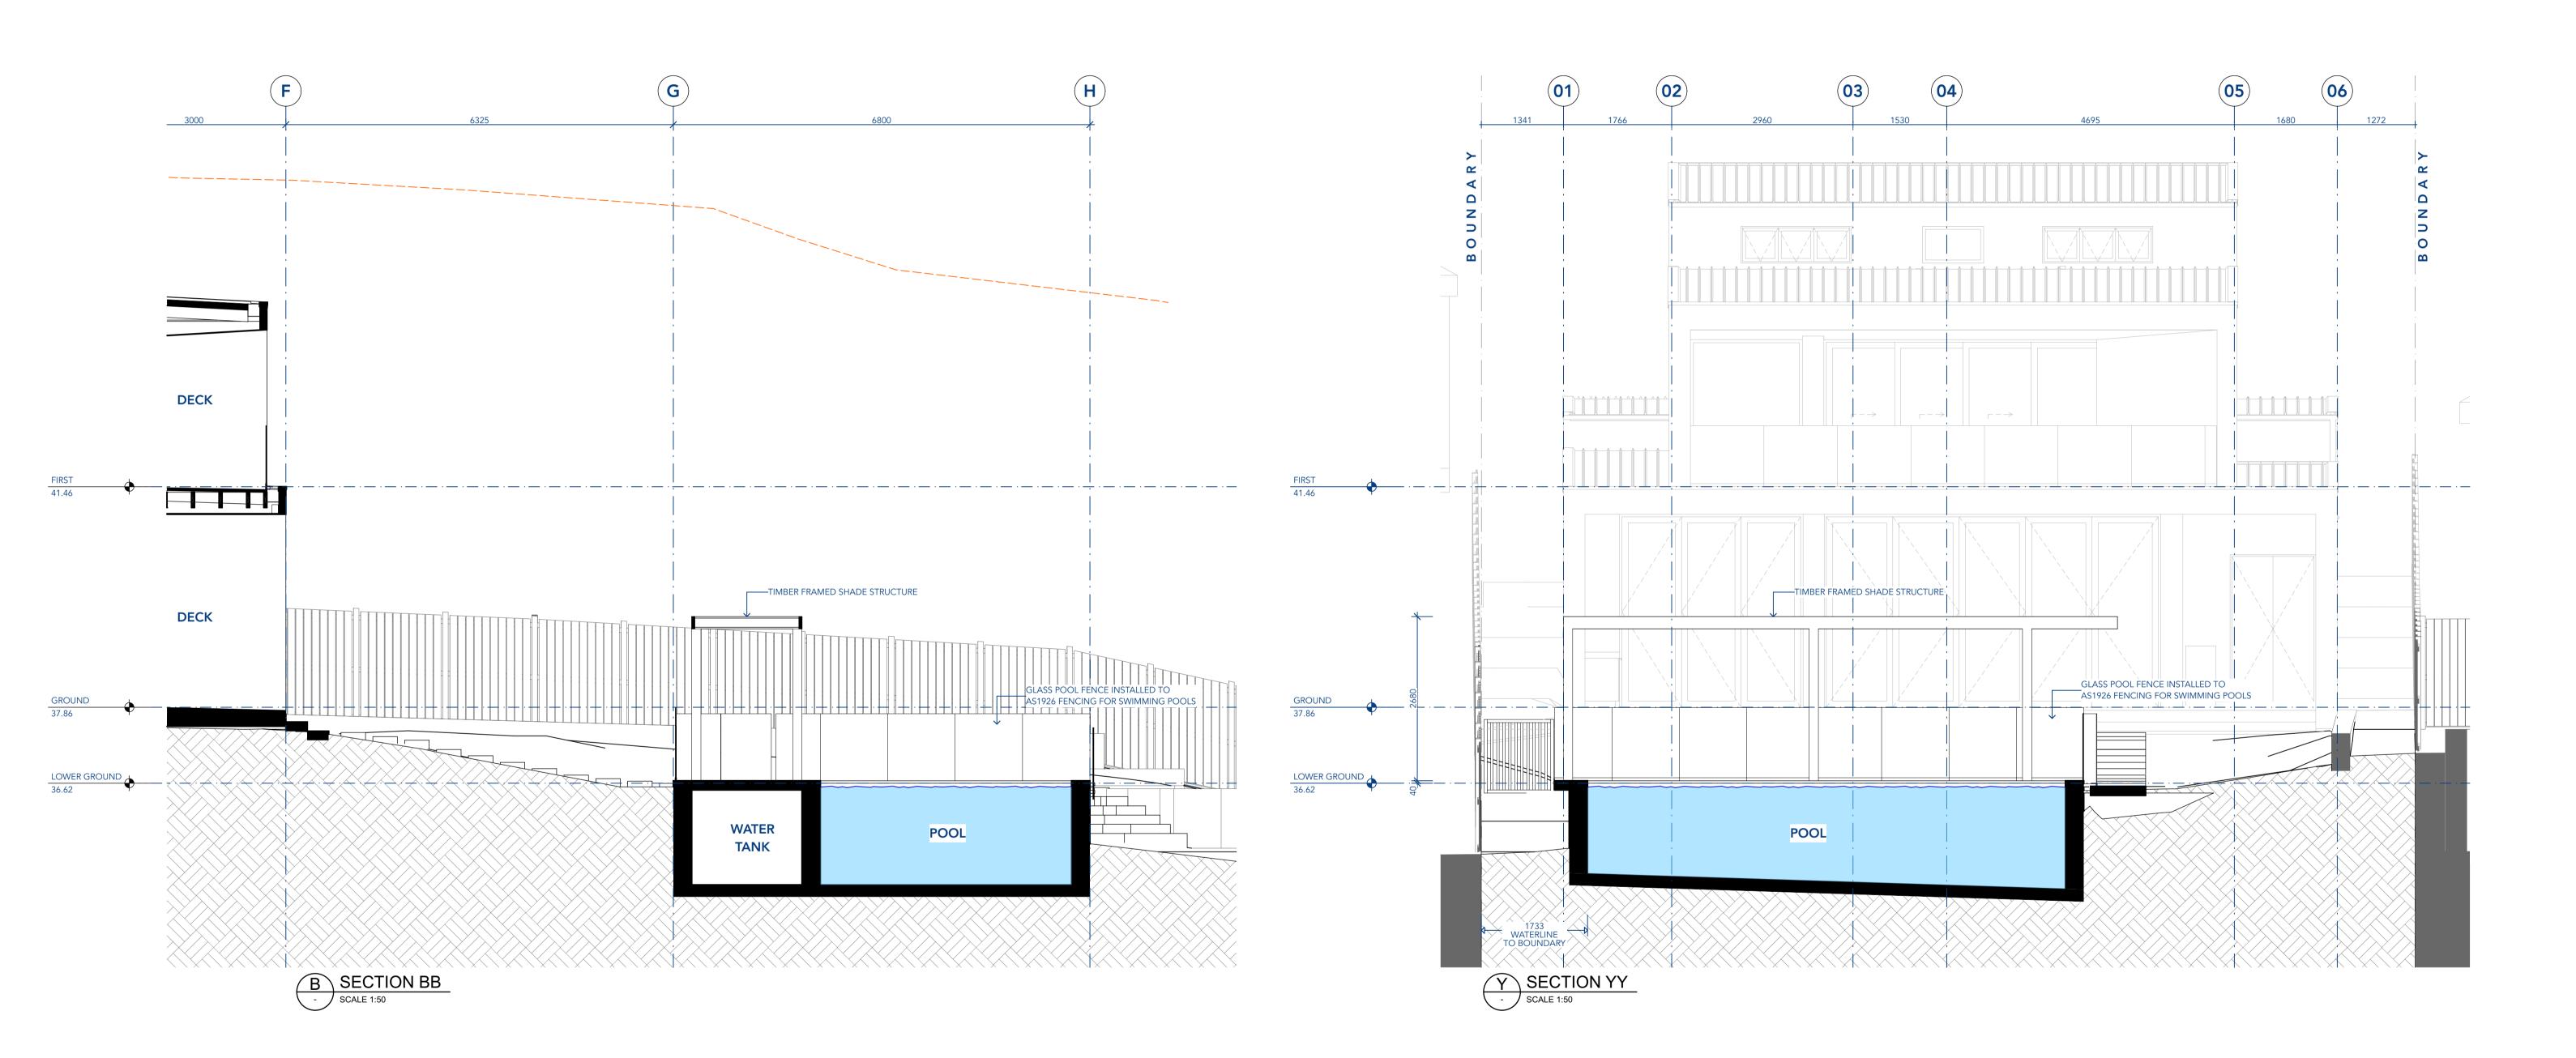
03/12/21 Date



Client KATE & JAMES MARTIN 14 ERNEST STREET BALGOWLAH HEIGHTS, NSW 2093


MARTIN RESIDENCE 14 ERNEST STREET, BALGOWLAH HEIGHTS, NSW 2093 Status SKETCH DESIGN Drawing Title **SECTIONS - SHEET 3** ^{Scale} **1:50** @A1






GENERAL NOTES:				DRAWING NOTES:
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D Habitat holds no liability for any loss, damage,				
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eceipt of drawings issued in DWG or PDF format.				
RIOR TO USE FOR BUILDING CONSTRUCTION				
THE BUILDER MUST ENSURE THEY ARE IN				
OSSESSION OF A CC AND ALL OTHER	01	DA - POOL SECTIONS	04/04/22	
REQUIRED COUNCIL APPROVALS	Rev	Change Name	Date	
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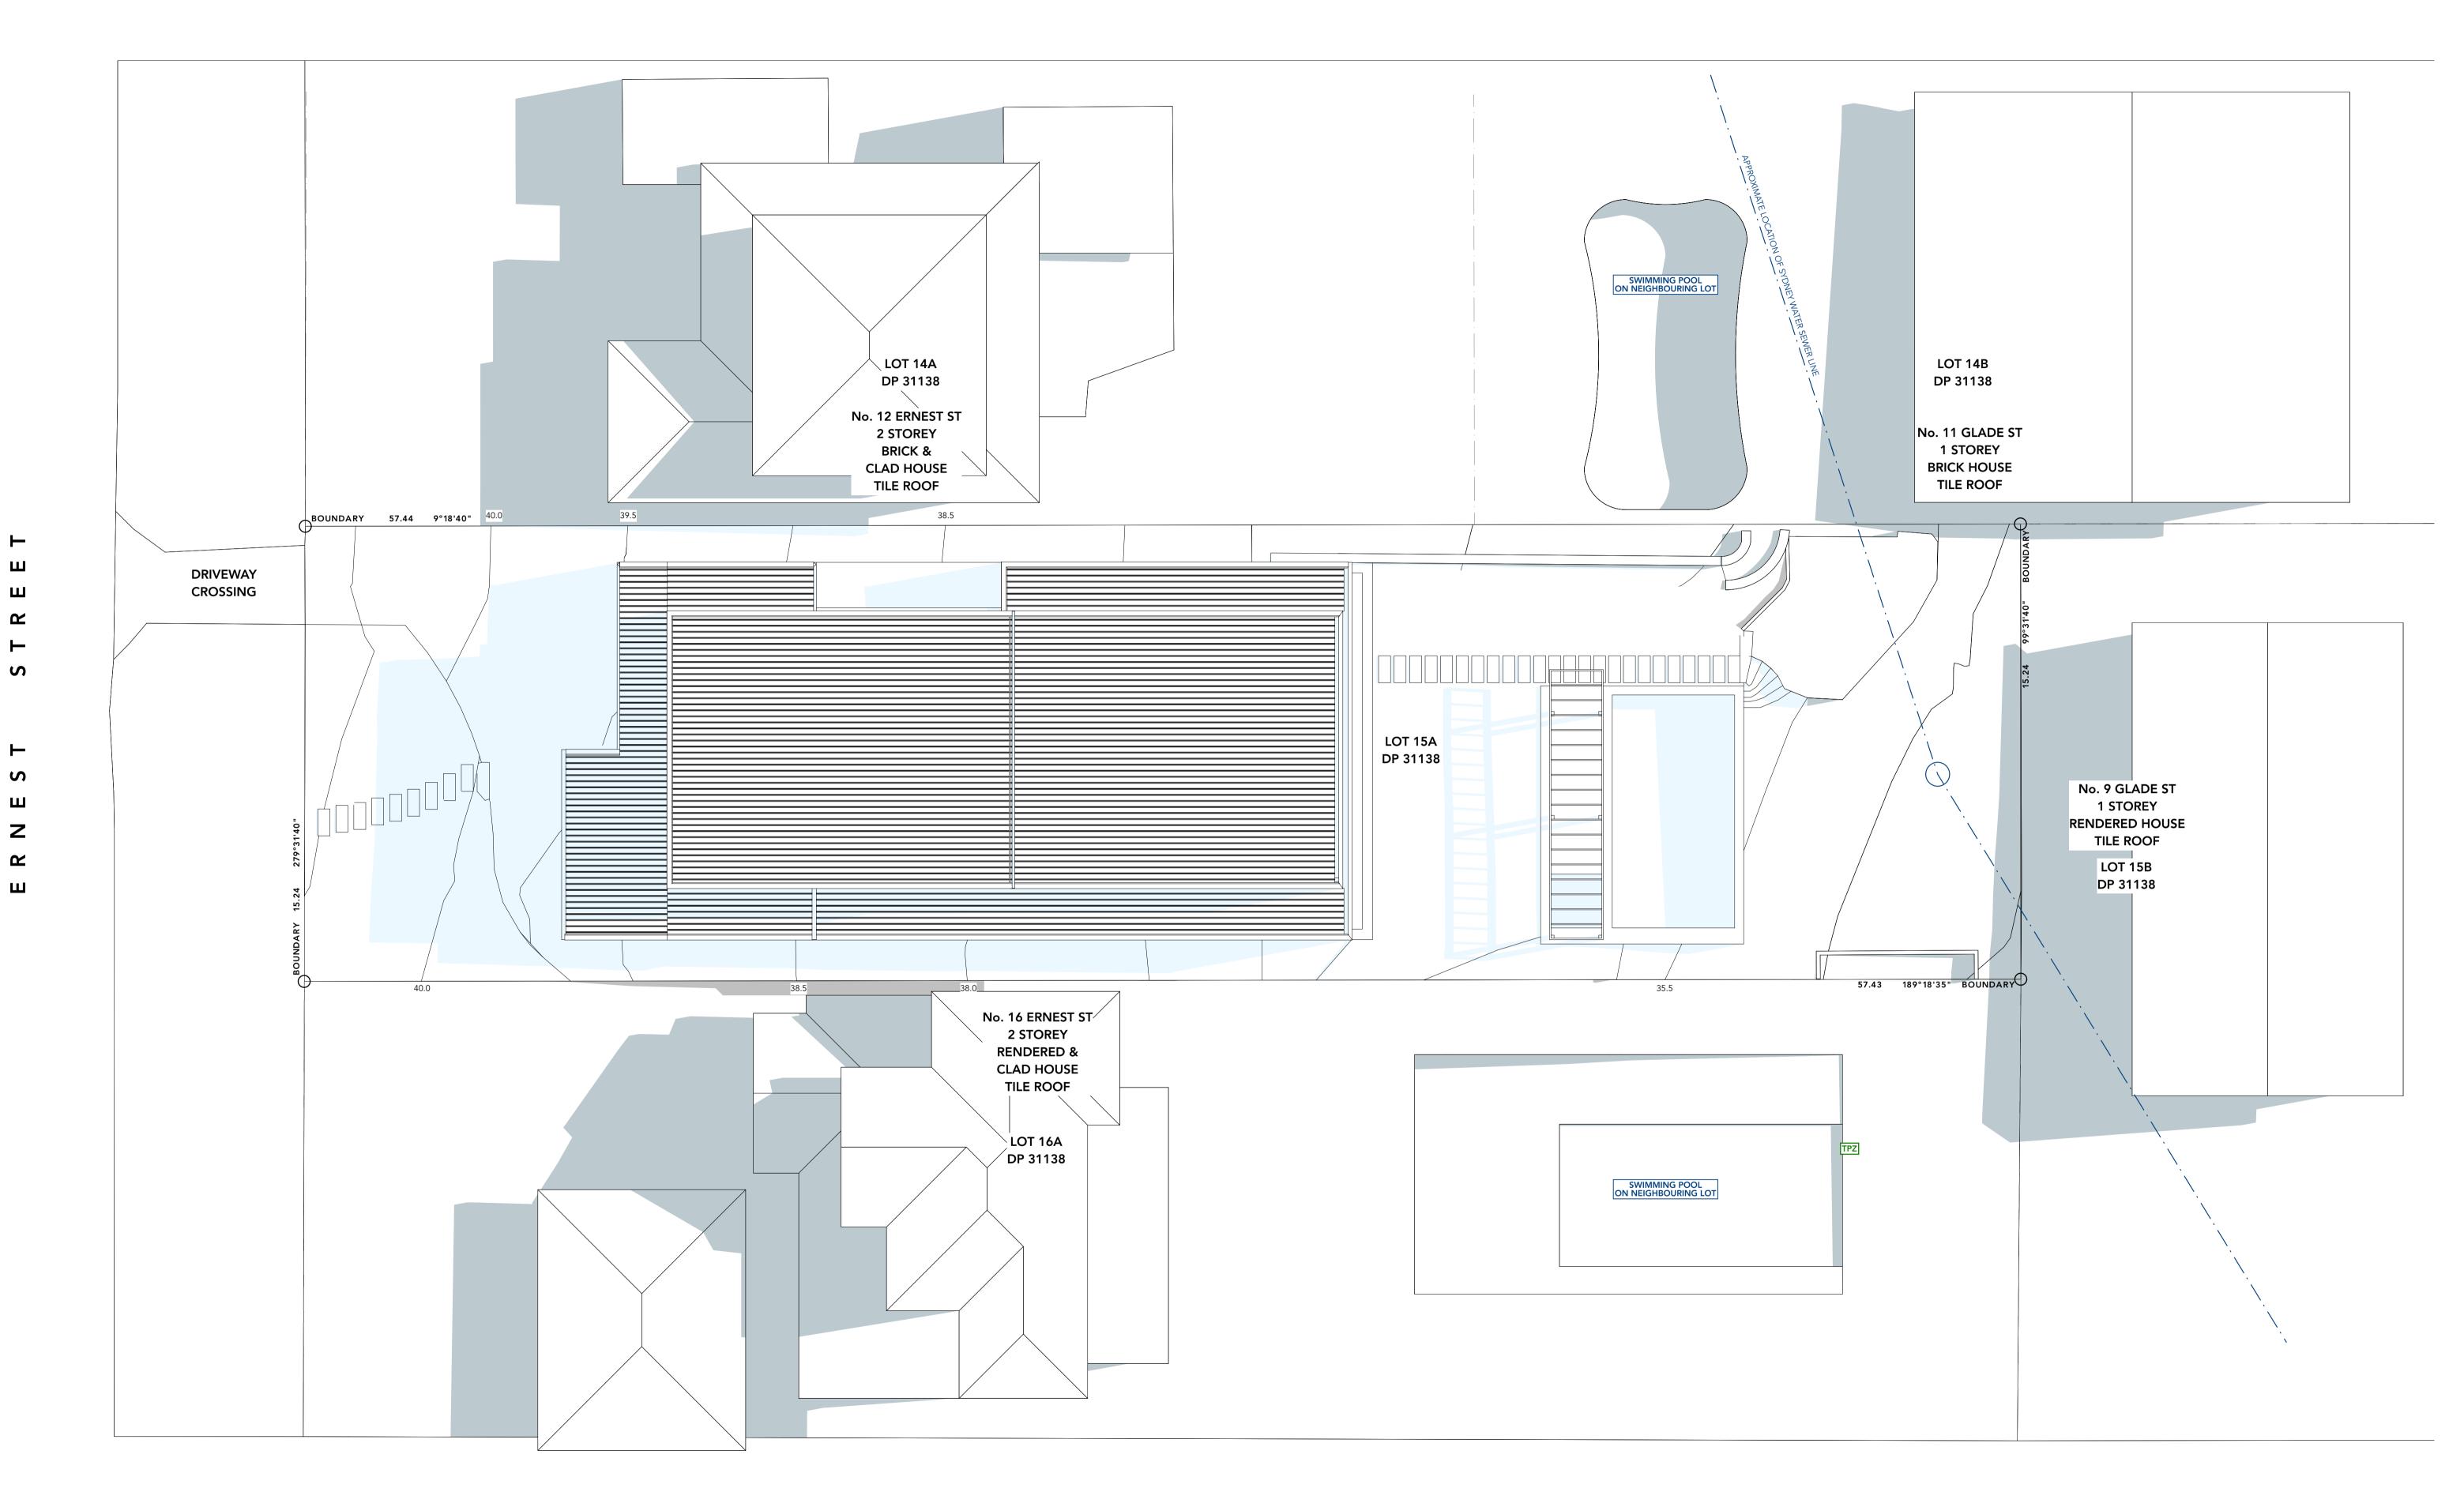


GENERAL NOTES:				DRAWING	NOTES:
Do not scale from this drawing. Use figured					
dimensions only.					
For any discrepancies in documentation contact 3D					EXISTING SHADOWS REMOVED
Habitat for clarifications if required.					
3D Habitat holds no liability for any loss, damage,					
claim or cost demand as a result of the use or					
receipt of drawings issued in DWG or PDF format.					EXISTING SHADOWS REMAINING
PRIOR TO USE FOR BUILDING CONSTRUCTION			4.4/00/00		
THE BUILDER MUST ENSURE THEY ARE IN	02	DA REVISION	14/03/22		
POSSESSION OF A CC AND ALL OTHER	01	DEVELOPMENT APPLICATION	03/12/21		
REQUIRED COUNCIL APPROVALS	Rev	Change Name	Date		NEW SHADOWS
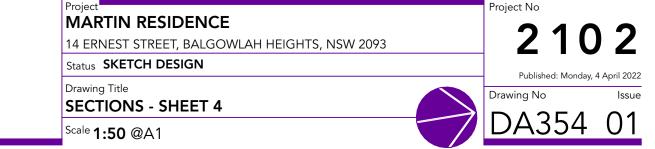
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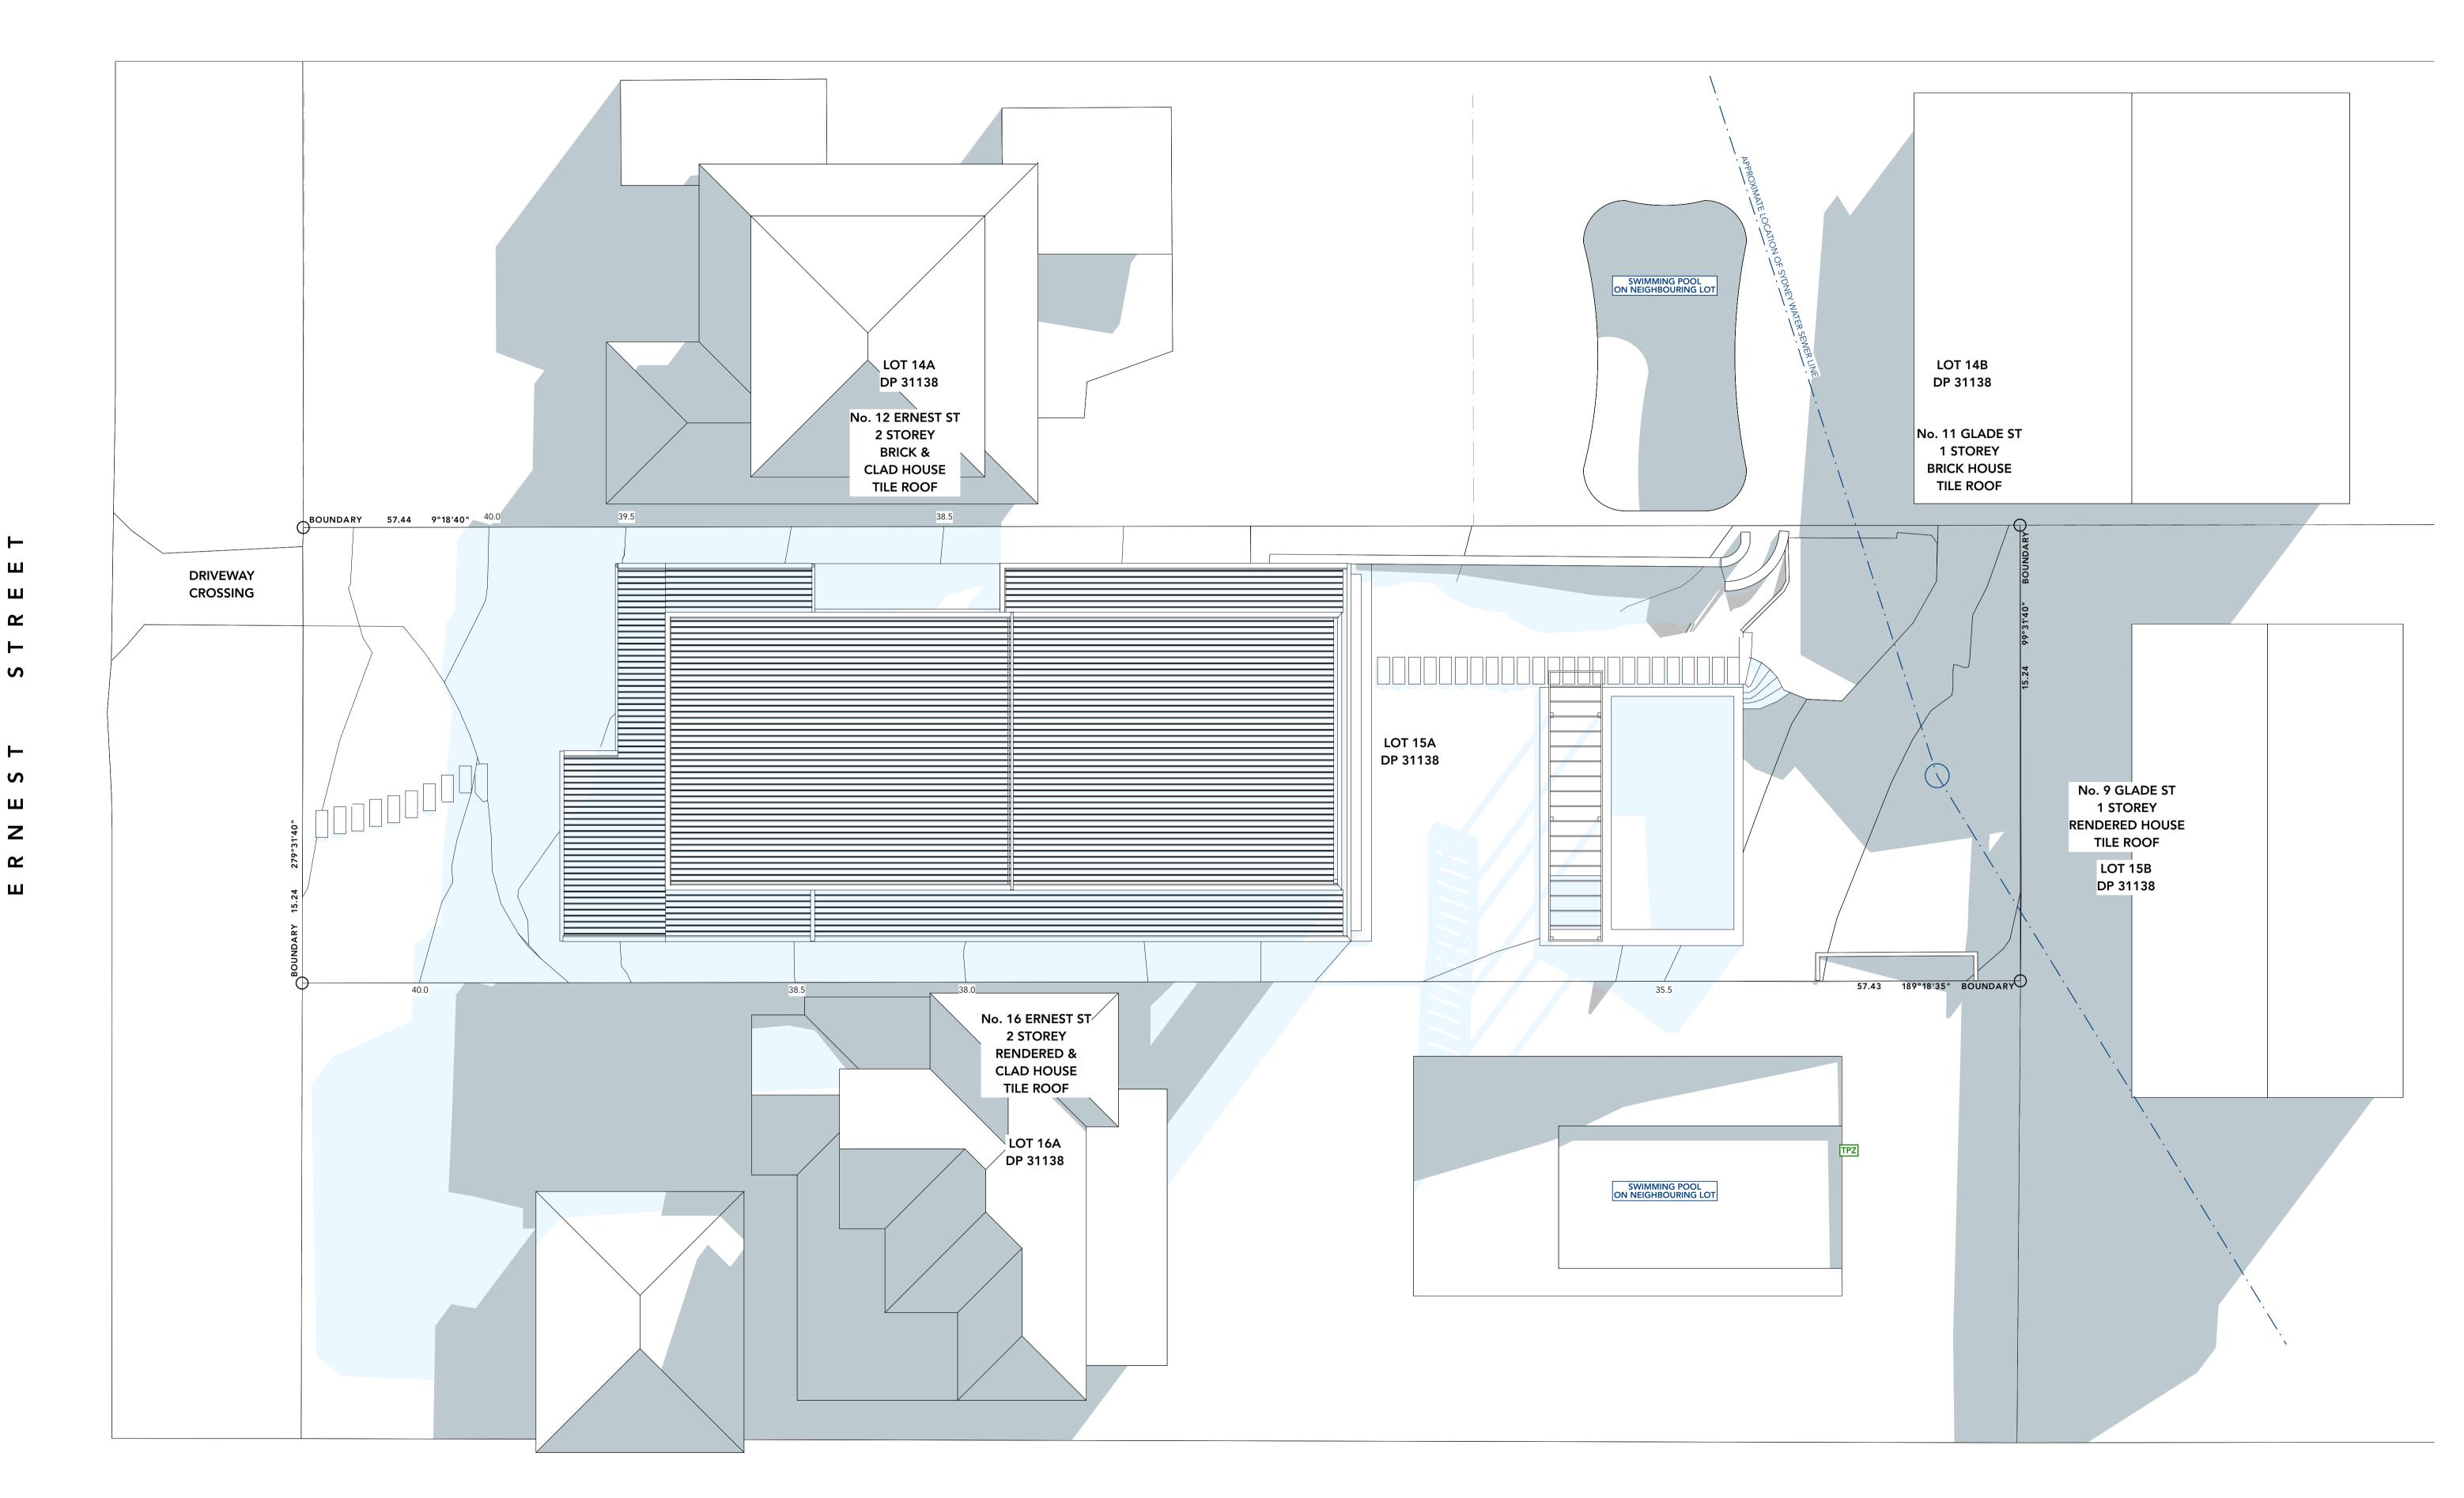
DRAWING NOTES: GENERAL NOTES: Do not scale from this drawing. Use figured dimensions only. For any discrepancies in documentation contact 3D Habitat for clarifications if required. 3D Habitat holds no liability for any loss, damage, claim or cost demand as a result of the use or receipt of drawings issued in DWG or PDF format. EXISTING SHADOWS REMOVED EXISTING SHADOWS REMAINING PRIOR TO USE FOR BUILDING CONSTRUCTION THE BUILDER MUST ENSURE THEY ARE IN POSSESSION OF A CC AND ALL OTHER REQUIRED COUNCIL APPROVALS Change Name 14/03/22 03/12/21 Date NEW SHADOWS
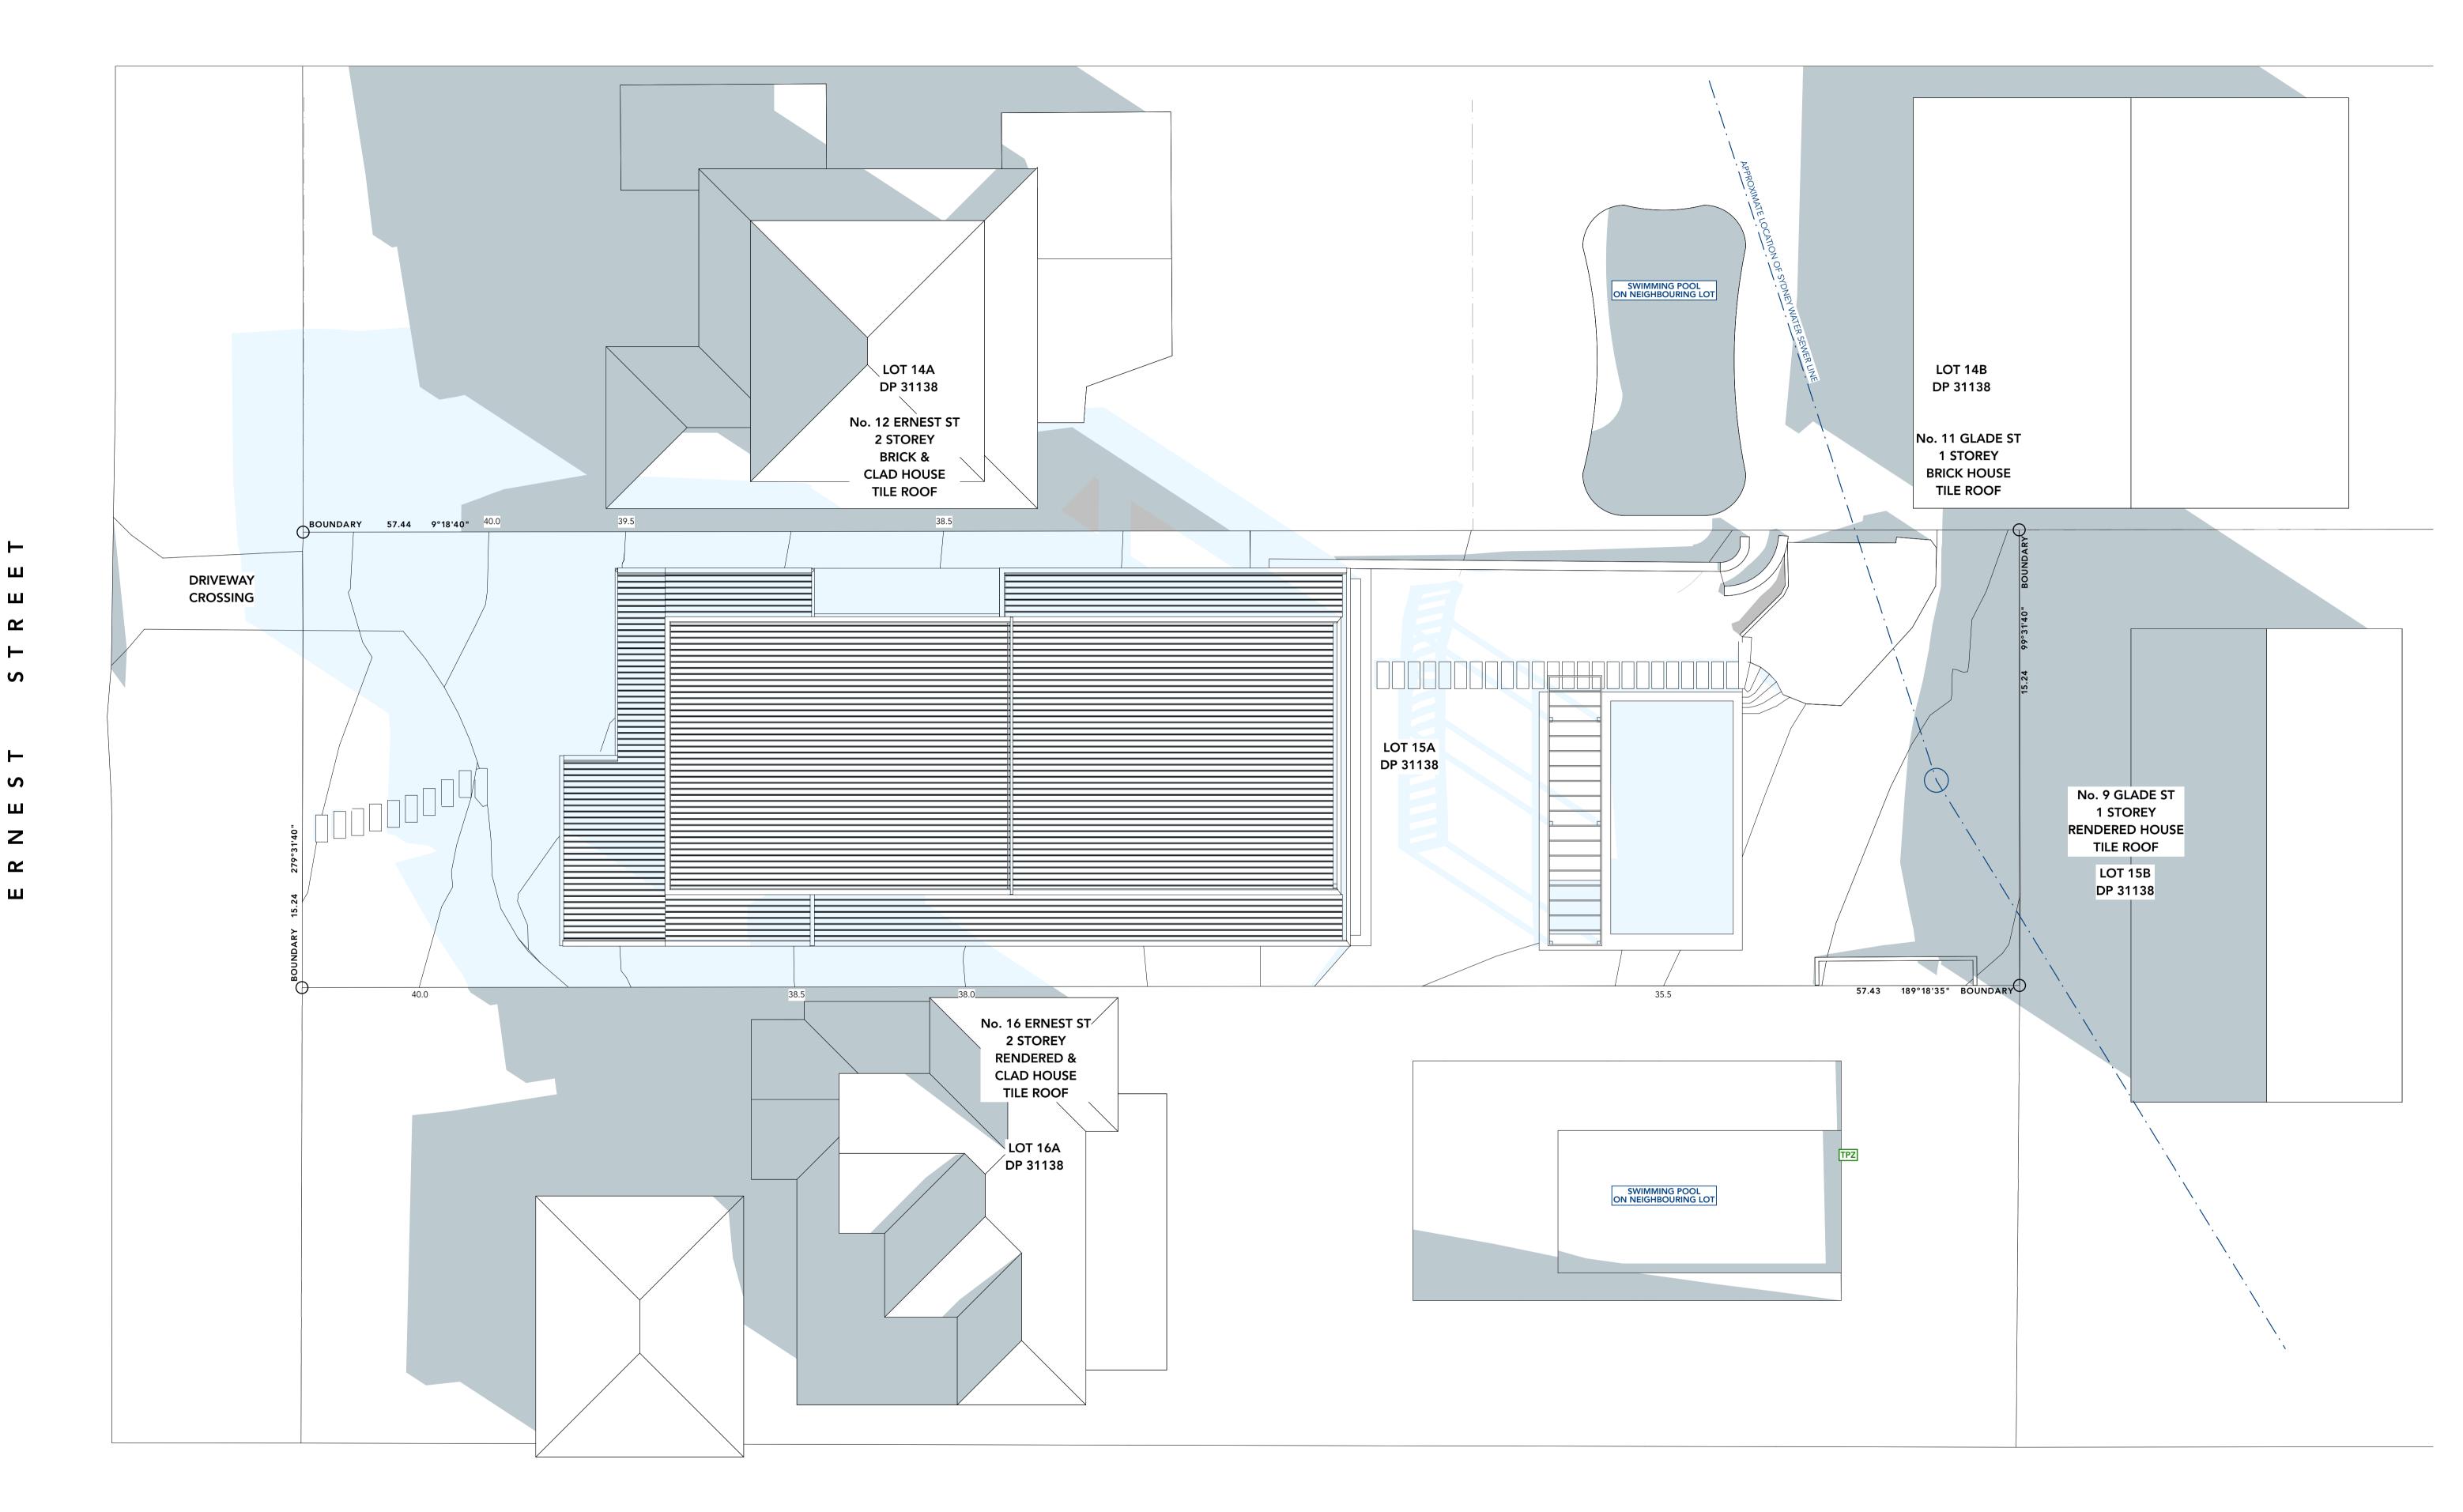
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14 ERNEST STREET BALGOWLAH HEIGHTS, NSW 2093





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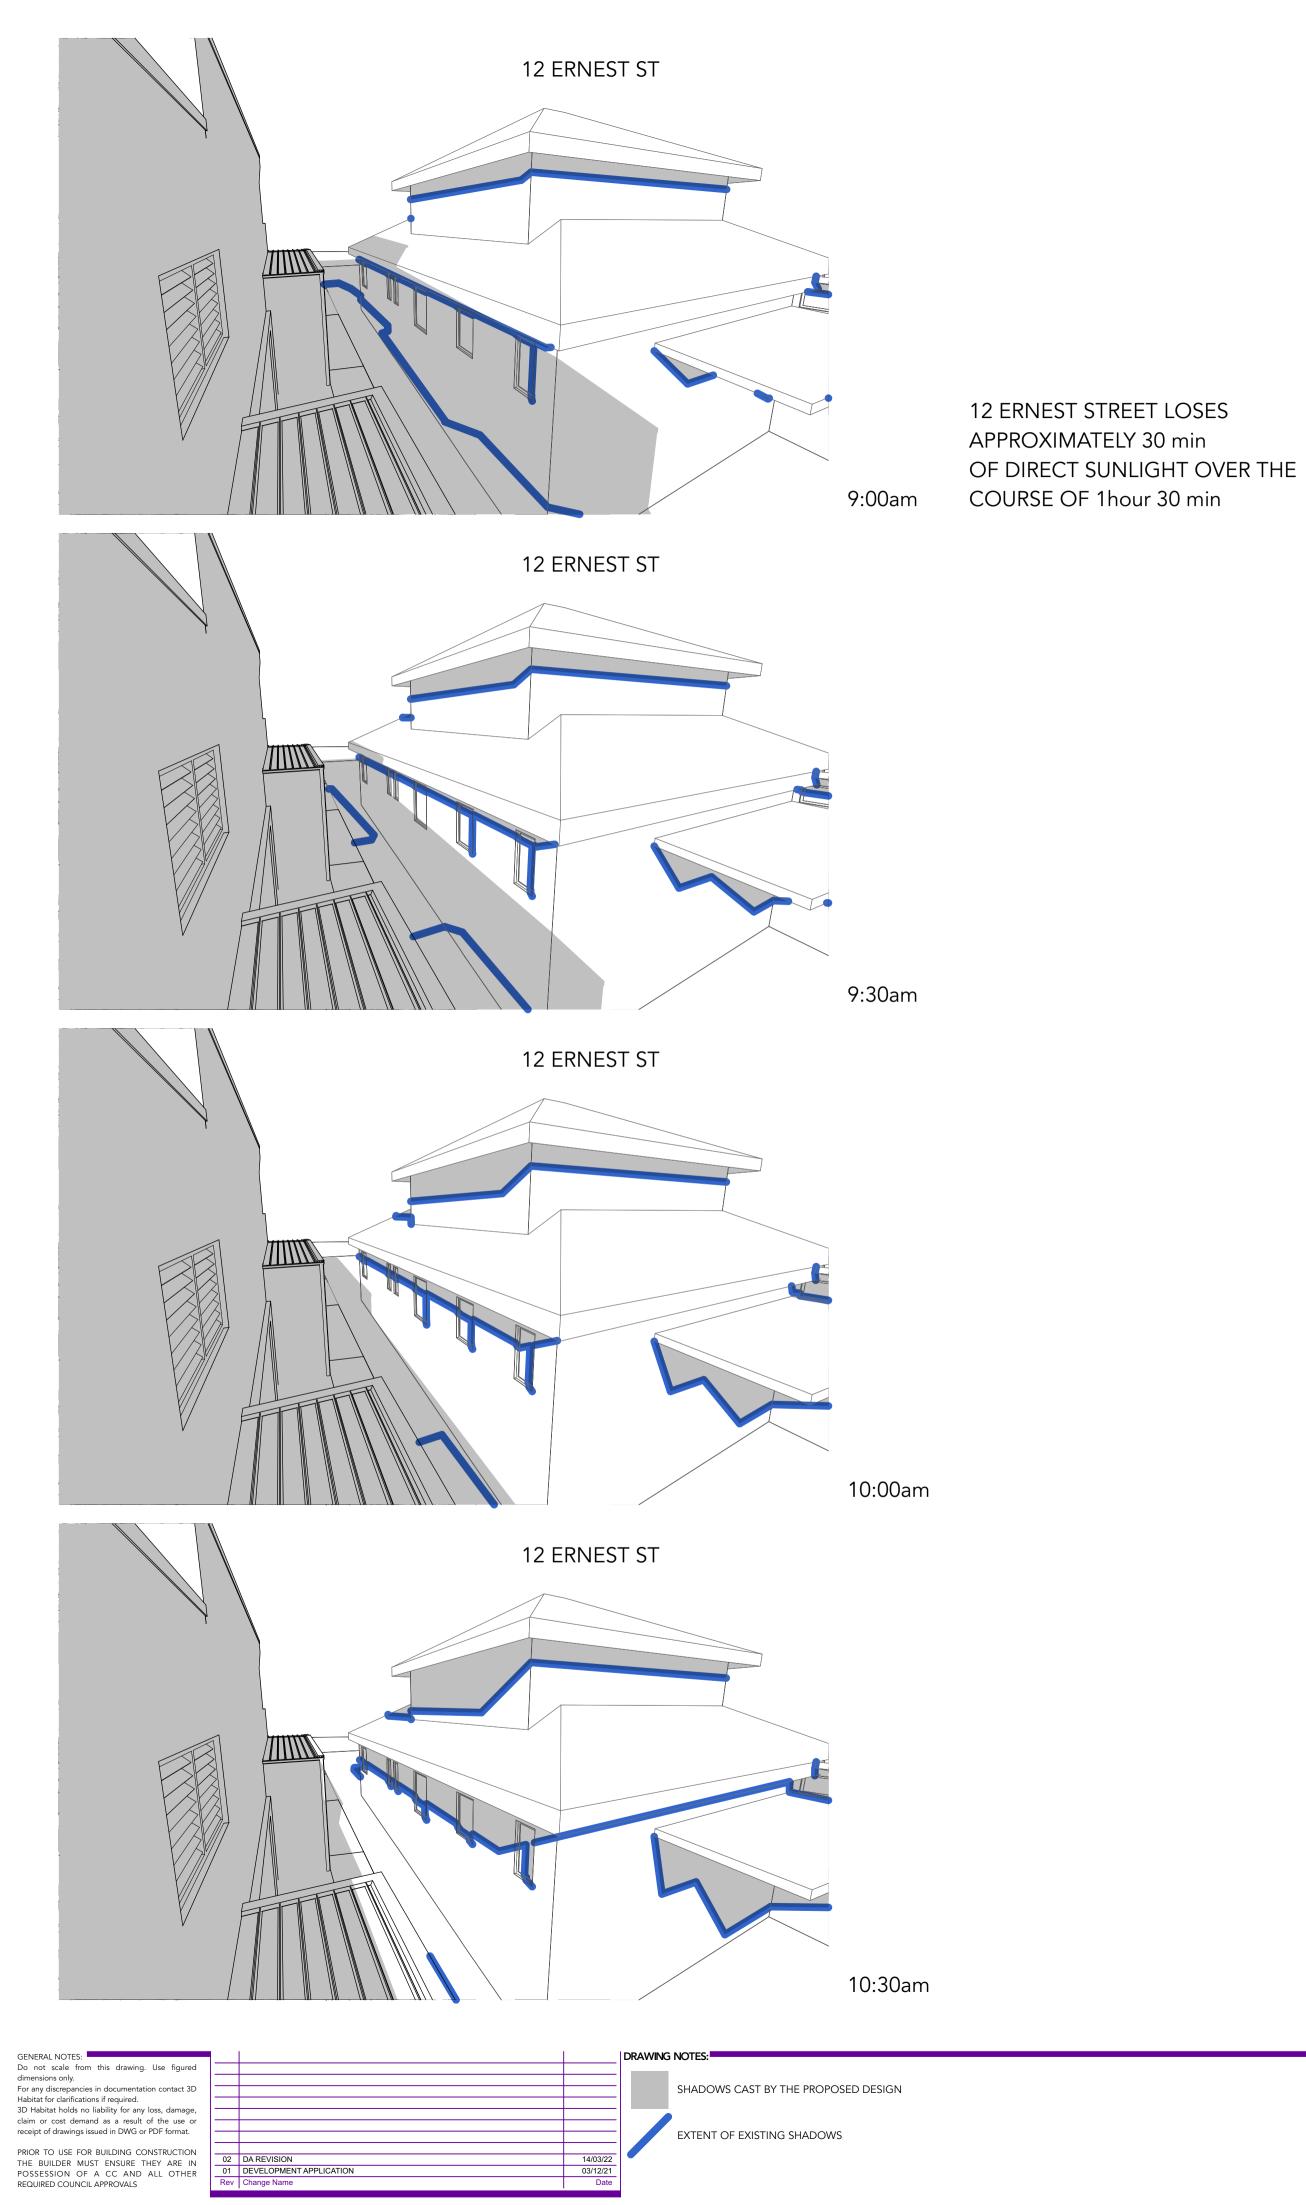
14 ERNEST STREET BALGOWLAH HEIGHTS, NSW 2093




I Project MARTIN RESIDENCE 14 ERNEST STREET, BALGOWLAH HEIGHTS, NSW 2093 Status SKETCH DESIGN Drawing Title

SUN SHADOW DIAGRAMS - SHEET 3 ^{Scale} 1:100 @A1





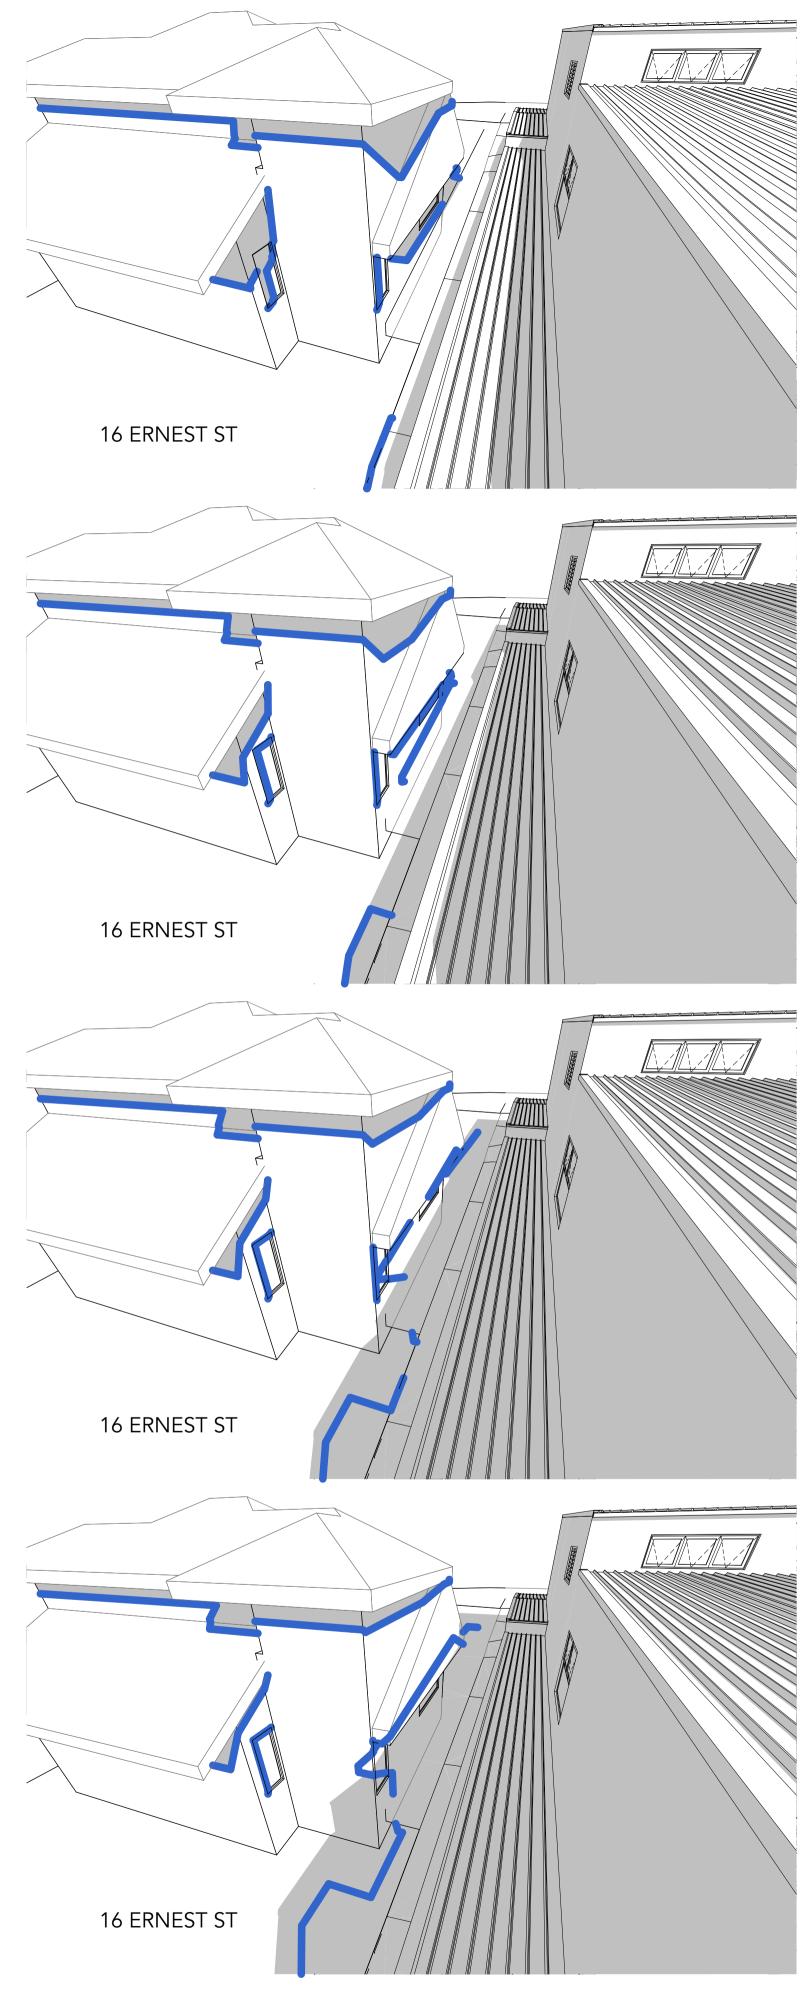



16 ERNEST STREET GAINS 12:00pm ADDITIONAL SOLAR ACCESS


12:30pm

1:00pm

1:30pm

MARTIN RESIDENCE 14 ERNEST STREET, BALGOWLAH HEIGHTS, NSW 2093 Status SKETCH DESIGN Drawing Title SUN SHADOW DIAGRAM - NEIGHBOURS ^{Scale} @A1



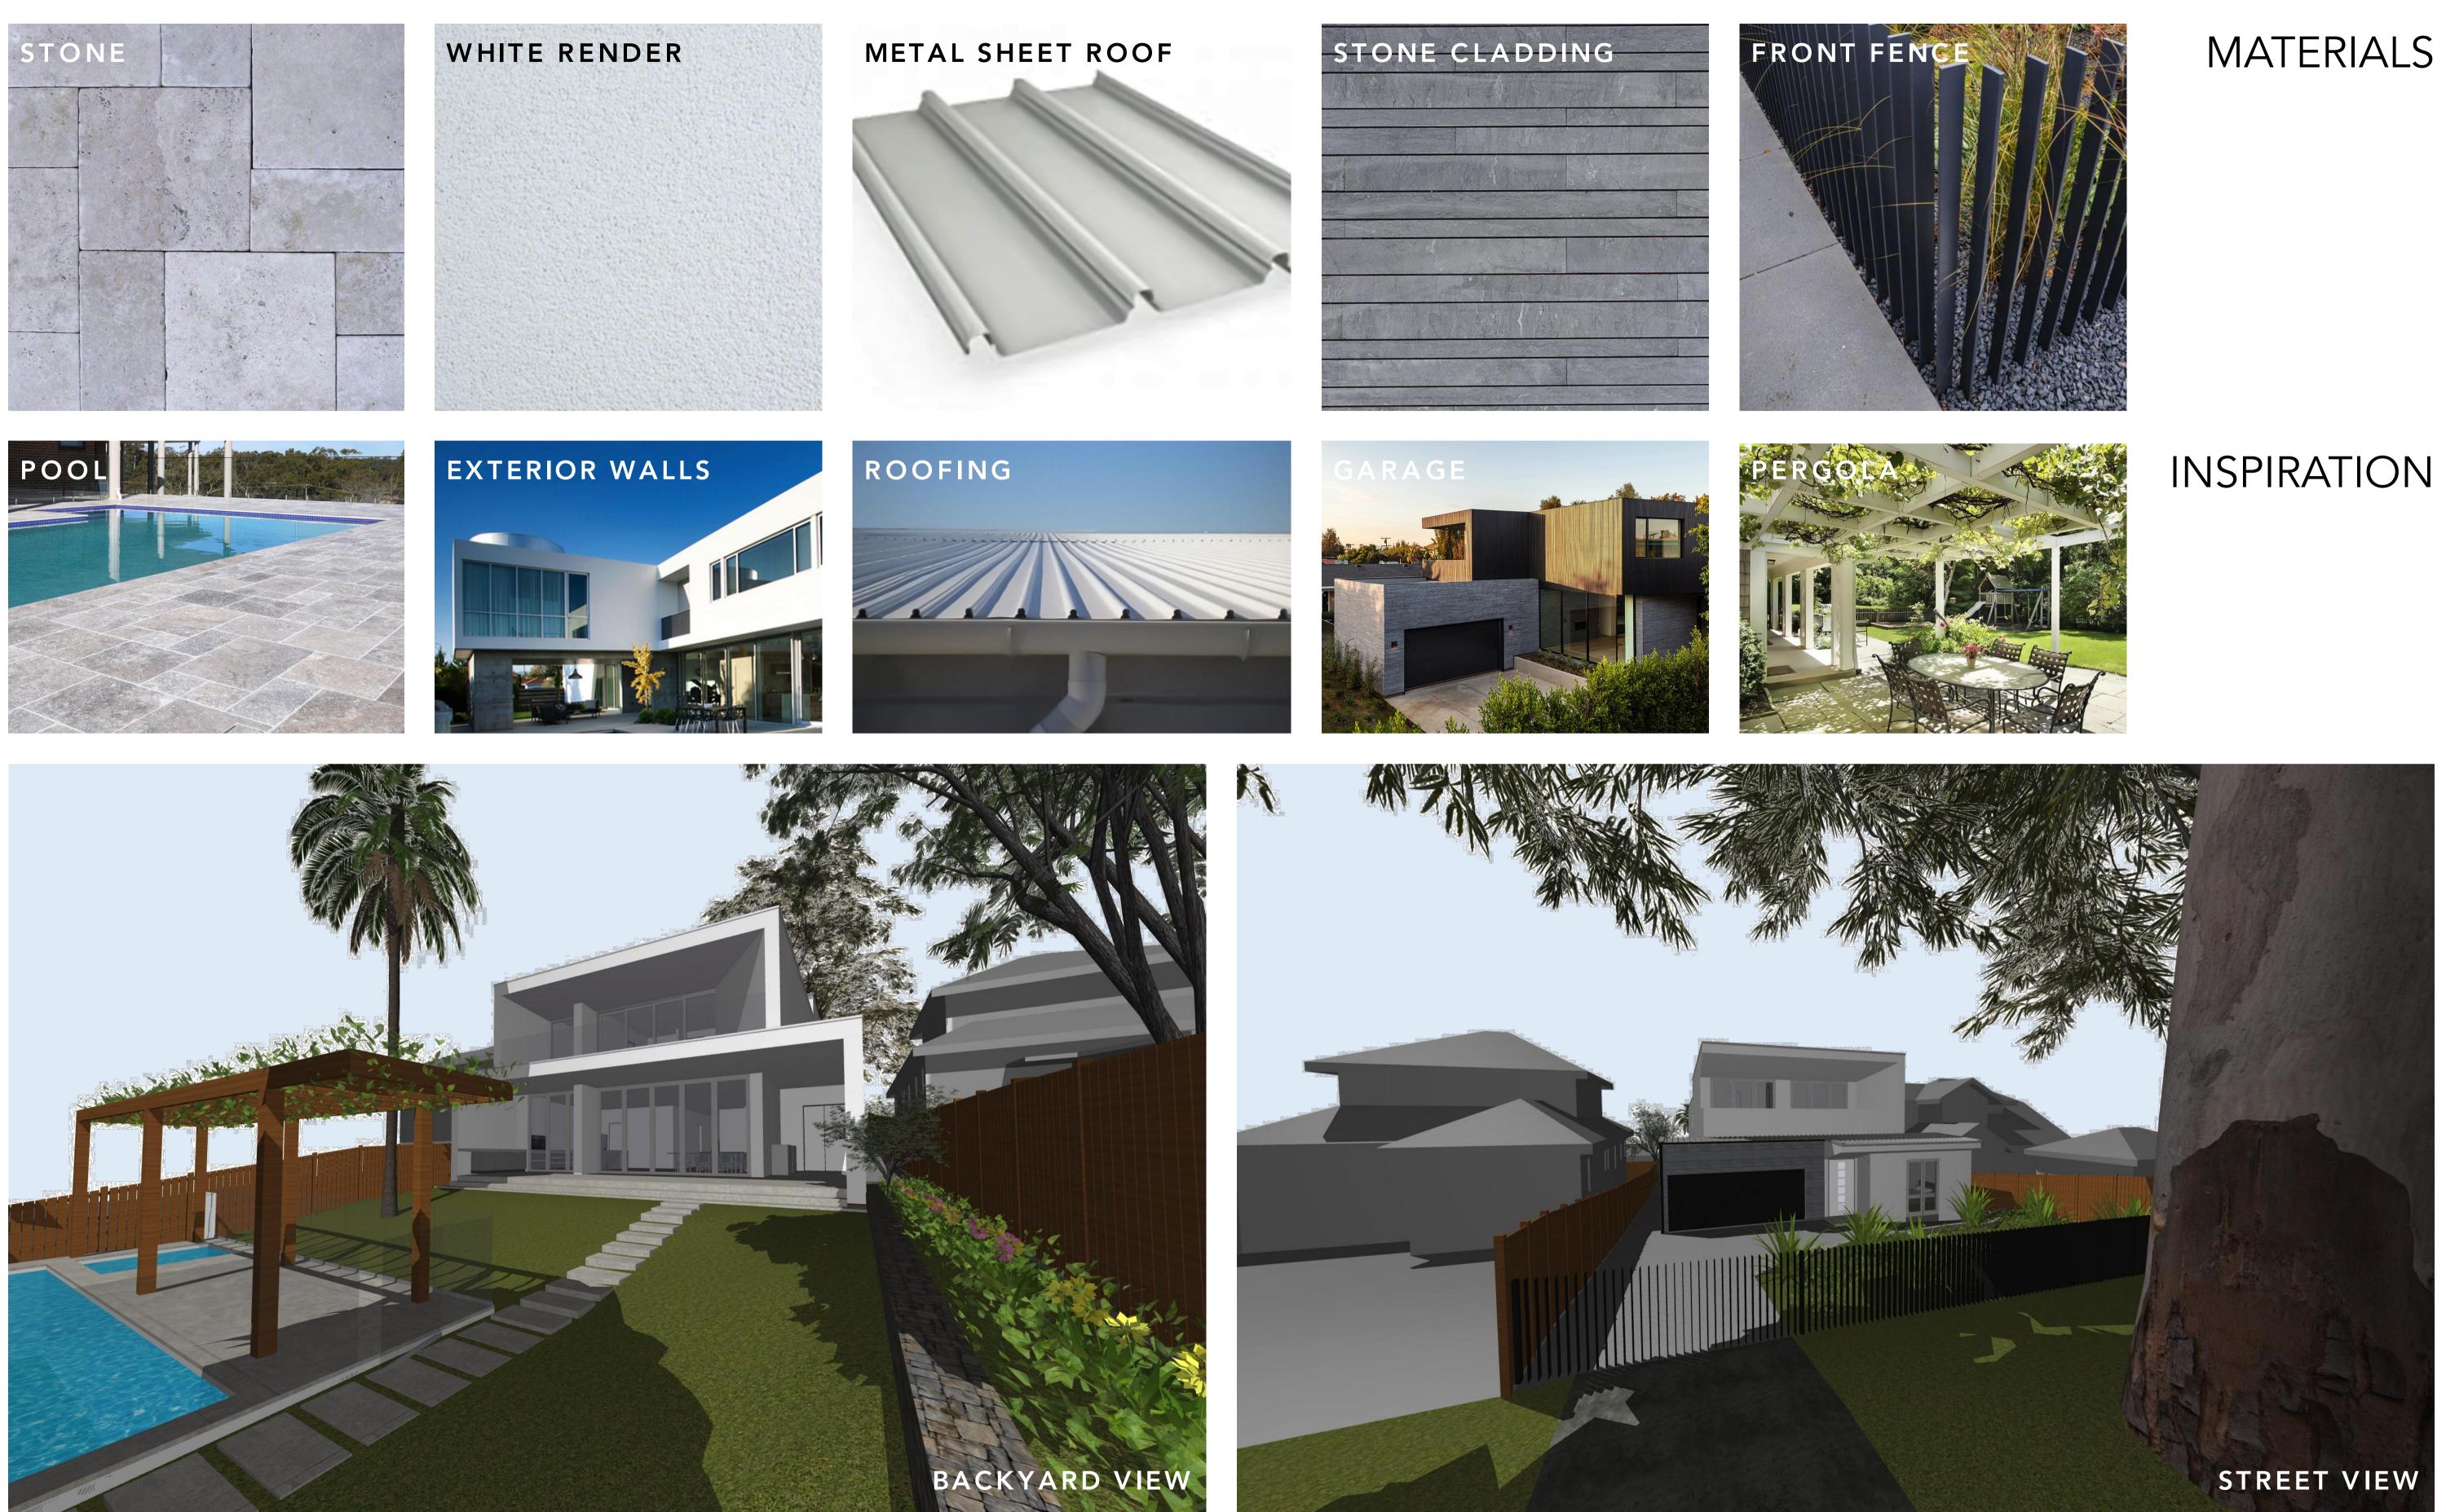

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PRIOR TO USE FOR BUILDING CONSTRUCTION	
THE BUILDER MUST ENSURE THEY ARE IN	
POSSESSION OF A CC AND ALL OTHER	01 DEVELOPMENT APPLICATION
REQUIRED COUNCIL APPROVALS	Rev Change Name

DRAWING NOTES:		














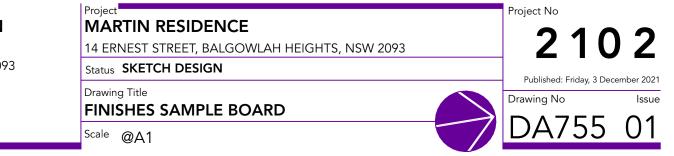

BASIX[°]Certificate

Building Sustainability Index www.basix.nsw.gov.au

Single Dwelling Certificate number: 1260066S

Secretarv

NSW | Planning, Industry & Environment

This certificate confirms that the proposed development will meet the NSW government's requirements for sustainability, if it is built in accordance with the commitments set out below. Terms used in this certificate, or in the commitments, have the meaning given by the document entitled "BASIX Definitions" dated 10/09/2020 published by the Department. This document is available at www.basix.nsw.gov.au

Date of issue: Friday, 03 December 2021 To be valid, this certificate must be lodged within 3 months of the date of issue.

2102_Martin		
14 Ernest Street Balgowlah Heights 2093		
Northern Beaches Council		
deposited 31138		
15A		
-		
separate dwelling house		
4		
V 45 Target 40		
V Pass Target Pass		
V 81 Target 50		

Project address
Project name
Street address
Local Government Area
Plan type and plan number
Lot no.
Section no.
Project type
Project type
No. of bedrooms
Site details
Site area (m ²)
Roof area (m ²)
Conditioned floor area (m2)
Unconditioned floor area (n
Total area of garden and la

BASIX Planning, Industry & Environment www.basix.nsw.

page 1/10

page 4/10

Vater Commitments	Show on DA plans	Show on CC/CDC plans & specs	Certifier check
he swimming pool must have a pool cover.		~	
he swimming pool must be outdoors.	✓	~	
Dutdoor Spa	· · ·		
he spa must not have a volume greater than 3.7 kilolitres.	✓	~	
he spa must have a spa cover.		~	
he spa must be shaded.	~	~	

BASIX Planning, Industry & Environment www.basix.nsw.gov.au Version: 3.0 / DARWINIA_3_18_5 Certificate No.: 1260066S Friday, 03 December 2021

Certificate Prepared by Name / Company Name: 3D Habitat ABN (if applicable): 22183198234

BASIX Planning, Industry & Environment www.basix.nsw.gov.au Version: 3.0 / DARWINIA_3_18_5 Certificate No.: 1260066S Friday, 03 December 2021

Window/glazed door no.	Maximum height (mm)	Maximum width (mm)	Туре	Shading Device (Dimension within 10%)	Overshadowing
W402	600	1000	aluminium, single, clear	none	not overshadowed
W403	600	1800	aluminium, single, clear	none	not overshadowed
East facing					
W205	600	3400	aluminium, single, clear	none	>4 m high, 2-5 m away
W306	1500	1800	aluminium, single, clear	none	not overshadowed
W307	900	1800	aluminium, single, clear	none	not overshadowed
South facing				·	
W201	2400	1600	aluminium, single, clear	none	not overshadowed
W202	2400	1200	timber/UPVC/fibreglass, single, clear	none	not overshadowed
W301	2400	3000	aluminium, single, clear	eave 1800 mm, 0 mm above head of window or glazed door	not overshadowed
W302	2400	3000	aluminium, single, clear	eave 1800 mm, 0 mm above head of window or glazed door	not overshadowed
West facing					
W303	900	1800	aluminium, single, clear	none	not overshadowed
W302 West facing W303				window or glazed door	

Energy Commitments Hot water The applicant must install the followi instantaneous with a performance of Cooling system The applicant must install the following ducting only; Energy rating: n/a The applicant must install the following ducting only; Energy rating: n/a Heating system The applicant must install the following heater; Energy rating: 5 Star The applicant must install the following ducting only; Energy rating: n/a Ventilation The applicant must install the following At least 1 Bathroom: individual fan, Kitchen: individual fan, ducted to fa Laundry: individual fan, ducted to fa Artificial lighting The applicant must ensure that the "p following rooms, and where the word light emitting diode (LED) lamps: at least 4 of the bedrooms / study at least 4 of the living / dining roo the kitchen; dedicated BASIX Planning, Industry & Environment www.basix.nsw.gov.au Version: 3.0 / DARWINIA_3_18_5 Certificate No.: 1260066S Friday, 03 December 2021

BASIX	Planning, Industry & Environment	www.basix.nsw.gov.au	Version: 3.0 / DARWINIA_3_18_5	Certificate No.: 1260066S	Friday, 03 December 2021

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REQUIRED COUNCIL APPROVALS

		_
		-
01	DEVELOPMENT APPLICATION	03/12/21
Rev	Change Name	Date

RAWING NOTES:

In these commitments, "applicant" means the person carrying out the development. Commitments identified with a 🥥 in the "Show on DA plans" column must be shown on the plans accompanying the development application for the proposed development (if a development application is to be lodged for the proposed development). Commitments identified with a 🥪 in the "Show on CC/CDC plans and specs" column must be shown in the plans and specifications accompanying the application for a construction certificate / complying development certificate for the proposed development. Commitments identified with a 📢 in the "Certifier check" column must be certified by a certifying authority as having been fulfilled, before a final occupation certificate(either interim or final) for the development may be issued.

page 7/10

Description of project

	Assessor details and thermal	loads	
2102_Martin	Assessor number	n/a	
14 Ernest Street Balgowlah Heights 2093	Certificate number	n/a	
Northern Beaches Council	Climate zone	n/a	
Deposited Plan 31138	Area adjusted cooling load (MJ/m².year)	n/a	
15A	Area adjusted heating load (MJ/m ² .year)	n/a	
-	Ceiling fan in at least one bedroom	n/a	
	Ceiling fan in at least one living room or other conditioned area	n/a	
separate dwelling house	Project score		
4	Project score		
	Water	45	Target 40
875	Thermal Comfort	V Pass	Target Pass
310		• • • • • • • • • • • • • • • • • • • •	raigett acc
260.0	Energy	V 81	Target 50
65.0			
325			

sw.gov.au	Version: 3.0 / DARWINIA_3_18_5	Certificate No.: 1260066S	Friday, 03 December 2021	page 2/10

	ons listed in the table	・ ・ ・ ・ ・		> > > >
The conditioned floor area of the dwelling must not exceed 300 square metres. The dwelling must not contain open mezzanine area exceeding 25 square metres. The dwelling must not contain third level habitable attic room. Floor, walls and ceiling/roof The applicant must construct the floor(s), walls, and ceiling/roof of the dwelling in accordance with the specification Construction Additional insulation required (R-Value)	ons listed in the table			
The dwelling must not contain open mezzanine area exceeding 25 square metres. The dwelling must not contain third level habitable attic room. Floor, walls and ceiling/roof The applicant must construct the floor(s), walls, and ceiling/roof of the dwelling in accordance with the specification Construction Additional insulation required (R-Value)	ons listed in the table			
The dwelling must not contain third level habitable attic room. Floor, walls and ceiling/roof The applicant must construct the floor(s), walls, and ceiling/roof of the dwelling in accordance with the specification Construction Additional insulation required (R-Value)	ons listed in the table	• • •		
The dwelling must not contain third level habitable attic room. Floor, walls and ceiling/roof The applicant must construct the floor(s), walls, and ceiling/roof of the dwelling in accordance with the specification Construction Additional insulation required (R-Value)	ons listed in the table	v v		
Floor, walls and ceiling/roof The applicant must construct the floor(s), walls, and ceiling/roof of the dwelling in accordance with the specificatio below. Construction Additional insulation required (R-Value)	ons listed in the table	~ ~	~	~
The applicant must construct the floor(s), walls, and ceiling/roof of the dwelling in accordance with the specification below. Construction Additional insulation required (R-Value)	ons listed in the table	~		
below. Construction Additional insulation required (R-Value)	ons listed in the table	~	<u> </u>	
		1	•	 ✓
floor - concrete slab on ground, 230 square metres nil				
floor - suspended floor above garage, framed nil				
external wall - brick veneer 2.86 (or 3.40 including construction)				
external wall - framed (weatherboard, fibre cement, metal clad) 3.00 (or 3.40 including construction)				
internal wall shared with garage - plasterboard nil				
ceiling and roof - flat ceiling / flat roof, framed ceiling: 4.5 (up), roof: foil backed blanket (75 mm)	lark (solar abs	orptance > 0.70)		
metres, framed nil floor - suspended floor above garage, framed nil external wall - brick veneer 2.86 (or 3.40 including construction)				
	fuero e el c	laula (a alau alau	0.70	
	named, c	iain (solai abs		

page 5/10

page 8/10

BASIX Planning, Industry & Environment www.basix.nsw.gov.au Version: 3.0 / DARWINIA_3_18_5 Certificate No.: 1260066S Friday, 03 December 2021

	Show on DA plans	Show on CC/CDC plans & specs	Certifier check
wing hot water system in the development, or a system with a higher energy rating: gas of 5 stars.	~	~	~
wing cooling system, or a system with a higher energy rating, in at least 1 living area: airconditioning		 Image: A set of the set of the	~
wing cooling system, or a system with a higher energy rating, in at least 1 bedroom: airconditioning		 Image: A set of the set of the	~
wing heating system, or a system with a higher energy rating, in at least 1 living area: gas fixed flued		~	~
wing heating system, or a system with a higher energy rating, in at least 1 bedroom: airconditioning		 	~
wing exhaust systems in the development:			
an, ducted to façade or roof; Operation control: manual switch on/off		_	_
façade or roof; Operation control: manual switch on/off			
o façade or roof; Operation control: manual switch on/off			
	I		
e "primary type of artificial lighting" is fluorescent or light emitting diode (LED) lighting in each of the ord "dedicated" appears, the fittings for those lights must only be capable of accepting fluorescent or			
ıdy; dedicated			
		✓	~
ooms; dedicated		 	~
		 Image: A set of the set of the	~
	E		

Schedule of BASIX commitments

The commitments set out below regulate how the proposed development is to be carried out development certificate issued, for the proposed development, that BASIX commitments be

Water Commitments	Show on DA plans	Show on CC/CDC plans & specs	Certifie check
Landscape			
The applicant must plant indigenous or low water use species of vegetation throughout 250 square metres of the site.	~	~	
Fixtures			
The applicant must install showerheads with a minimum rating of 4 star (> 4.5 but <= 6 L/min plus spray force and/or coverage tests) in all showers in the development.		~	~
The applicant must install a toilet flushing system with a minimum rating of 5 star in each toilet in the development.		~	~
The applicant must install taps with a minimum rating of 5 star in the kitchen in the development.		 Image: A set of the set of the	
The applicant must install basin taps with a minimum rating of 5 star in each bathroom in the development.		 Image: A set of the set of the	
Alternative water			
Rainwater tank			
The applicant must install a rainwater tank of at least 10000 litres on the site. This rainwater tank must meet, and be installed in accordance with, the requirements of all applicable regulatory authorities.	~	~	~
The applicant must configure the rainwater tank to collect rain runoff from at least 300 square metres of the roof area of the development (excluding the area of the roof which drains to any stormwater tank or private dam).		 	~
The applicant must connect the rainwater tank to:			
all toilets in the development		 Image: A set of the set of the	~
 at least one outdoor tap in the development (Note: NSW Health does not recommend that rainwater be used for human consumption in areas with potable water supply.) 		 Image: A set of the set of the	~
Swimming pool			
The swimming pool must not have a volume greater than 48 kilolitres.	~	 Image: A set of the set of the	

Thermal Comfort Cor	Show on DA plans	Show on CC/CDC plans & specs	Certifier check				
Windows, glazed doo	ors and skylights	;					
The applicant must install the windows, glazed doors and shading devices described in the table below, in accordance with the specifications listed in the table. Relevant overshadowing specifications must be satisfied for each window and glazed door.						 Image: A second s	~
The dwelling may have 1 skylight (<0.7 square metres) which is not listed in the table.					~	 Image: A second s	~
The following requirements must also be satisfied in relation to each window and glazed door:					~	~	~
 For the following glass a 	ind frame types, the c	ertifier check can be	e performed by visual inspection.				~
- Aluminium single cle	ar						
- Aluminium double (a	ir) clear						
- Timber/uPVC/fibregl	ass single clear						
- Timber/uPVC/fibregl	ass double (air) clear						
 Overshadowing building 	aluge and the mount he						
			istance from the centre and the ba	ase of the window and glazed	_	_	_
door, as specified in th			istance from the centre and the b	ase of the window and glazed	~	~	~
			istance from the centre and the b	ase of the window and glazed Shading Device (Dimens 10%)	ion within	Overshadowing	~
door, as specified in th	e 'overshadowing' col Maximum	lumn. Maximum width		Shading Device (Dimens	ion within	Overshadowing	~
door, as specified in th Window/glazed door no.	e 'overshadowing' col Maximum	lumn. Maximum width		Shading Device (Dimens	0 mm	Overshadowing not overshadowed	~
door, as specified in th Window/glazed door no. North facing	e 'overshadowing' col Maximum height (mm)	lumn. Maximum width (mm)	Туре	Shading Device (Dimens 10%) solid overhang 3000 mm, above head of window or g	0 mm glazed 0 mm		~
door, as specified in th Window/glazed door no. North facing W203	e 'overshadowing' col Maximum height (mm) 3150	lumn. Maximum width (mm) 6430	Type aluminium, single, clear	Shading Device (Dimens 10%) solid overhang 3000 mm, above head of window or g door solid overhang 3000 mm, above head of window or g	0 mm glazed 0 mm glazed 0 mm	not overshadowed	~
door, as specified in th Window/glazed door no. North facing W203 W204	e 'overshadowing' col Maximum height (mm) 3150 3150	lumn. Maximum width (mm) 6430 2995	Type aluminium, single, clear aluminium, single, clear	Shading Device (Dimension 10%) solid overhang 3000 mm, above head of window or good solid overhang 3000 mm, above head of window or good solid overhang 3000 mm, above head of window or good solid overhang 3000 mm, above head of window or good solid overhang 3000 mm, above head of window or good	0 mm glazed 0 mm glazed 0 mm glazed 0 mm	not overshadowed	

Thermal Comfort Commitments						Show on CC/CDC plans & specs	Certifier check
Nindows, glazed doo	ors and skylight	s					
The applicant must install the province of the specifications listed in the tagged of the tagged of the specifications are specificated as the specification of the specification	ne windows, glazed o able. Relevant overs	doors and shading de hadowing specification	evices described in the table below ons must be satisfied for each win	w, in accordance with the dow and glazed door.	~	~	~
The dwelling may have 1 skylight (<0.7 square metres) which is not listed in the table.					~	 	~
The following requirements must also be satisfied in relation to each window and glazed door:For the following glass and frame types, the certifier check can be performed by visual inspection.					~	~	~
• For the following glass a	and frame types, the	certifier check can b	e performed by visual inspection.				
- Aluminium single cle	ear						
- Aluminium double (a	air) clear						
- Timber/uPVC/fibreg	ass single clear						
- Timber/uPVC/fibreg	ass double (air) clea	ır					
			stance from the centre and the ba	ase of the window and glazed			
door, as specified in th	ie oversnadowing c	olumn.			•	•	•
			1				
Nindow/glazed door no.	Maximum height (mm)	Maximum width (mm)	Туре	Shading Device (Dimens 10%)	sion within	Overshadowing	
Window/glazed door no. North facing			Туре		sion within	Overshadowing	
			Type aluminium, single, clear		0 mm	Overshadowing not overshadowed	
North facing	height (mm)	(mm)		10%) solid overhang 3000 mm, above head of window or	0 mm glazed 0 mm		
North facing W203 W204	height (mm) 3150	(mm) 6430	aluminium, single, clear	10%) solid overhang 3000 mm, above head of window or door solid overhang 3000 mm, above head of window or	0 mm glazed 0 mm glazed 0 mm	not overshadowed	
North facing W203	height (mm) 3150 3150	(mm) 6430 2995	aluminium, single, clear aluminium, single, clear	10%) solid overhang 3000 mm, above head of window or door solid overhang 3000 mm, above head of window or door solid overhang 3000 mm, above head of window or above head of window or	0 mm glazed 0 mm glazed 0 mm glazed 0 mm	not overshadowed	

Energy Commitments	Show on DA plans	Show on CC/CDC plans & specs	Certifier check
all bathrooms/toilets; dedicated		~	~
the laundry; dedicated			Ú,
all hallways; dedicated		~	~
Natural lighting			
The applicant must install a window and/or skylight in the kitchen of the dwelling for natural lighting.	~	~	~
The applicant must install a window and/or skylight in 2 bathroom(s)/toilet(s) in the development for natural lighting.	~	 Image: A set of the set of the	~
Swimming pool			
The applicant must install the following heating system for the swimming pool in the development (or alternatively must not install any neating system for the swimming pool): solar (gas boosted)		~	
The applicant must install a timer for the swimming pool pump in the development.		~	
Outdoor spa			
The applicant must install the following heating system for the spa in the development (or alternatively must not install any heating system for the spa): solar (gas boosted)		~	
The applicant must install a timer for the spa pump in the development.		 Image: A set of the set of the	
Alternative energy			
The applicant must install a photovoltaic system with the capacity to generate at least 5 peak kilowatts of electricity as part of the development. The applicant must connect this system to the development's electrical system.	~	~	~
Other			
The applicant must install an induction cooktop & electric oven in the kitchen of the dwelling.		~	
The applicant must construct each refrigerator space in the development so that it is "well ventilated", as defined in the BASIX definitions.		 Image: A set of the set of the	
The applicant must install a fixed outdoor clothes drying line as part of the development.		_	



Client KATE & JAMES MARTIN 14 ERNEST STREET BALGOWLAH HEIGHTS, NSW 2093

but. It is a condition of any developm be complied with.	nent consent	t granted, or complyin	g




MARTIN RESIDENCE 14 ERNEST STREET, BALGOWLAH HEIGHTS, NSW 2093 Status SKETCH DESIGN Drawing Title BASIX COMMITMENTS Scale @A1









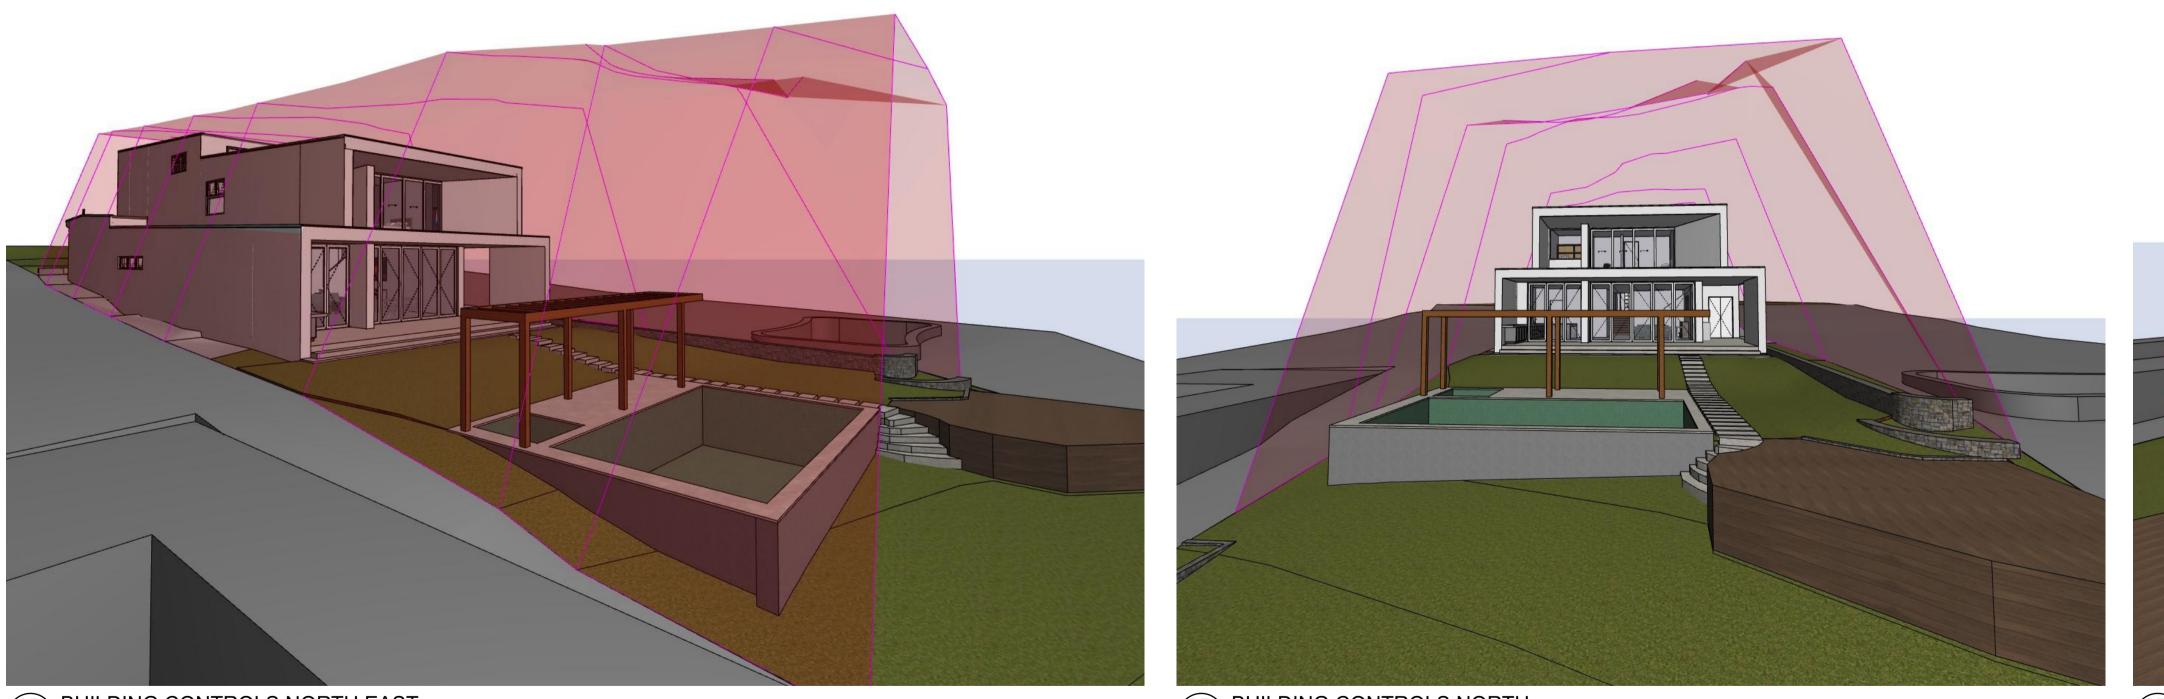

3D BUILDING CONTROLS NORTH EAST

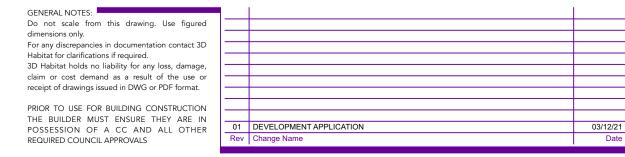

DRAWING NOTES:

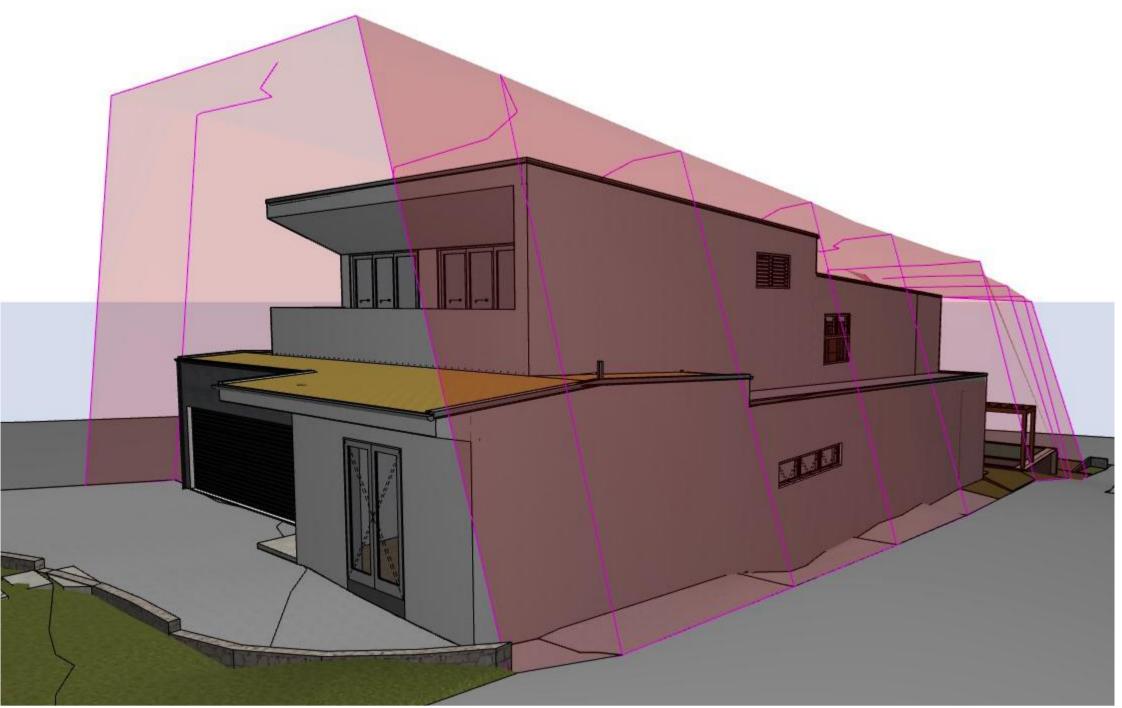


3D BUILDING CONTROLS SOUTH EAST





3D BUILDING CONTROLS NORTH WEST



Client KATE & JAMES MARTIN 14 ERNEST STREET BALGOWLAH HEIGHTS, NSW 2093

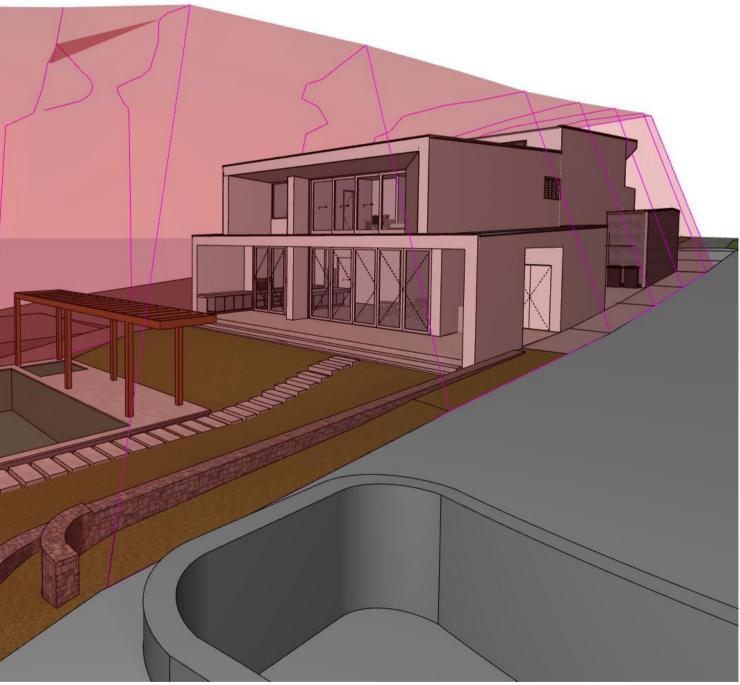

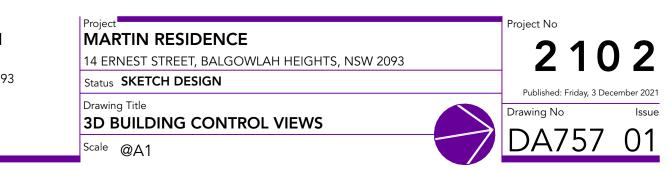

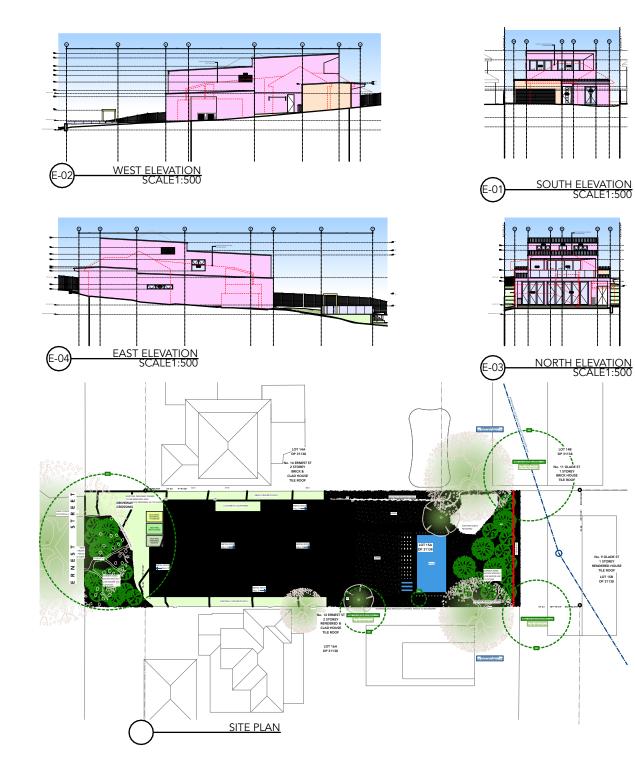



Project MARTIN RESIDENCE

14 ERNEST STREET BALGOWLAH HEIGHTS, NSW 2093

Drawing Title NOTIFICATION

