

PLANNING CONTROL CO	MPLIANCE TABLE		
LOT DESCRIPTION ADDRESS ZONING COUNCIL CONTROL	LOT 70 DP 11067 32 THE STRAND, WHALE BEACH 42 ENVIRONMENTAL LIVING & RE1 PUBLIC RECREATION NORTHERN BEACHES PITWATER LEP & PALM BEACH LOCALITY DCP		
CONTROL	OBJECTIVE	PROPOSED	COMPLIANCE
Height	8.5m (merit based assessment for heights exceeding 8.5m but not more than 10m for sites in excess of 30% slope)	Height < 10.0m	Compliant. see drawings 100.02, 210.01, 300.01, 300.02 for extent exceeding 8.5m but not exceeding 10.0m. Satisfaction of the objectives of LEP clause 4.3 (2D) and all subclauses.
Front setback	The greater of 6.5m or average of adjacent dwelling setbacks	6.5m to house - 5.1m to garage outter most projection	Partly complianty. Note proposed setbacks are a minimum of 2.6m greater than existing house at the closest point of outter most projection.
Side setback	2.5m to at least one side 1.0m to other side	3.35m 1.25m	Compliant Compliant
Rear setback	6.5m	29.4m	Compliant
Building envelope	3.5m at 45° measured at side boundary (merit based assessment for sites in excess of 30% slope)	varies	Compliant. see drawings 100.02, 210.01, 300.01, 300.02 for extent exceeding 8.5m but not exceeding 10.0m.
Landscaped area	60% min	60.8%	Compliant. Note calculation excludes RE1 Public Recreation Zone.
Private open space	80m2 at ground level	589m2	Compliant
Solar access	3hrs min (to private open space of proposed and neighbouring properties)	varies	Compliant
Views	Provide reasonable access	NA NA	Compliant
Privacy	Design to minimise impacts (on the privacy of proposed and neighbouring properties)	NA	Compliant
Car parking	2 spaces per 2 or more bedrooms	2 x covered	Compliant
Driveway	1 per 30m of frontage	1 x (off west body)	Compliant
Character (as viewed from a public place)	Design elements compatible with locale	Roof forms, materials, landscaping, terracing, scale and architectural form in keeping with local character.	Compliant
Scenic protection	landscaping the dominant feature and built form the secondary component	Built form recedes from western street front behind landscaped verge and roof	Compliant
Building colours and materials	Visual prominence minimised, and colours and materials to harmonise with native vegetation and character of the area	proposed natural material (timber and stone predominatly) along with deep planted terraces and roofs of scale that is minised to the street and public appearance	Compliant



Seat added

Landscape plan amended in accordance with prescribed conditions of consent (15) + (38).

Height of landscaped wall facing street to be increased to the North to a max height of 1800mm above ground level to follow

DRAWN REV DATE

MF A 13.11.18

MF B 18.04.19

MF C 26.06.19

ISSUE
Pre DA set reissued for information
preliminary issue
revised for DA

32 The Strand Whale Beach, NSW, 2107 Lot 70 on DP11067 Robert & Susie Nugan


Site analysis
site & locality plans

PHASE DWG NO RE DA 100.01 C

schematic design

PROJECT NO 0255 SCALE 1:10

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	<ol> <li>all works to be carried out in accordance with the general construction notes in coversheets of this package.</li> <li>all works to be carried out in accordance with the Dq (if required) and BA including drawings &amp; conditions.</li> <li>handralls are required to all stainways where a change of level of 575mm or greater occurs as per BCA 2013 Part 3.9.2.4.</li> <li>where boundary locations are not clear, the builder shall arrange for survey to locate the boundaries and</li> </ol>	5. contours shown are existing and do not represent finished levels. 6. levels and services locations for civil works may vary from those shown - verify all levels and services locations prior to commencement of construction. 7. concrete profile and blockwork setout is provided on 220 (series) of drawings, refer to these for setout. licensed surveyor to establishing jirds. where discrepancies occur the 220 series drawings are to take preceden	L0 (level) W01 (ref)	window code. refer to window ar door/window hardware schedule	rangements + is	door/gate code. refe door/window hardwa	r to door arrangements + re schedules	lpb01 finish* 2700 height**	'ceiling code  "refer finishes schedule  "* heights are relative to assocaited finished floor	20 h	I step up code. note step line occurs on low side of level change I I m	SSL xx.xxx	top of wall (surface) level  structural slab level	
	complete an identification survey prior to setting out the new work.		- RL xx.xx	spot level   tos = top of step   bos = bottom of step   RL = IvI at point (AHD typ)	(cos) (mir) (sim) (part)	confirm on site mirrored detail similar detail partial detial		Ipb01	scheduled item (refer to finishes/ sanitary/ applicances/ lighting/ services as appropriate)	thec	hose cock. refer services schedule. client to confirm locations	FFL xx.xxx	finished floor level	
[	Studio 2 22 w	wandra street (w22) newstead old 4006 DRAWN	REV	DATE	ISSUE		PROJECT		CLIENT		DRAWING NAME	PHASE DV	/G NO REV	PROJECT NO 0255

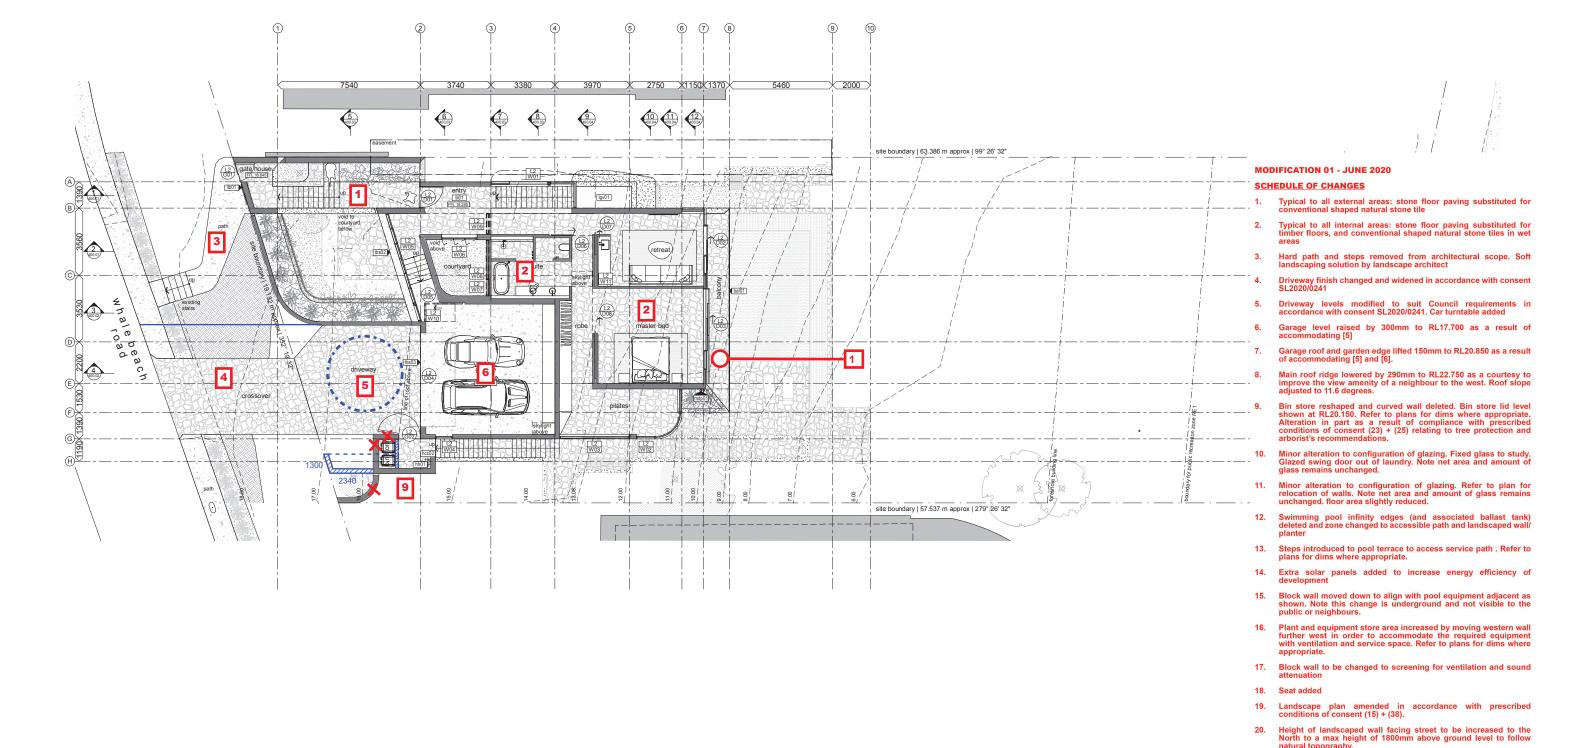

13.11.18 18.04.19

Pre DA set reissued for information preliminary issue


32 The Strand Whale Beach, NSW, 2107 Lot 70 on DP11067

Robert & Susie Nugan

floor plans

DA 200.01 B

schematic design

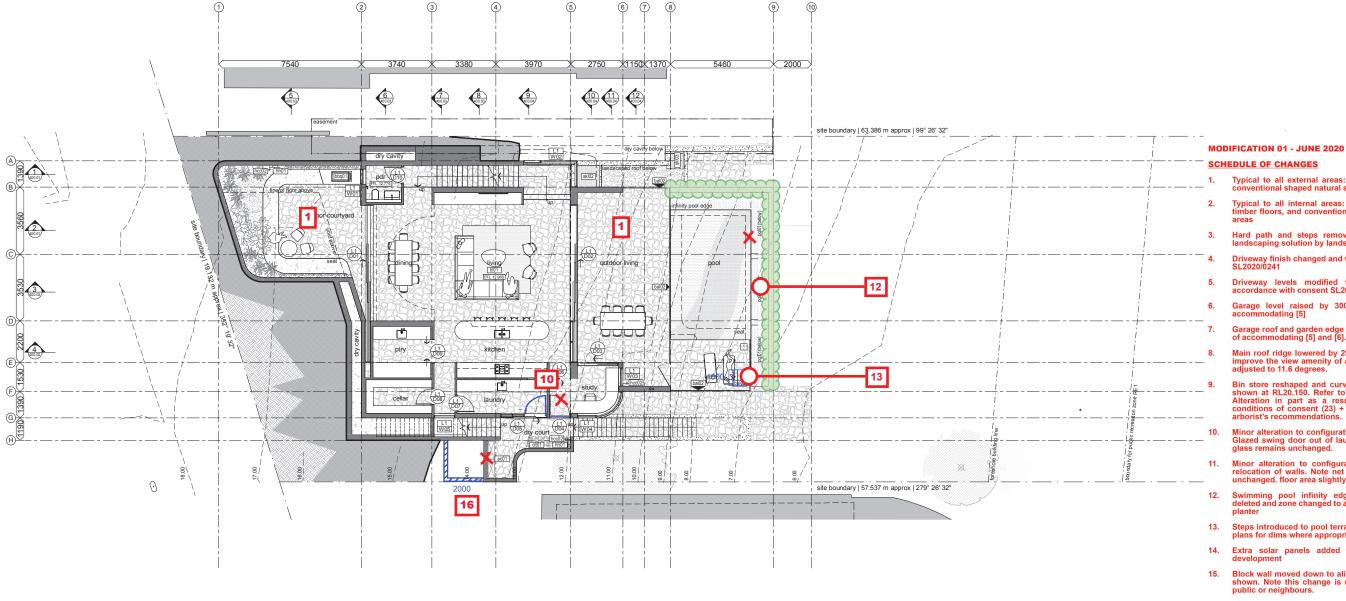

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- Typical to all external areas: stone floor paving substituted for conventional shaped natural stone tile
- Typical to all internal areas: stone floor paving substituted for timber floors, and conventional shaped natural stone tiles in wet
- Hard path and steps removed from architectural scope. Soft landscaping solution by landscape architect
- Driveway finish changed and widened in accordance with consent SL2020/0241
- Driveway levels modified to suit Council requirements in accordance with consent SL2020/0241. Car turntable added
- Garage level raised by 300mm to RL17.700 as a result of accommodating [5]
- Garage roof and garden edge lifted 150mm to RL20.850 as a result of accommodating [5] and [6].
- Main roof ridge lowered by 290mm to RL22.750 as a courtesy to improve the view amenity of a neighbour to the west. Roof slope adjusted to 11.6 degrees.
- Bin store reshaped and curved wall deleted. Bin store lid level shown at RL20,150. Refer to plans for dims where appropriate. Alteration in part as a result of compliance with prescribed conditions of consent (23) + (25) relating to tree protection and
- Minor alteration to configuration of glazing. Fixed glass to study. Glazed swing door out of laundry. Note net area and amount of glass remains unchanged.
- Minor alteration to configuration of glazing. Refer to plan for relocation of walls. Note net area and amount of glass remains unchanged. floor area slightly reduced.
- Swimming pool infinity edges (and associated ballast tank) deleted and zone changed to accessible path and landscaped wall/
- Steps introduced to pool terrace to access service path . Refer to plans for dims where appropriate.
- Extra solar panels added to increase energy efficiency of
- Block wall moved down to align with pool equipment adjacent as shown. Note this change is underground and not visible to the public or neighbours.
- Plant and equipment store area increased by moving western wall further west in order to accommodate the required equipment with ventilation and service space. Refer to plans for dims where
- 17. Block wall to be changed to screening for ventilation and sound
- Landscape plan amended in accordance with prescribed conditions of consent (15) + (38).
- Height of landscaped wall facing street to be increased to the North to a max height of 1800mm above ground level to follow

general notes g	general items	s							
all works to be carried out in accordance with the general construction notes in coversheets of this package.     all works to be carried out in accordance with the DA (if required) and BA including drawings & conditions.     3. handralls are required to all stailways where a change of level of 575mm or greater occurs as per BCA 2013     Part 3.9.2.4.     4. where boundary locations are not clear, the builder shall arrange for survey to locate the boundaries and	L0 (level) W01 (ref)	I window code, refer to window arrangements +   door/window hardware schedules	L1 (level) D01 (ref)	door/gate code. refer to door arrangements + door/window hardware schedules	lpb01 finish* 2700 height*	ceiling code ' refer finishes schedule ' refer finishes schedule '' heights are relative to assocaited finished floor	20 low lvl + 20 m		TOW xx.xxx   top of wall (surface) level
nplete an identification survey prior to setting out the new work.	RL xx.xxx	spot level   tos = top of step   tos = top of step   tos = bottom of step   RL = Ivl at point (AHD typ)	(cos) (mir) (sim) (part)	confirm on site mirrored detail similar detail partial detail	[pb01]	scheduled item (refer to finishes/ sanitary/ applicances/ lighting/ services as appropriate)	thcc	hose cock. refer services schedule. client to confirm locations	FFL xx.xxx   finished floor level



13.11.18 18.04.19

Pre DA set reissued for information preliminary issue


32 The Strand Whale Beach, NSW, 2107 Lot 70 on DP11067

Robert & Susie Nugan

DRAWING NAME floor plans first floor

PHASE DWG NO REV

schematic design

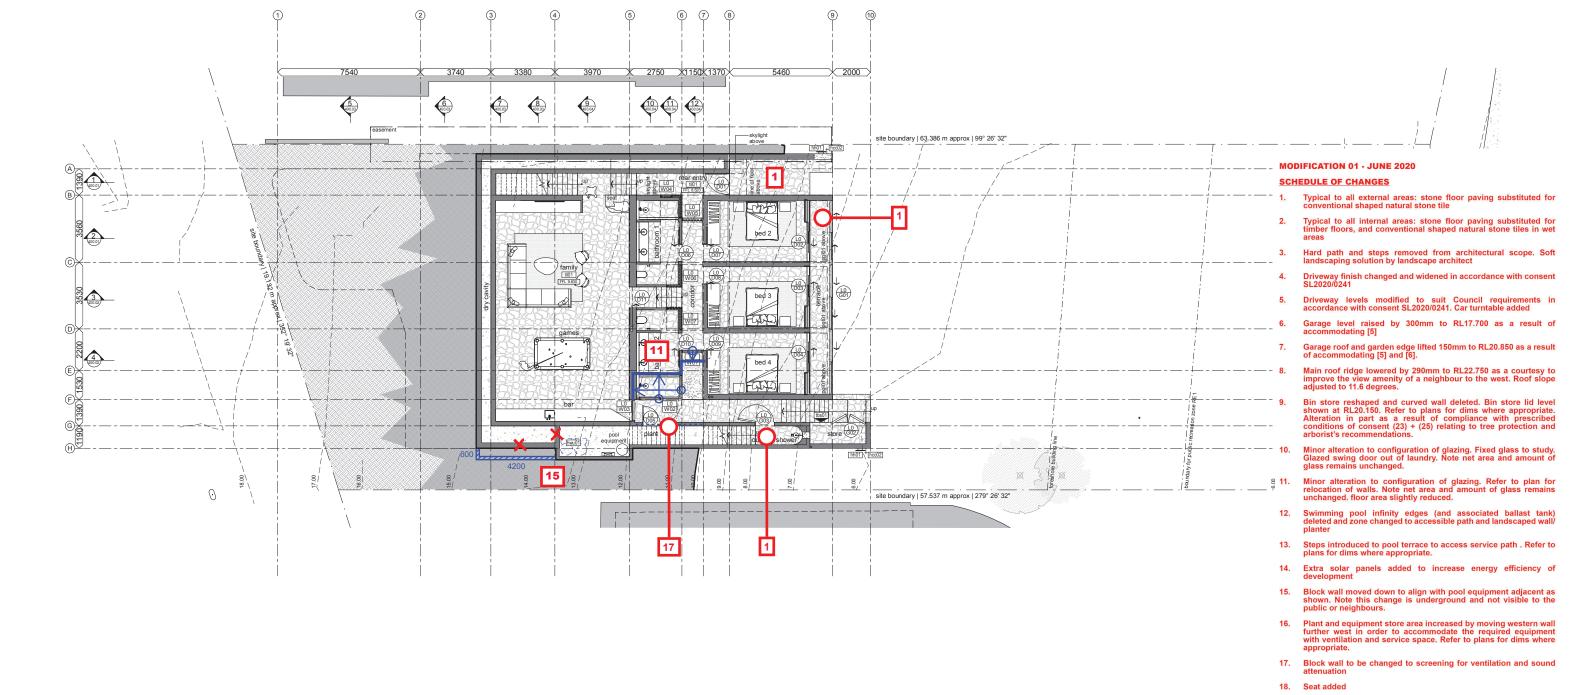

general notes	general items	
all works to be carried out in accordance with the general construction notes in coversheets of this package.     all works to be carried out in accordance with the DA (if required) and BA including drawings & conditions.     a handralis are required to all stainways where a change of level of 575mm or greater occurs as per BCA 2013     Part 3.9.2.4.     where boundary locations are not clear, the builder shall arrange for survey to locate the boundaries and	window code. refer to window arrangements + door/window hardware schedules   door/window hardware s	xx.xxxx   top of wall (surface) level
complete an identification survey prior to setting out the new work.	spot level (cos) confirm on site scheduled item   hose cock. refer services schedule. client to confirm locations   FFL xx.xxxxxxxxxxxxxxxxxxxxxxxxxxxxxxxx	xx.xxx finished floor level
	1	xx.xxx reduced level
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AWN REV DATE
A 13.11.18
B 18.04.19

Pre DA set reissued for information preliminary issue

32 The Strand Whale Beach, NSW, 2107 Lot 70 on DP11067 Robert & Susie Nugan

floor plans ground floor PHASE DWG NO REV DA 200.03 B


SCALE 1:100

schematic design

Landscape plan amended in accordance with prescribed conditions of consent (15) + (38).

Height of landscaped wall facing street to be increased to the North to a max height of 1800mm above ground level to follow natural topography.

1:1 @

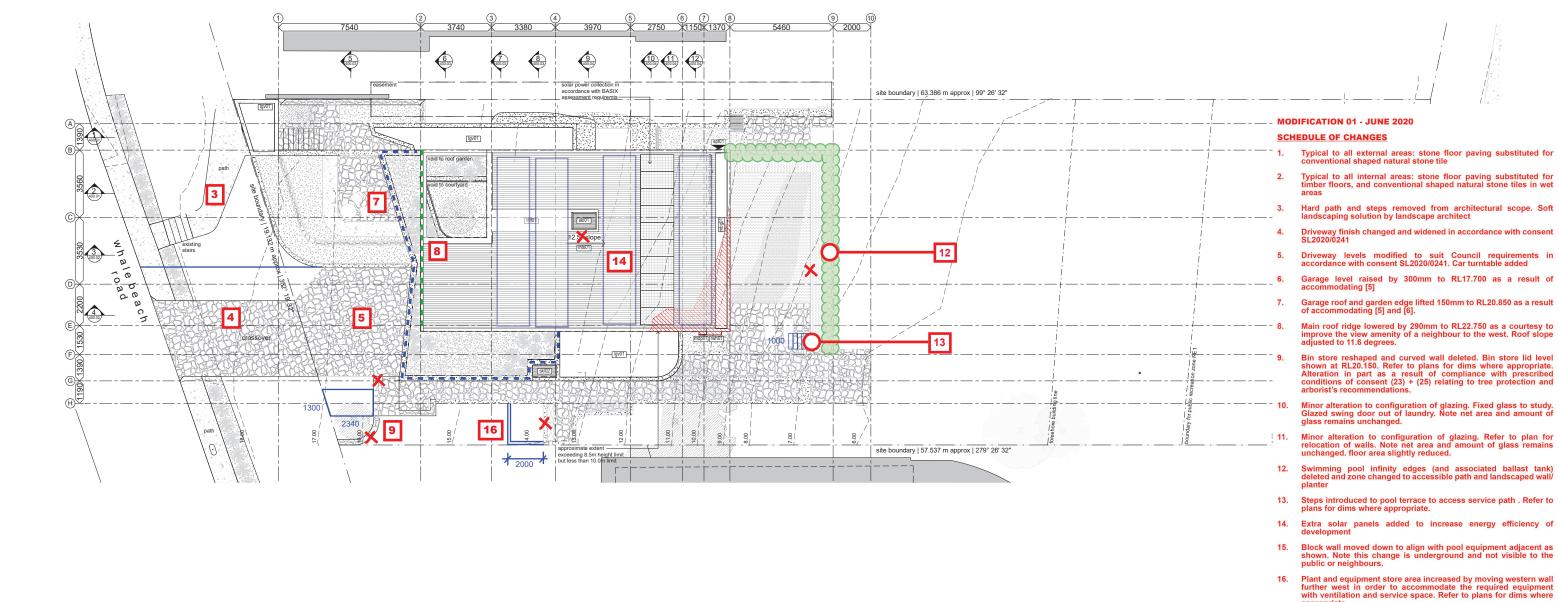

general notes	general items	
1. all works to be carried out in accordance with the general construction notes in coversheets of this package. 2. all works to be carried out in accordance with the DA (if required) and BA including drawings & conditions. 3. handralis are required to all stairways where a change of level of 575mm or greater occurs as per BCA 2013 Part 3.9.2.4. 4. where boundary locations are not clear, the builder shall arrange for survey to locate the boundaries and	window code, refer to window arrangements + Uniform (level)   door/window hardware schedules   Uniform (level)   U	
complete an identification survey prior to setting out the new work.	spot level (cos) (mir) imfrared detail imfrared detail (sm) (part)   partial detail   parti	



\( \text{VN} \) REV DATE ISSUE \( A \) 13.11.18 Pre DA set reissued for information \( B \) 18.04.19 preliminary issue \( C \) 26.06.19 revised for DA

32 The Strand Whale Beach, NSW, 2107 Lot 70 on DP11067 Robert & Susie Nugan

DRAWING NAME floor plans roof plan PHASE DWG NO REV DA 210.01 C


SCALE 1:

schematic design

17. Block wall to be changed to screening for ventilation and sound


19. Landscape plan amended in accordance with prescribed conditions of consent (15) + (38).
20. Height of landscaped wall facing street to be increased to the North to a max height of 1800mm above ground level to follow

1:1 @

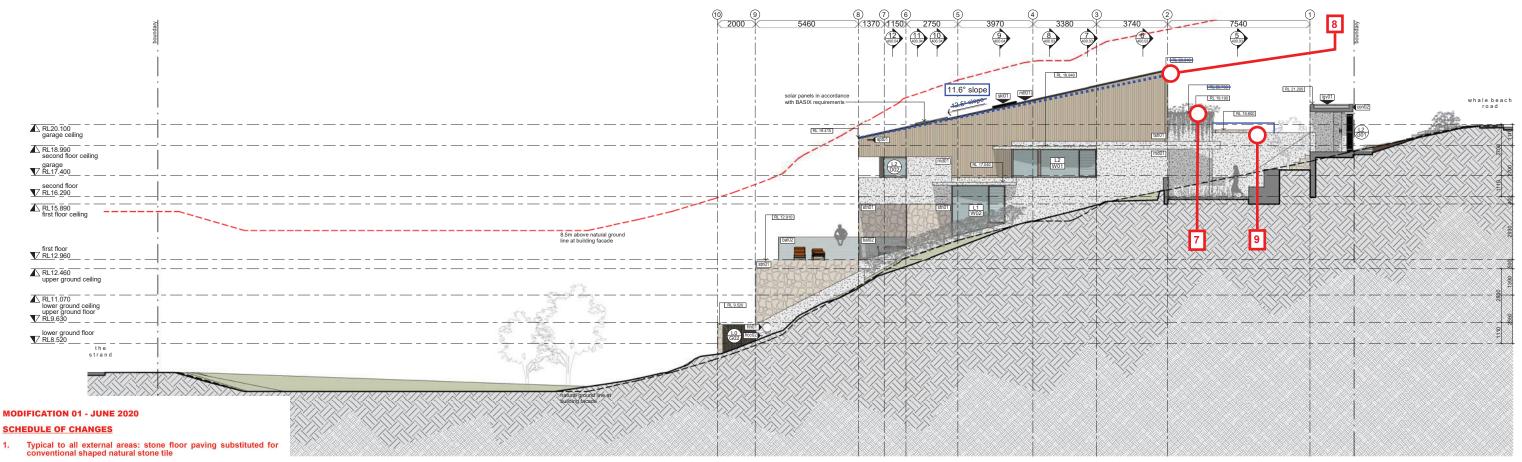

- Typical to all internal areas: stone floor paving substituted for timber floors, and conventional shaped natural stone tiles in wet
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- Bin store reshaped and curved wall deleted. Bin store lid level shown at RL20,150. Refer to plans for dims where appropriate. Alteration in part as a result of compliance with prescribed conditions of consent (23) + (25) relating to tree protection and
- Minor alteration to configuration of glazing. Fixed glass to study. Glazed swing door out of laundry. Note net area and amount of glass remains unchanged.
- Minor alteration to configuration of glazing. Refer to plan for relocation of walls. Note net area and amount of glass remains unchanged, floor area slightly reduced.
- Swimming pool infinity edges (and associated ballast tank) deleted and zone changed to accessible path and landscaped wall/
- Steps introduced to pool terrace to access service path . Refer to plans for dims where appropriate.
- Extra solar panels added to increase energy efficiency of
- Block wall moved down to align with pool equipment adjacent as shown. Note this change is underground and not visible to the public or paighbour.
- Plant and equipment store area increased by moving western wall further west in order to accommodate the required equipment with ventilation and service space. Refer to plans for dims where
- 17. Block wall to be changed to screening for ventilation and sound

- Height of landscaped wall facing street to be increased to the North to a max height of 1800mm above ground level to follow

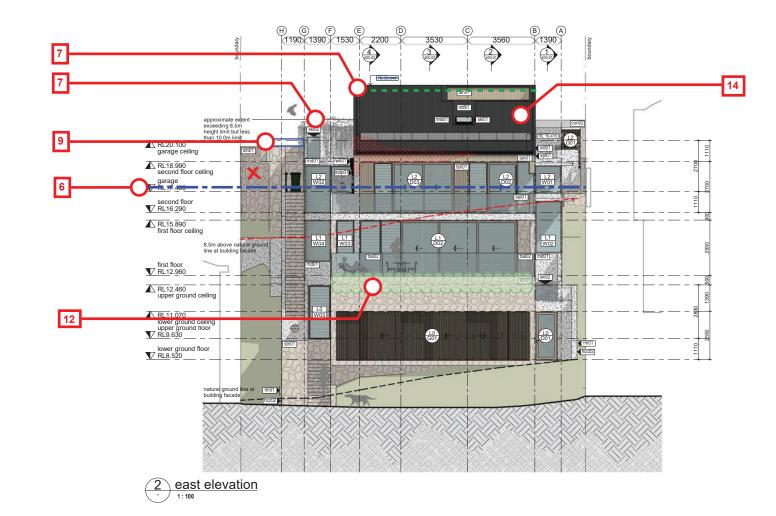



18.04.19 26.06.19 04.09.19


preliminary issue revised for DA RL's added per DA RFI

32 The Strand Whale Beach, NSW, 2107 Lot 70 on DP11067


Robert & Susie Nugan

elevations north & east elevation

schematic design

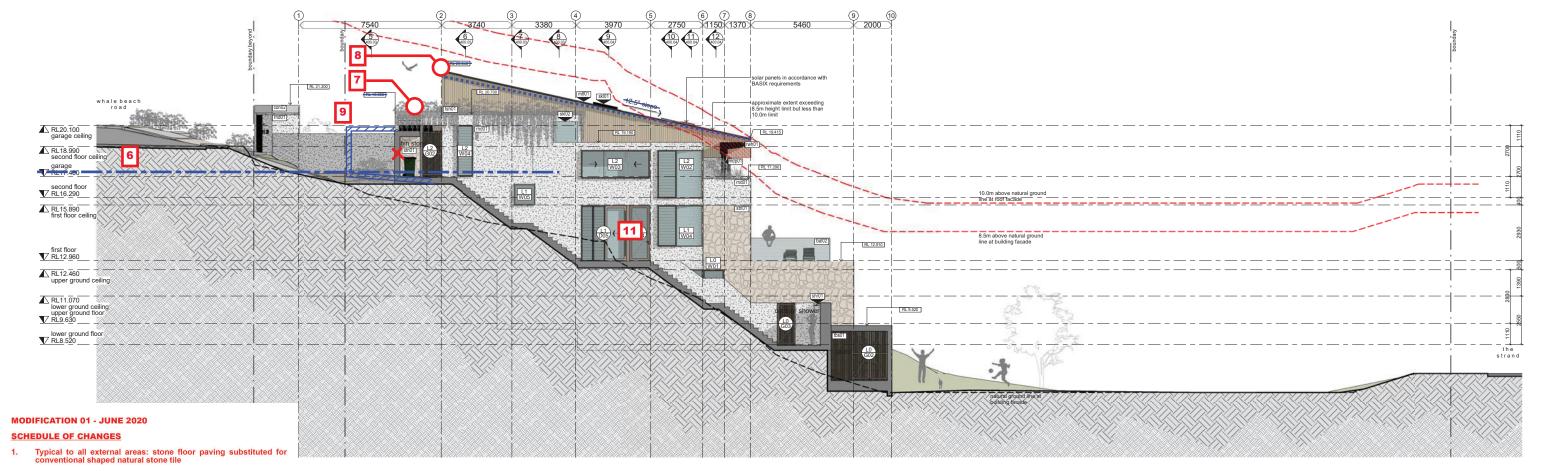

- Typical to all internal areas: stone floor paving substituted for timber floors, and conventional shaped natural stone tiles in wet areas
- Hard path and steps removed from architectural scope. Soft landscaping solution by landscape architect
- 4. Driveway finish changed and widened in accordance with consent SL2020/0241
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- Minor alteration to configuration of glazing. Fixed glass to study. Glazed swing door out of laundry. Note net area and amount of glass remains unchanged.
- 11. Minor alteration to configuration of glazing. Refer to plan for relocation of walls. Note net area and amount of glass remains unchanged. floor area slightly reduced.
- Swimming pool infinity edges (and associated ballast tank) deleted and zone changed to accessible path and landscaped wall/ planter
- 13. Steps introduced to pool terrace to access service path. Refer to
- 4. Extra solar panels added to increase energy efficiency of
- Block wall moved down to align with pool equipment adjacent as shown. Note this change is underground and not visible to the public or neighbours.
- 16. Plant and equipment store area increased by moving western wall further west in order to accommodate the required equipment with ventilation and service space. Refer to plans for dims where
- 17. Block wall to be changed to screening for ventilation and sound
- 18. Seat added
- 19. Landscape plan amended in accordance with prescribed conditions of consent (15) + (38).
- Height of landscaped wall facing street to be increased to the North to a max height of 1800mm above ground level to follow natural topography.

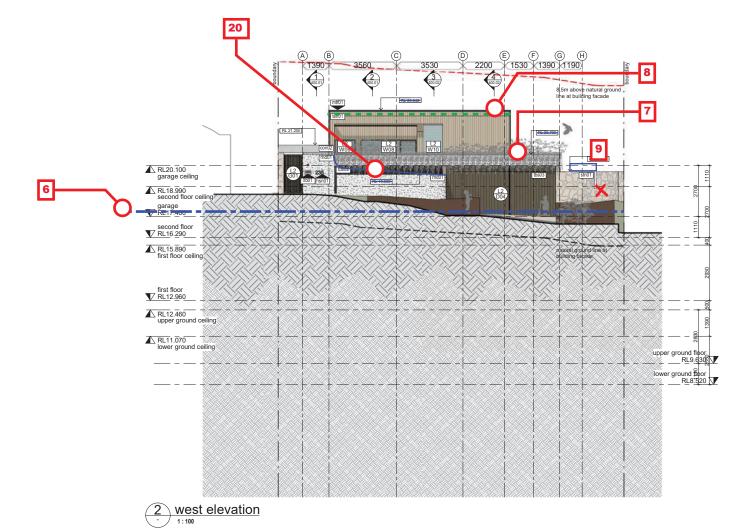

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 MF
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 18.04.19
 preliminary issue

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 C
 26.06.19
 revised for DA

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 D
 04.09.19
 RL's added per DA RFI

32 The Strand Whale Beach, NSW, 2107 Lot 70 on DP11067 Robert & Susie Nugan


elevations south & west elevation PHASE DWG NO REV DA 300.02 D


schematic design


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PROJECT NO 0255

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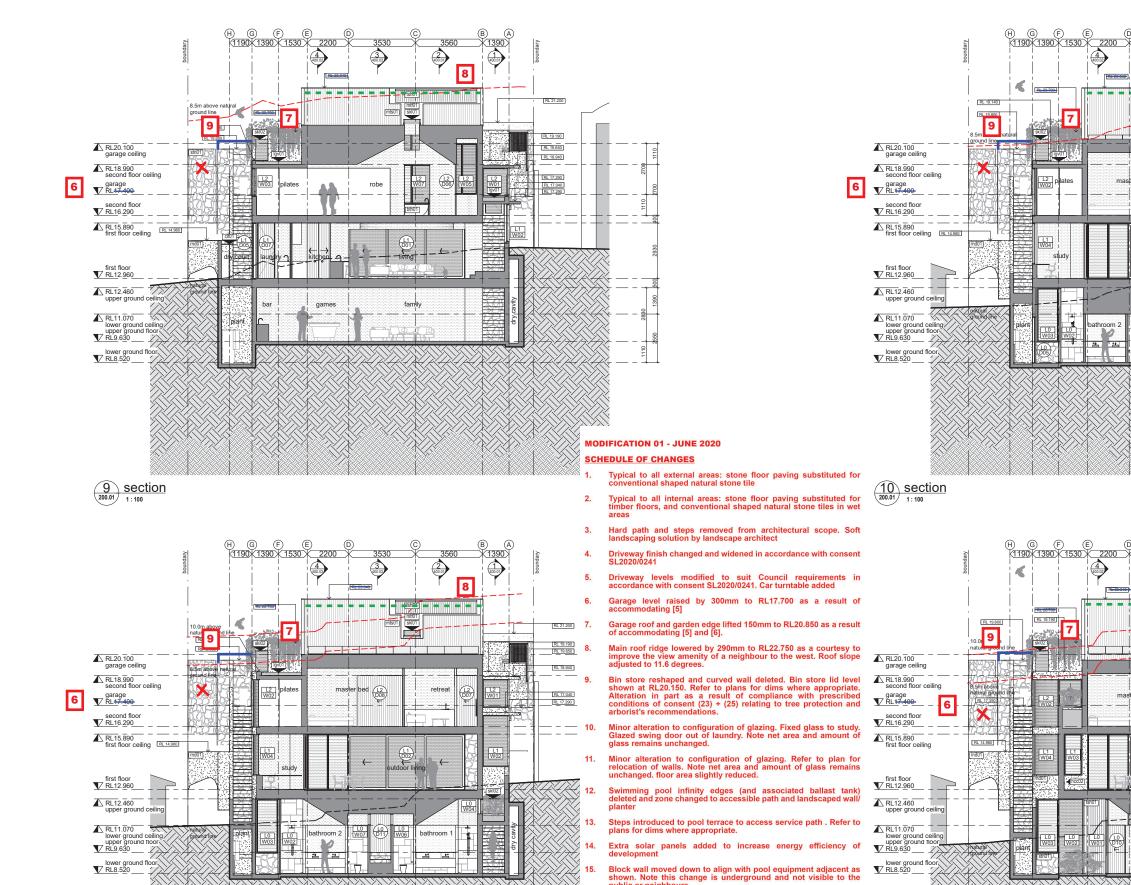
18.04.19 shaunlockyerarchitects pty ltd 04.09.19

preliminary issue RL's added per DA RFI

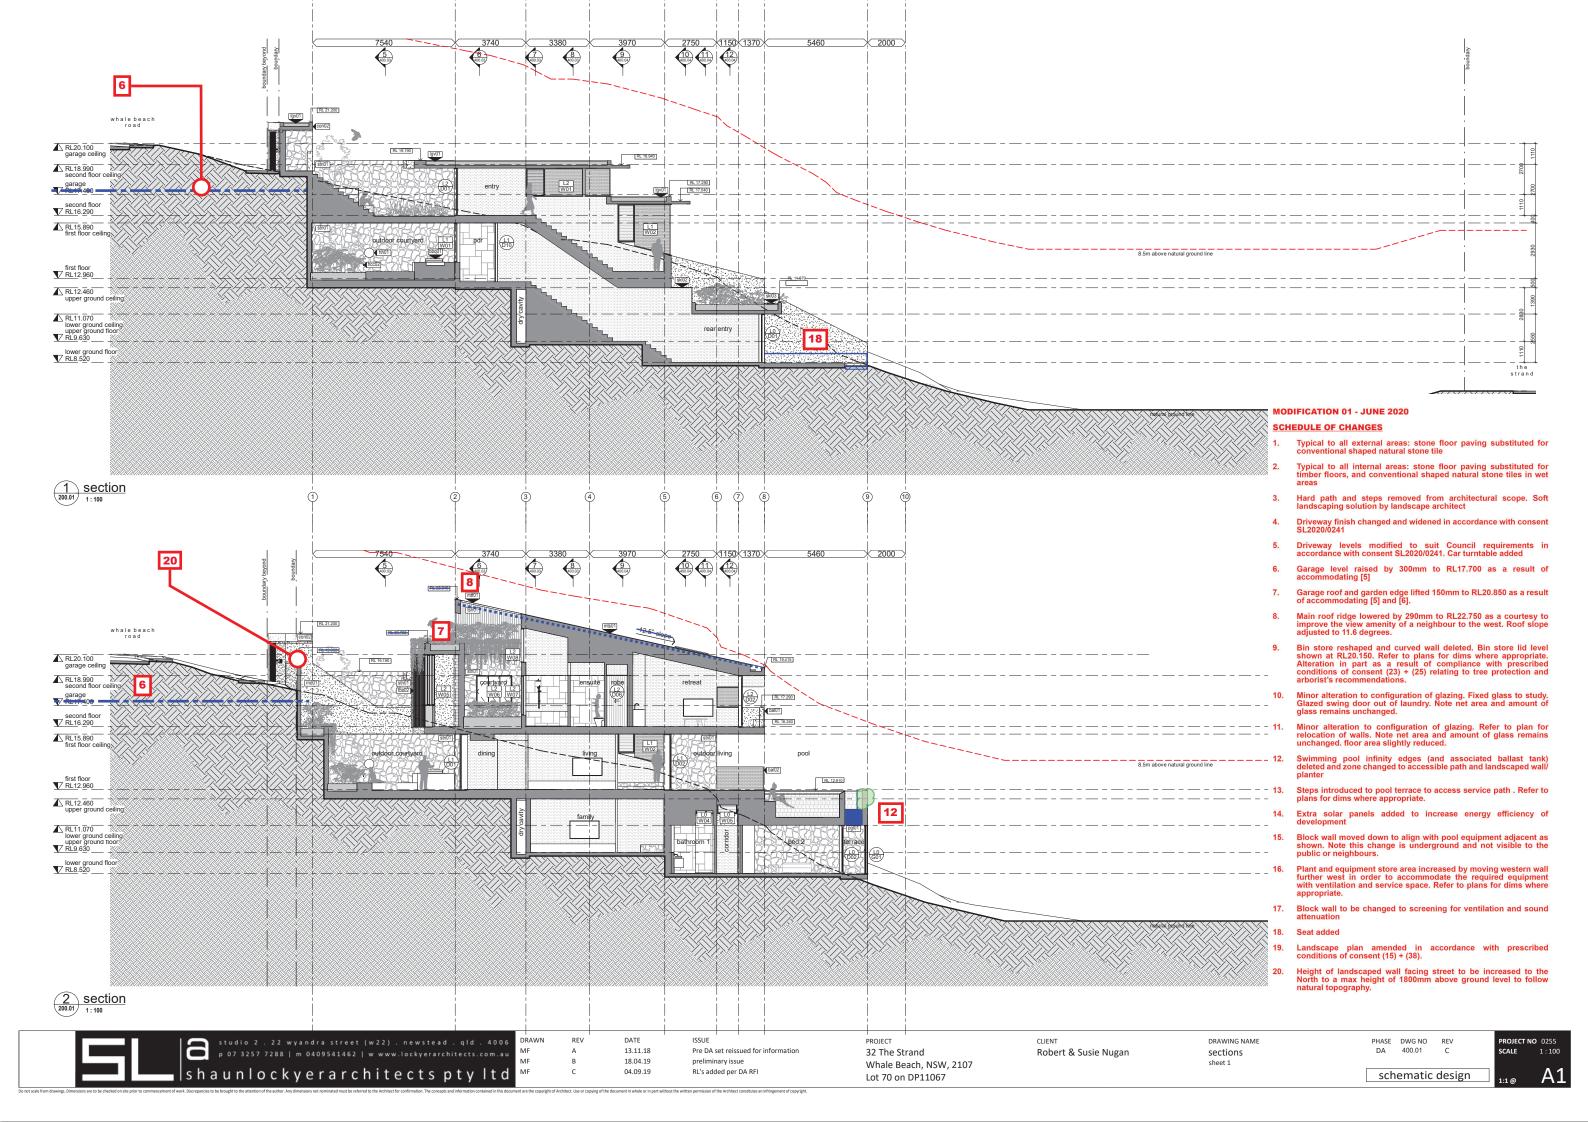Whale Beach, NSW, 2107 Lot 70 on DP11067

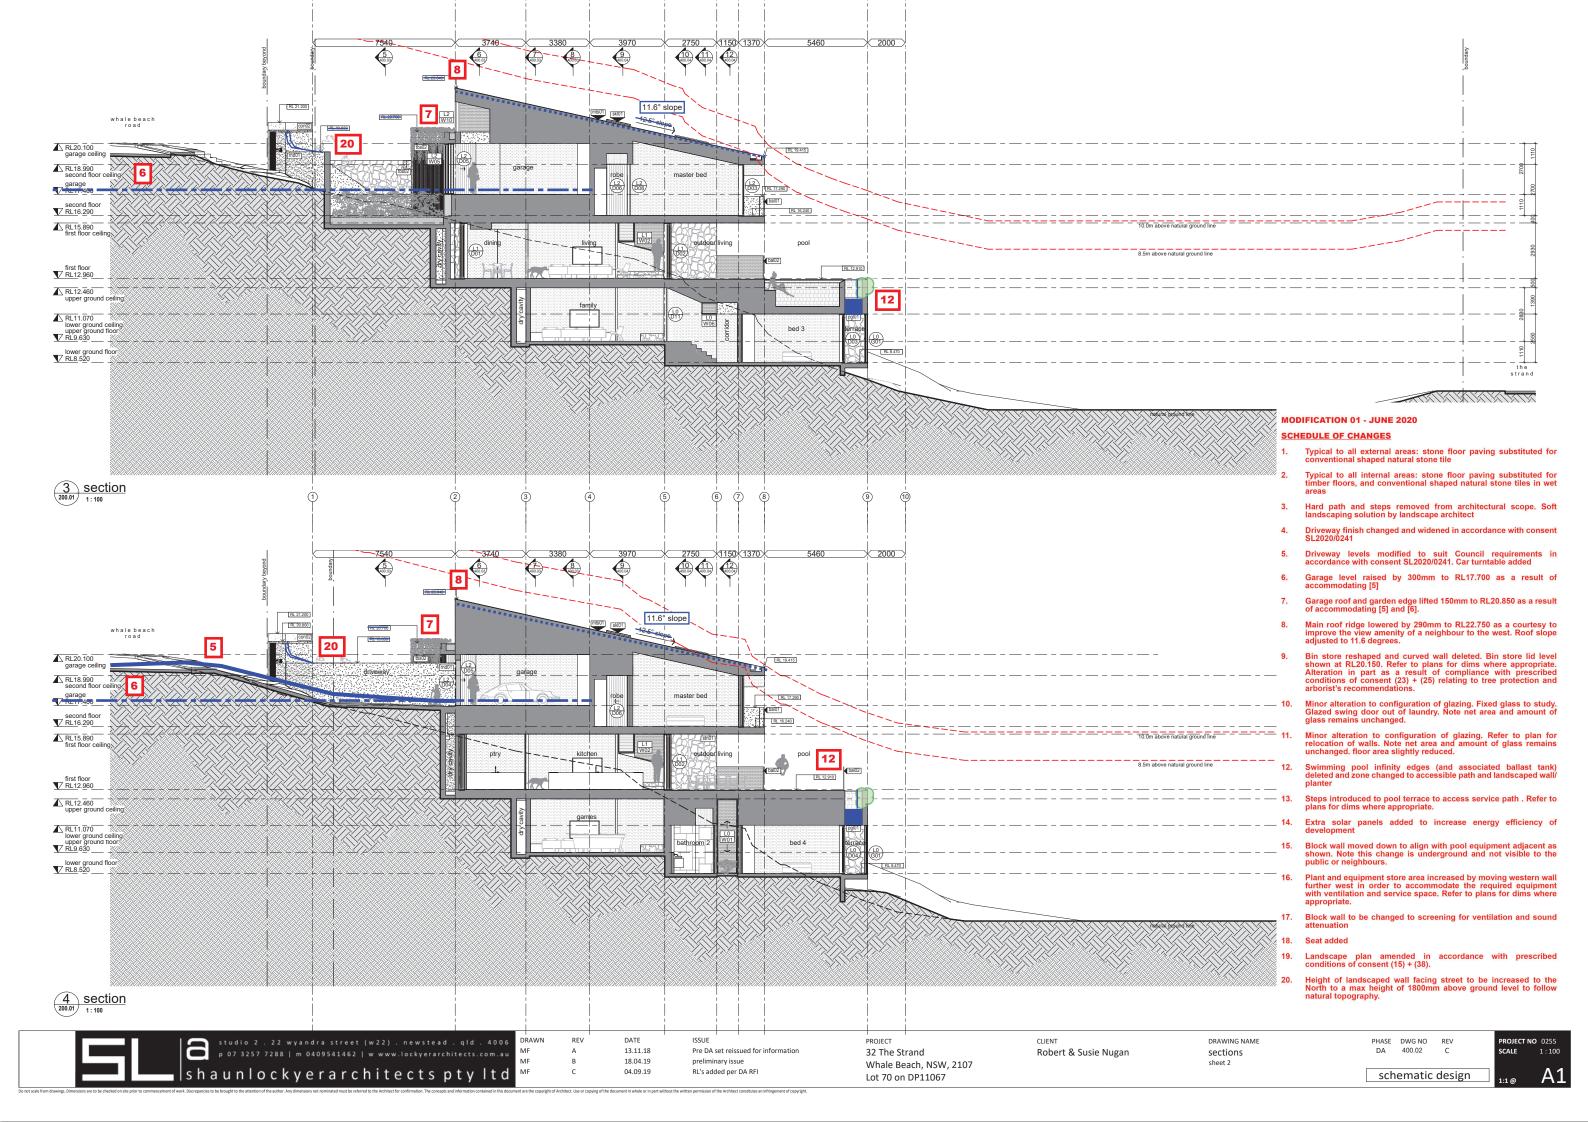sheet 3

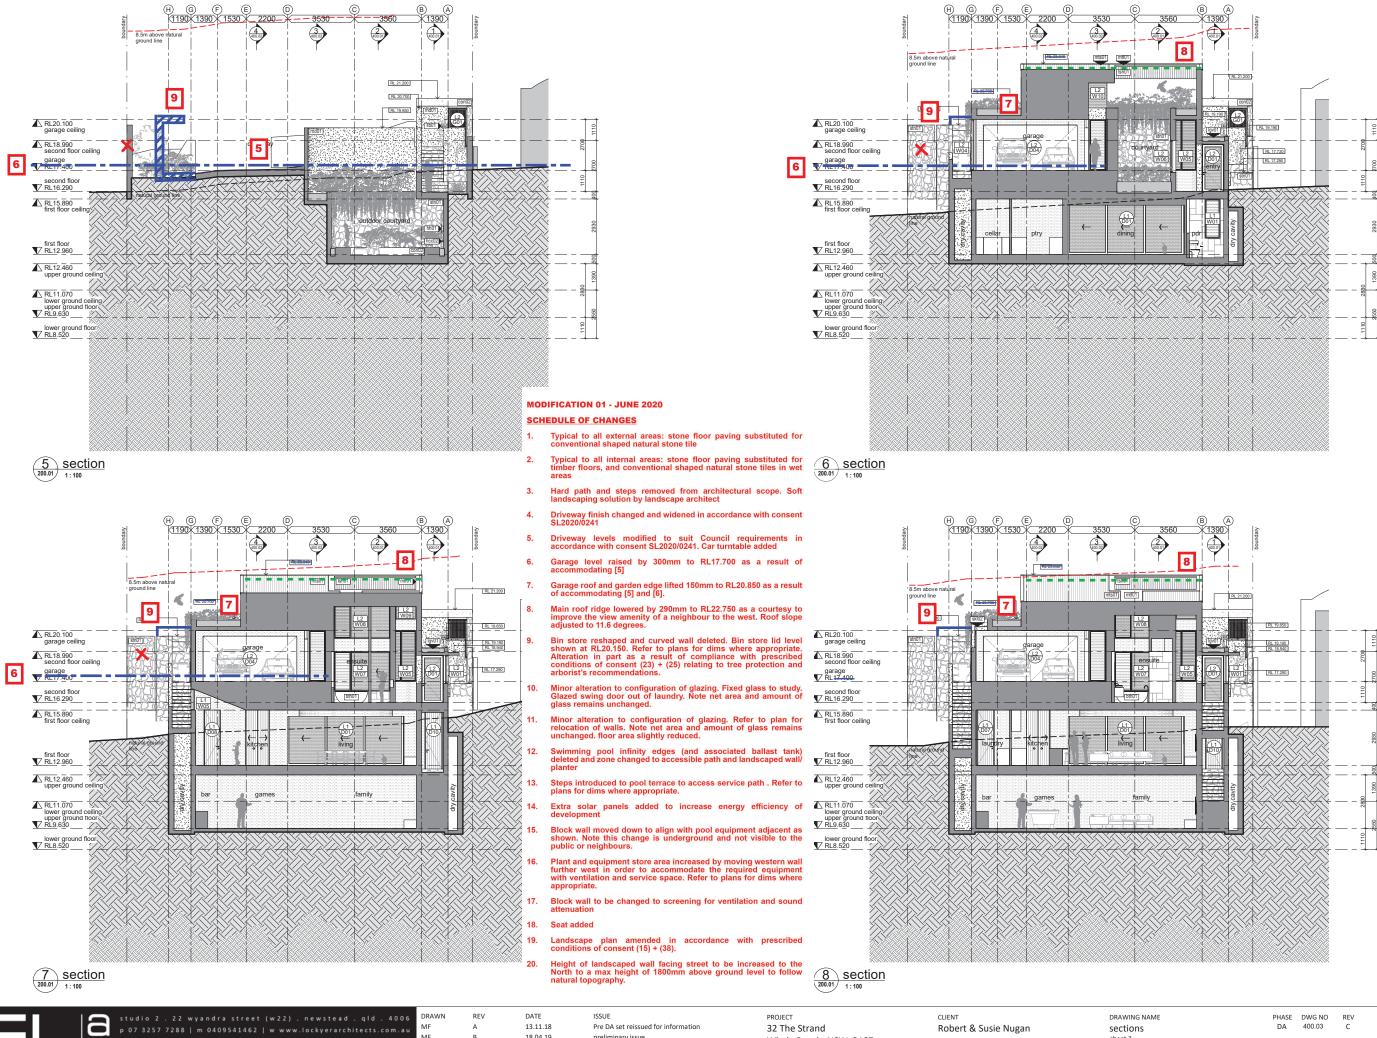schematic design





18 04 19 nreliminary issue 04.09.19 RL's added per DA RFI

natural topography.

18. Seat added

Plant and equipment store area increased by moving western wall further west in order to accommodate the required equipment with ventilation and service space. Refer to plans for dims where

Landscape plan amended in accordance with prescribed conditions of consent (15) + (38).

Height of landscaped wall facing street to be increased to the North to a max height of 1800mm above ground level to follow

17. Block wall to be changed to screening for ventilation and sound

32 The Strand Whale Beach, NSW, 2107 Lot 70 on DP11067

12 section 200.01 1:100

Robert & Susie Nugan

RL 19.190

**4** 

DRAWING NAME sections sheet 4

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DTT Corric

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RL 21.200 RL 19.190

RL 18.940


RL 17.290 RL 17.720


retreat

RL 21.200

DA 400.04

schematic design

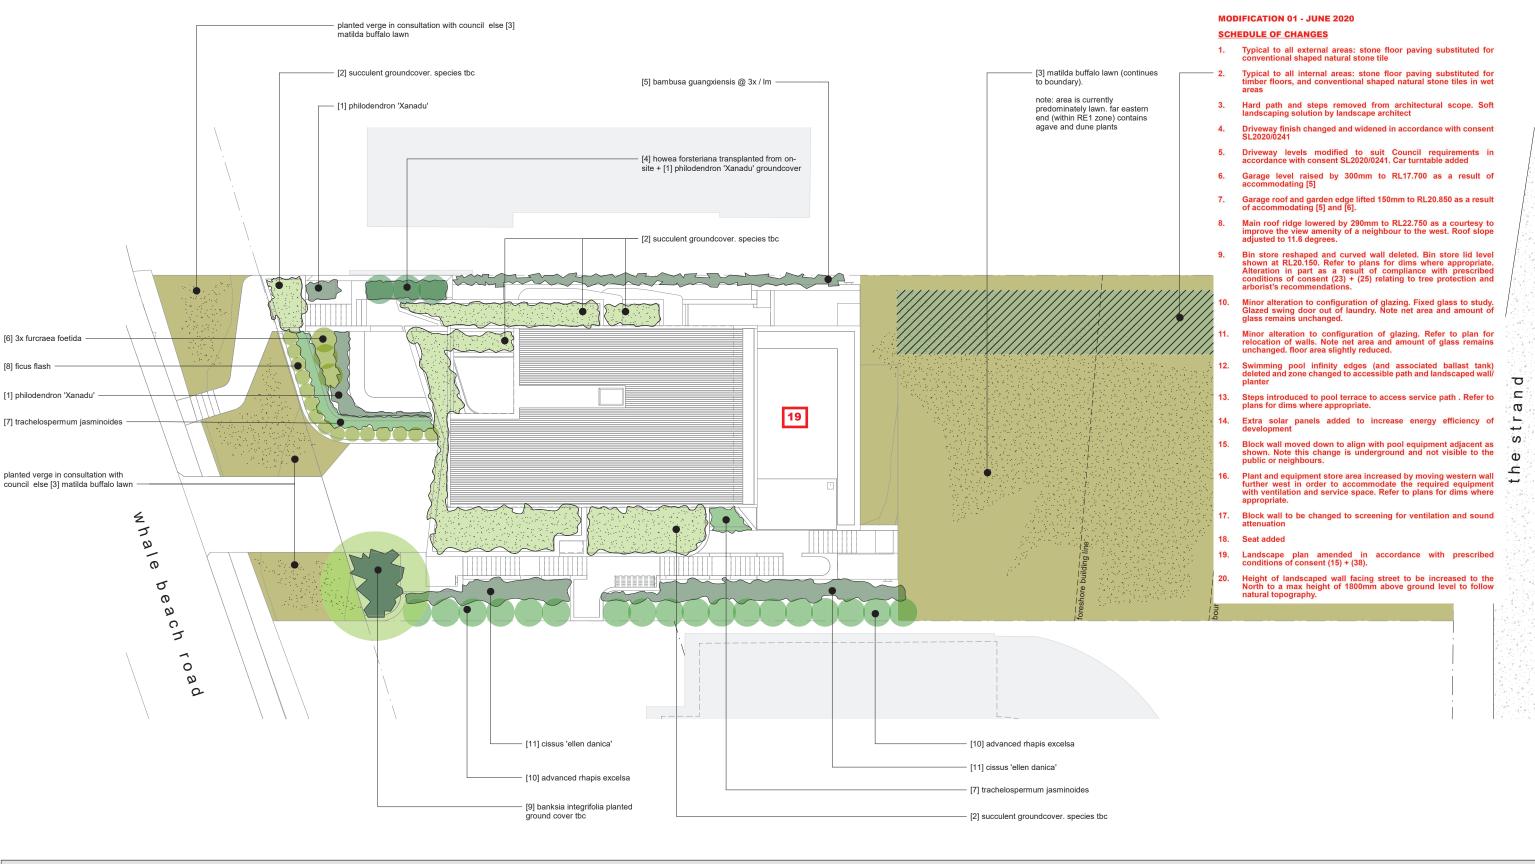

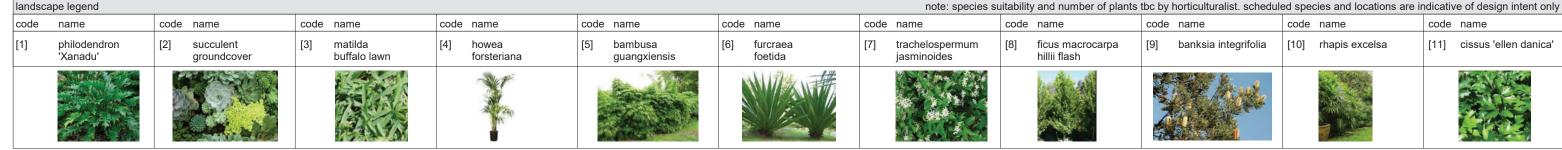

shaunlockyerarchitects pty ltd

DRAWN

26.06.19


revised for DA 32 The Strand Whale Beach, NSW, 2107 Lot 70 on DP11067

Robert & Susie Nugan

Site Plans

DA 100.10

schematic design

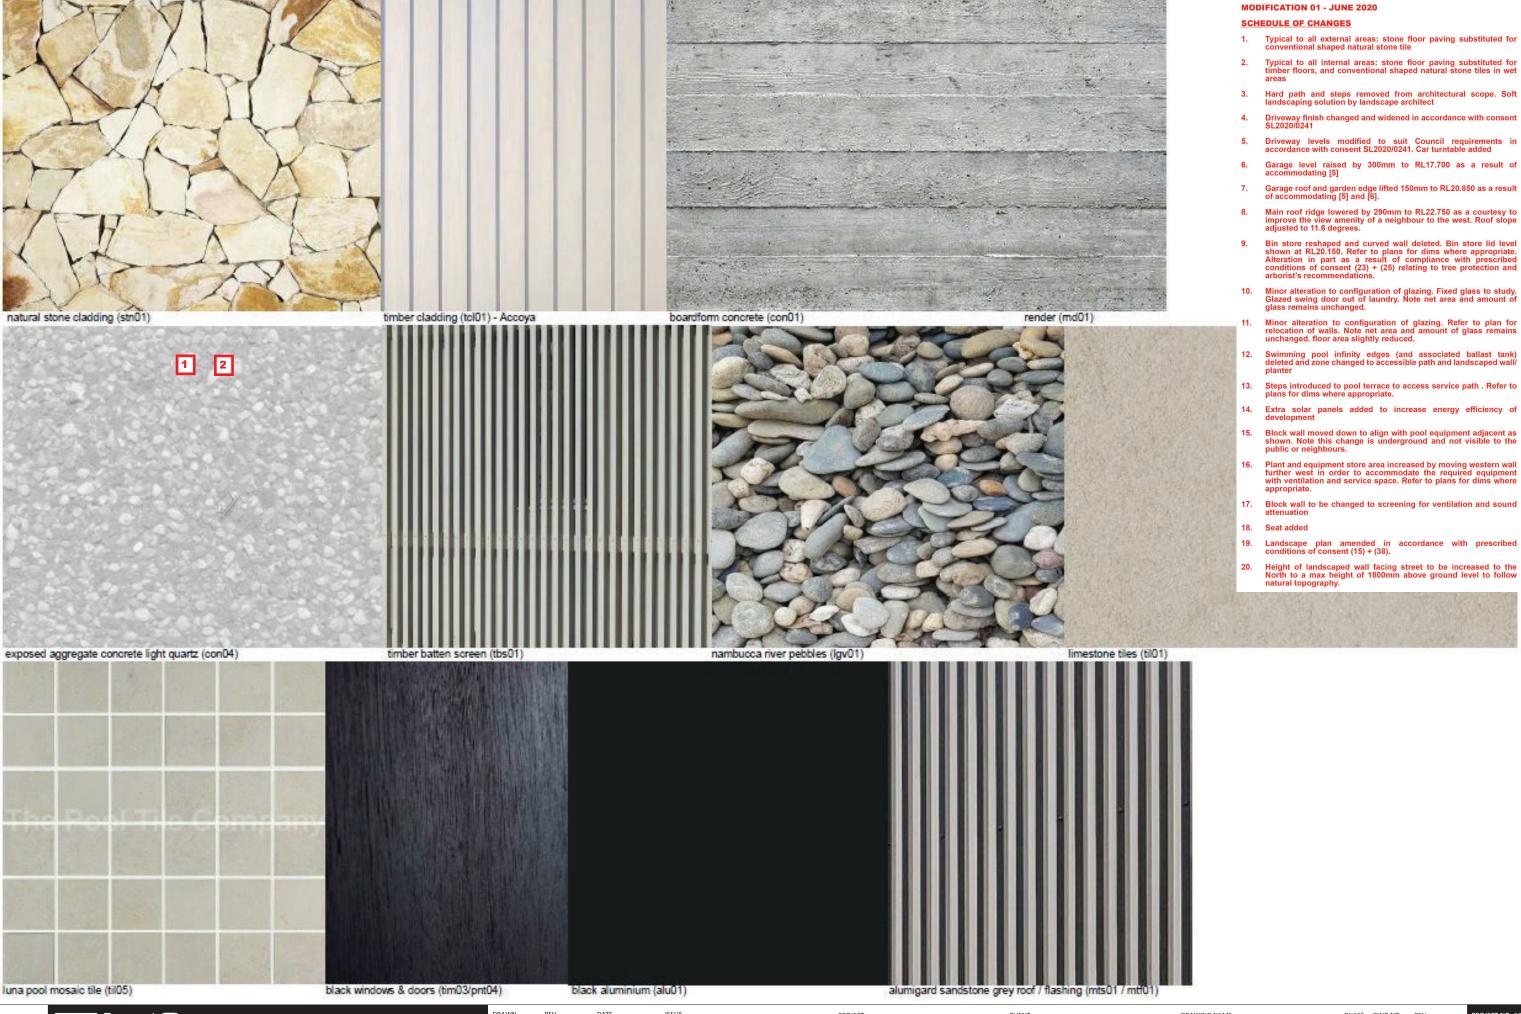

8 shaunlockyerarchitects pty ltd

18.04.19

32 The Strand Whale Beach, NSW, 2107 Lot 70 on DP11067

Robert & Susie Nugan

reference images

PHASE DWG NO REV

schematic design