

G	ISSUED FOR APPROVAL	01/06/2023			Γ
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А	PRELIMINARY DESIGN	20/09/2022			
REVISION	AMENDMENT	ISSUE DATE	ISSUE	ISSUED TO	ISS



SUITE 303 / 29-31 LEXINGTON DRIVE NORWEST BUSINESS PARK, BELLA VISTA N.S.W. 2153 ALL CORRESPONDENCE TO:

P.O. BOX 6080 BAULKHAM HILLS BC **BAULKHAM HILLS NSW 2153** 

PH. 8814 6191 FAX 8814 5301 MOB. 0425 270 333 EMAIL andrew@camconsulting.com.au

PROPOSED DEVELOPME LOT 2, 6 ORCHARD STRE WARRIEWOOD CLIENT

PROJECT

SKYCORP ARCHITECT / PROJECT MANAGER PTI ARCHITECTURE

### NOTES

1. THESE DRAWINGS ARE TO BE READ IN CONJUNCTION WITH THE ARCHITECTURAL DRAWINGS, STRUCTURAL DRAWINGS AND THE SPECIFICATON.

2. PRIOR TO COMMENCEMENT OF WORKS THE CONTRACTOR SHALL SATISFY HIMSELF OF THE CORRECT LOCATION OF EXISTING SERVICES WHETHER INDICATED OR NOT ON THE PLANS. ANY DAMAGE TO EXISTING SERVICES SHALL BE RECTIFIED AT THE CONTRACTORS EXPENSE. 3. TRAFFIC MANAGEMENT MEASURES HAVE TO BE IMPLEMENTED AND MAINTAINED DURING CONSTRUCTON, ALL IN ACCORDANCE WITH COUNCIL'S REQUIREMENTS. THE CONTRACTOR SHALL MAINTAIN SAFE PEDESTRIAN ACCESS ALONG THE FOOTPATH. 4. THE CONTRACTOR SHALL EFFECT TEMPORARY DRAINAGE MEASURES TO AVOID LOCALISED PONDING OF SURFACE RUN-OFF. 5. REFER TO ARCHITECT'S DRAWINGS FOR ALL DETAILS (LEVELS, GRADING ETC.) OF DRIVEWAYS, CONCRETE AND PAVED AREAS, AND RETAINING WALL TYPES AND LOCATIONS. 6. REFER TO LANDSCAPE ARCHITECT'S DRAWINGS FOR DETAILS AND EXTENT OF ALL LANDSCAPED AREAS. 7. ALL SWD PIPES ARE UPVC AT 1.0% MINIMUM GRADE (UNO). 8. SWD PITS CAN BE PRE-CAST SIZED AS FOLLOWS: 450mm SQ. UP TO 600mm DEEP

600mm SQ. UP TO 1000mm DEEP 9. ALL PITS LOCATED IN TRAFFICABLE AREAS, (IE, DRIVEWAYS) TO HAVE MEDIUM DUTY GRATED COVERS SUITABLE FOR WITHSTANDING LOADS ASSOCIATED WITH SMALL TRUCKS. 10. PROVIDE STEP IRONS TO ALL PITS GREATER THAN 1.2m DEEP. 11. THE CONTRACTOR SHALL IMPLEMENT ALL SOIL EROSION AND SEDIMENT CONTROL MEASURES PRIOR TO COMMENCEMENT OF WORKS. 12. TOPSOIL SHALL BE STRIPPED DN STOCKPILED OUTSIDE HAZARD AREAS SUCH AS DRAINAGE LINES. THIS TOPSOIL IS TO BE RESPREAD LATER ON AREAS TO BE REVEGETATED. 13. THE CONTRACTOR SHALL REGULARLY MAINTAIN ALL SEDIMENT AND EROSION CONTROL DEVICES AND REMOVE ACCUMULATED SILT FROM SUCH DEVICES. ALL SILT REMOVED SHALL BE DISPOSED OF AS DIRECTED BY THE SUPERINTENDENT. THE PERIOD FOR MAINTAINING THESE DEVICES SHALL BE AT LEAST UNTIL ALL DISTURBED AREAS ARE REVEGETATED AND FURTHER AS MAY BE DIRECTED BY THE SUPERINTENDENT OR COUNCIL.

14. THE CONTRACTOR SHALL MAINTAIN DUST CONTROL UNTIL

FINAL COMPLETION OF WORKS.

L	EGEND
RL 00.000	NEW REDUCED LEVEL
GFL. 00.00	GROUND FLOOR LEVEL
FFL. 00.00	FINISH FLOOR LEVEL
A,B,C,D, etc.	REFER TO PIPE SEHEDULE
L1	PIPE LABEL
PIT P1	SURFACE INLET PIT
• DP	DOWNPIPE
C RWH	RAIN WATER HEAD
	PIT: SIZE AS MARKED
	SEALED PIT: SIZE AS MARKED
	W:200mm x D:200mm GRATED DRAIN
	GROUND FALL
	OVERLAND FLOW
	UPVC PIPE TO RAIN WATER TANK
	UPVC DRAINAGE PIPE IN GROUND
	RWT OVERFLOW PIPE & OUTLET PIPE
	EXISTING DRAINAGE EASEMENT PIPE




	DRAWING TITLE			
ENT ET	BASEMENT AND GROUND FLOOR DRAINAGE LAYOUT PLAN			
	SCALES	DESIGNED	DRAFTED	
	A1 - 1:100	A.C.	M.W.	
	DRAWING NO.	APPROVED	REVISION	
	C22065 -SW 100	A.C.	G	


CONTRACTOR TO EXCAVATE /- & BACKFILL PIT AS PER PIPE LAYING SPECIFICATION

CONCRETE BENCHING/SHAPING TO BASE OF ALL PITS

Min. GRADE 1% 1% \_

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## FIRST FLOOR DRAINAGE PLAN

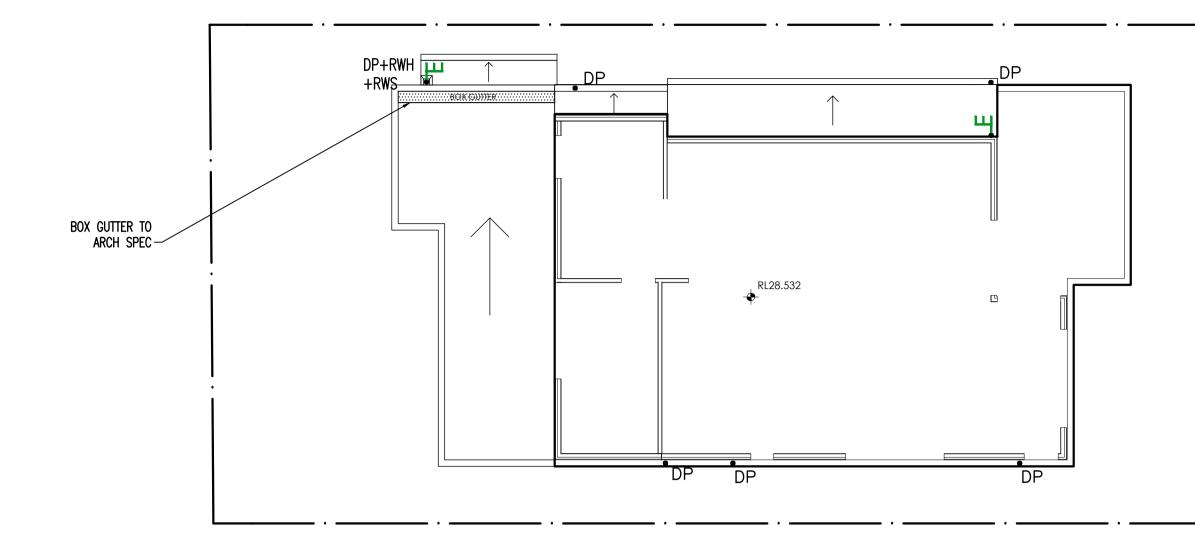
1:100 @ A1

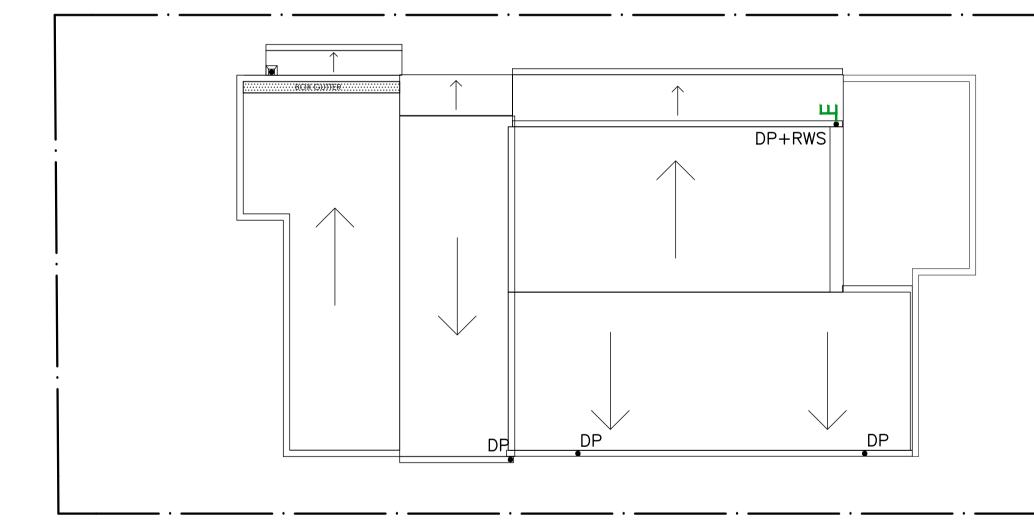ALL DRAINAGE LINES SHALL BE UPVC (CLASS SH) STORMWATER DRAINAGE PIPE, UNO.

ALL DRAINAGE LINES SHALL BE LAID @ 1% FALL MIN, UNO. FIRST FLUSH RAINWATER DEVICES TO BE FITTED TO DRAINAGE LINES TO BUILDER'S DETAIL, TYPICAL MINIMUM EFFECTIVE EAVES GUTTER SIZE = 6700 mm<sup>2</sup> MINIMUM EFFECTIVE EAVES GUTTER SLOPE = 1:500

THE FOLLOWING SYMBOLS & ABBREVIATIONS HAVE BEEN USED:

- DP = Ø100, UNO. FD = FLOOR OUTLET , REFER TO DETAIL
- SIP = SURFACE INLET PIT (NO LINTEL)
- 100Ø = Ø100 CHARGED LINE
- IP = Ø150 INSPECTION POINT
- RWH = RAIN WATER HEAD RWO = RAIN WATER OUTLET (300 x 300)
- FG = FLOOR GULLY Ø150
- = RAINWATER SPREADER
- + RL 16.85 = PROPOSED FINISHED SURFACE LEVEL

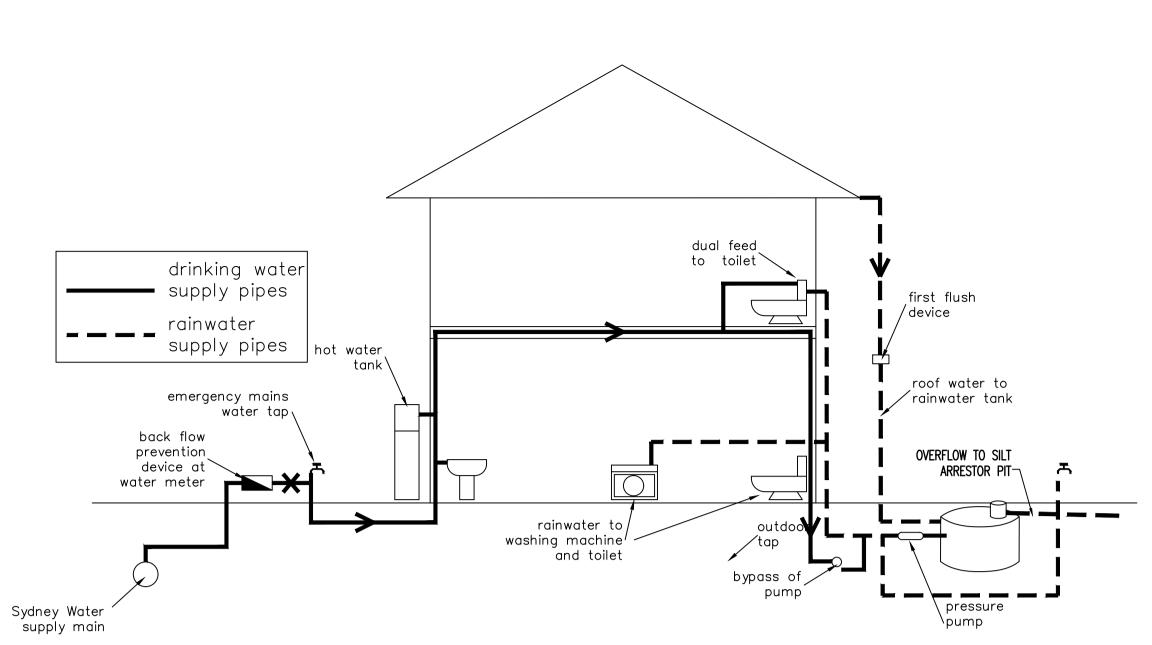

## RAINWATER TANK EXPLANATORY DIAGRAM

SCALE : NTS NOTE:


2.A SIGN STATING NOT FOR DRINKING MUST BE AFFIXED TO THE TANK AND OR TAP FIXTURE BACKGROUND NOISE LEVELS

1:100 @ A1
ALL DRAINAGE LINES SHALL BE UPVC (CLASS SH) STORMWATER DRAINAGE PIPE, UNO.
ALL DRAINAGE LINES SHALL BE LAID @ 1% FALL MIN, UNO. FIRST FLUSH RAINWATER DEVICES TO BE FITTED TO DRAINAGE LINES TO BUILDER'S DETAIL, TYPICAL MINIMUM EFFECTIVE EAVES GUTTER SIZE = 6700 mm <sup>2</sup> MINIMUM EFFECTIVE EAVES GUTTER SLOPE = 1:500
THE FOLLOWING SYMBOLS & ABBREVIATIONS HAVE BEEN USED: DP = $\emptyset$ 100, UNO.

- FD = FLOOR OUTLET , REFER TO DETAIL
- SIP = SURFACE INLET PIT (NO LINTEL)

ROOF DRAINAGE PLAN

- 100Ø = Ø100 CHARGED LINE
- IP = Ø150 INSPECTION POINT
- RWH = RAIN WATER HEAD
- RWO = RAIN WATER OUTLET (300 x 300)
- FG = FLOOR GULLY Ø150 E = RAINWATER SPREADER
- RL 16.85 = PROPOSED FINISHED SURFACE LEVEL

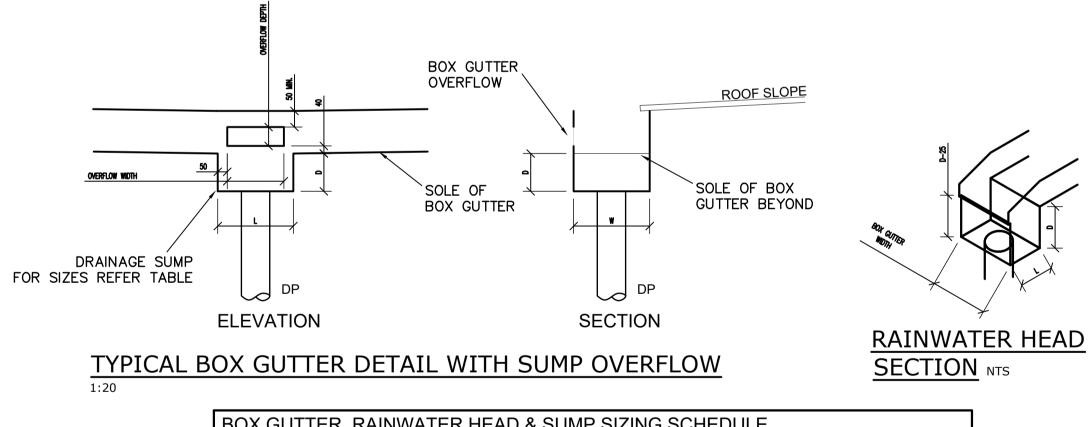

BOX GUTTER, RAINWATER HEAD & SUMP SIZING SCHEDULE					
NODE	BOX GUTTER SIZE	RAINWATER HEAD SIZE	SUMP SIZE	OVERFLOW TO SUMP	DOWNPIPE Ø mm
BG1	300W x 150D	150Lx300Wx200H	200L X 150D	200W X 100H	150



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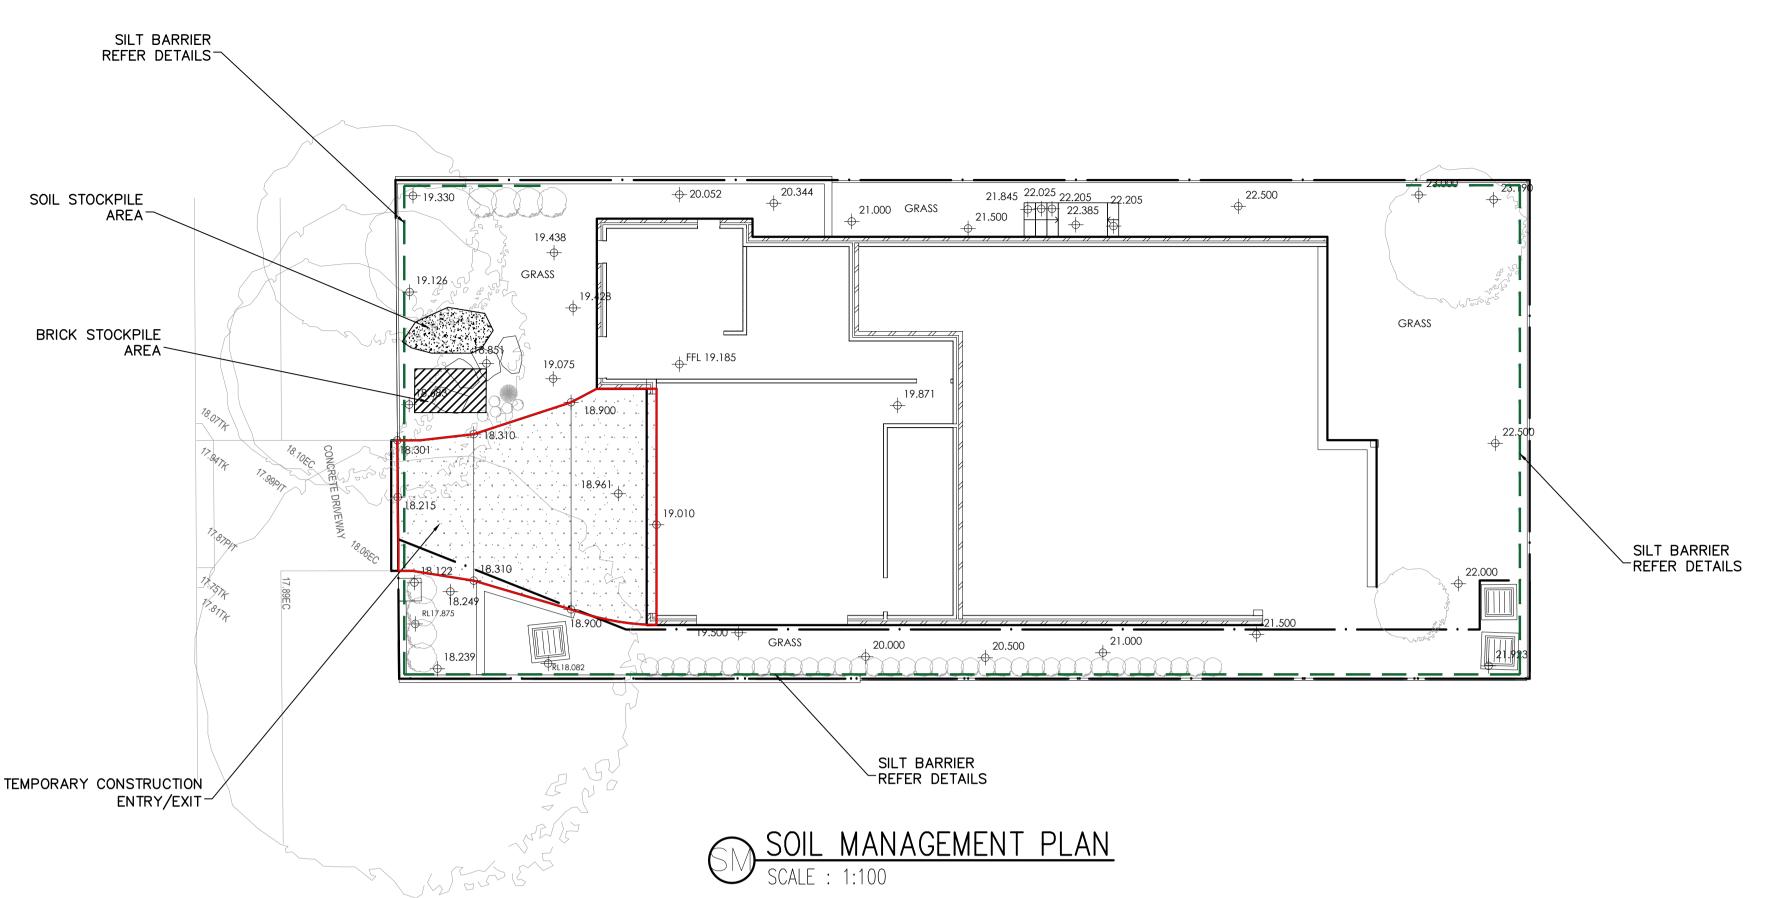
ALL CORRESPONDENCE TO: P.O. BOX 6080 BAULKHAM HILLS BC BAULKHAM HILLS NSW 2153


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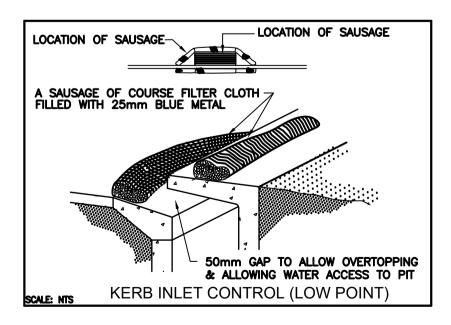
PROJECT PROPOSED DEVELOPMENT LOT 2, 6 ORCHARD STREET WARRIEWOOD	DRAWING TITLE FIRST FLOOR AND ROOF DRAINAGE PLAN				
SKYCORP	SCALES	DESIGNED	drafted		
	A1 - 1:100	A.C.	M.W.		
ARCHITECT / PROJECT MANAGER	DRAWING NO.	APPROVED	REVISION		
PTI ARCHITECTURE	C22065 -SW 101	A.C.	G		

1. TANK WATER IS NOT RECOMMENDED FOR HUMAN CONSUMPTION.

3.ANY PUMP INSTALLED FOR THE RAINWATER TANKS IS TO BE NO LOUDER THAN 5dB(A) ABOVE





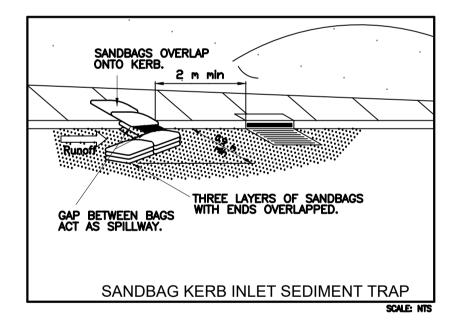


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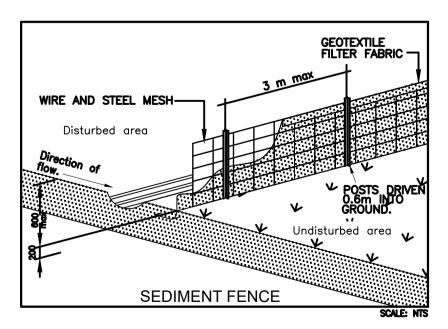
## SOIL EROSION CONTROL INSTRUCTIONS

- OTHERWISE NTOED, THAN:
- OF "MANAGING URBAN STORMWATER SOILS AND
- LATER.
- MILLET 20KG/HA AND OATS.
- 20KG/HA
- SHOULS BE USED.

### DUST CONTROL INSTRUCTIONS

- PROBLEM AREA.



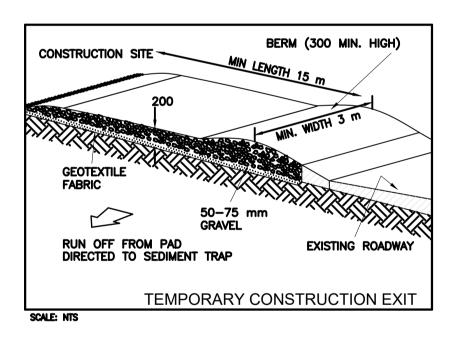



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PROJECT PROPOSED DEVELOPME LOT 2, 6 ORCHARD STRE WARRIEWOOD CLIENT SKYCORP

ARCHITECT / PROJECT MANAGER PTI ARCHITECTURE

 EARTH BATTERS WILL BE CONSTRUCTED WITH AS LOW AS A GRADIENT AS PRACTICABLE BUT NO STEEPER, UNLESS

-2(H): 1(V) WHERE SLOPE LENGTH LESS THAN 12 METRES -2.5(H): 1(V) WHERE SLOPE LENGTH BETWEEN 12 & 16 METRES -3(H):1(V) WHERE SLOPE LENGTH BETWEEN 16 & 20 METRES -4(H):1(V) WHERE SLOPE LENGTH GREATER THAN 20 METRES ALL WATERWAYS, DRAINS, SPILLWAYS AND THEIR OUTLETS WILL BE CONSTRUCTED TO BE STABLE IN AT LEAST THE 1:20 YEAR ARI, TIME OF CONCENTRATION STORM EVENT.

• WATERWAYS AND OTHER AREAS SUBJECT TO CONCENTRATED FLOWS AFTER CONSTRUCTION ARE TO HAVE A MAXIMUM GROUNDCOVER C-FACTOR OF 0.05 (70% GROUND COVER) WITHIN 10 WORKING DAYS FROM COMPLETION OFFORMATION. FLOW VELOCITIES ARE TO BE LIMITED TO THOSE SHOWN INTABLE 5-1

CONSTRUCTION DEPT OF HOUSING 1998 (BLUE BOOK). FOOT AND VEHICULAR TRAFFIC WILL BE PROHIBITED IN THESE AREAS. • STOCKPILES AFTER CONSTRUCTION ARE TO HAVE A MAXIMUM GROUND COVER C-FATOR OF 0.1 (60% GROUND COVER) WITHIN 10 WORKING DAYS FROM COMPLETION OF FORMATION. • ALL LANDS, INCLUDING WATERWAYS AND STOCKPILES, DURING CONSTRUCTION ARE TO HAVE A MAXIMUM GROUND COVER C-FACTOR OF 0.15 (50% GROUND COVER) WITHIN 20 WORKING DAYS FROM INACTIVITY EVEN THOUGH WORKS MAY CONTINUE

• FOR AREAS OF SHEET FLOW USE THE FOLLOWING GROUND COVER PLANT SPECIES FOR TEMPORARY COVER: JAPANESE


• PERMANENT REHABILITATION OF LANDS AFTER CONSTRUCTION WILL ACHIEVE A GROUND COVER C-FACTOR OF LESS THAN 0.1 AND LESS THAN 0.05 WITHIN 60 DAYS. NEWLY PLANTED LANDS WILL BE WATERED REGULARLY UNTIL AN EFFECTIVE COVER IS ESTABLISHED AND PLANTS ARE GROWING VIGOROUSLY FOLLOW-UP SEED AND FERTILISER WILL BE APPLIED AS

• REVEGATATION SHOULD BE AIMED AT RE-ESTABLISHING NATURAL SPECIES. NATURAL SURFACE SOILS SHOULD BE REPLACED AND NON-PERSISTANT ANNUAL COVER SROPS

 ALL STOCKPILED MATERIAL OR SEDIMENT COLLECTION TO BE SPRAYED BY LIGHTLY WIDE ANGLED WATER • THIS TEMPORARY MECHANICAL METHOD CONFINES AND SETTLES THE DUST FROM THE AIR BY DUST AND WATER PARTICLE ADHESION. WATER IS SPRAYED THROUGH NOZZELS OVER THE

TEMPORARY STABILISATION OF / SURFACE. (BMPS 9–21)	
EARTH BANK (BMP22A) WHERE NECESSARY TO CONTROL RUNOFF AND PREVENT SCOUR OF STOCKPILE.	
Direction of flow Stockpile	
SOIL STOCKPILE DETAILS (1.15)	

ENT ET	SOIL MANAGEMENT	PLAN		
	scales	DESIGNED	DRAFTED	
	A1 - 1:100	A.C.	M.W.	
	DRAWING NO.	APPROVED	REVISION	
	C22065 -SW 102	A.C.	G	

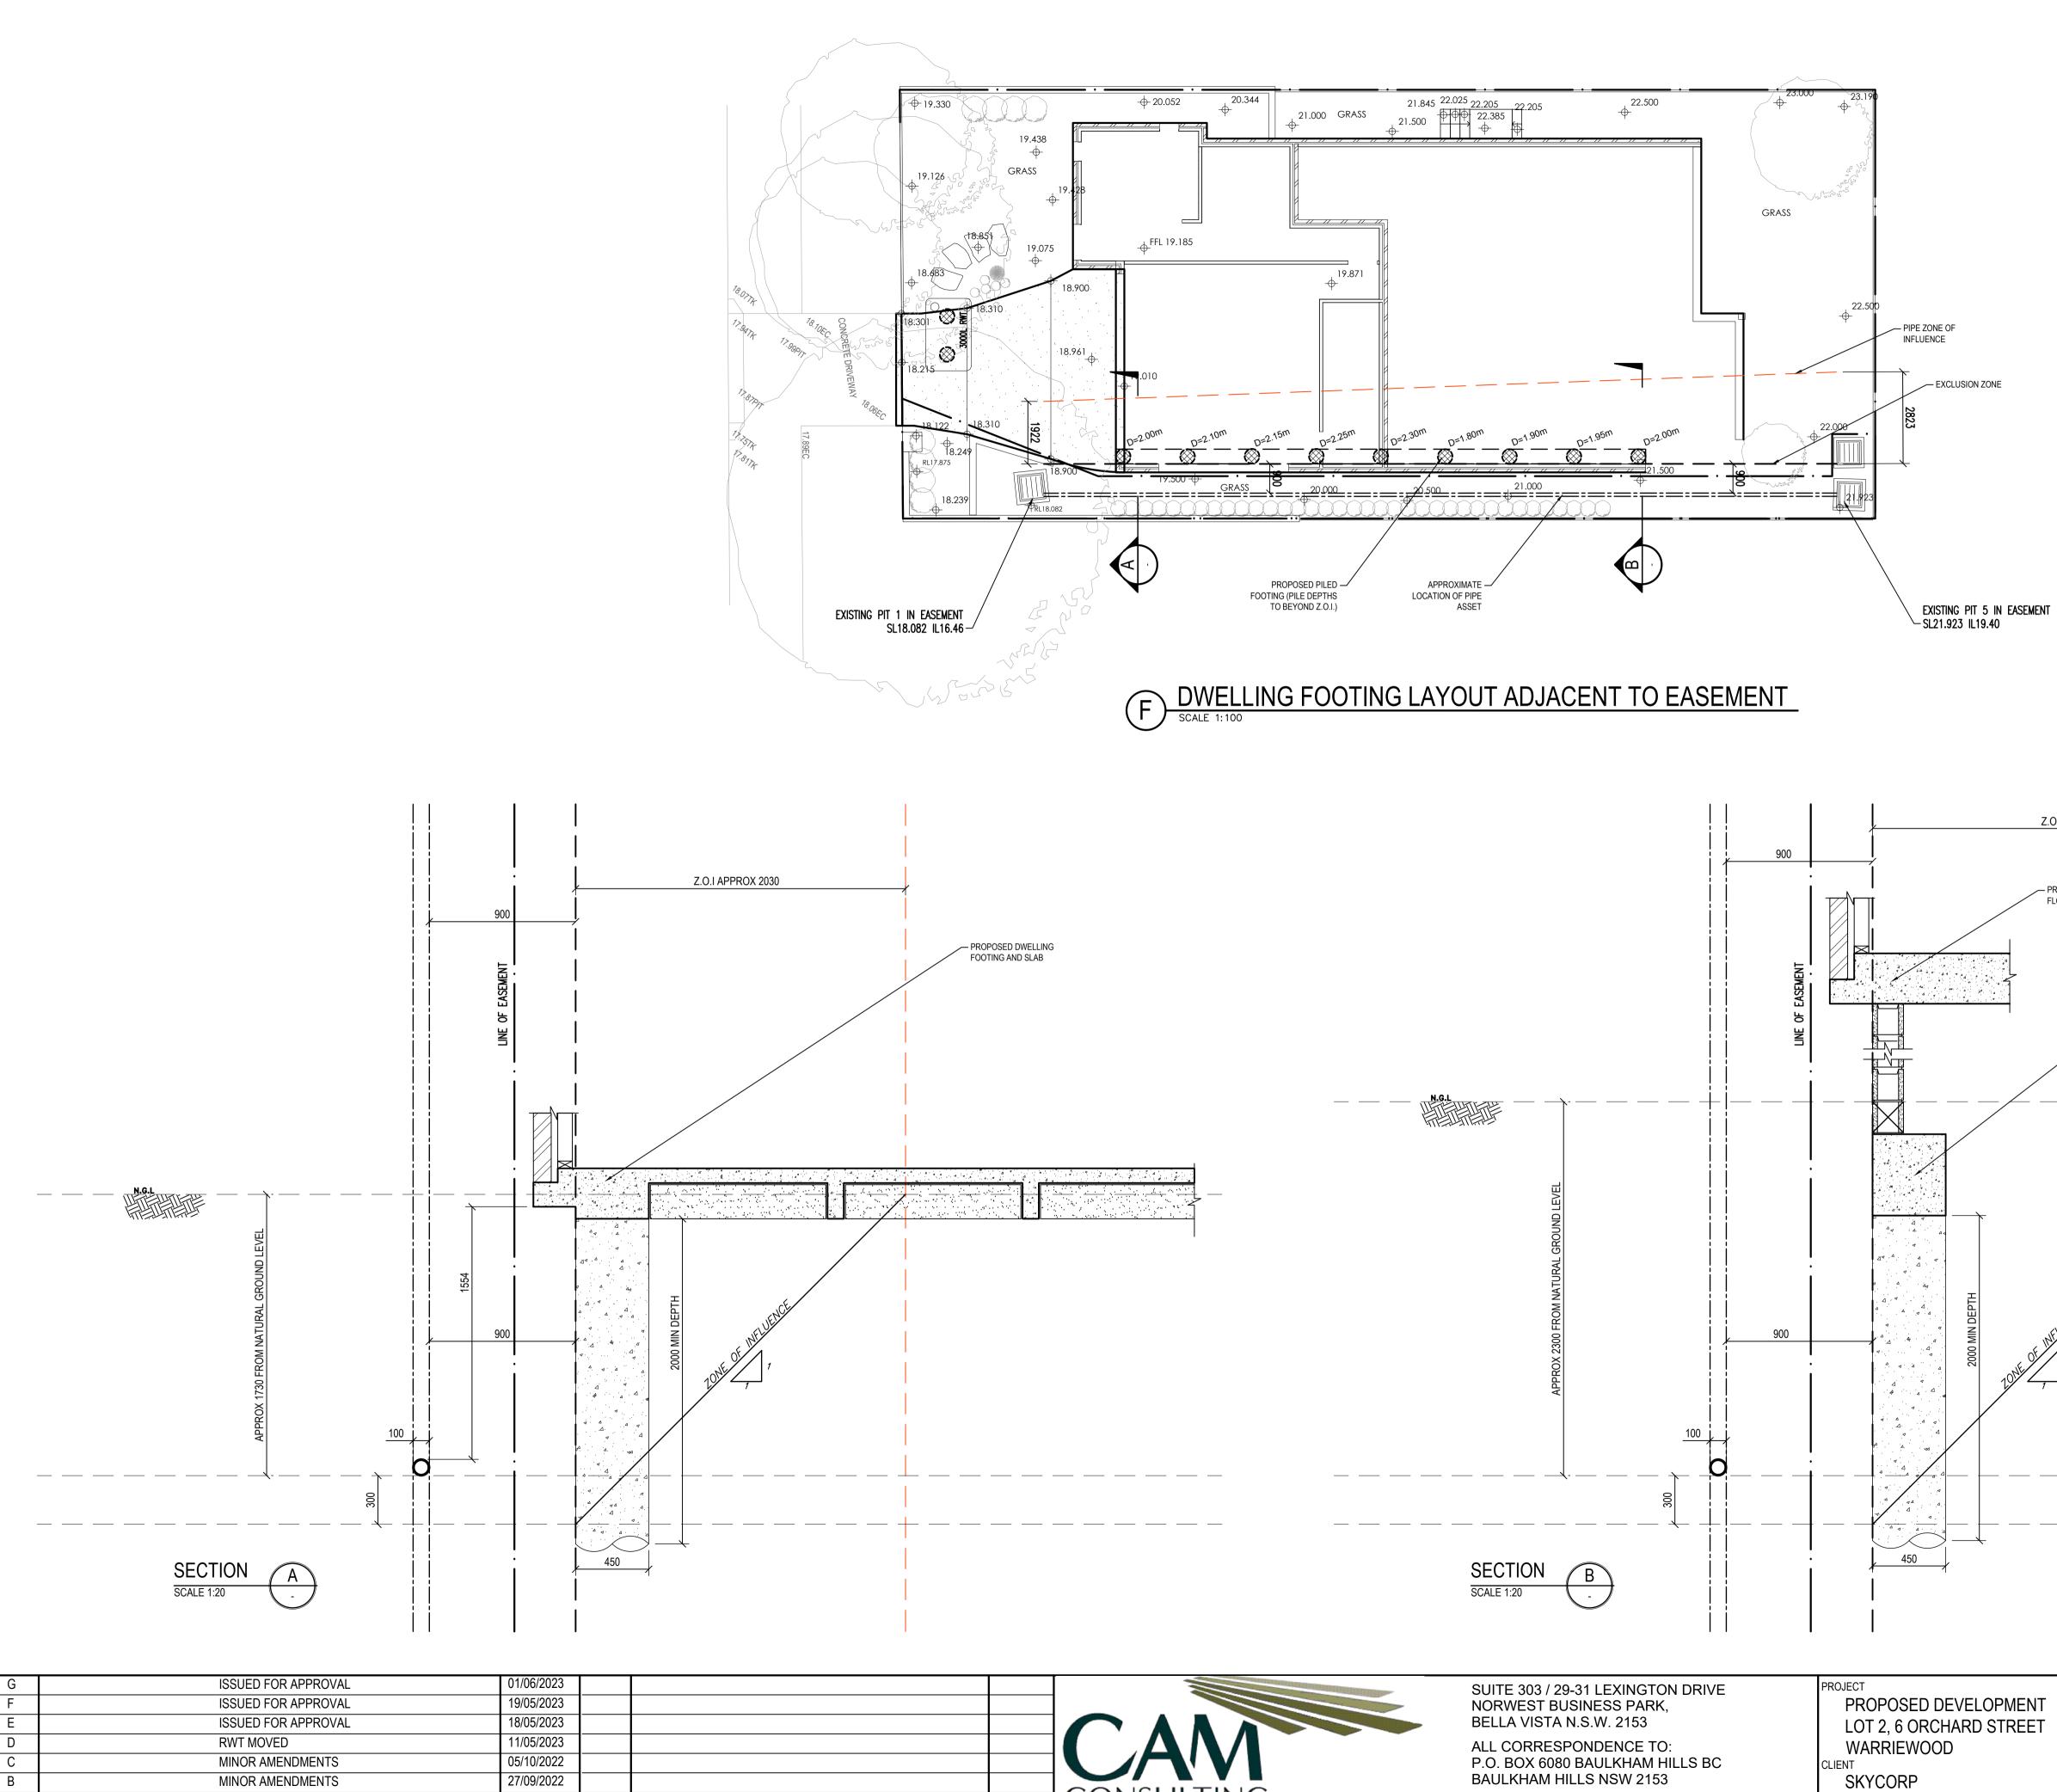

CONSULTING

STRUCTURAL& CIVIL ENGINEERS

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ARCHITECT / PROJECT MANAGER

PTI ARCHITECTURE

# LEGEND ∞ DENOTES MINIMUM DEPTH OF PIER DENOTES PIERS IN EFFECTED ZONE OF INFLUENCE (Z.O.I). MINIMUM DEPTH FOR STORMWATER REQUIREMENTS ONLY. REFER TO ENGINEERING PLANS FOR BEARING AND REINFORCEMENT. Z.O.I APPROX 2600 - PROPOSED GROUND FLOOR ABOVE N.G.L. - PROPOSED DWELLING FOOTING DRAWING TITLE DWELLING FOOTING LAYOUT ADJACENT TO EASEMENT STORMWATER ASSET SCALES A1 - 1:100 DESIGNED DRAFTED M.W. A.C. REVISION G DRAWING NO. APPROVED C22065 -SW 103 A.C.