DA APPLICATION 48-50 EUROBIN AVENUE CHANGE OF USE, DEMOLITION OF EXISTING BUILDINGS AND CONSTRUCT OF NEW 8 TEMPORARY CLASSROOMS



LOCATION MAP







project: STELLA /	MARIS COLLEGE	DRAWING TITLE : COVER PAGE					
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SITE:	48-50 EUROBIN AVENUE, MANLY NSW 2095 AUS	CHECKED BY	JH	PROJECT NO.	1235		


STELLA MARIS COLLEGE 48-50 EUROBIN AVENUE, MANLY NSW 2095 AUS


SHEET NO.	DESCRIPTION	Drawing Scales
DA_000	COVER PAGE	
DA_001	LOT CONSOLIDATION PLAN	1:300
DA_002	EXISTING SITE ANALYSIS PLAN	1:400
DA_003	EXISTING & DEMOLITION SITE PLAN	1:400
DA_004	PROPOSED SITE PLAN	1:400
DA_005	PROPOSED SITE PLAN AFTER DEMOLITION OF TEMPORARY STRUCTURE	1:400
DA_101	EXISTING & DEMOLITION PLAN	1:100
DA_111	PROPOSED FLOOR PLAN	1:100
DA_112	PROPOSED ROOF PLAN	1:100
DA_401	ELEVATIONS	1:100
DA_403	SECTIONS	1:100
DA_410	FENCE DETAILS	1:100
DA_501	EXISTING SHADOW DIAGRAM	


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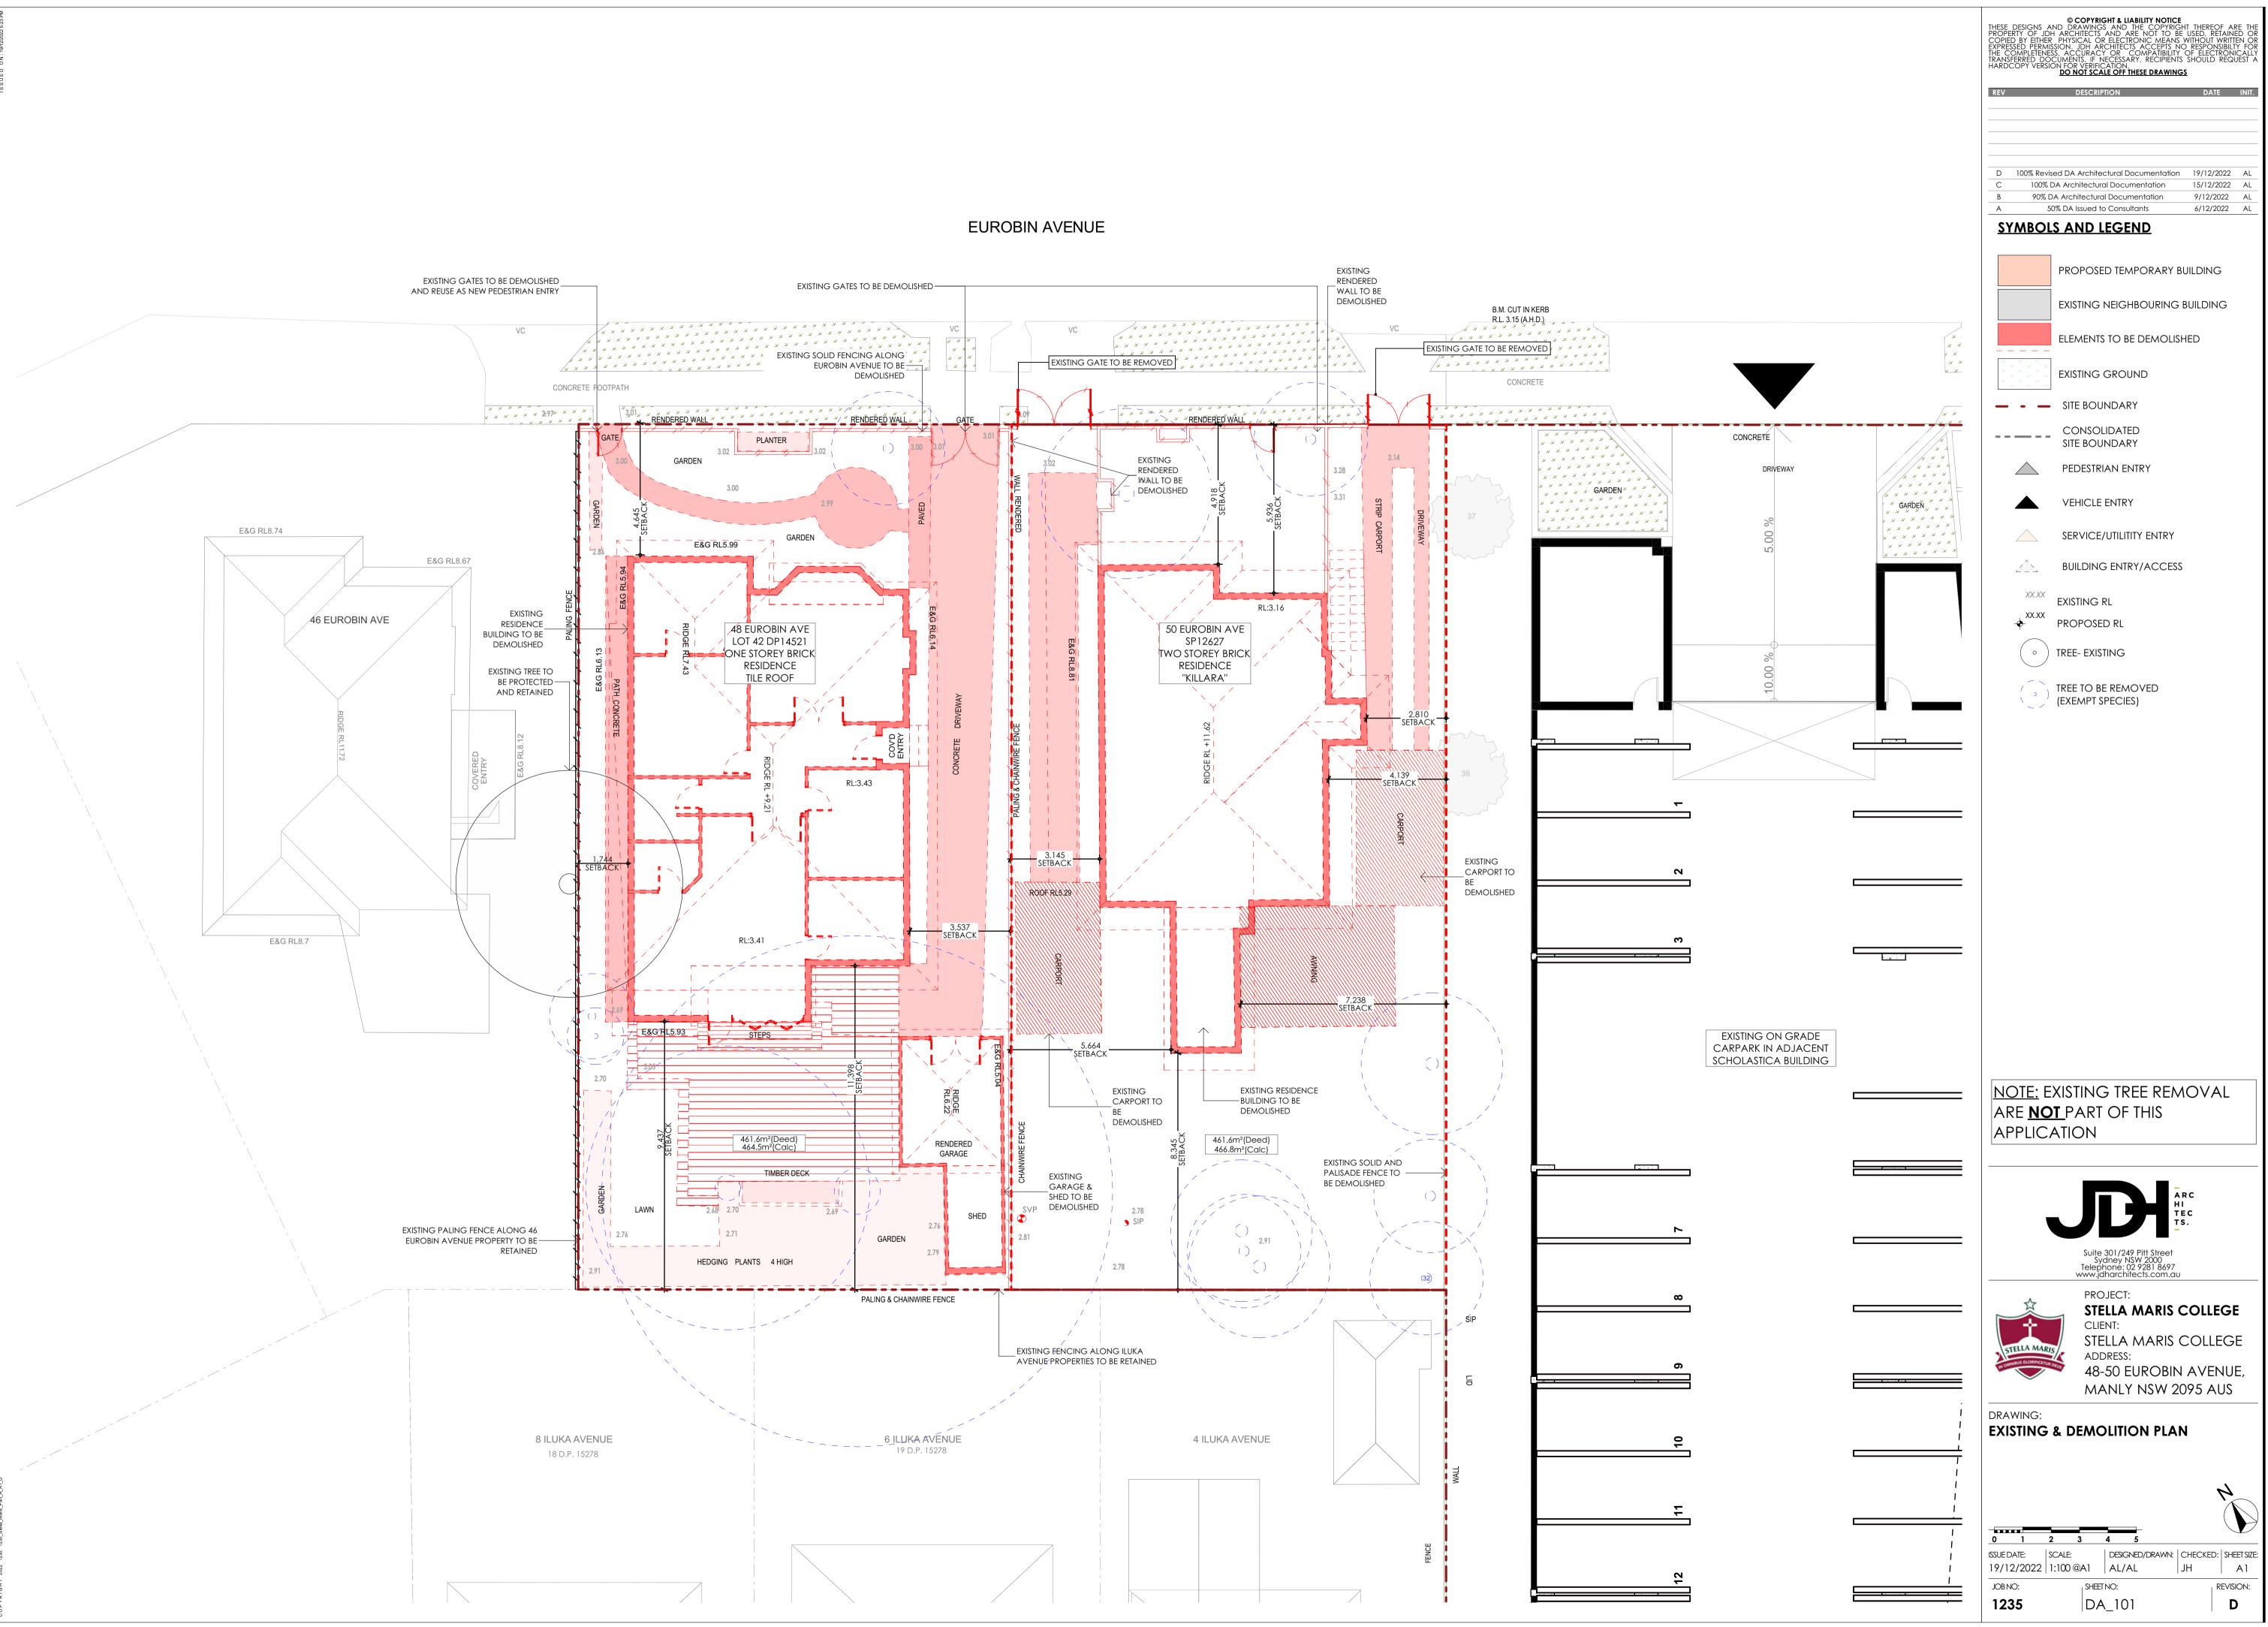


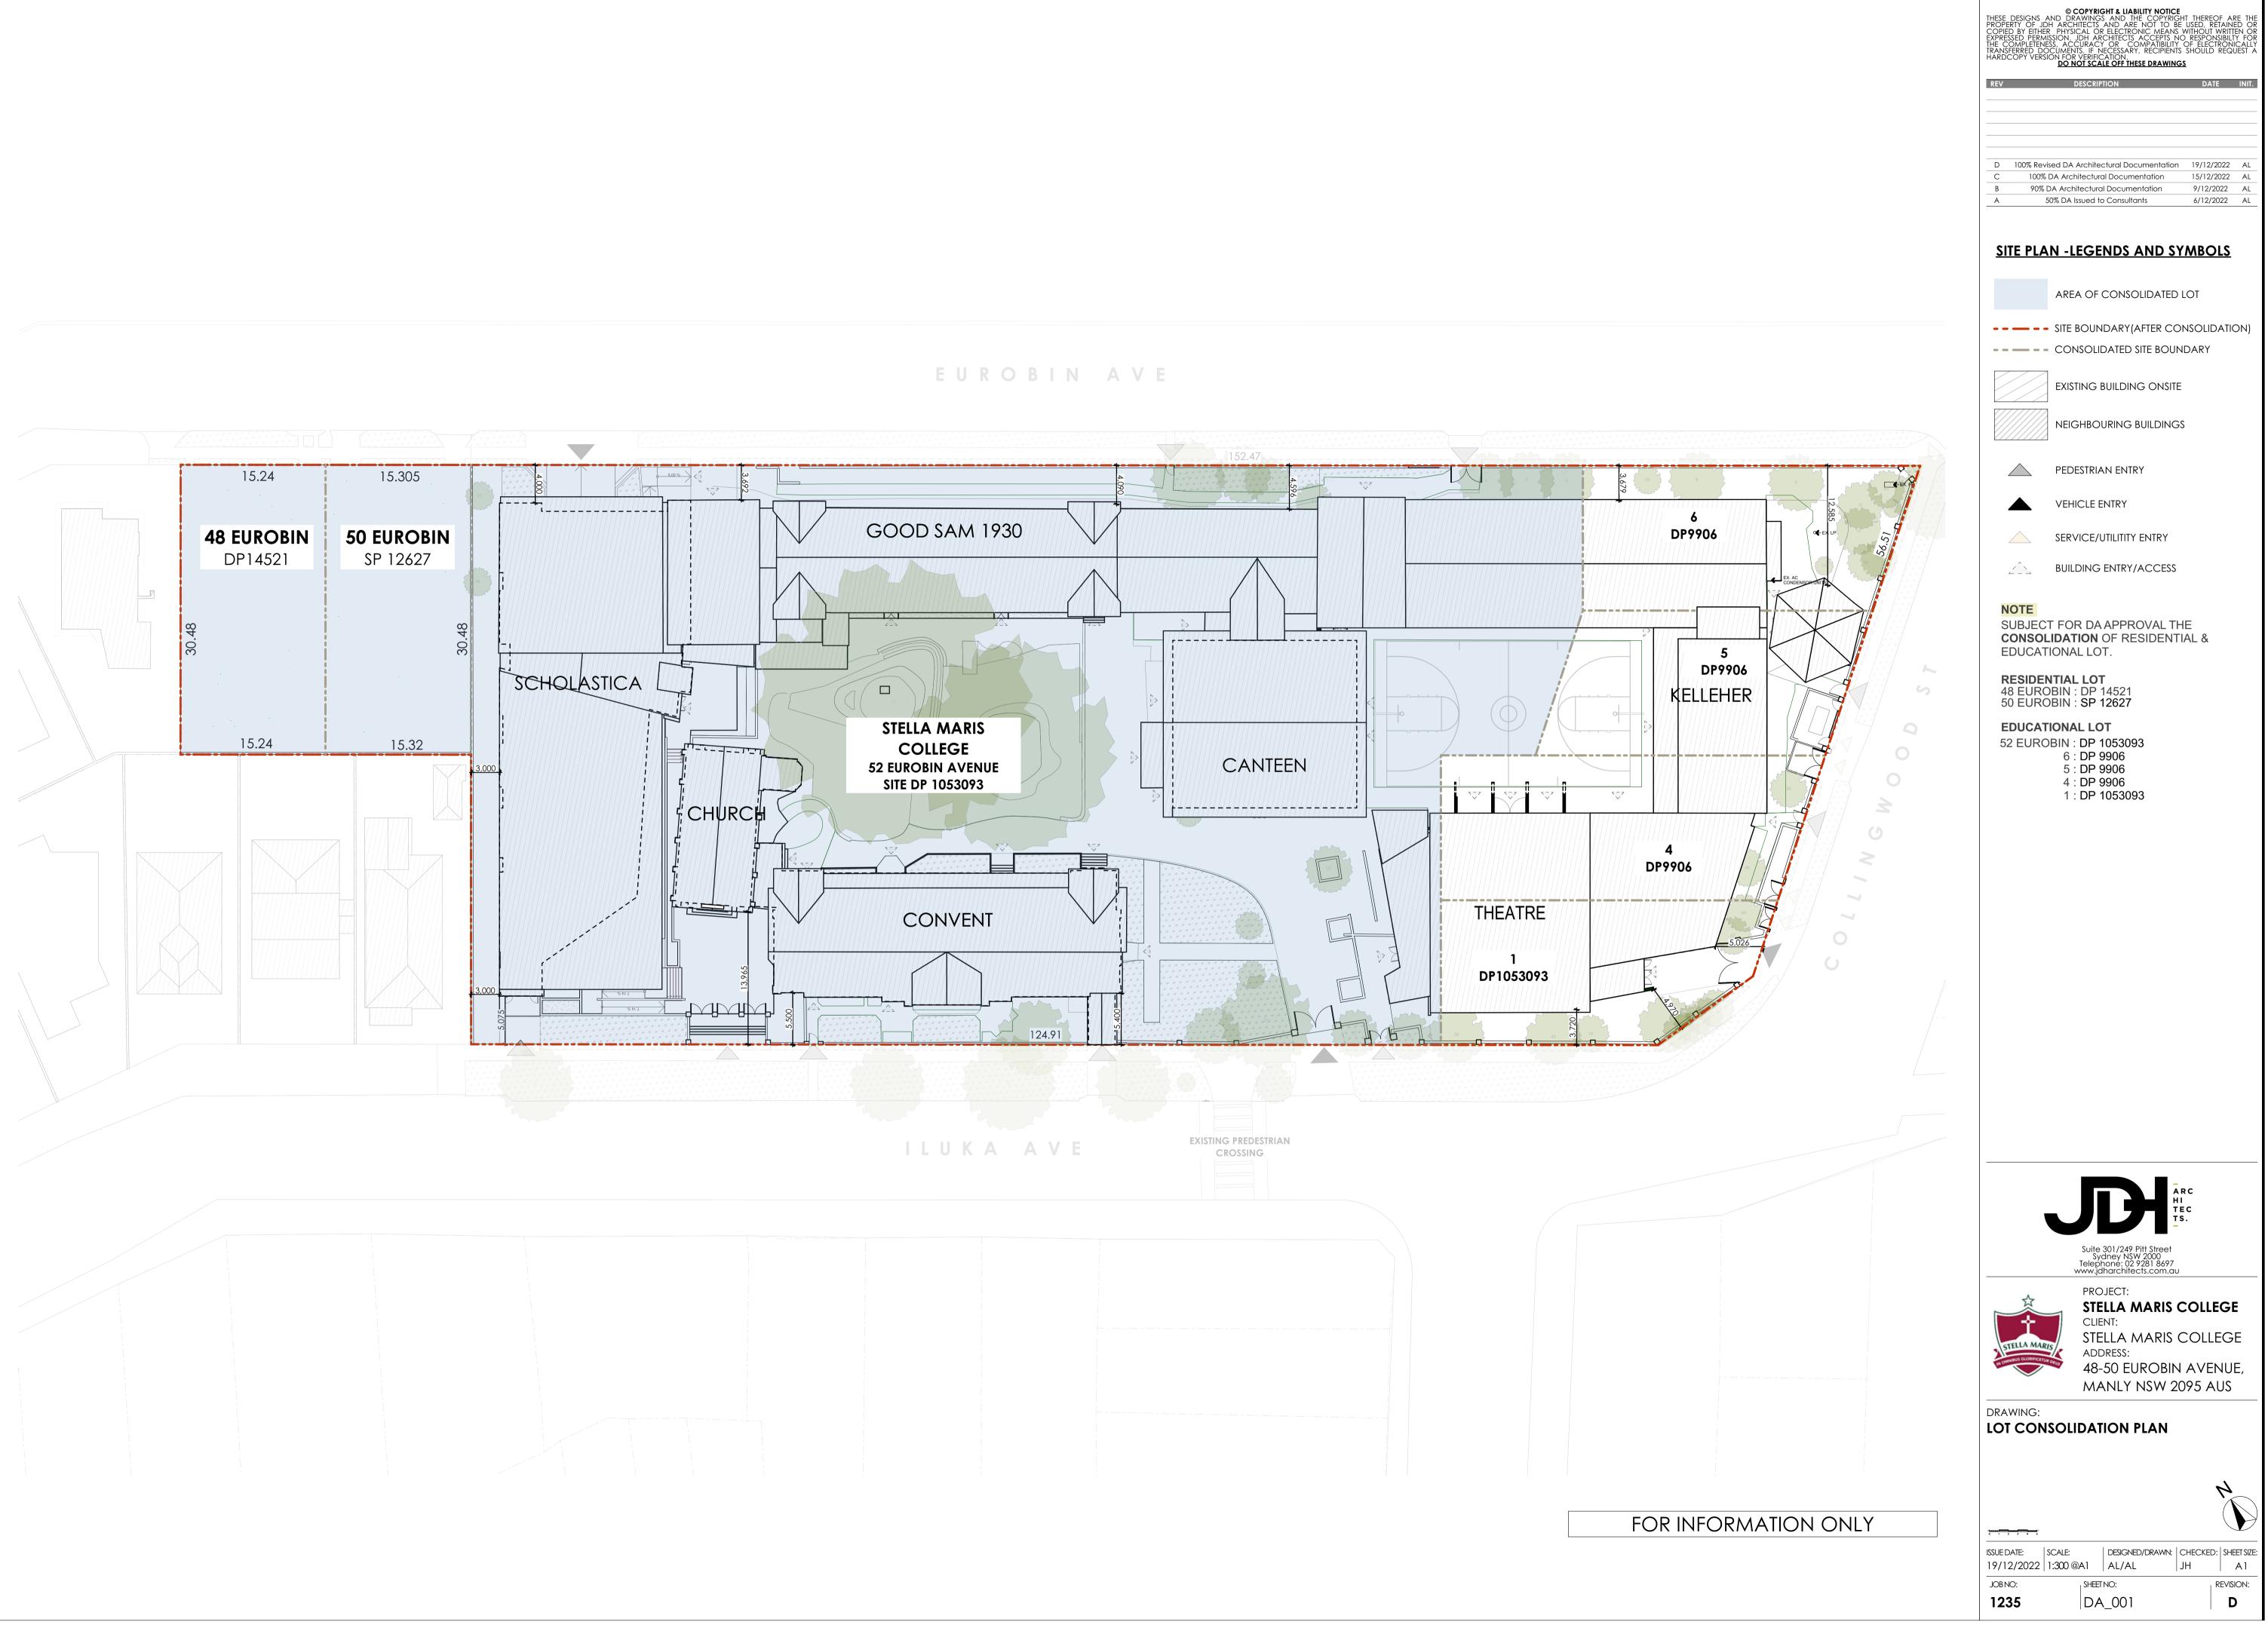


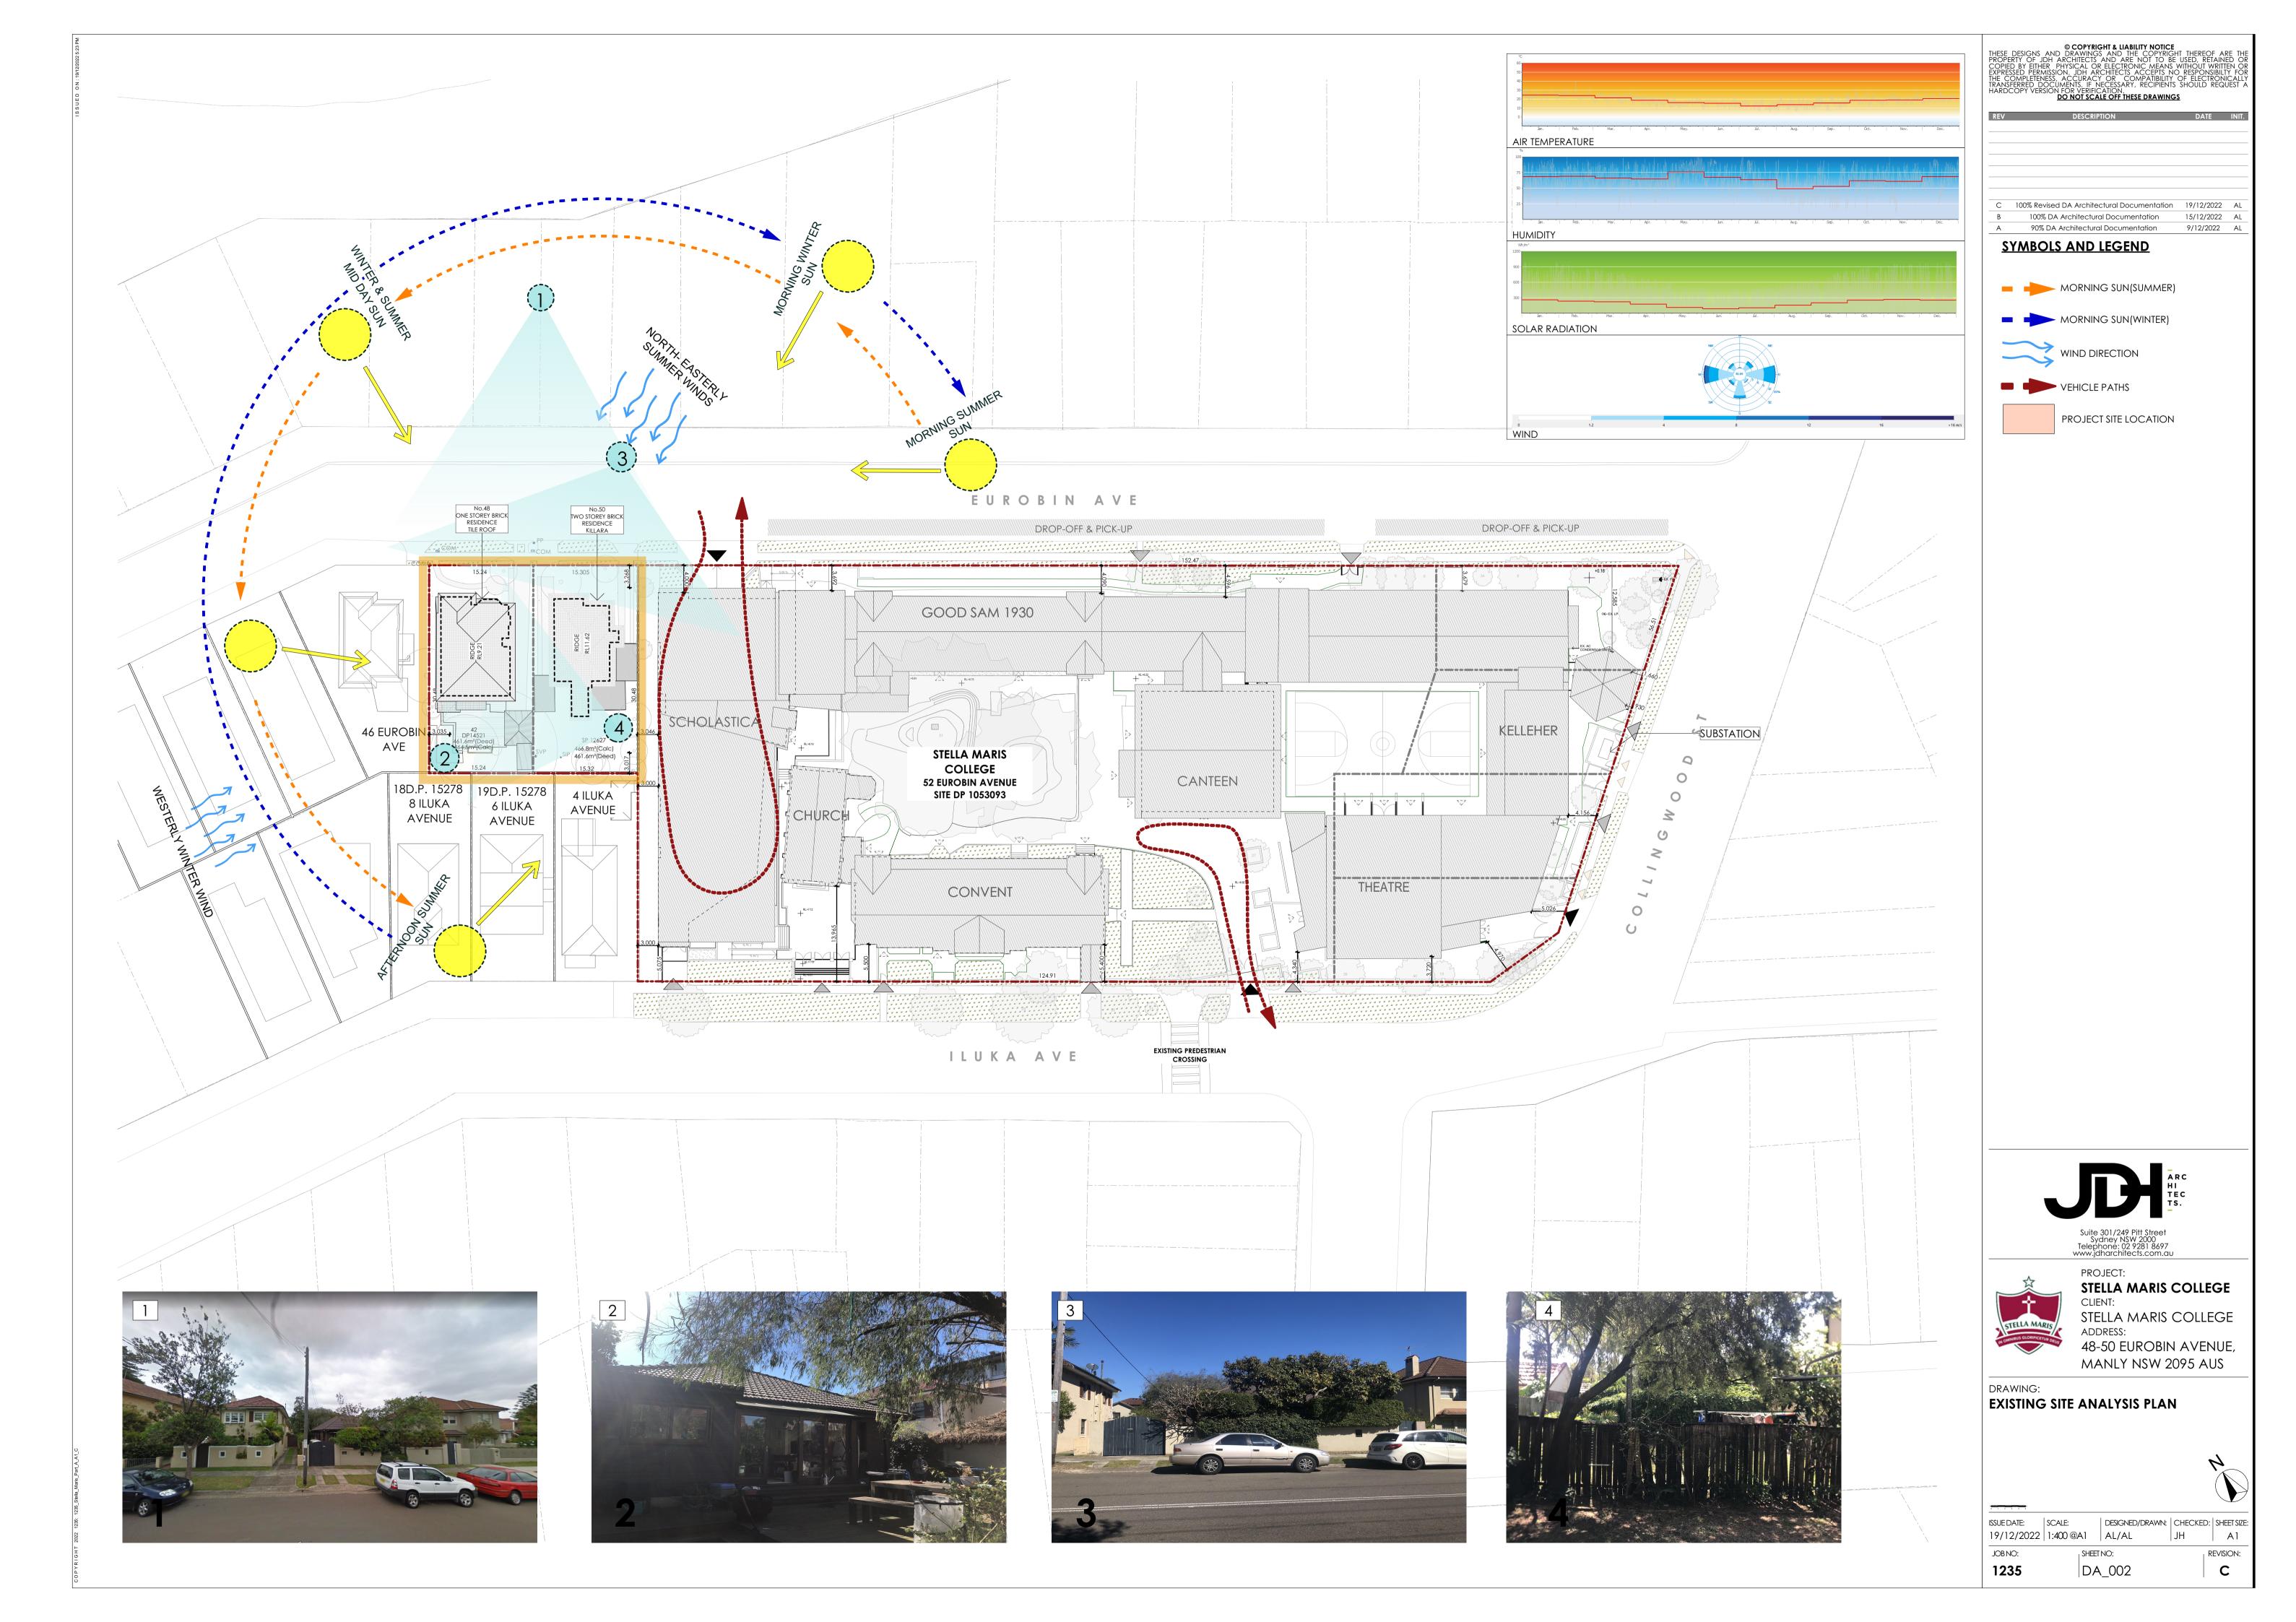
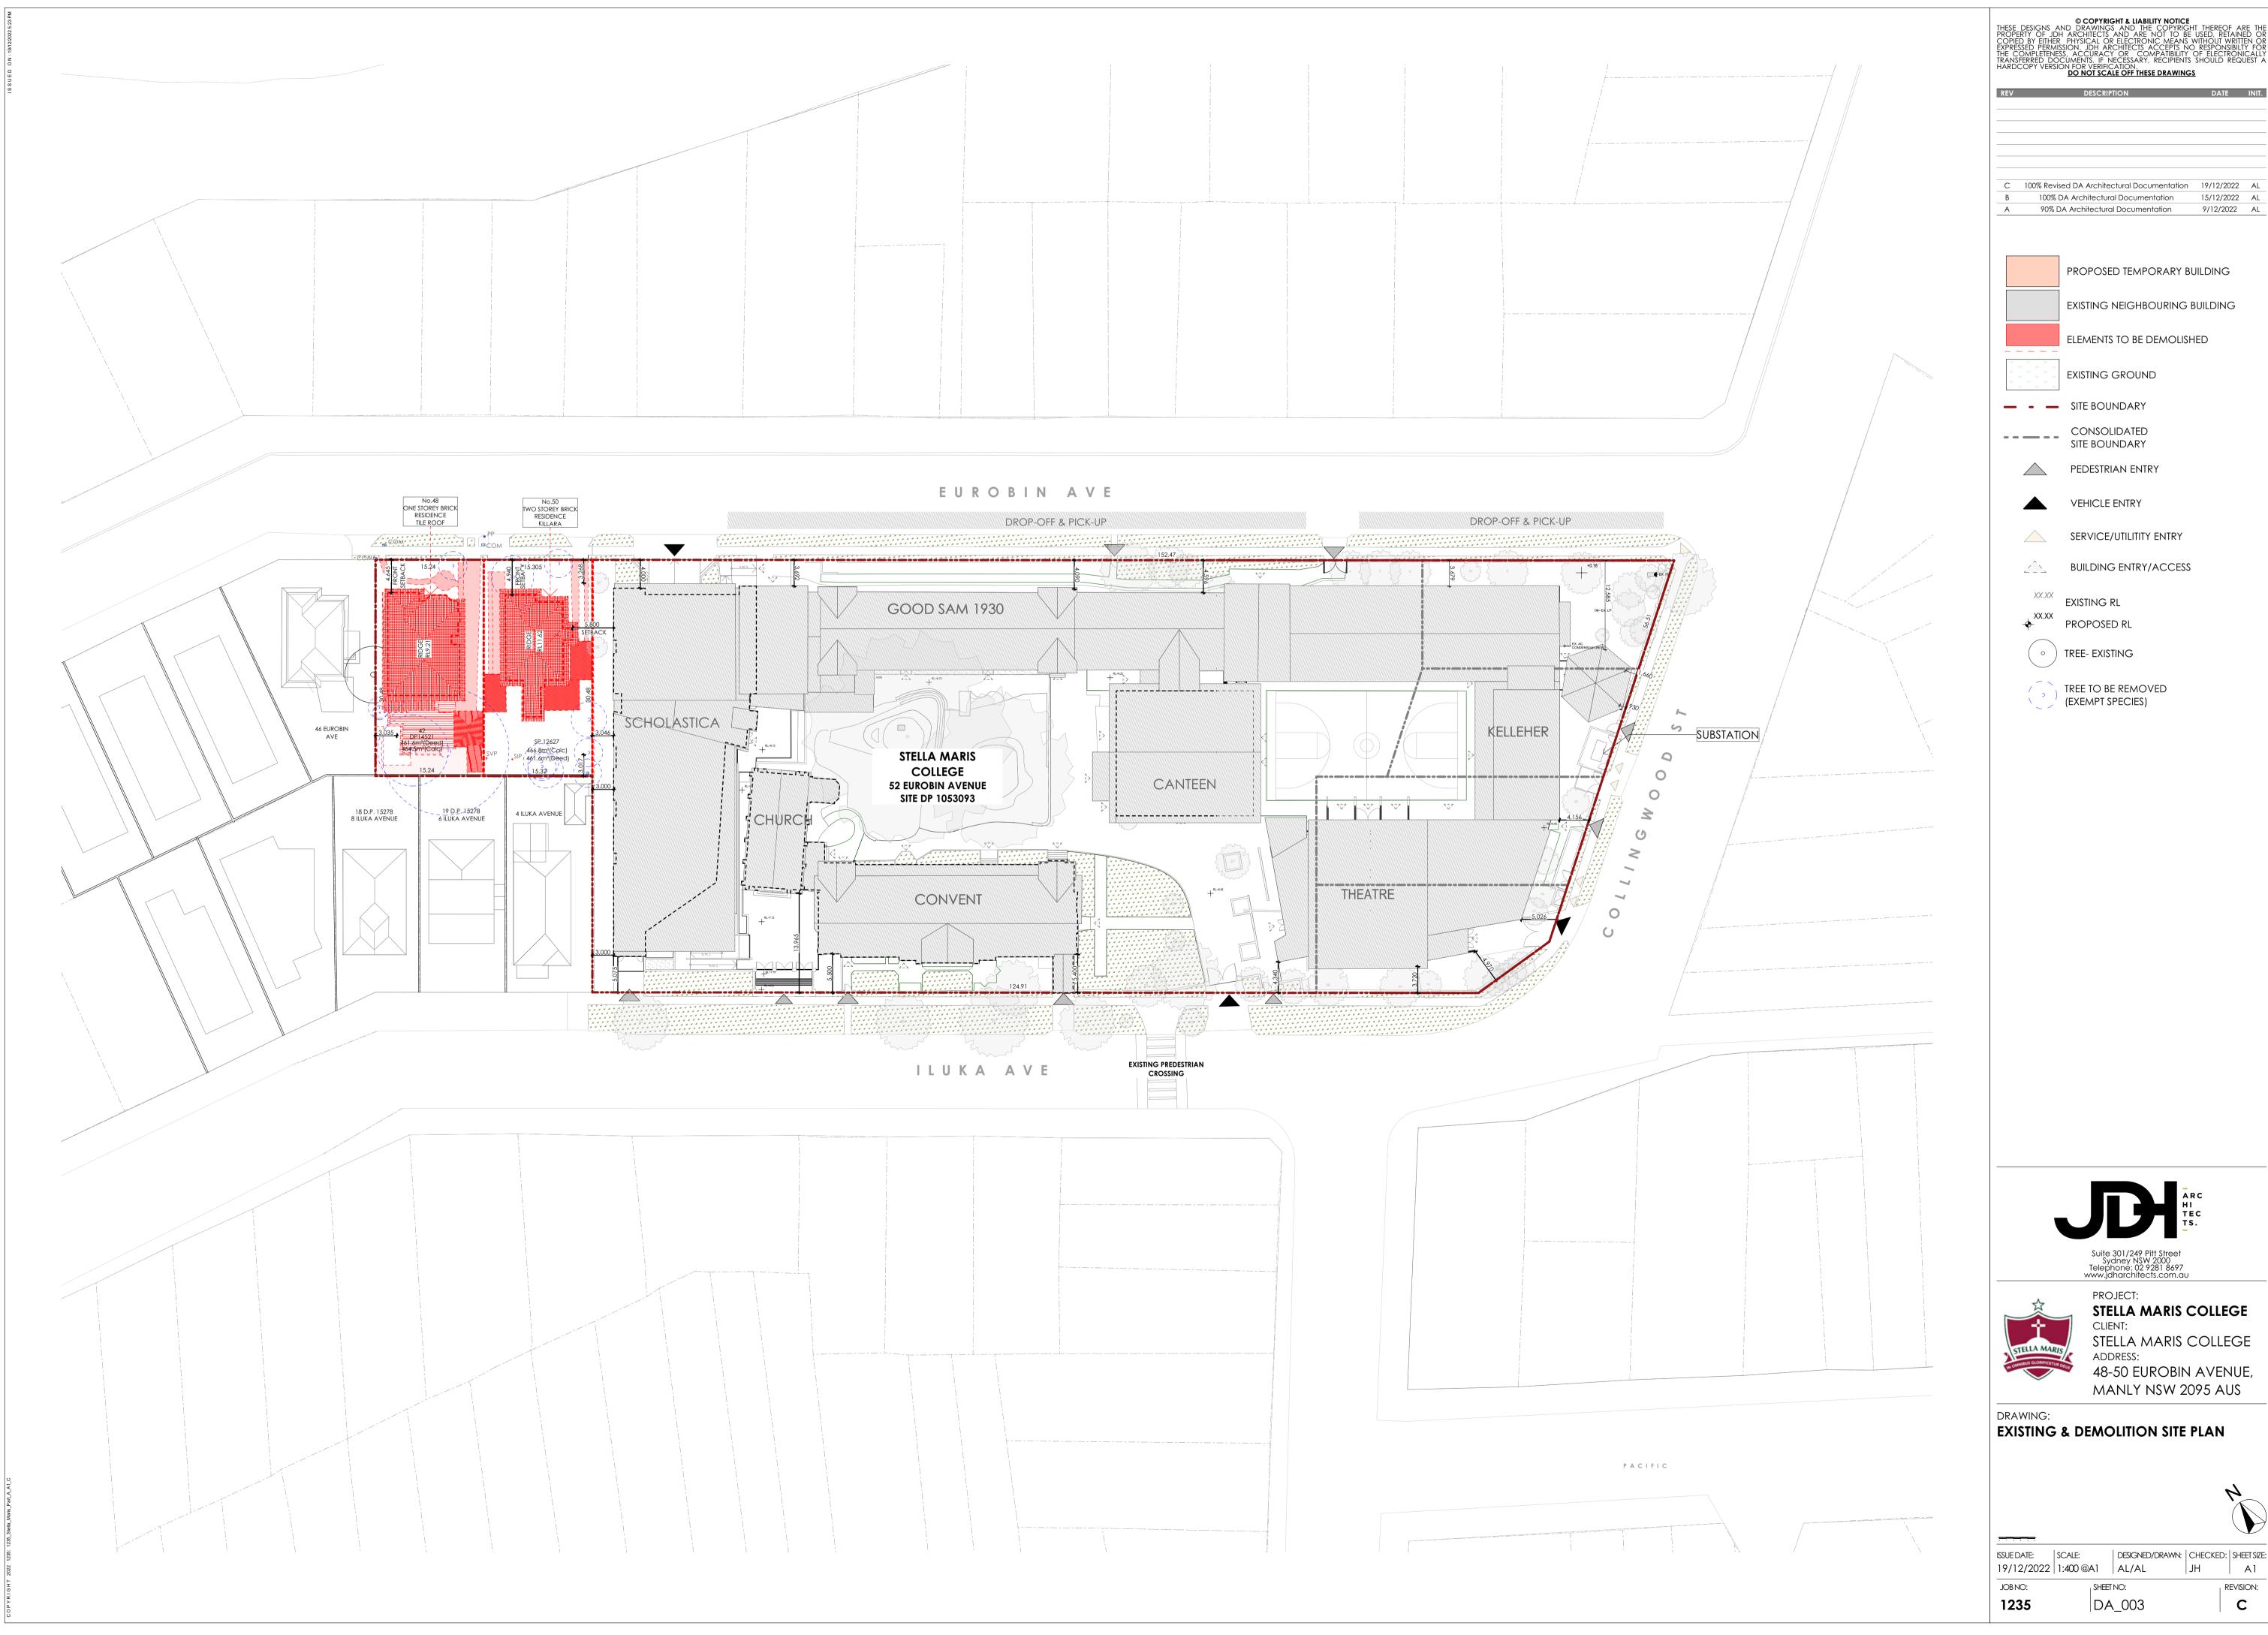
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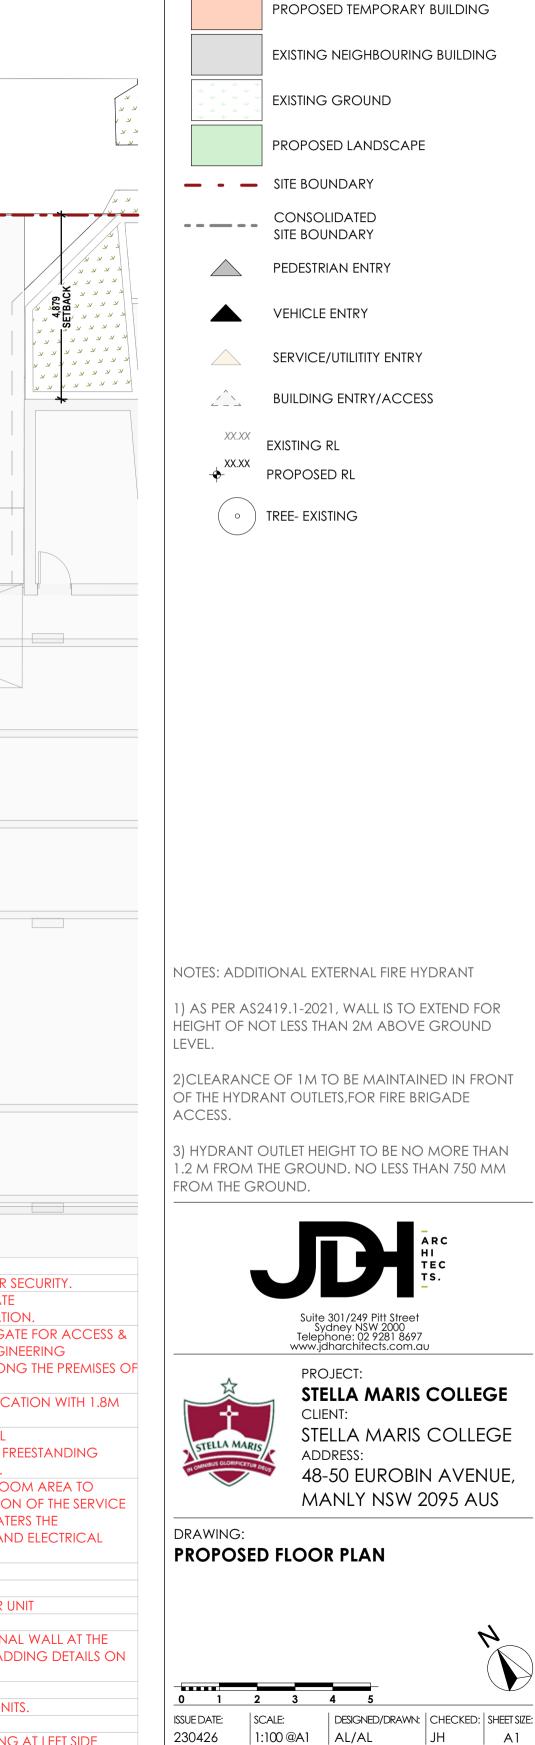
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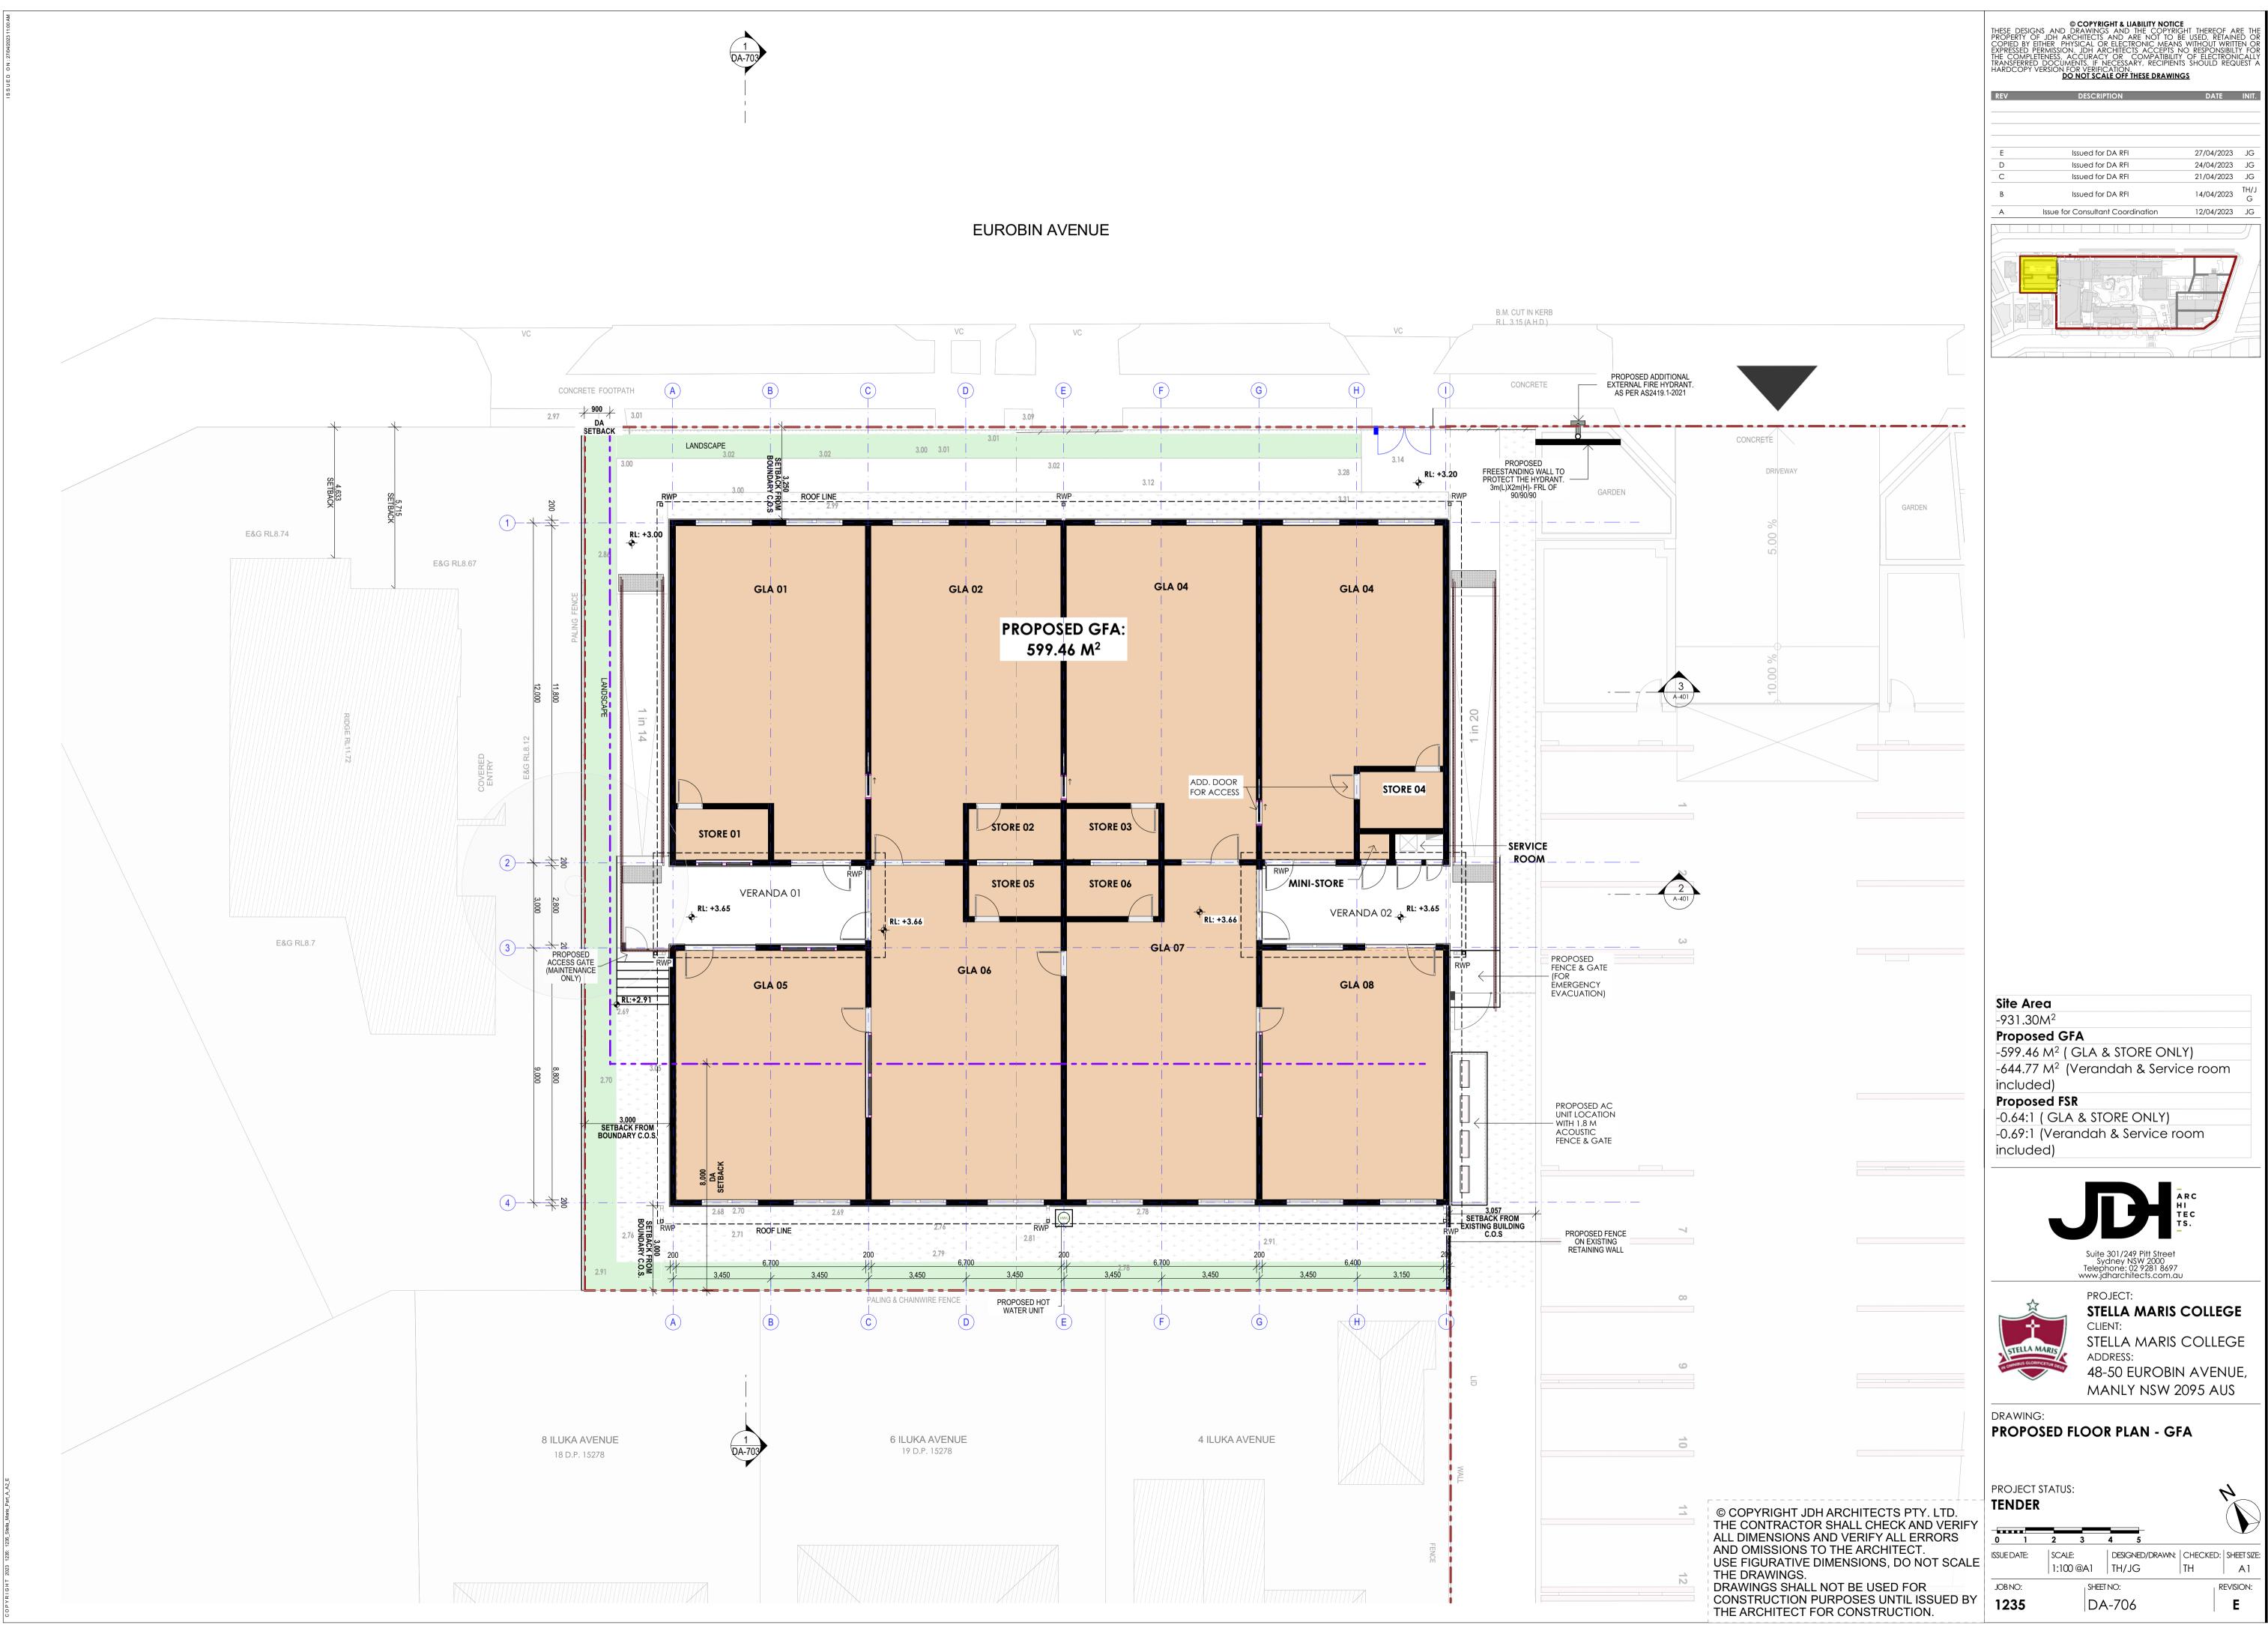
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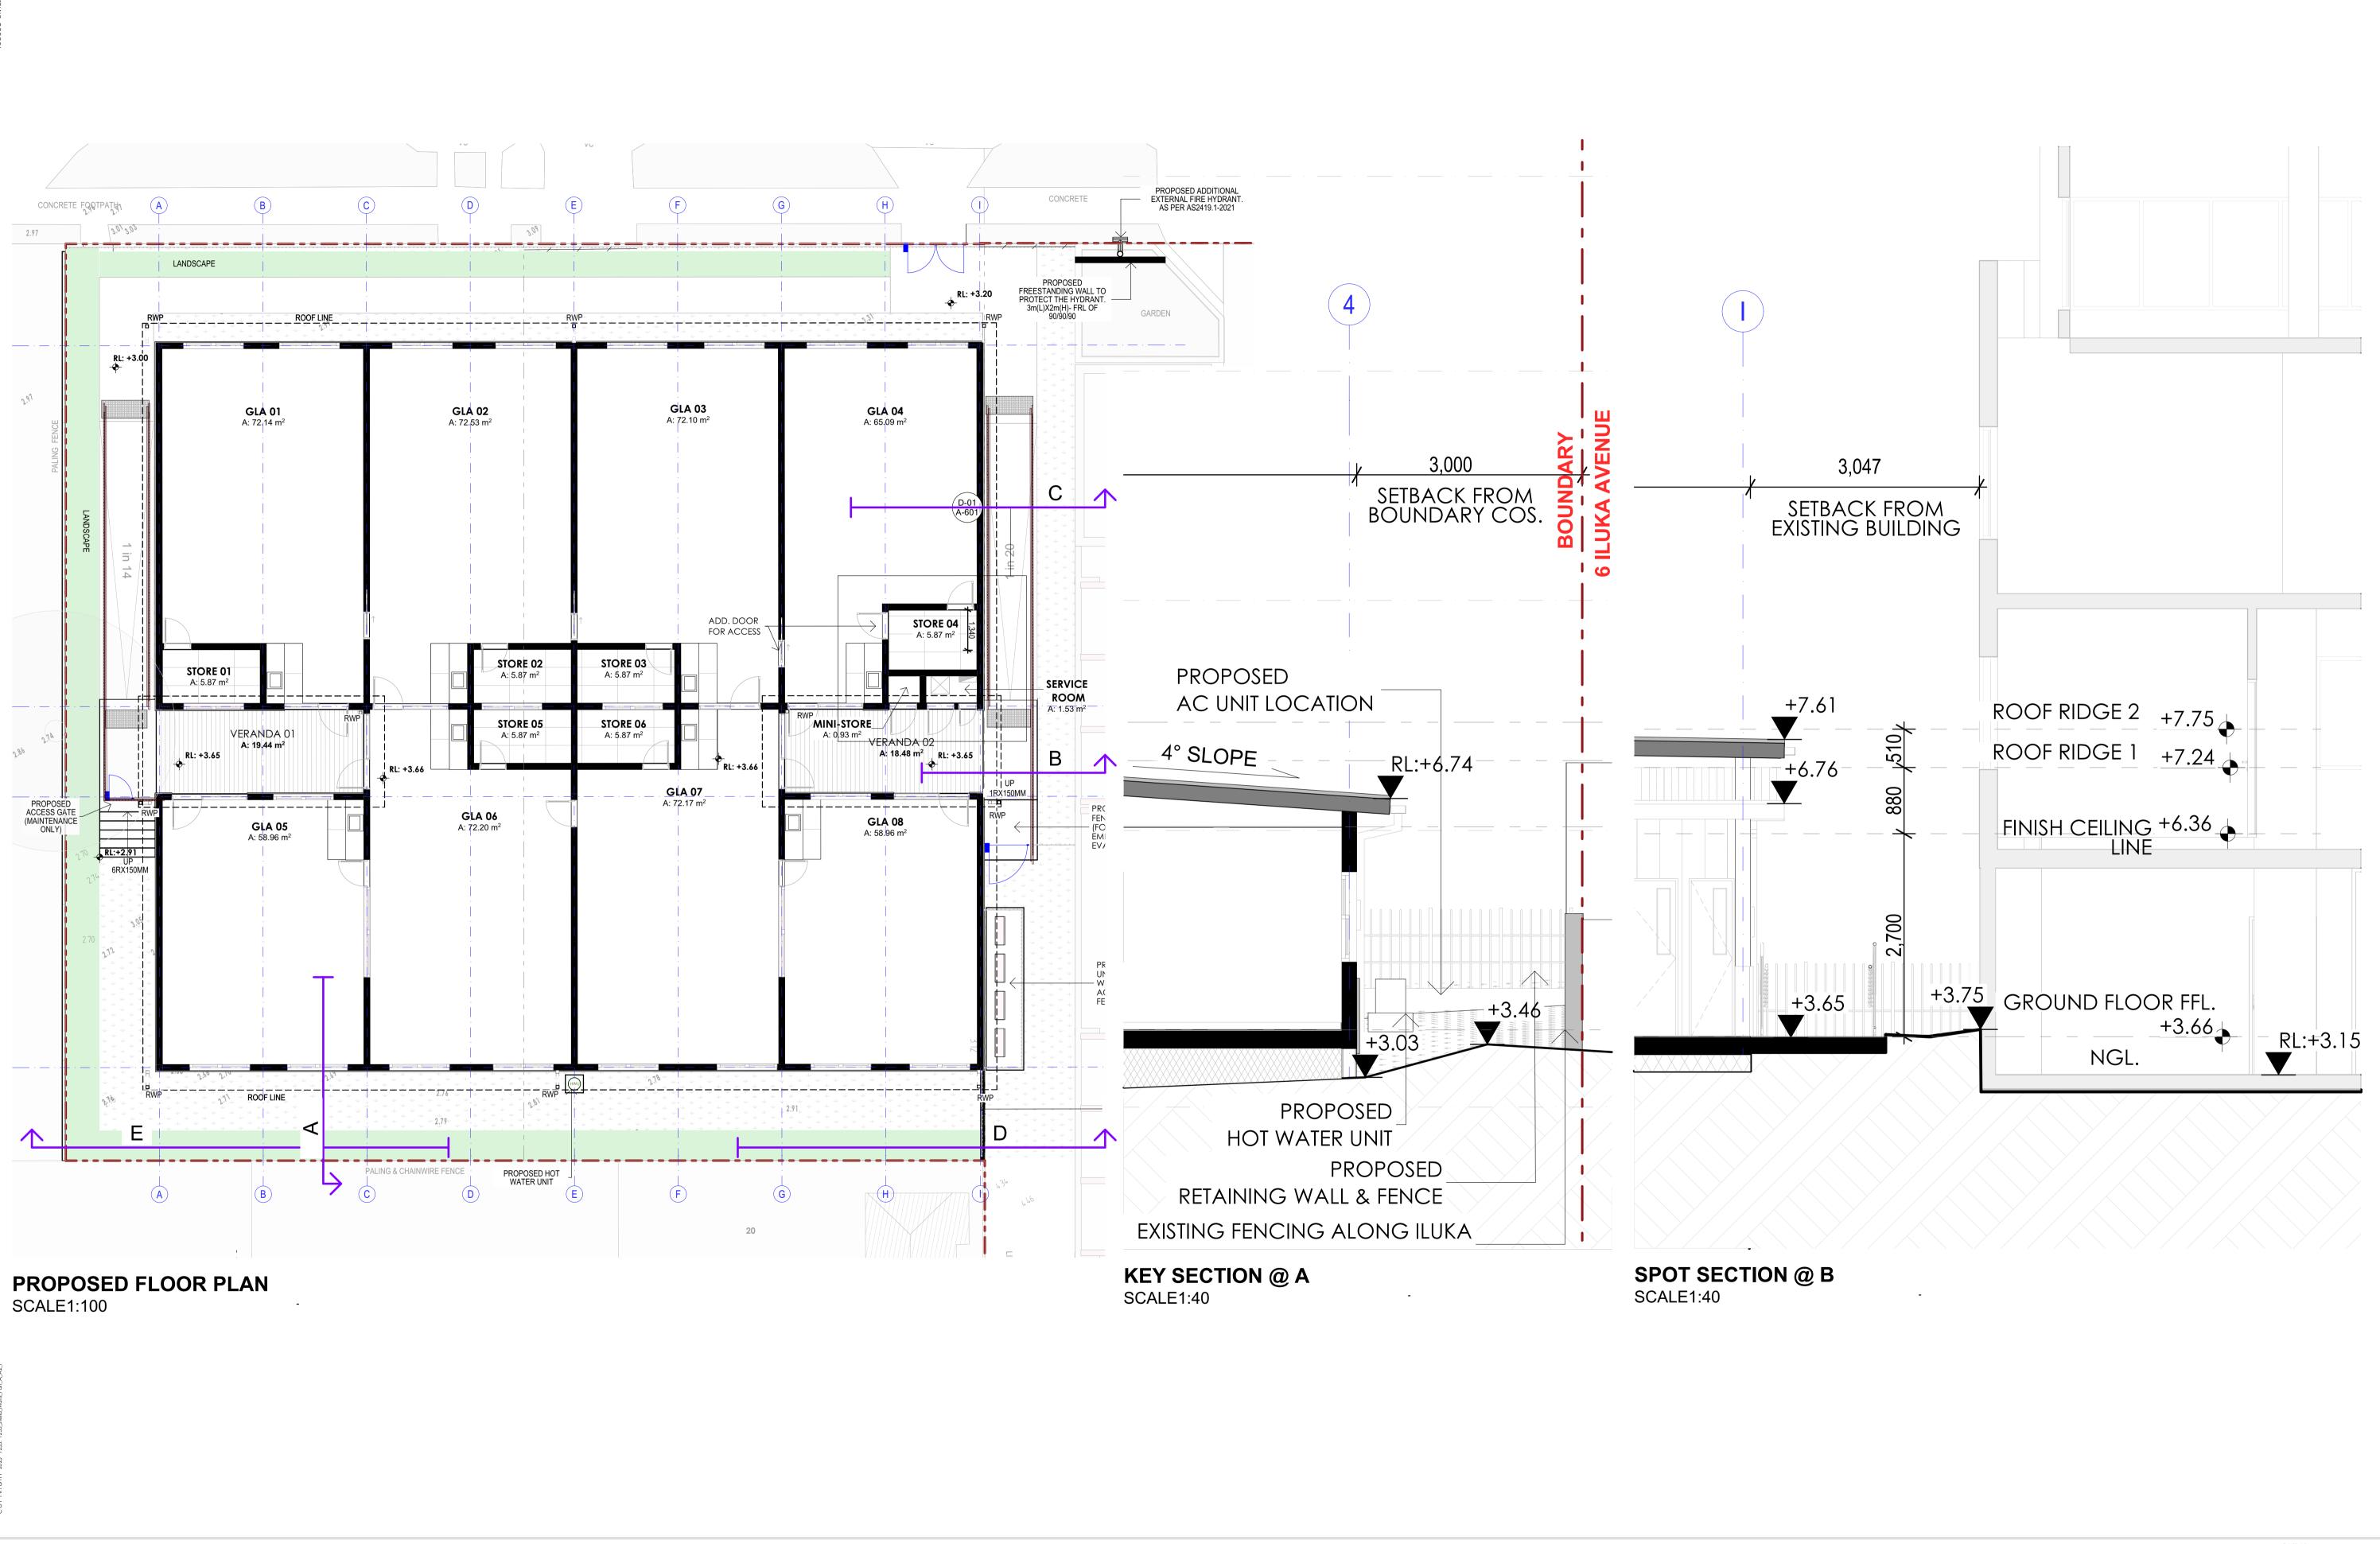
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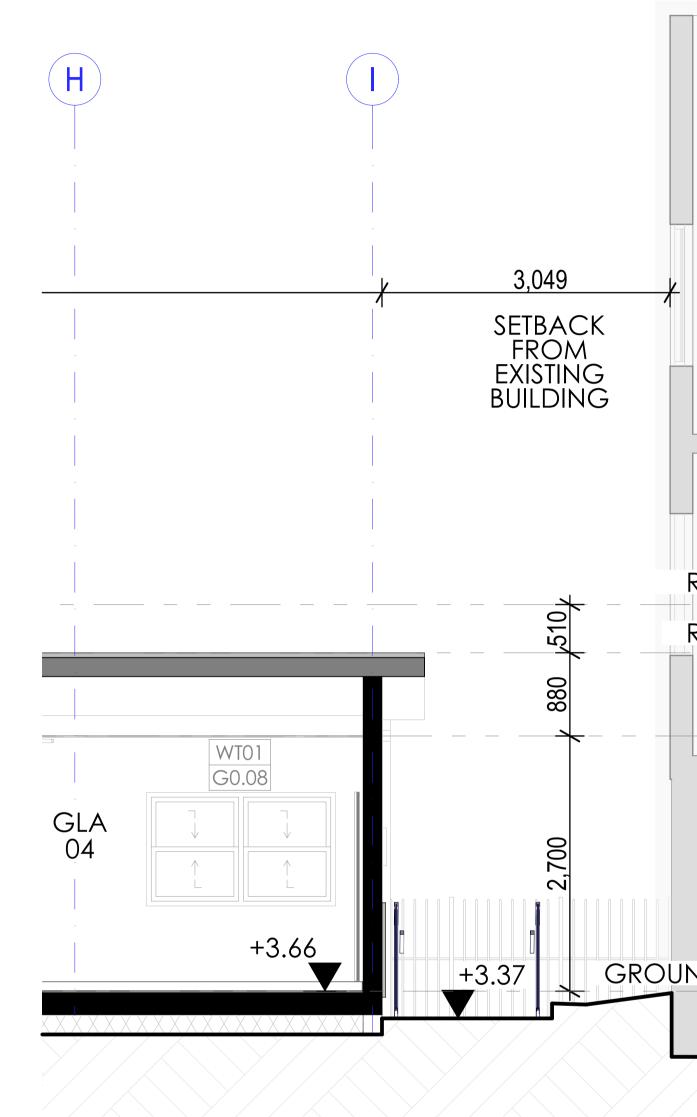


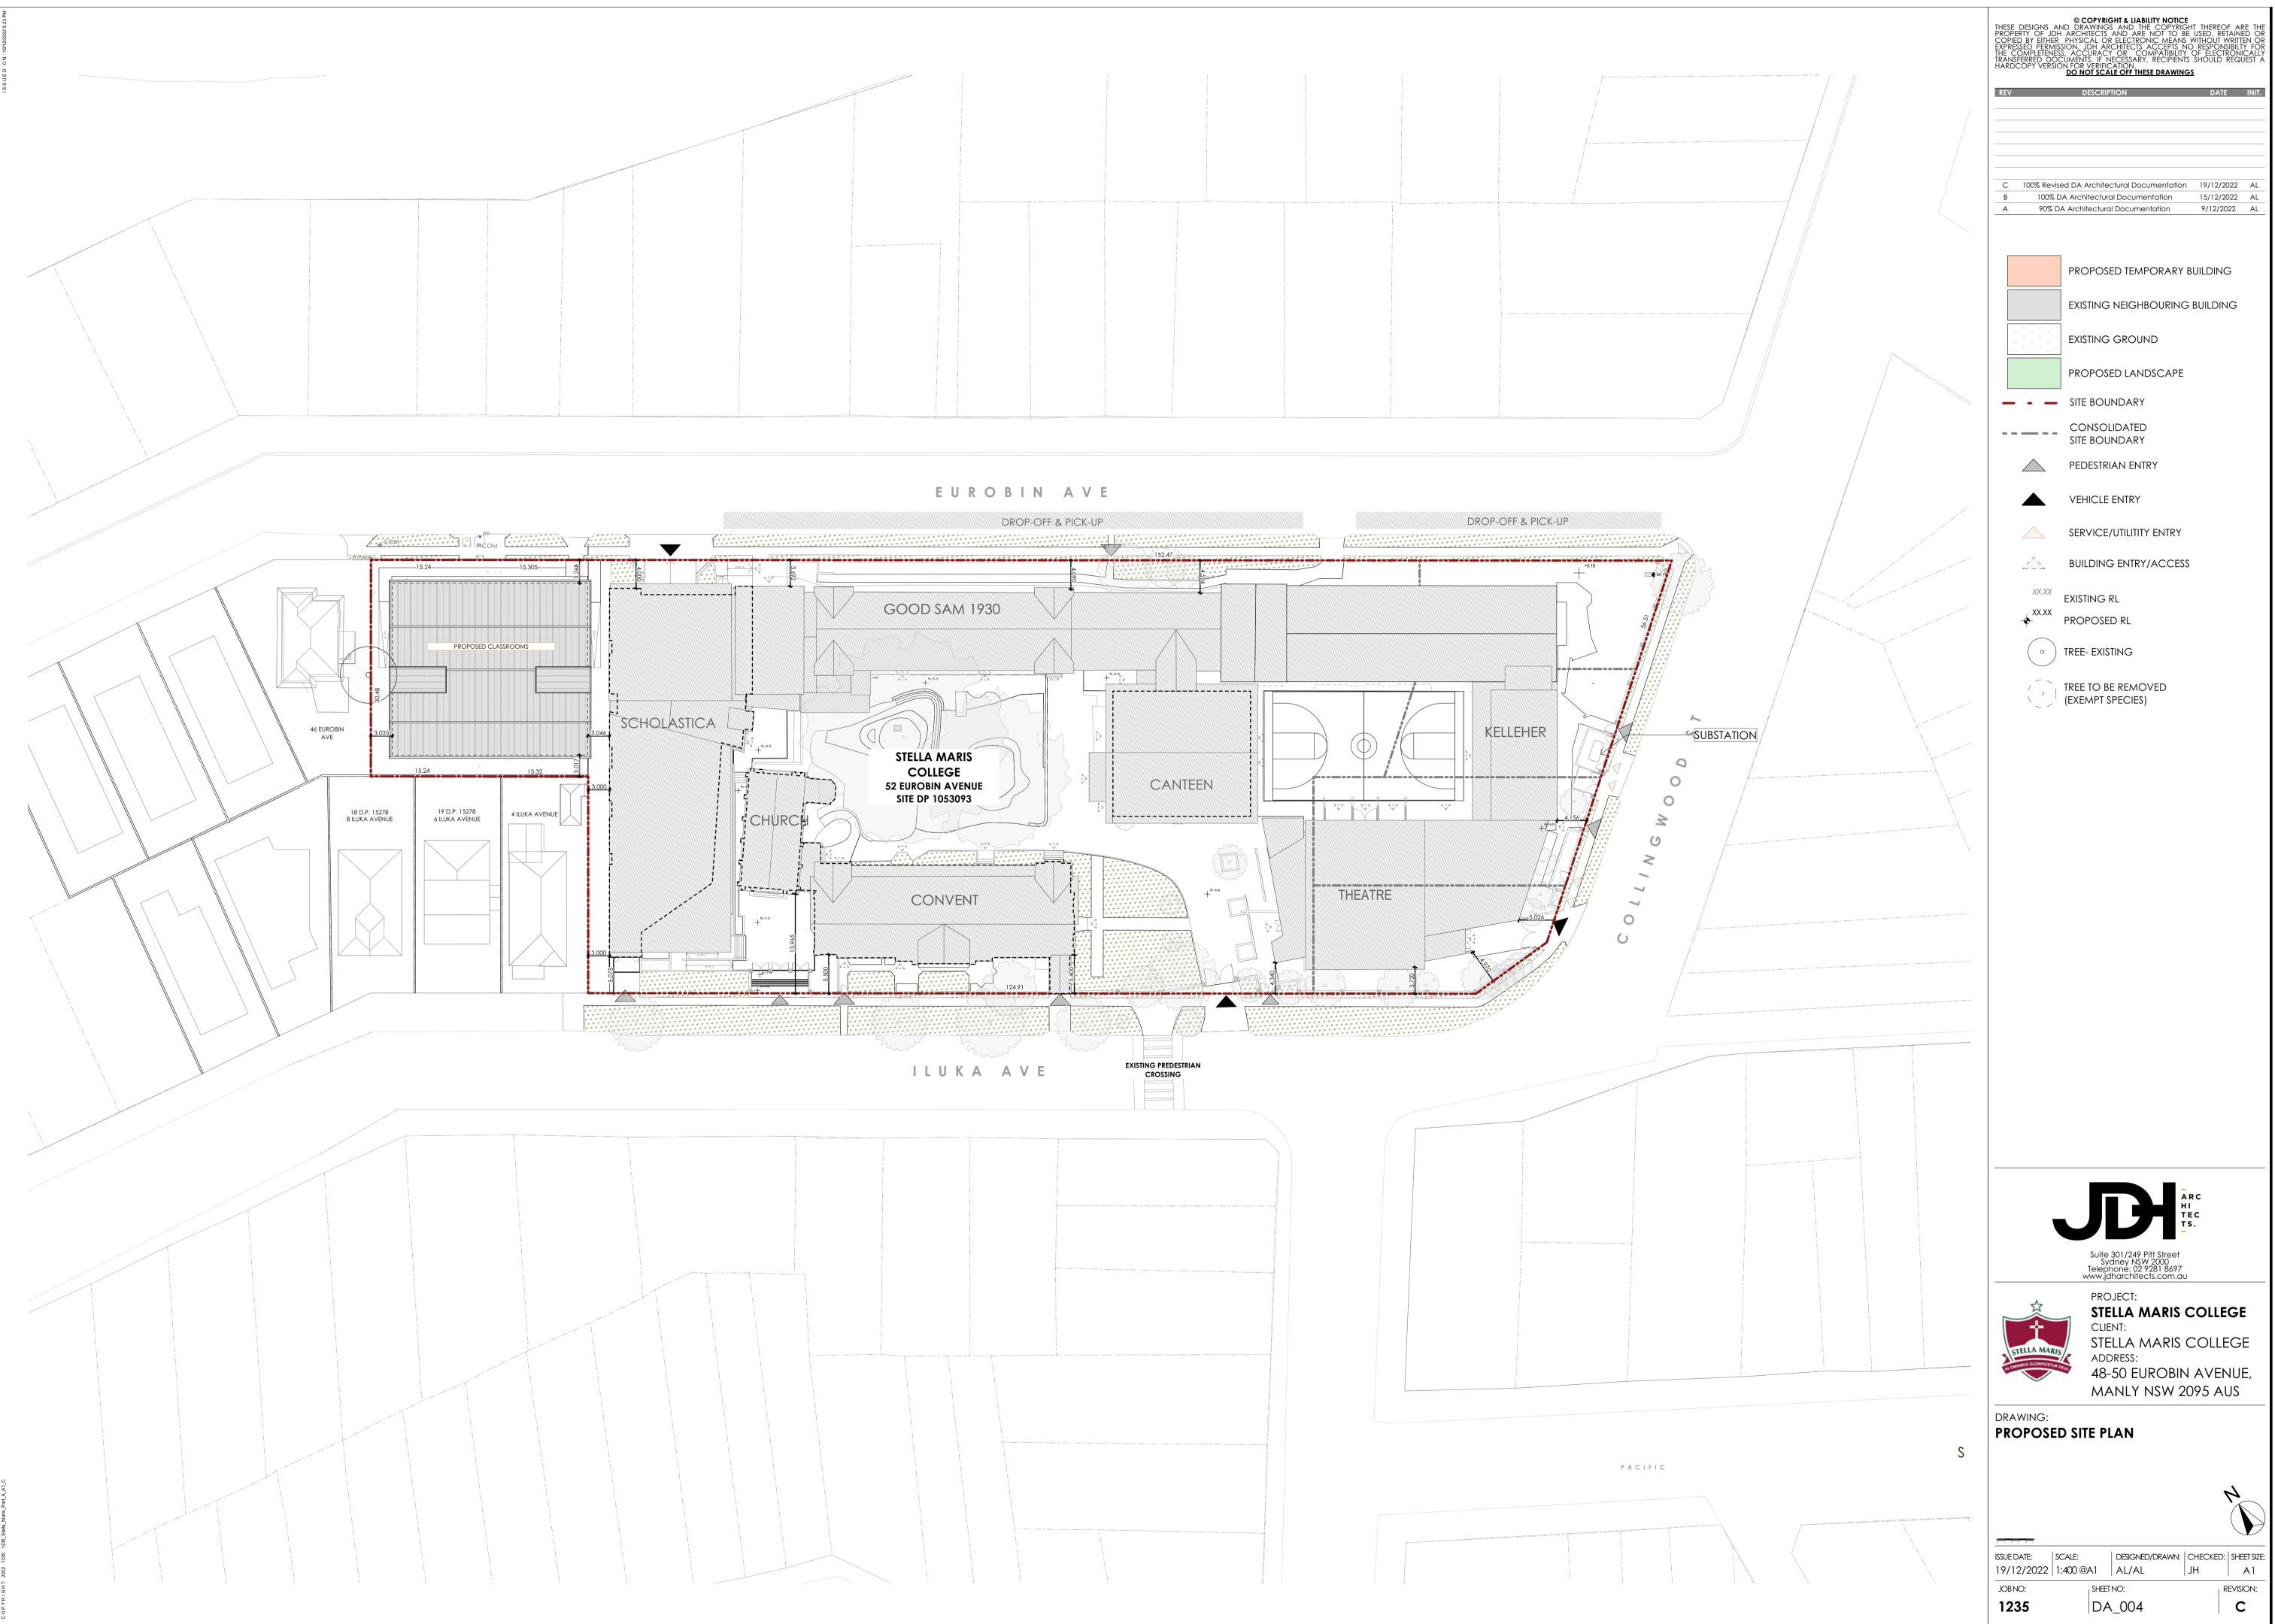

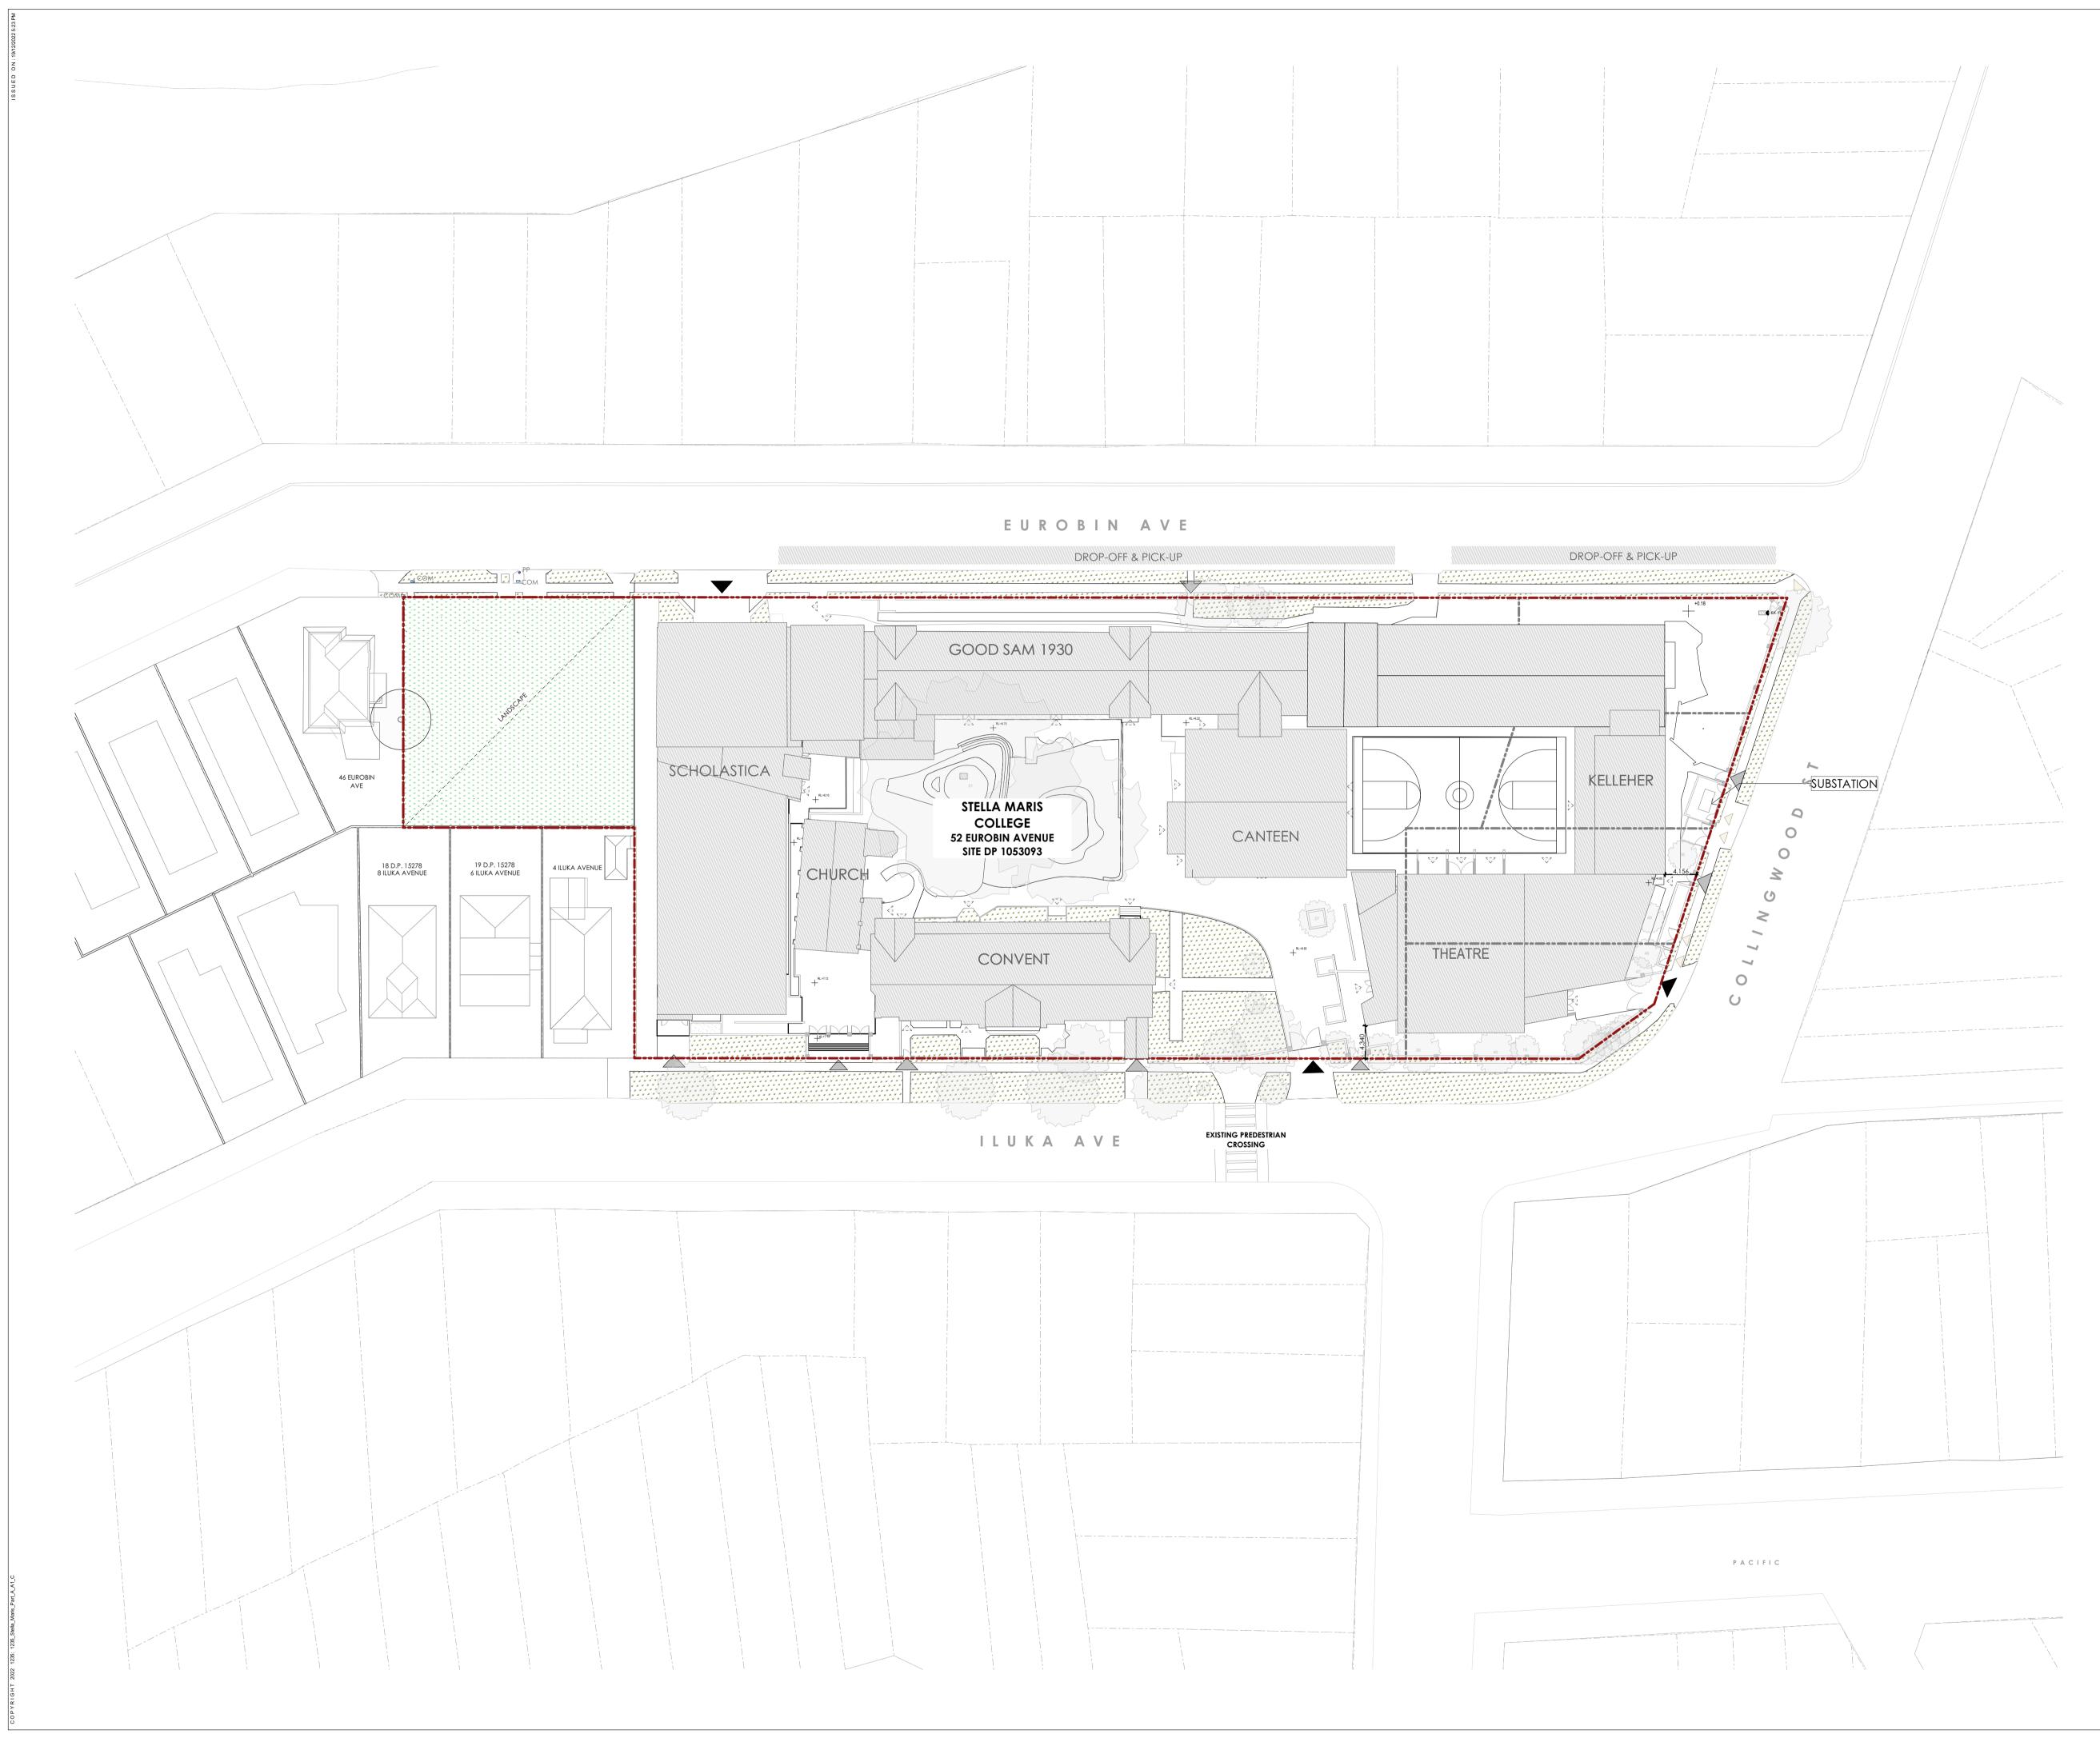

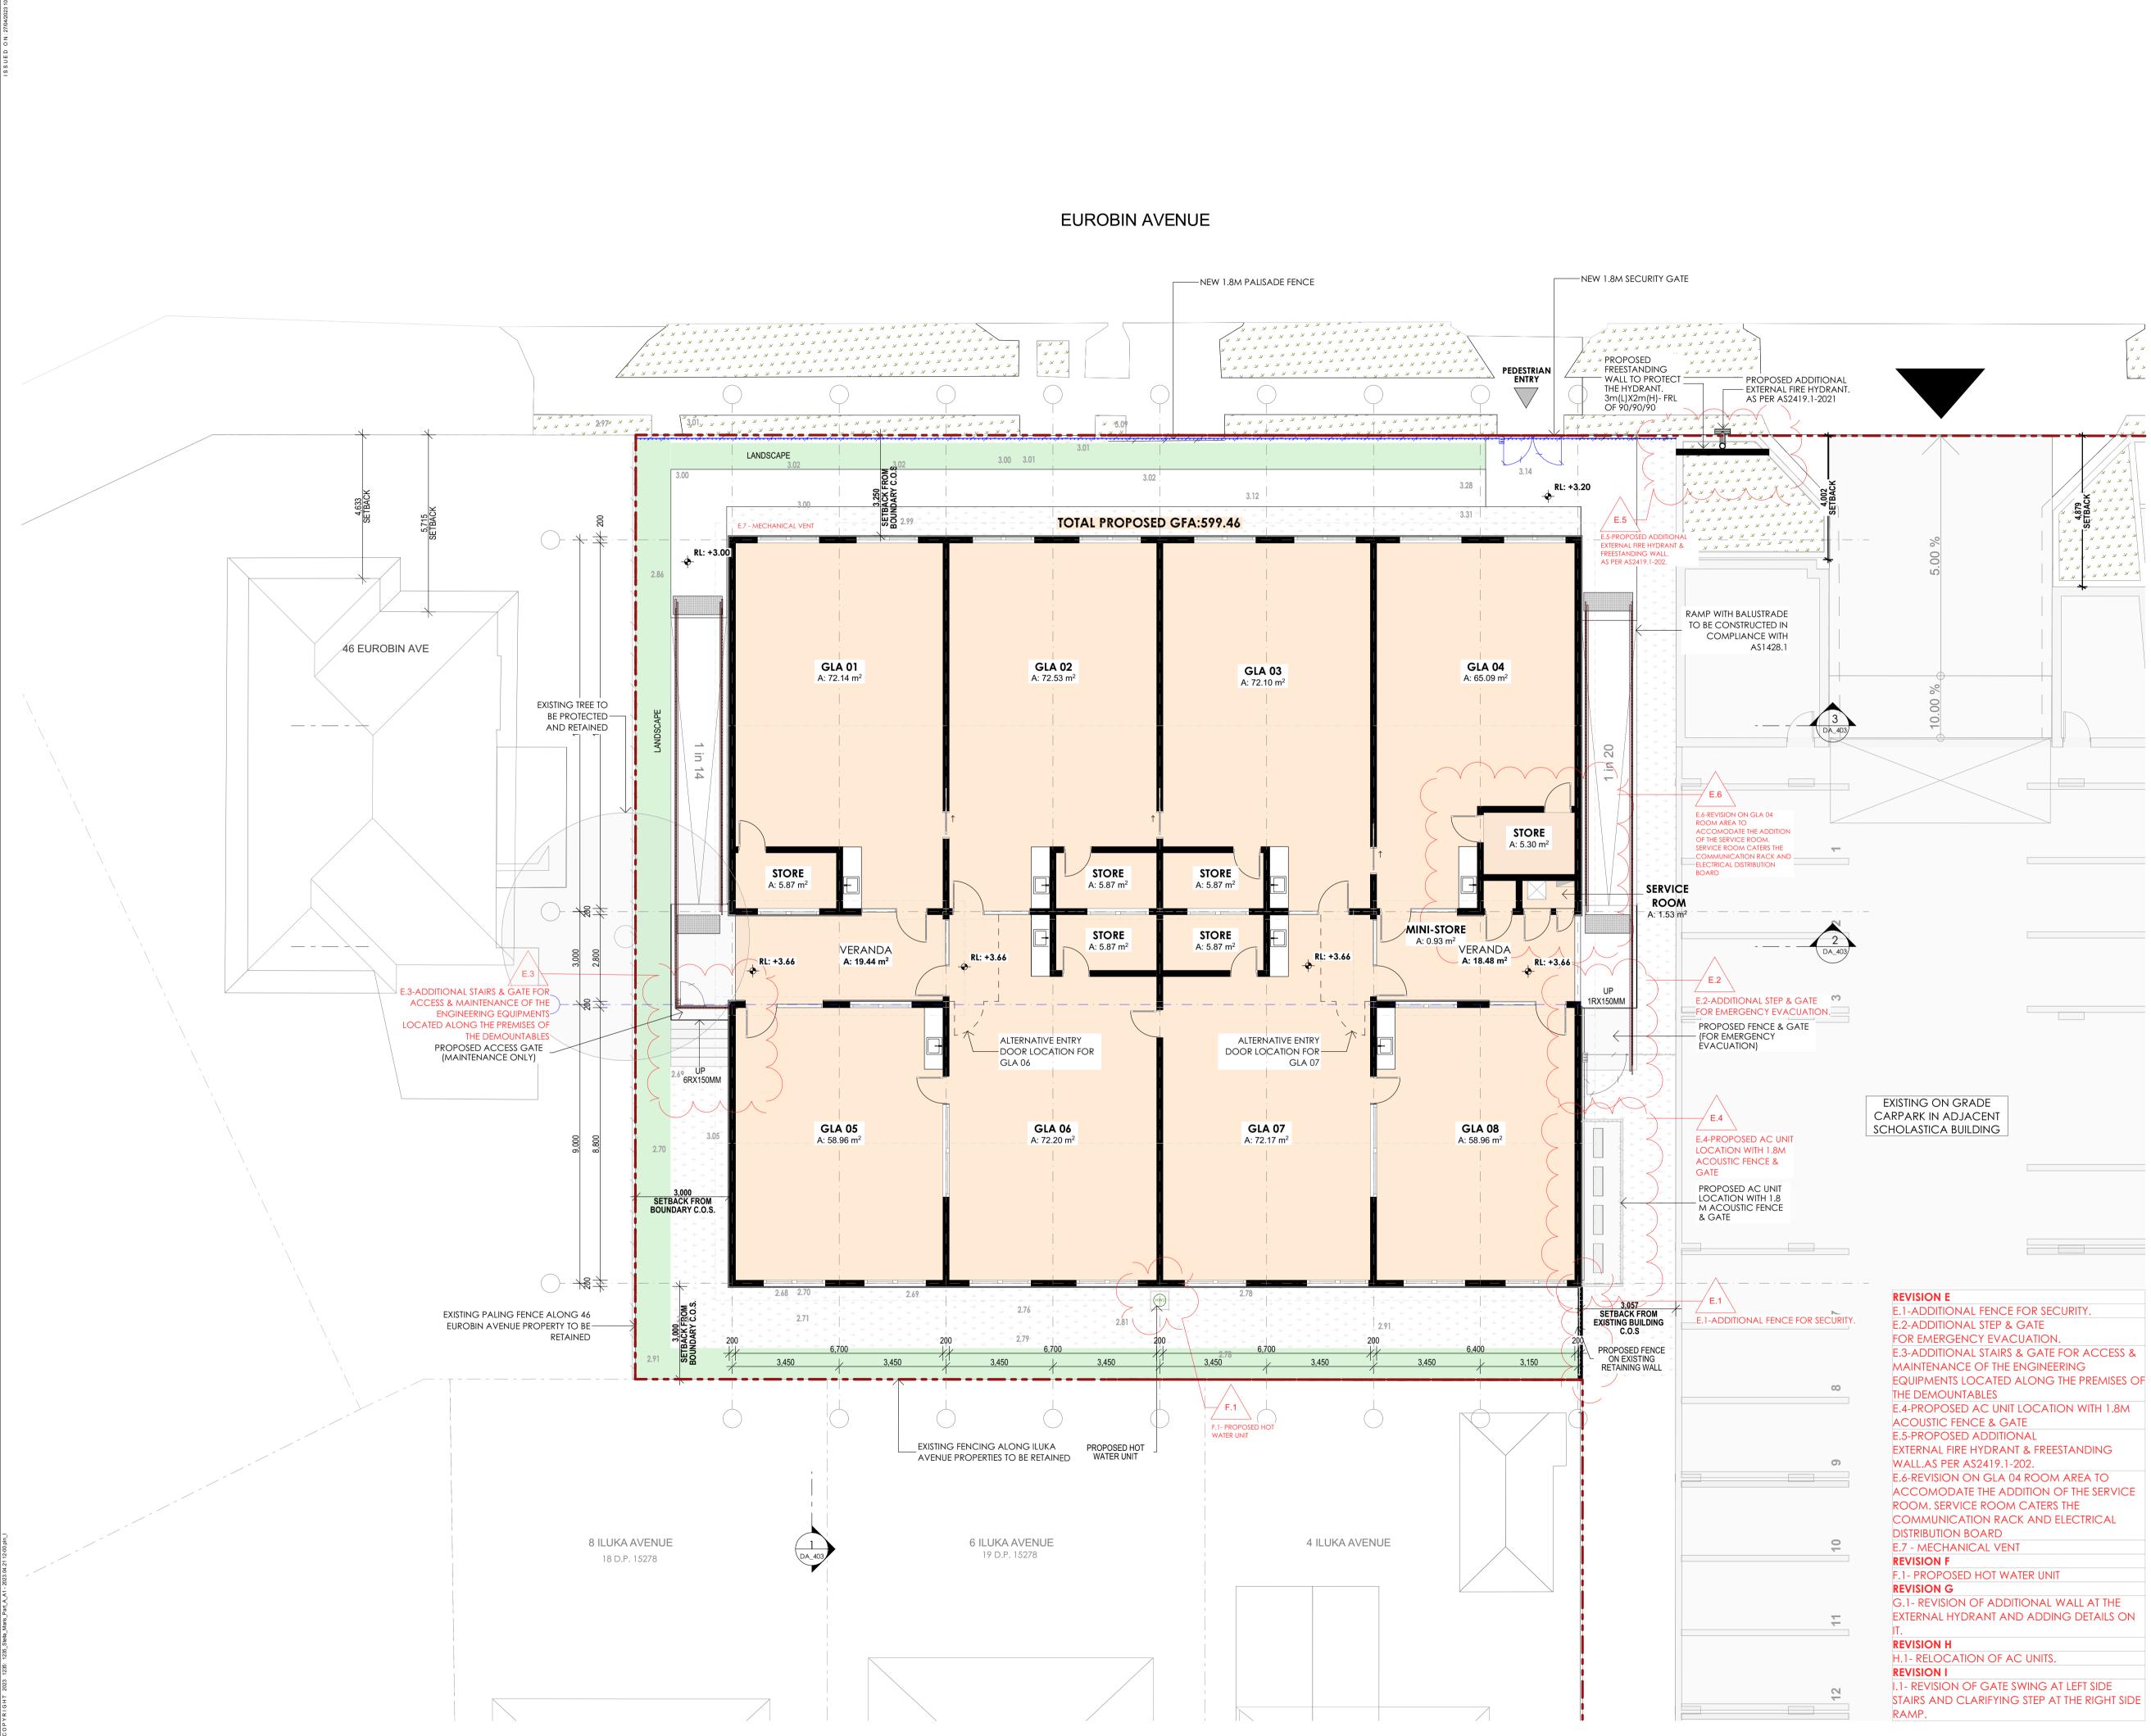STELLA MARIS COLLEGE GROUND FLOOR PLAN & KEY SECTION A & B	
CLIENT: STELLA MARIS COLLEGE DESIGNED/DRAWN TH/JG SCA	LE AS SHOWN
SITE:48-50 EUROBIN AVENUE, MANLY NSW 2095 AUSCHECKED BYTHPRO-	DJECT NO. 1235

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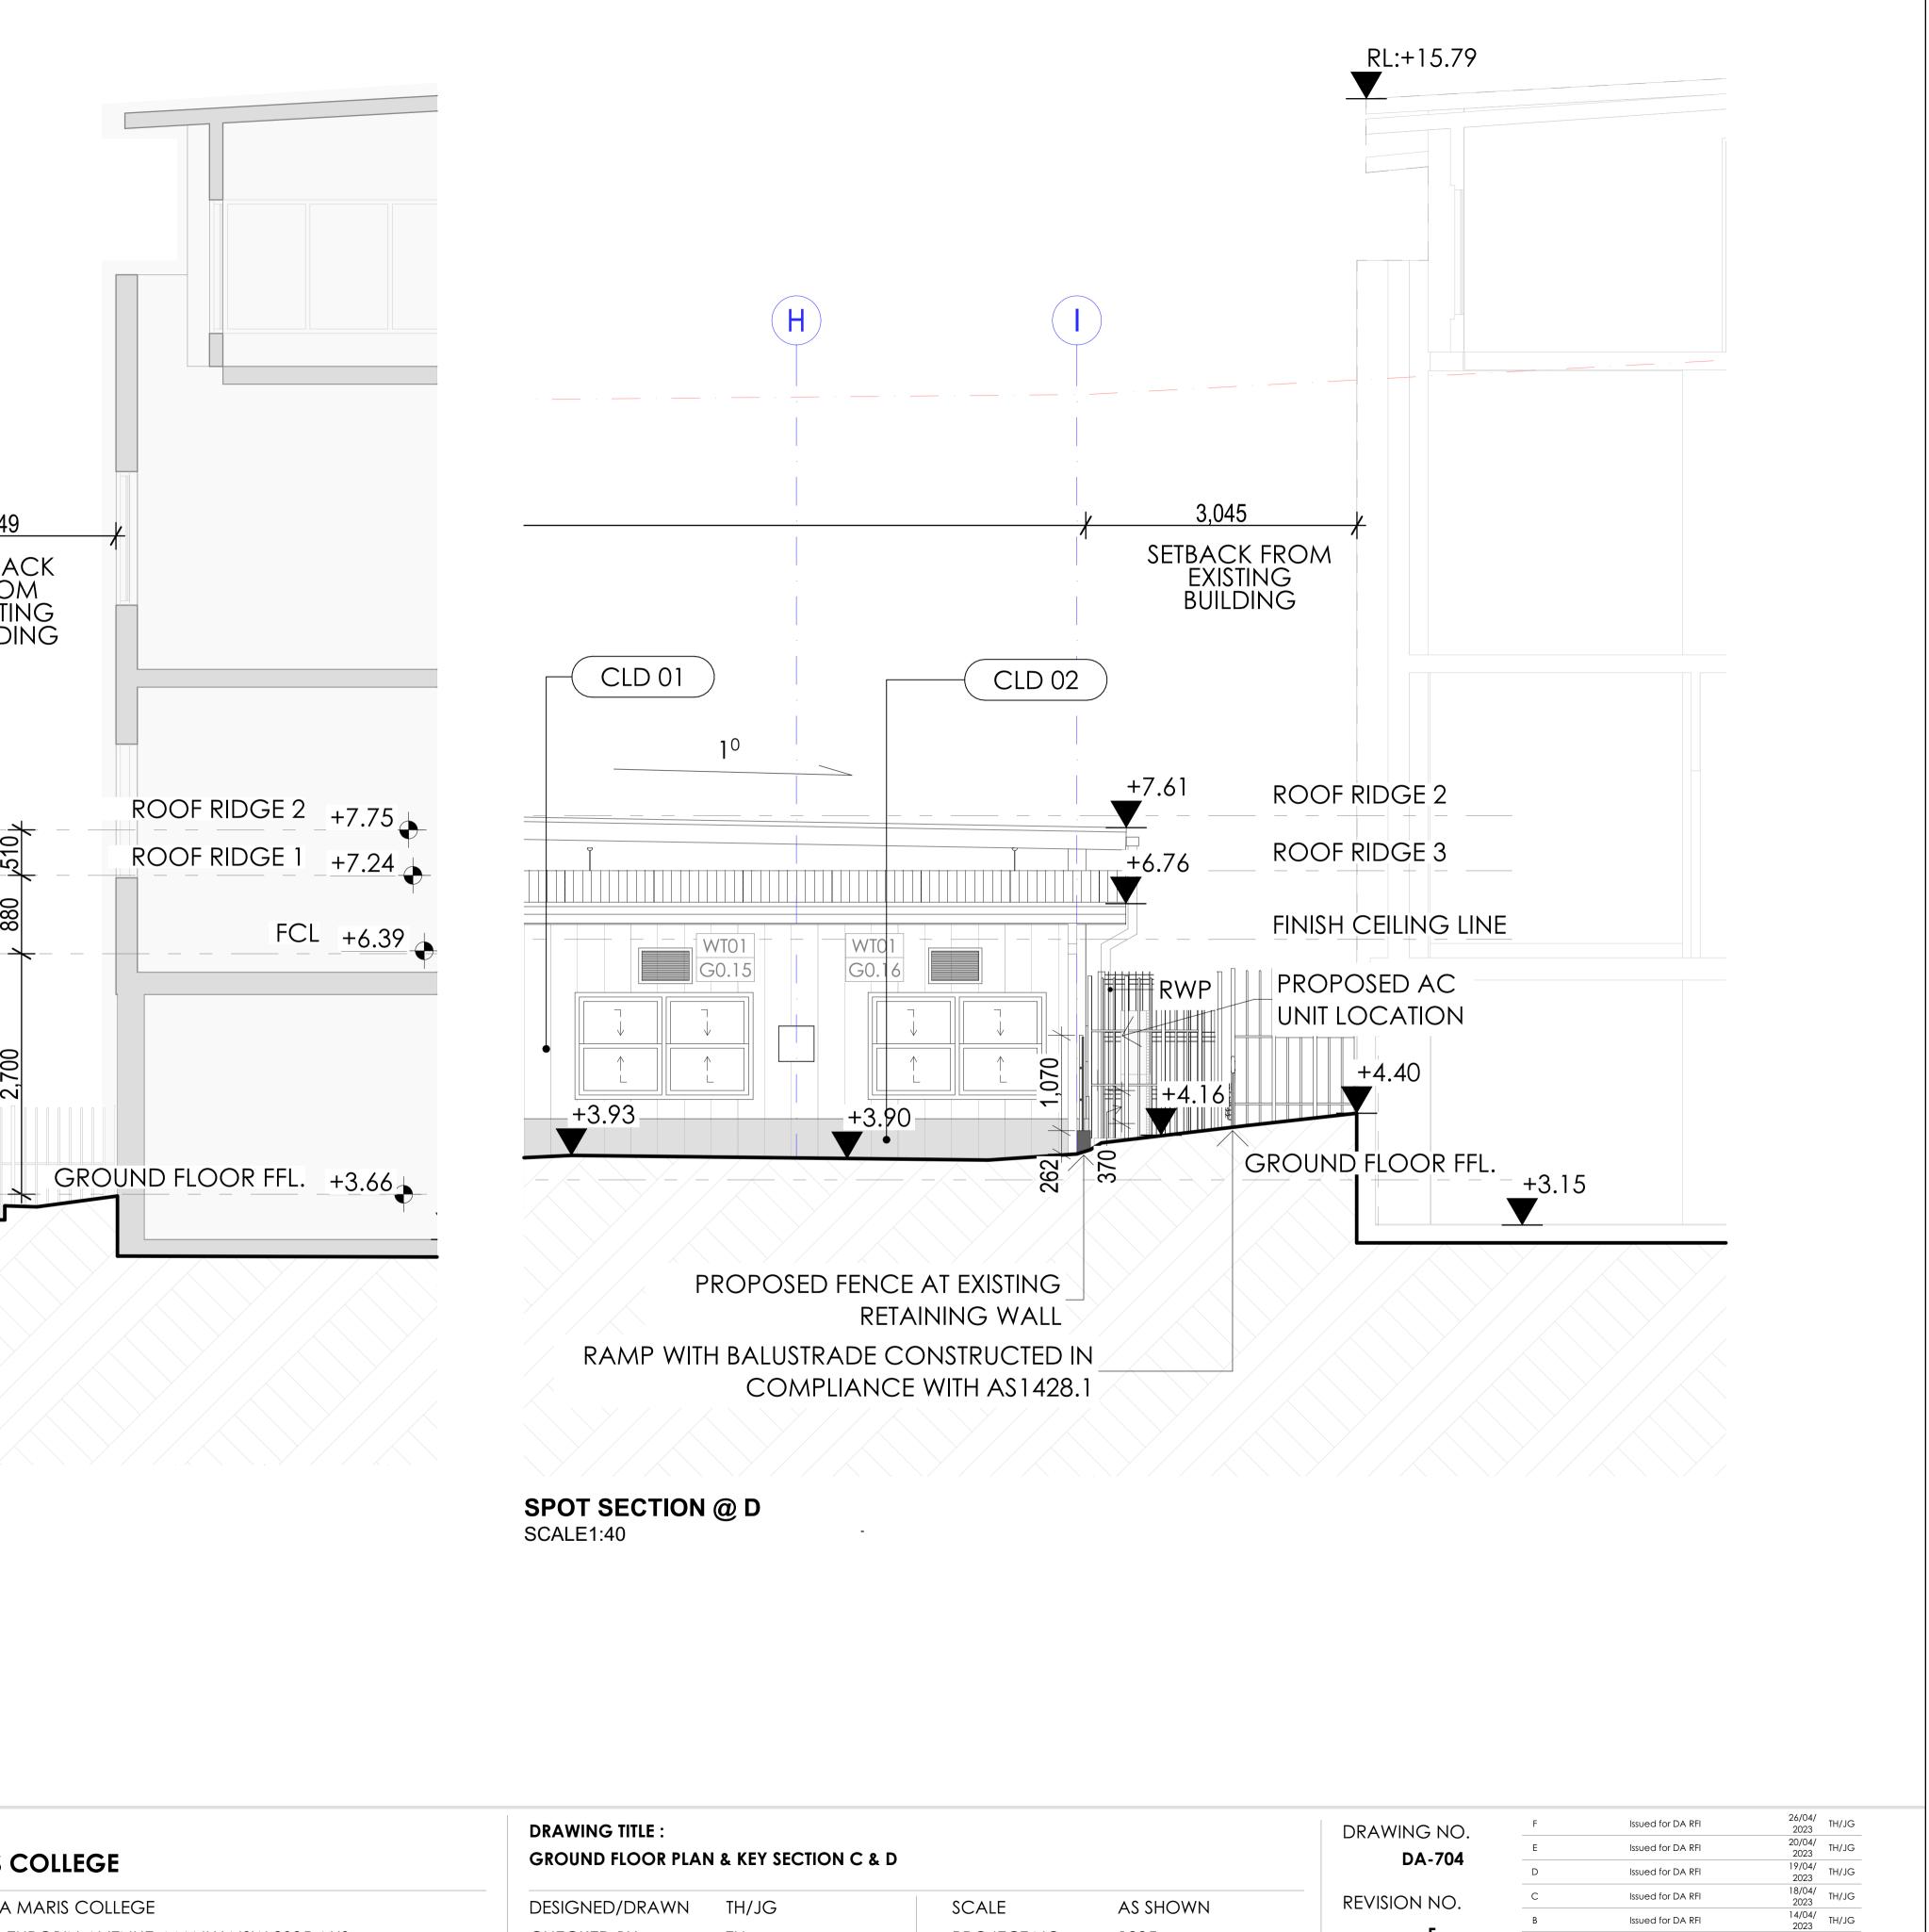


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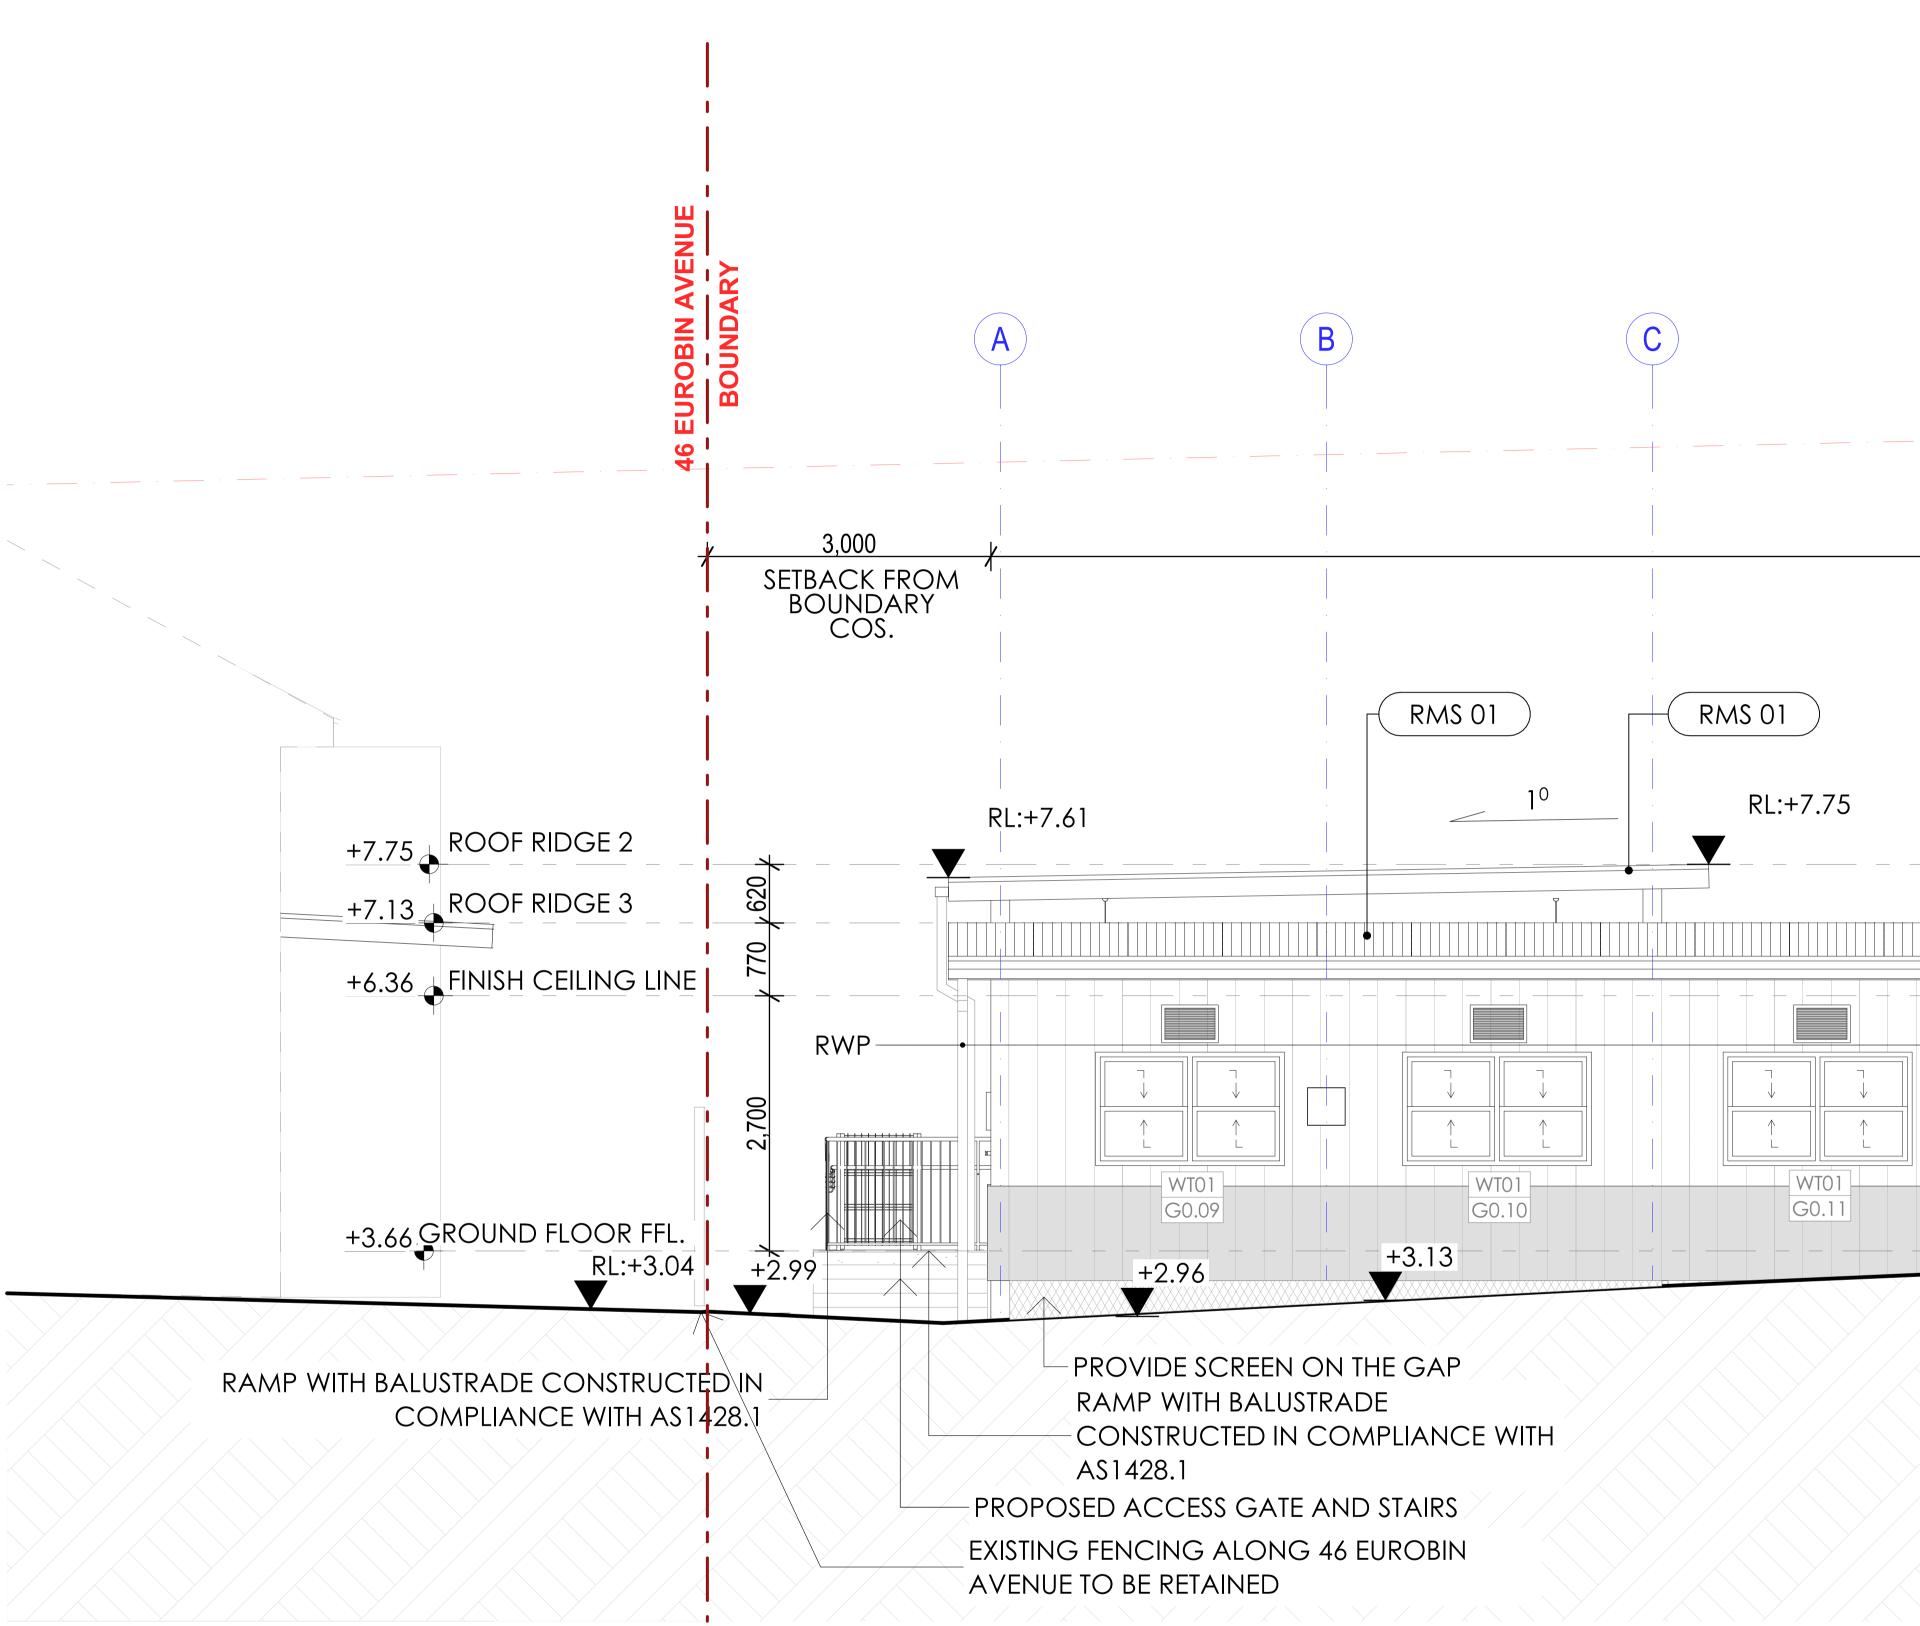




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CLIENT:	STELLA MARIS COLLEGE	DESIGNED/DRAWN	TH/JG	SCALE	AS SHOWN			
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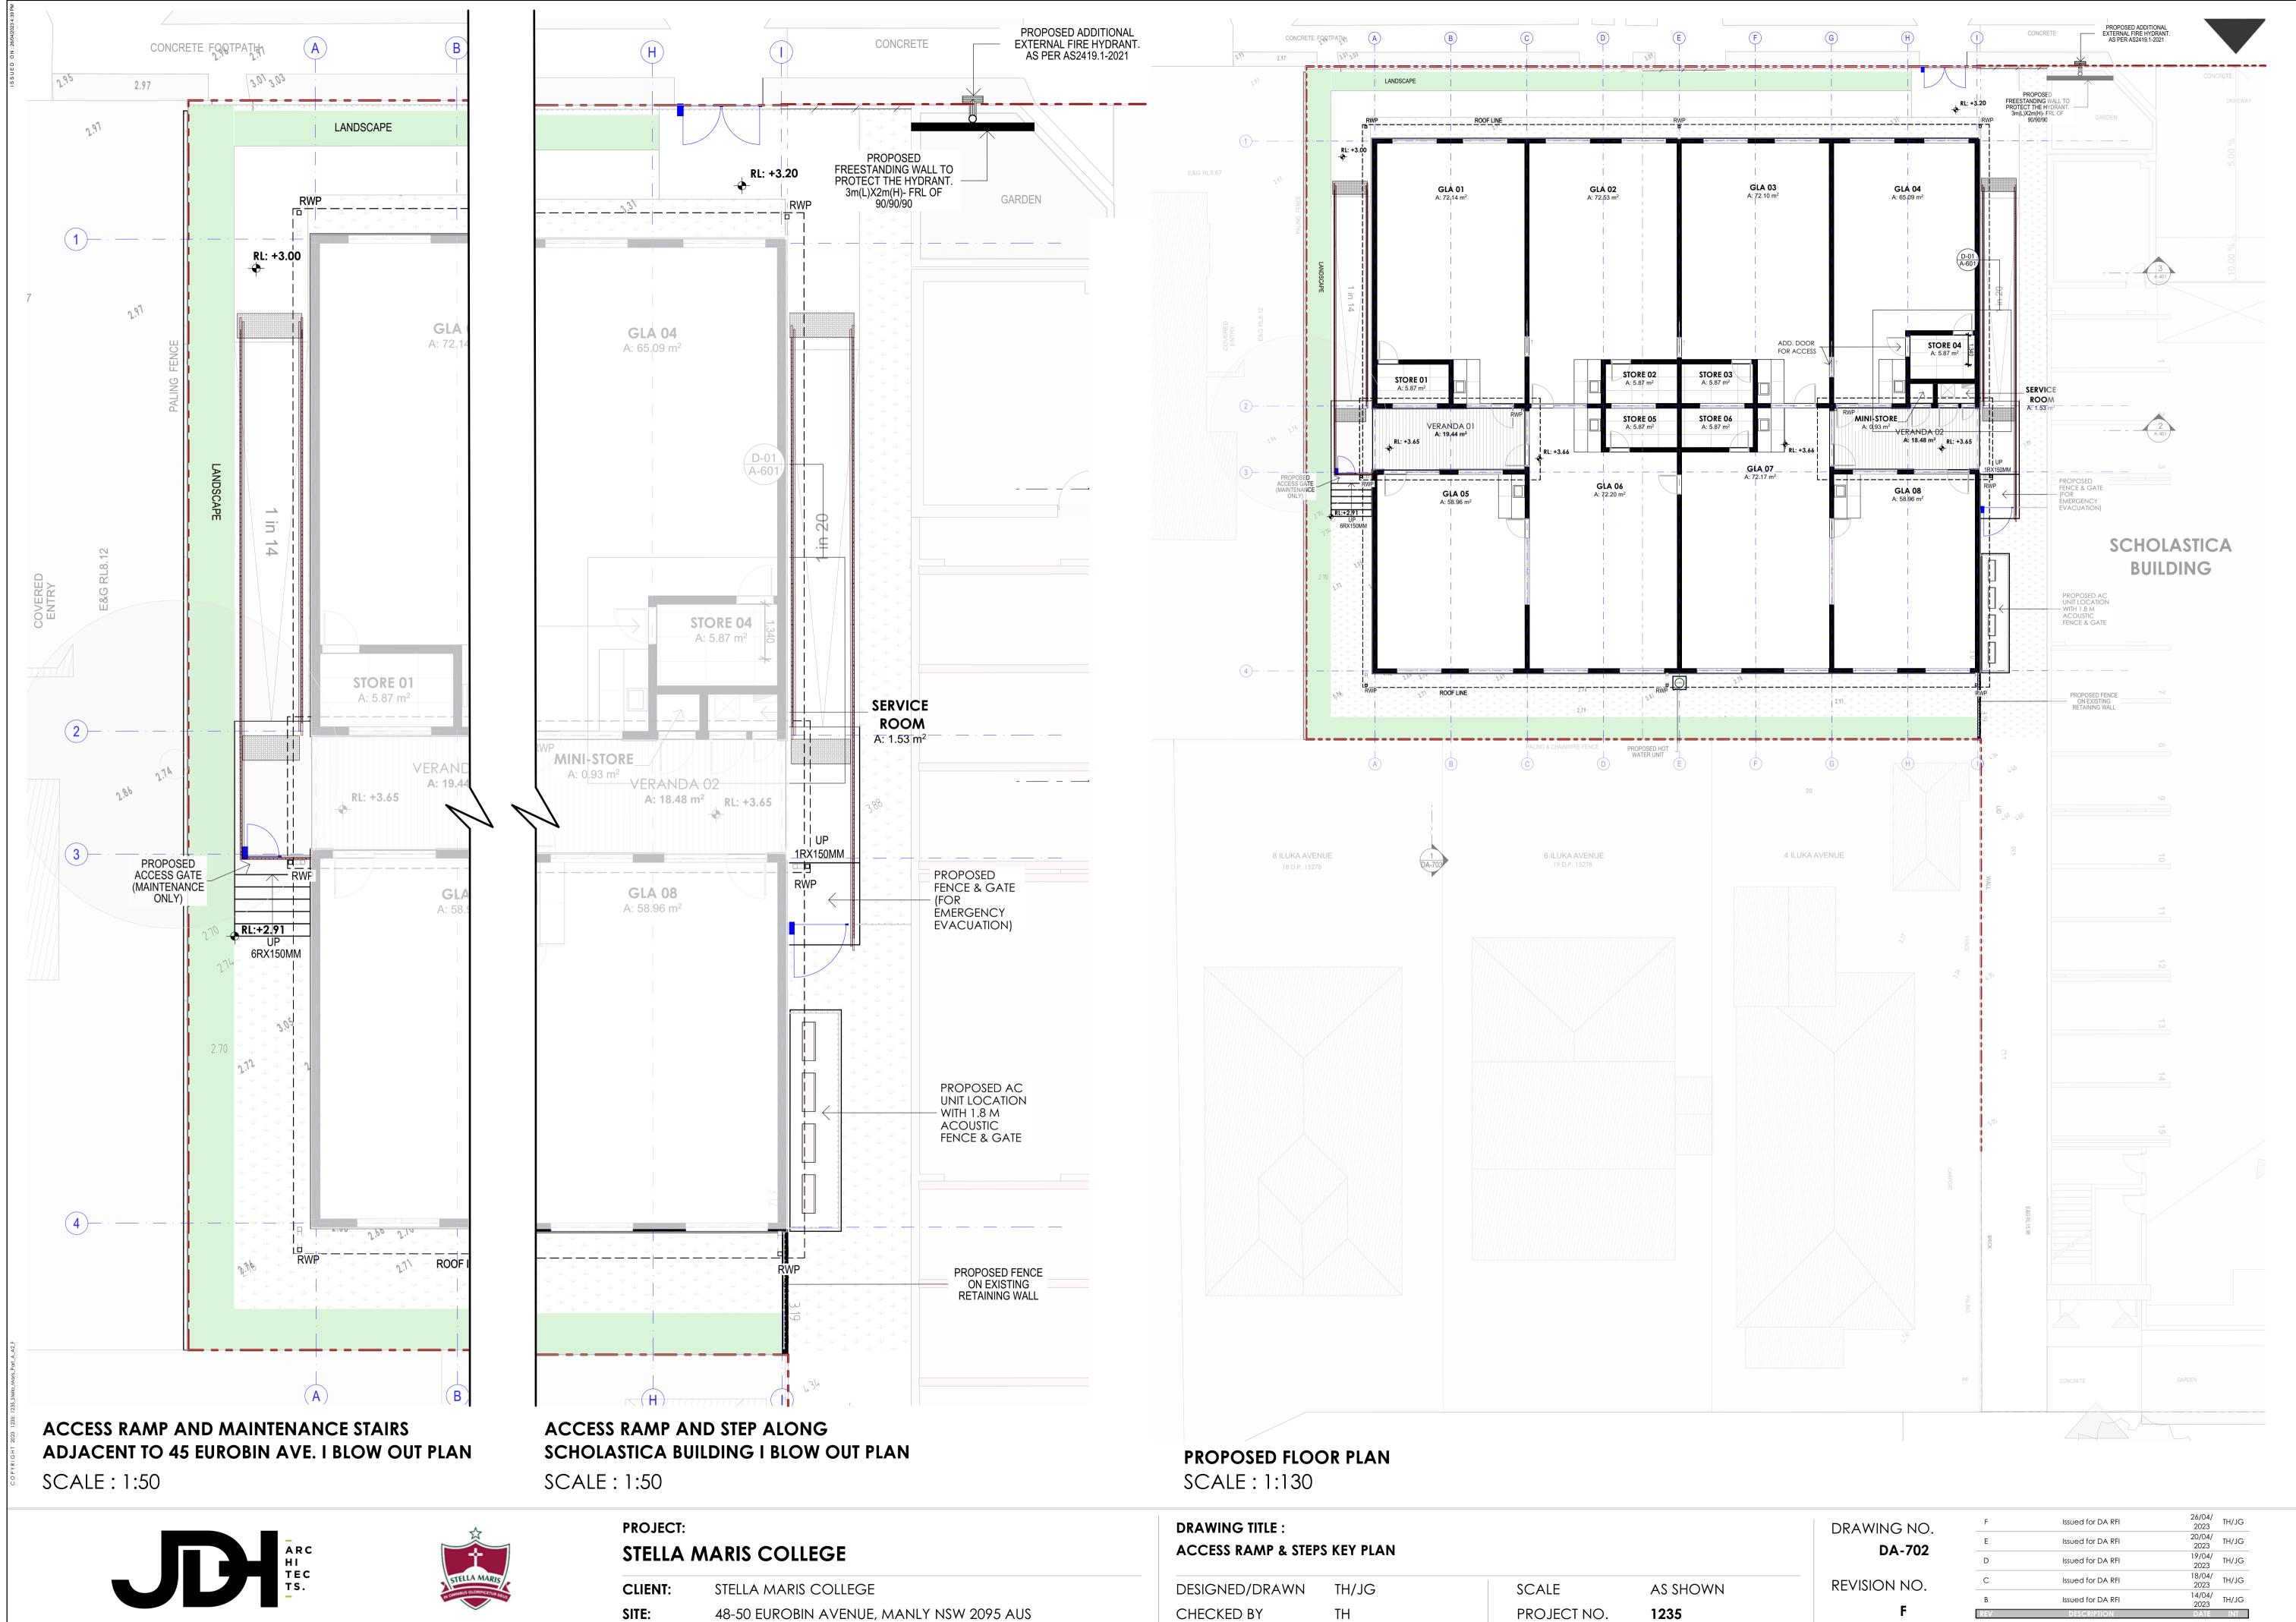







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А	90% DA Architectural Documentation	9/12/2022	AL

WF-01	WALL FINISH 1 METAL CLADDING - SURFMIST COLOUR
WF-02	WALL FINISH 2 METAL CLADDING - BLUE GUM COLOUR
EF-01	EXTERIOR FINISH EXTERNAL CLADDING EXTEND ON DOWN THE GROUND TO COVER SUBFLOOR SPACE
RF-01	ROOF FINISH TRIMDEK ROOF SHEETING - SURFMIST COLOUR
W-01	WINDOW DOUBLE GLAZING WINDOW W/ ALUMINUM FRAME
RP-01	RAMP LIGHTWEIGHT METAL RAMP WITH BALUSTRADE & HANDRAIL
	EXISTING NEIGHBOURING BUILDING

- - SITE BOUNDARY

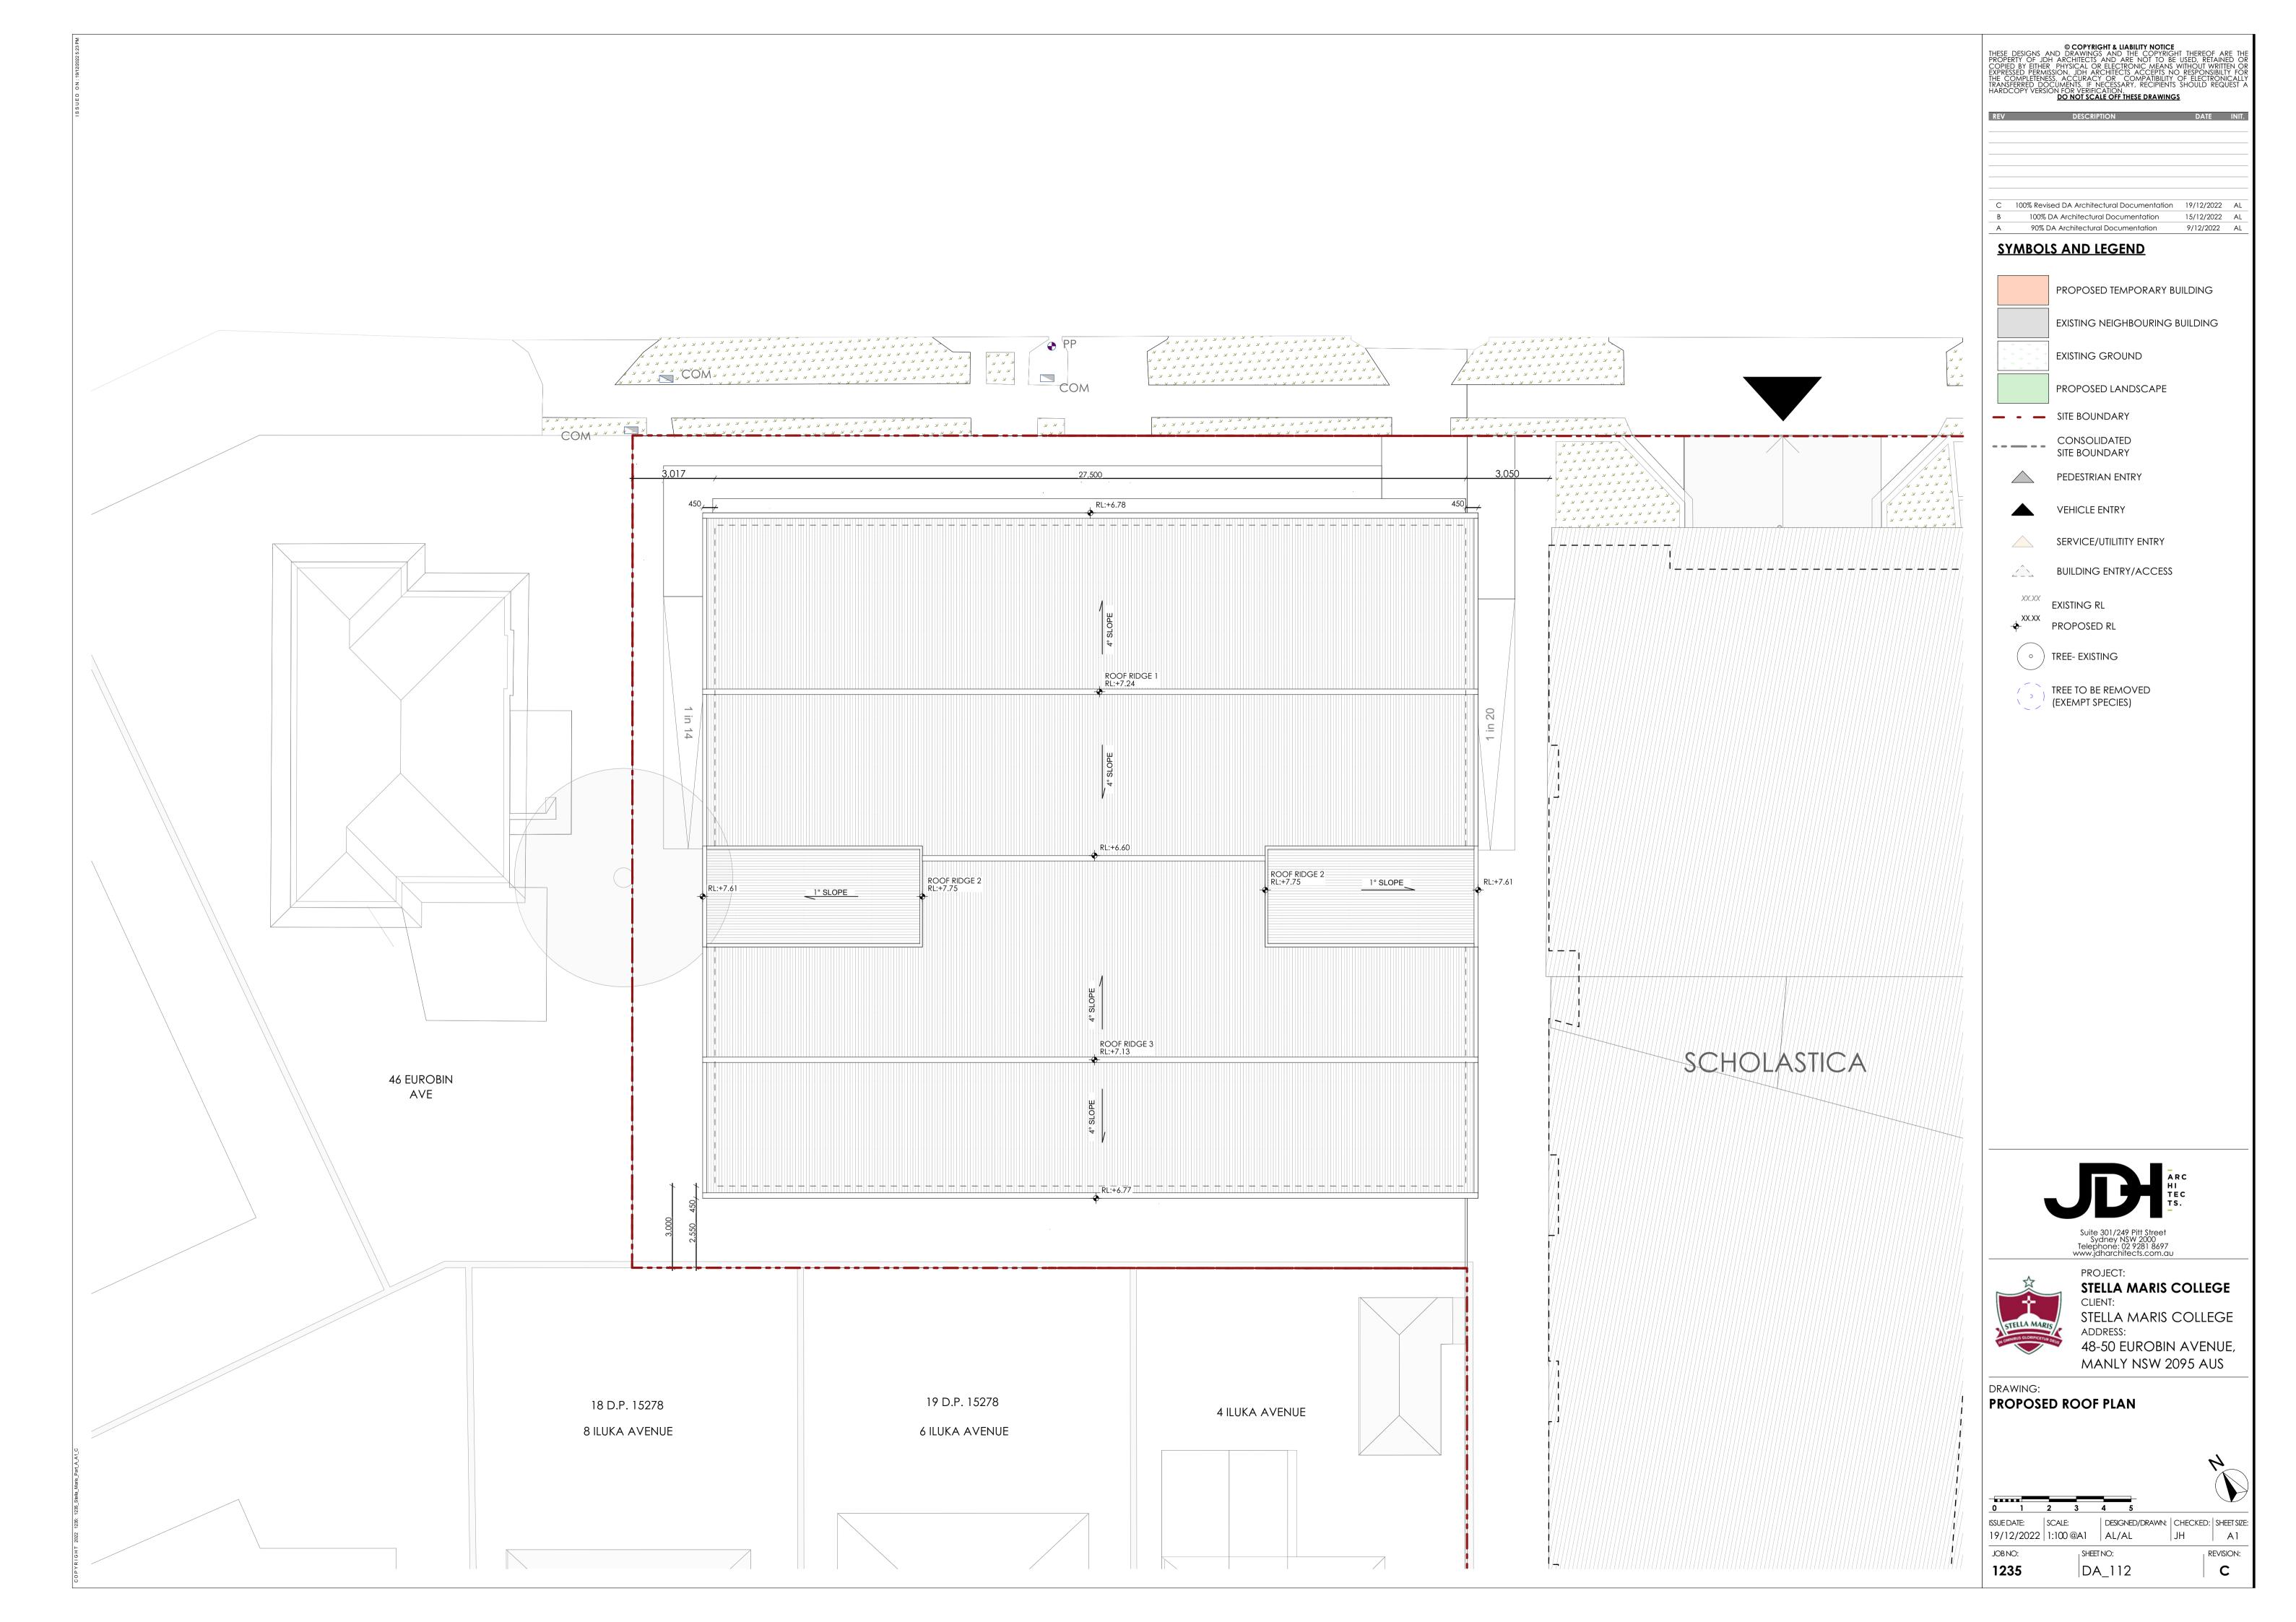

Suite 301/249 Pitt Street Sydney NSW 2000 Telephone: 02 9281 8697 www.jdharchitects.com.au



PROJECT: **STELLA MARIS COLLEGE** CLIENT: **STELLA MARIS COLLEGE** ADDRESS: **48-50 EUROBIN AVENUE,** MANLY NSW 2095 AUS

DRAWING: ELEVATIONS


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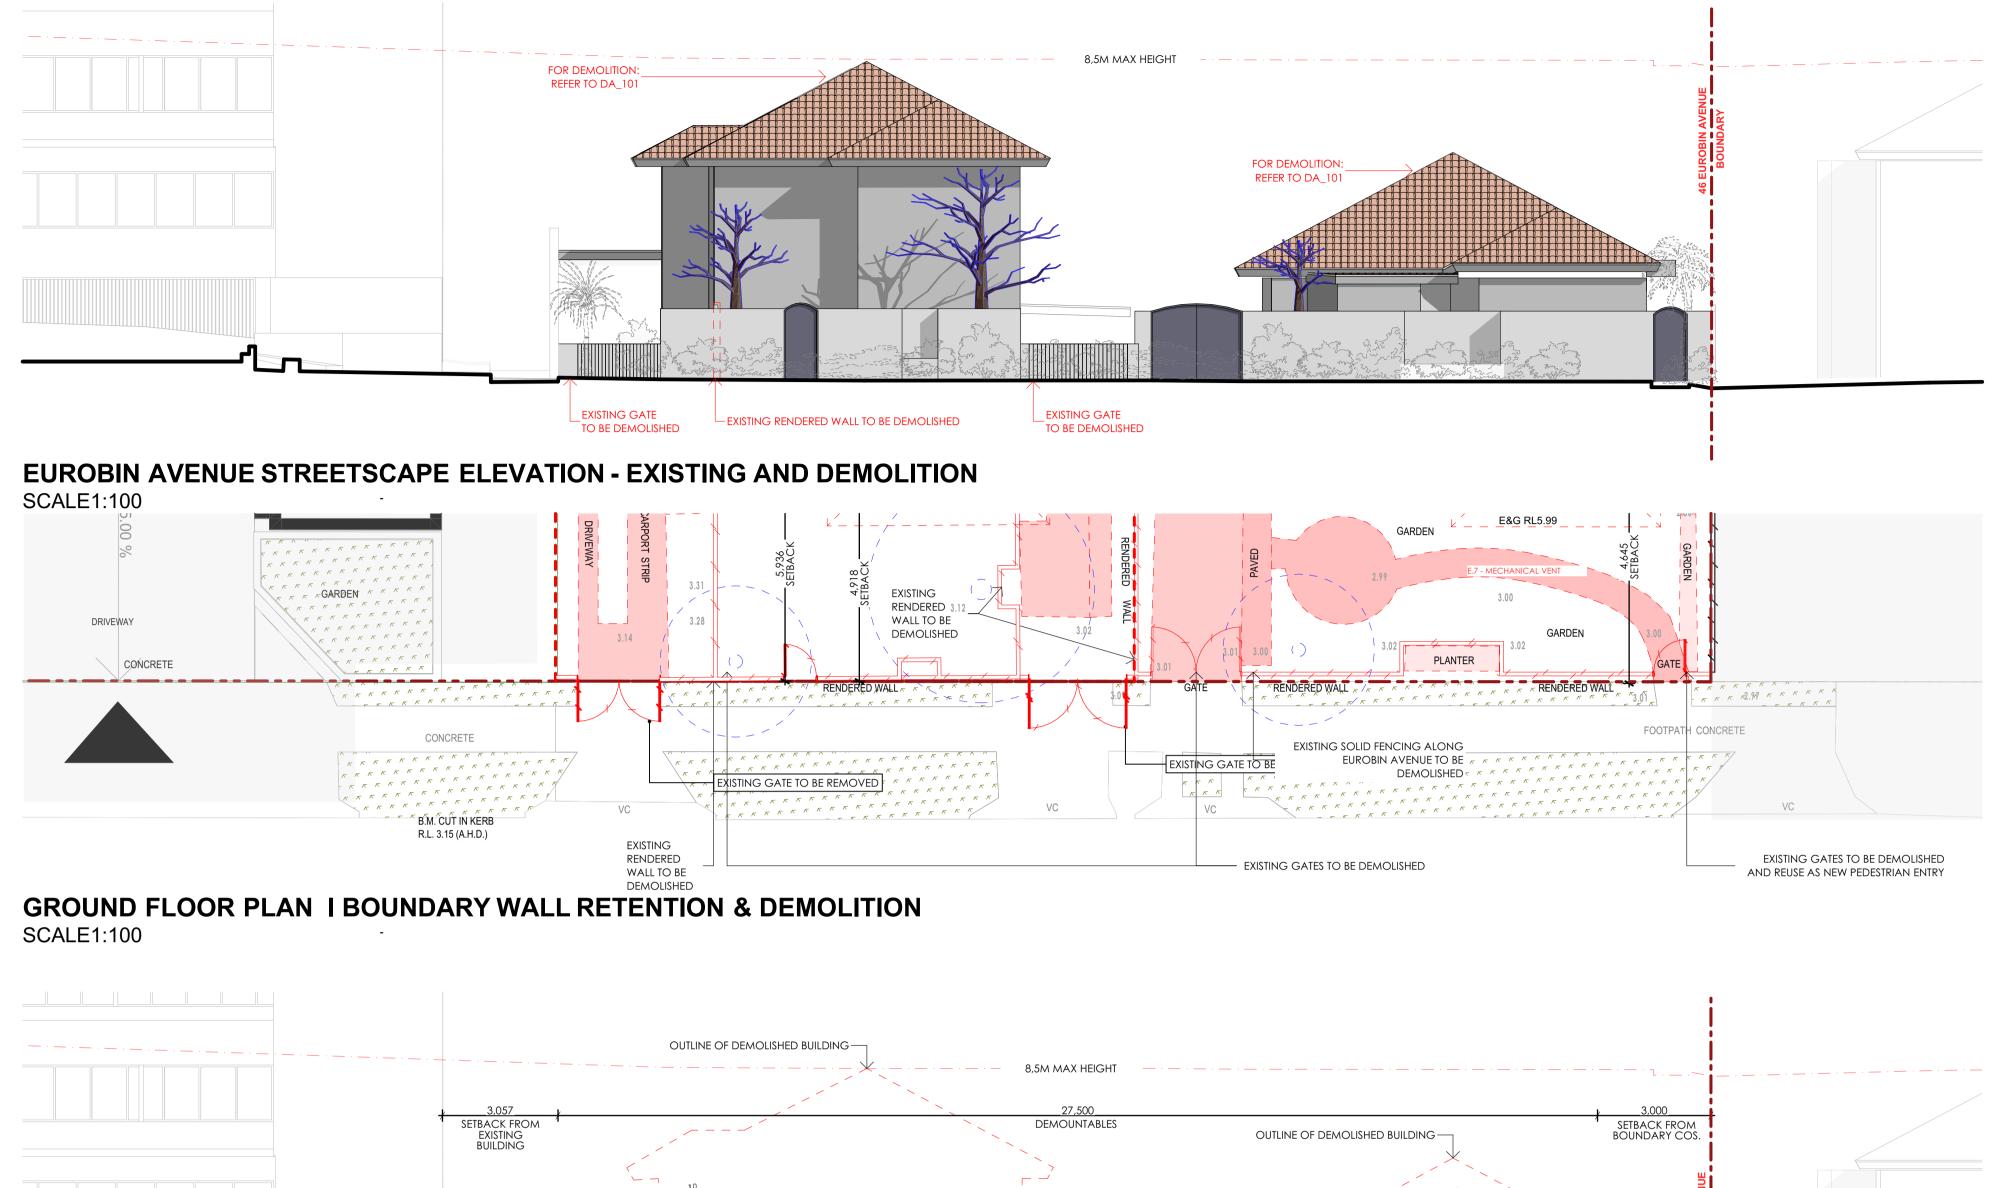
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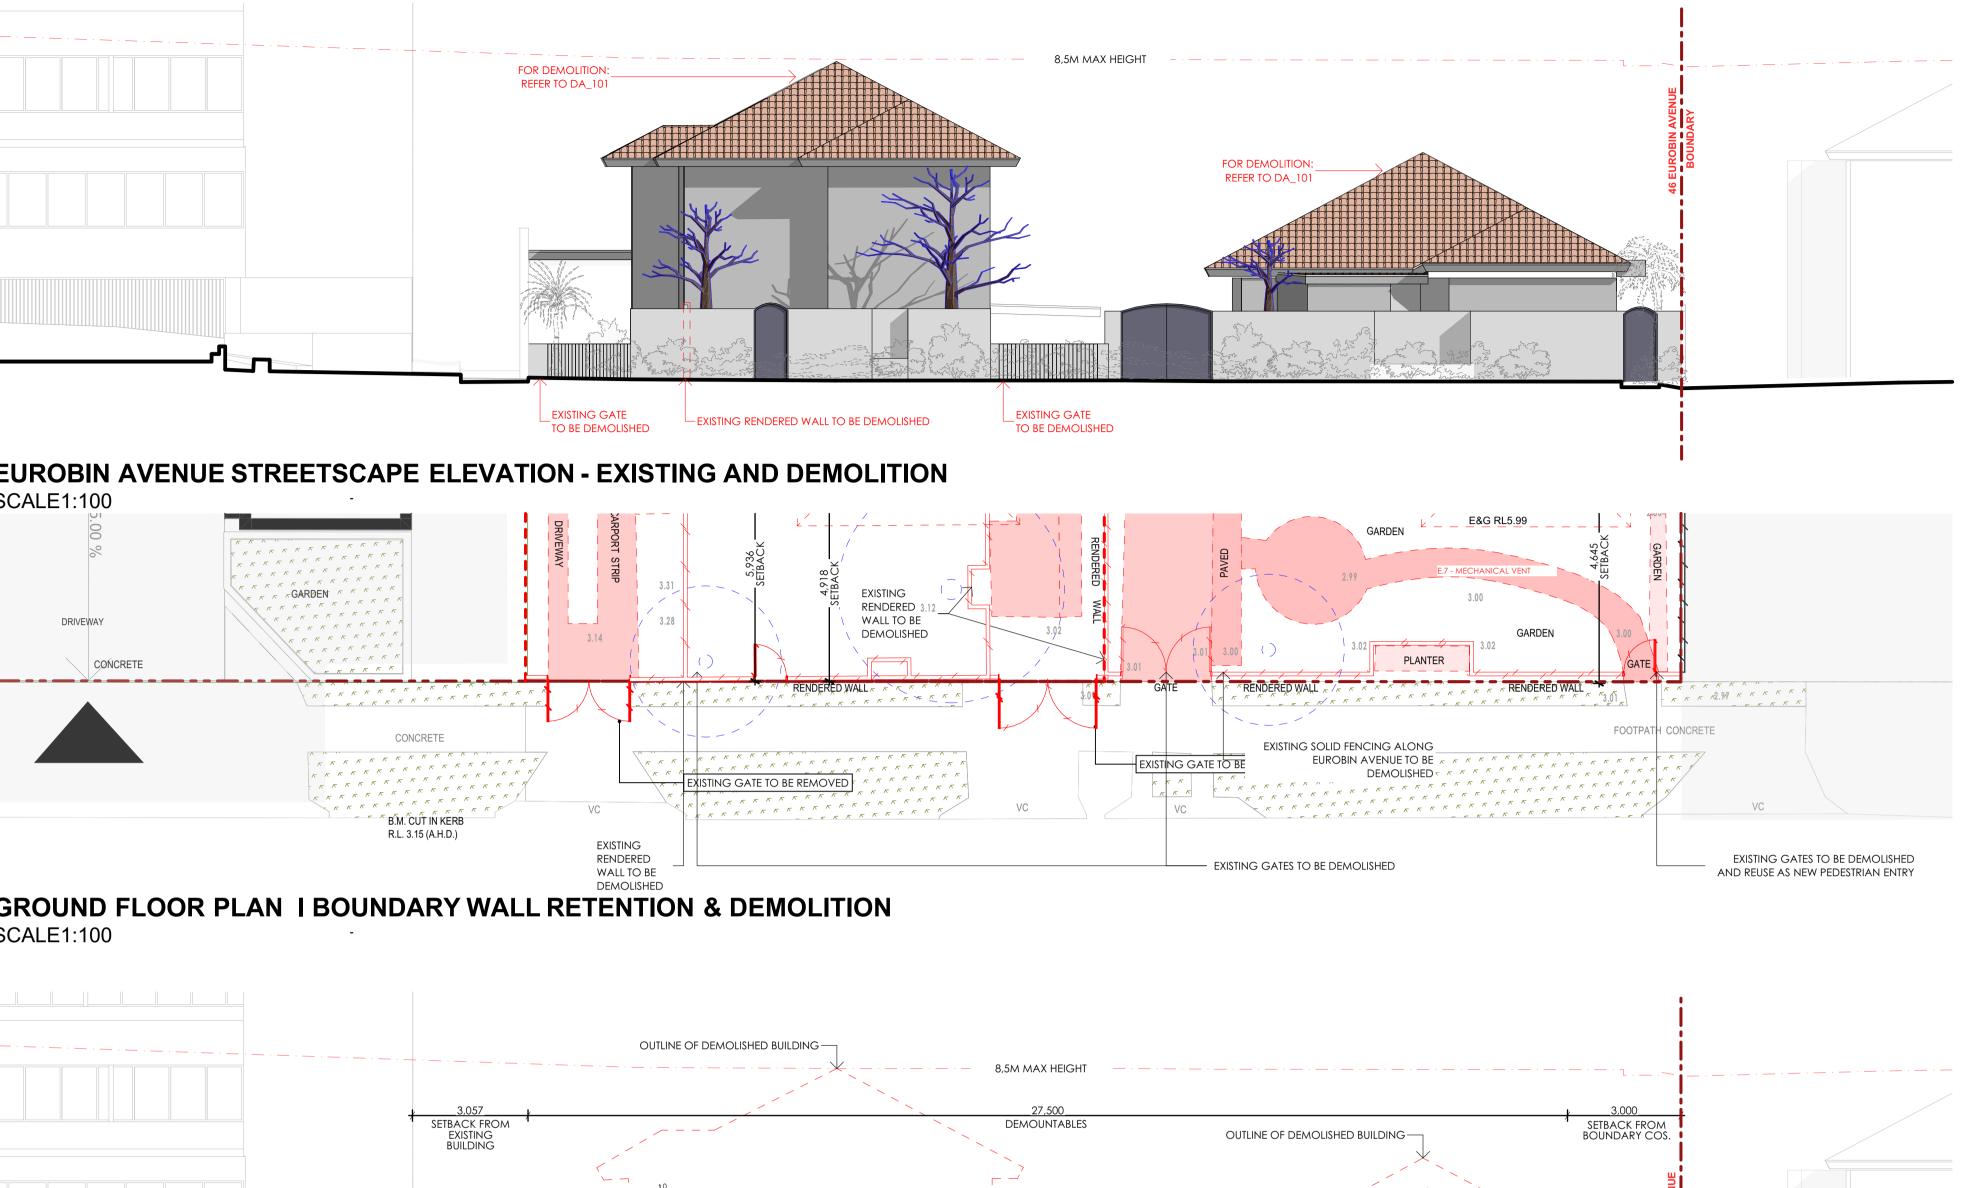
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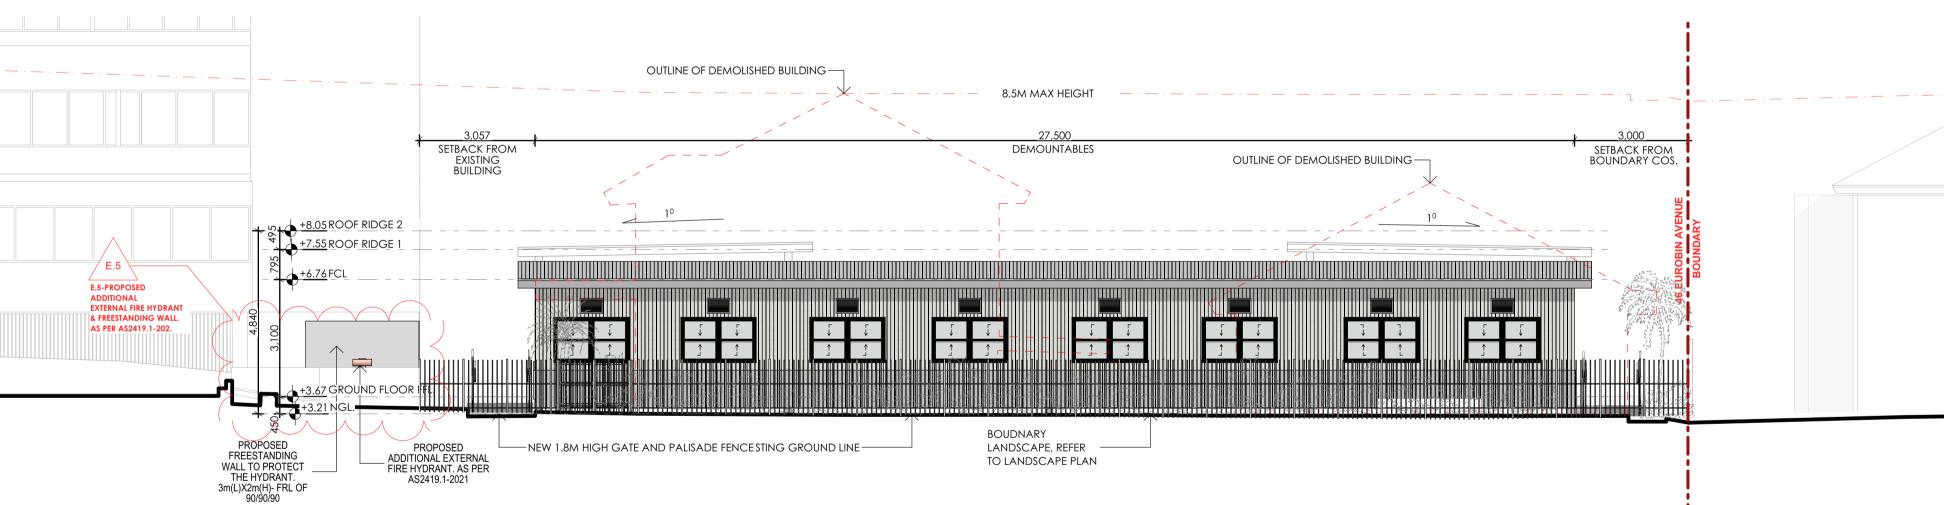
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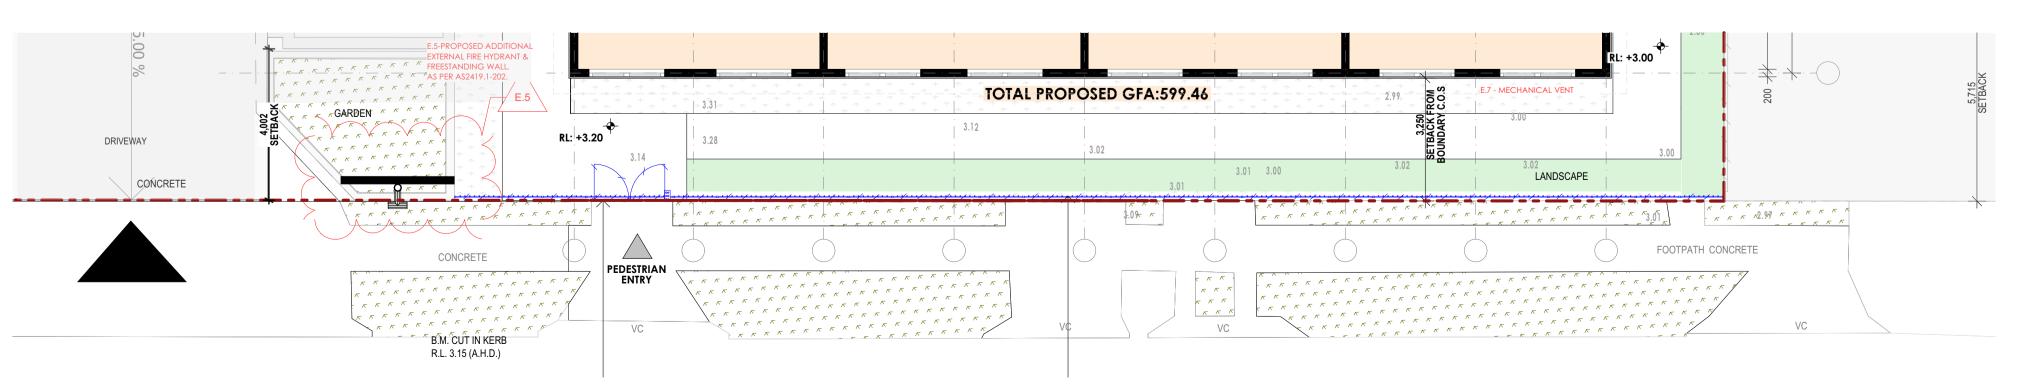
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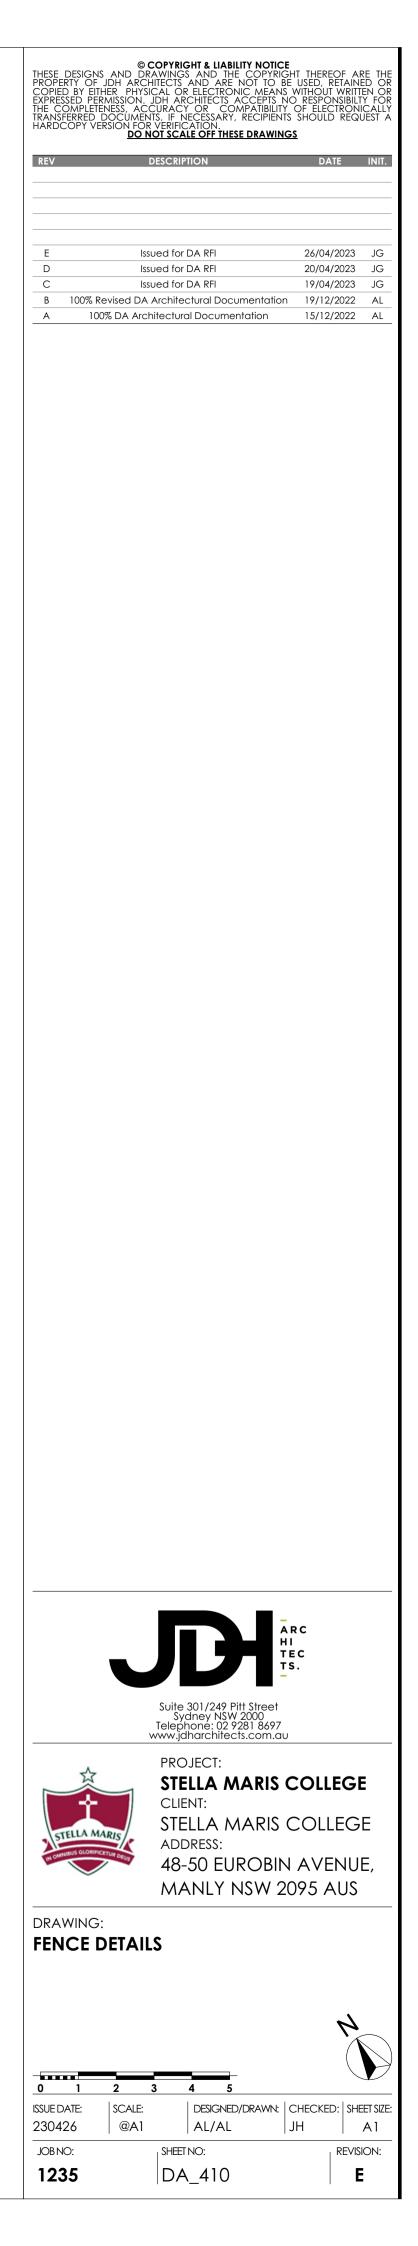






EUROBIN AVENUE STREETSCAPE ELEVATION - PROPOSED SCALE1:100



GROUND FLOOR PLAN I BOUNDARY WALL FENCE & GATE SCALE1:100

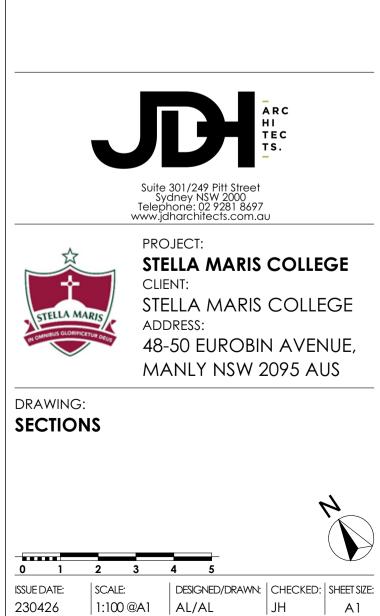


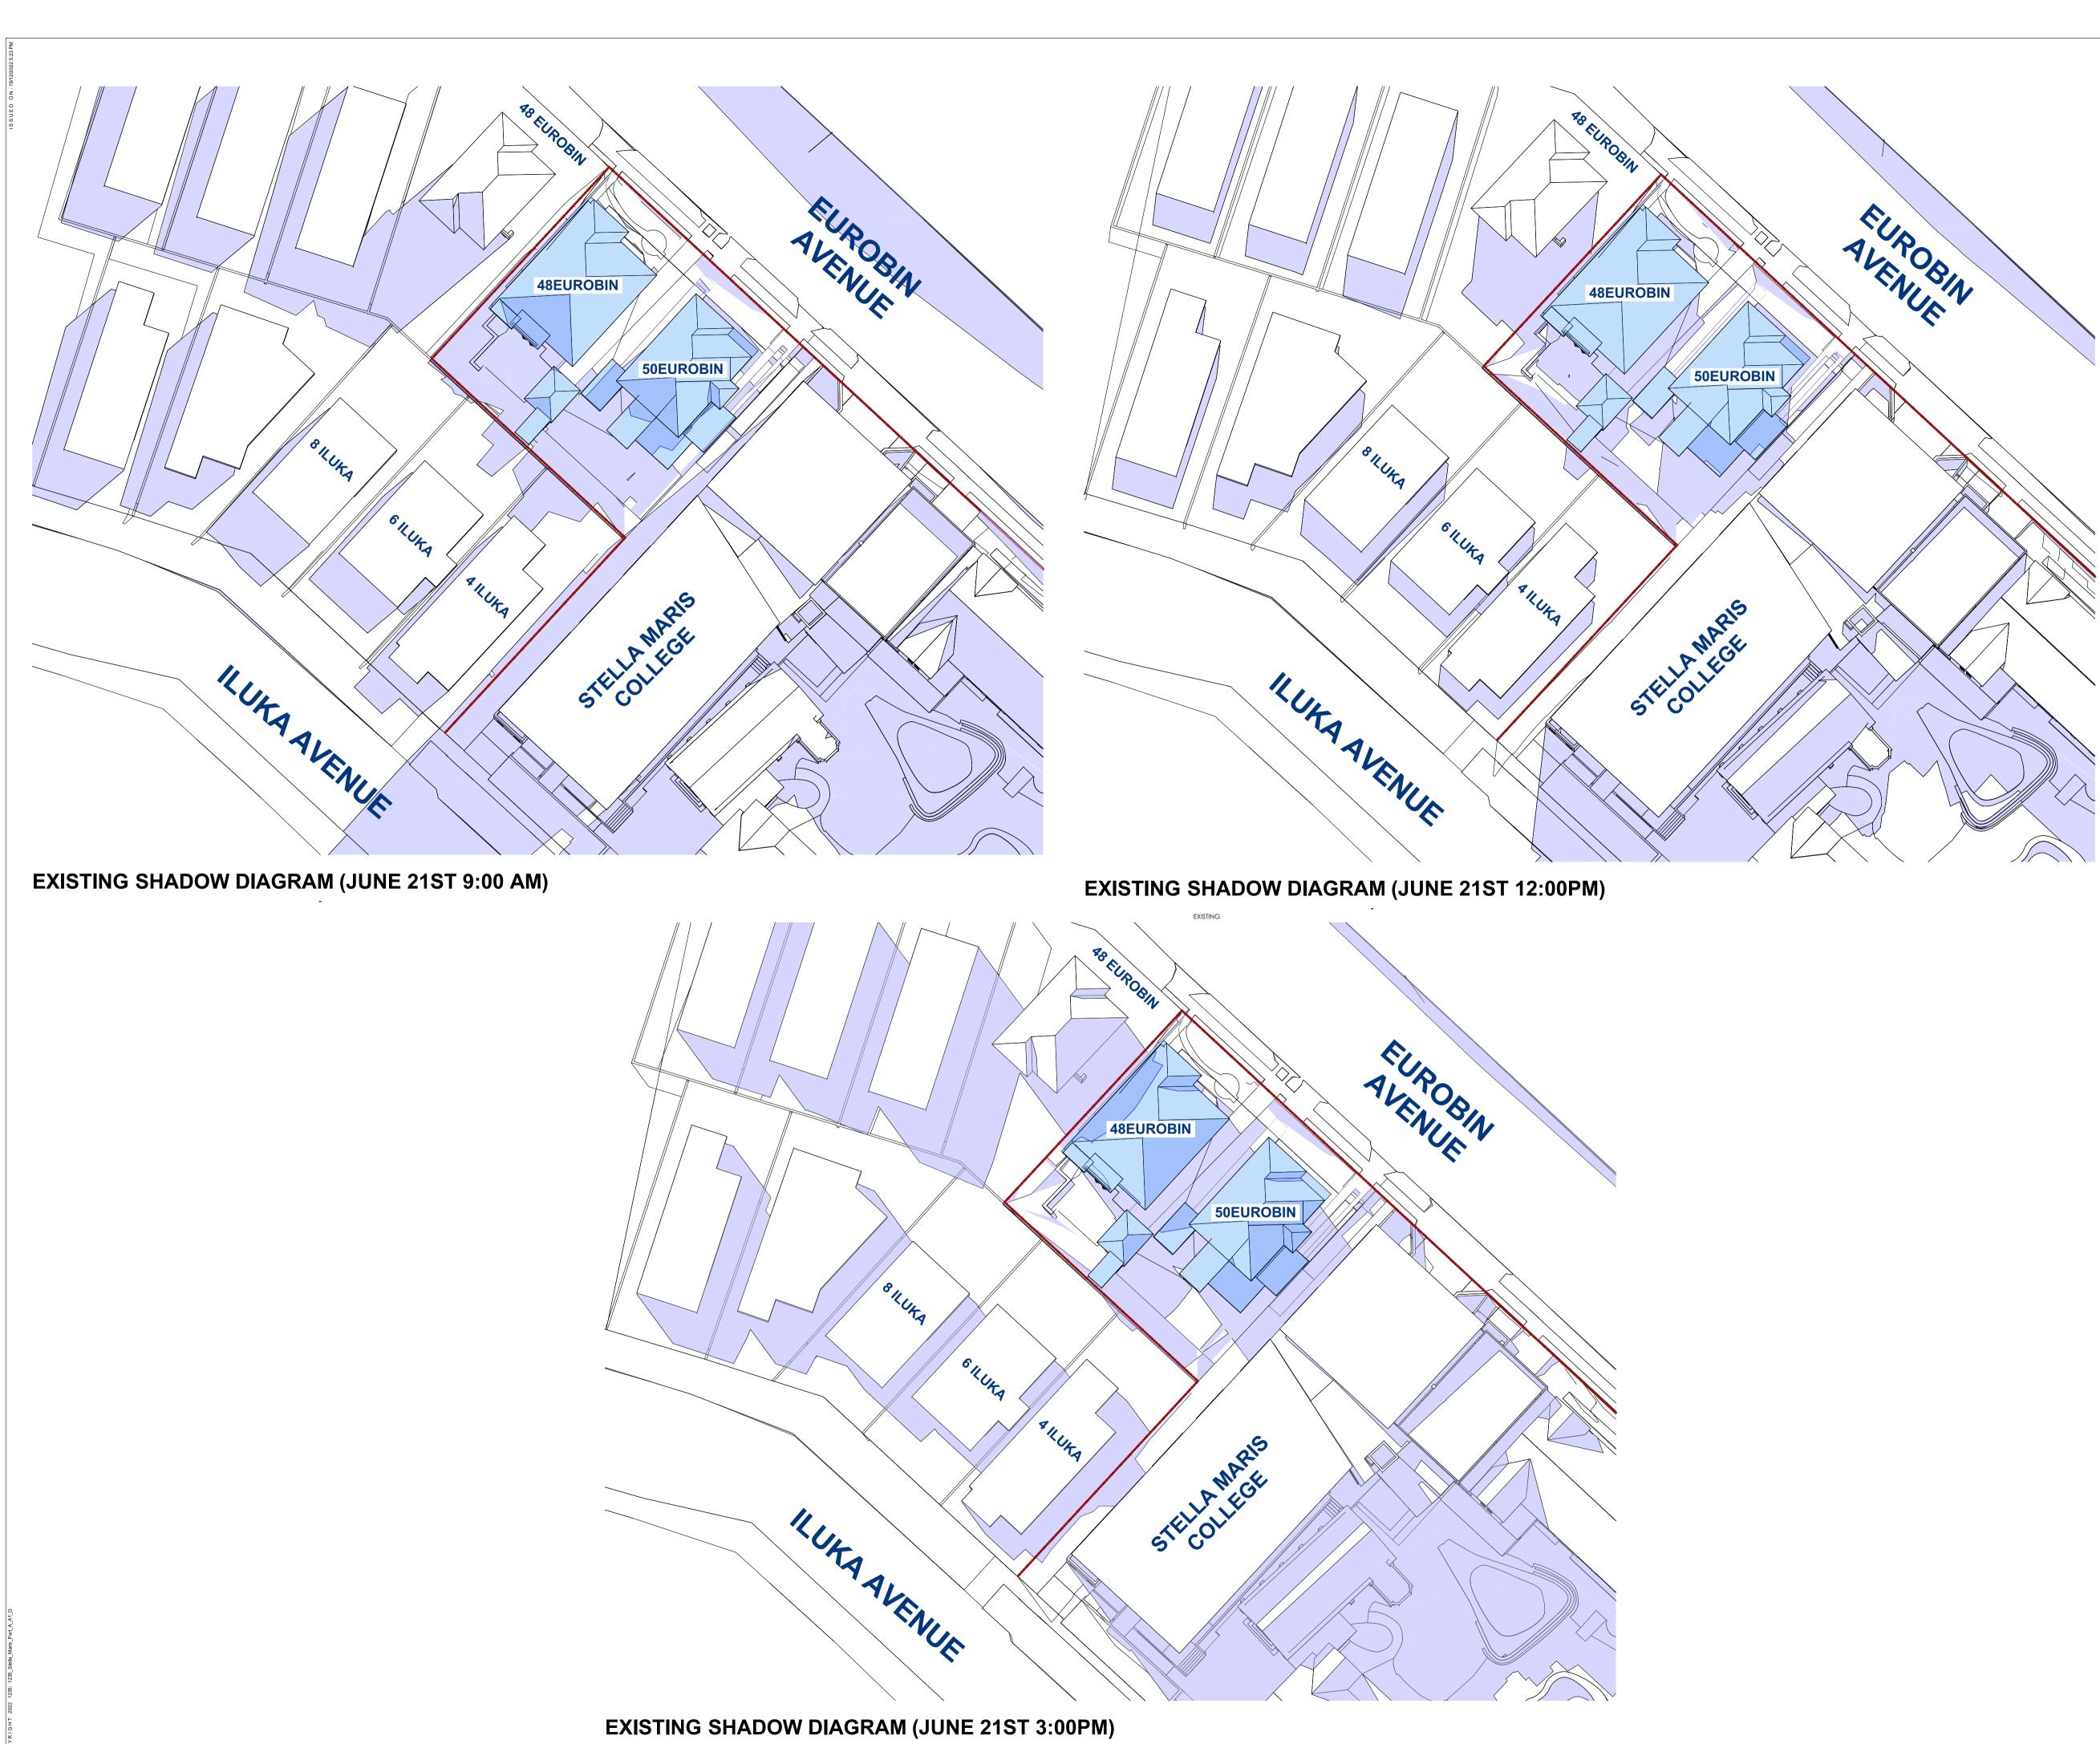

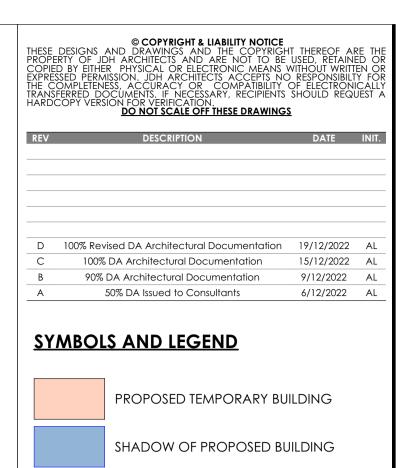

SHADOW OF EXISTING BUILDINGS

EXISTING BUILDING ONSITE

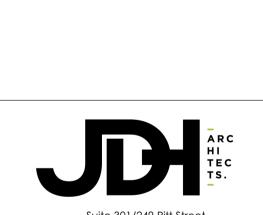

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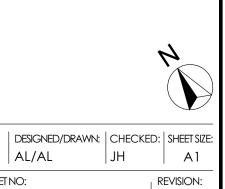


PROJECT: STELLA MARIS COLLEGE CLIENT: STELLA MARIS COLLEGE ADDRESS: 48-50 EUROBIN AVENUE, MANLY NSW 2095 AUS

DRAWING: EXISTING SHADOW DIAGRAM

SHEET NO:

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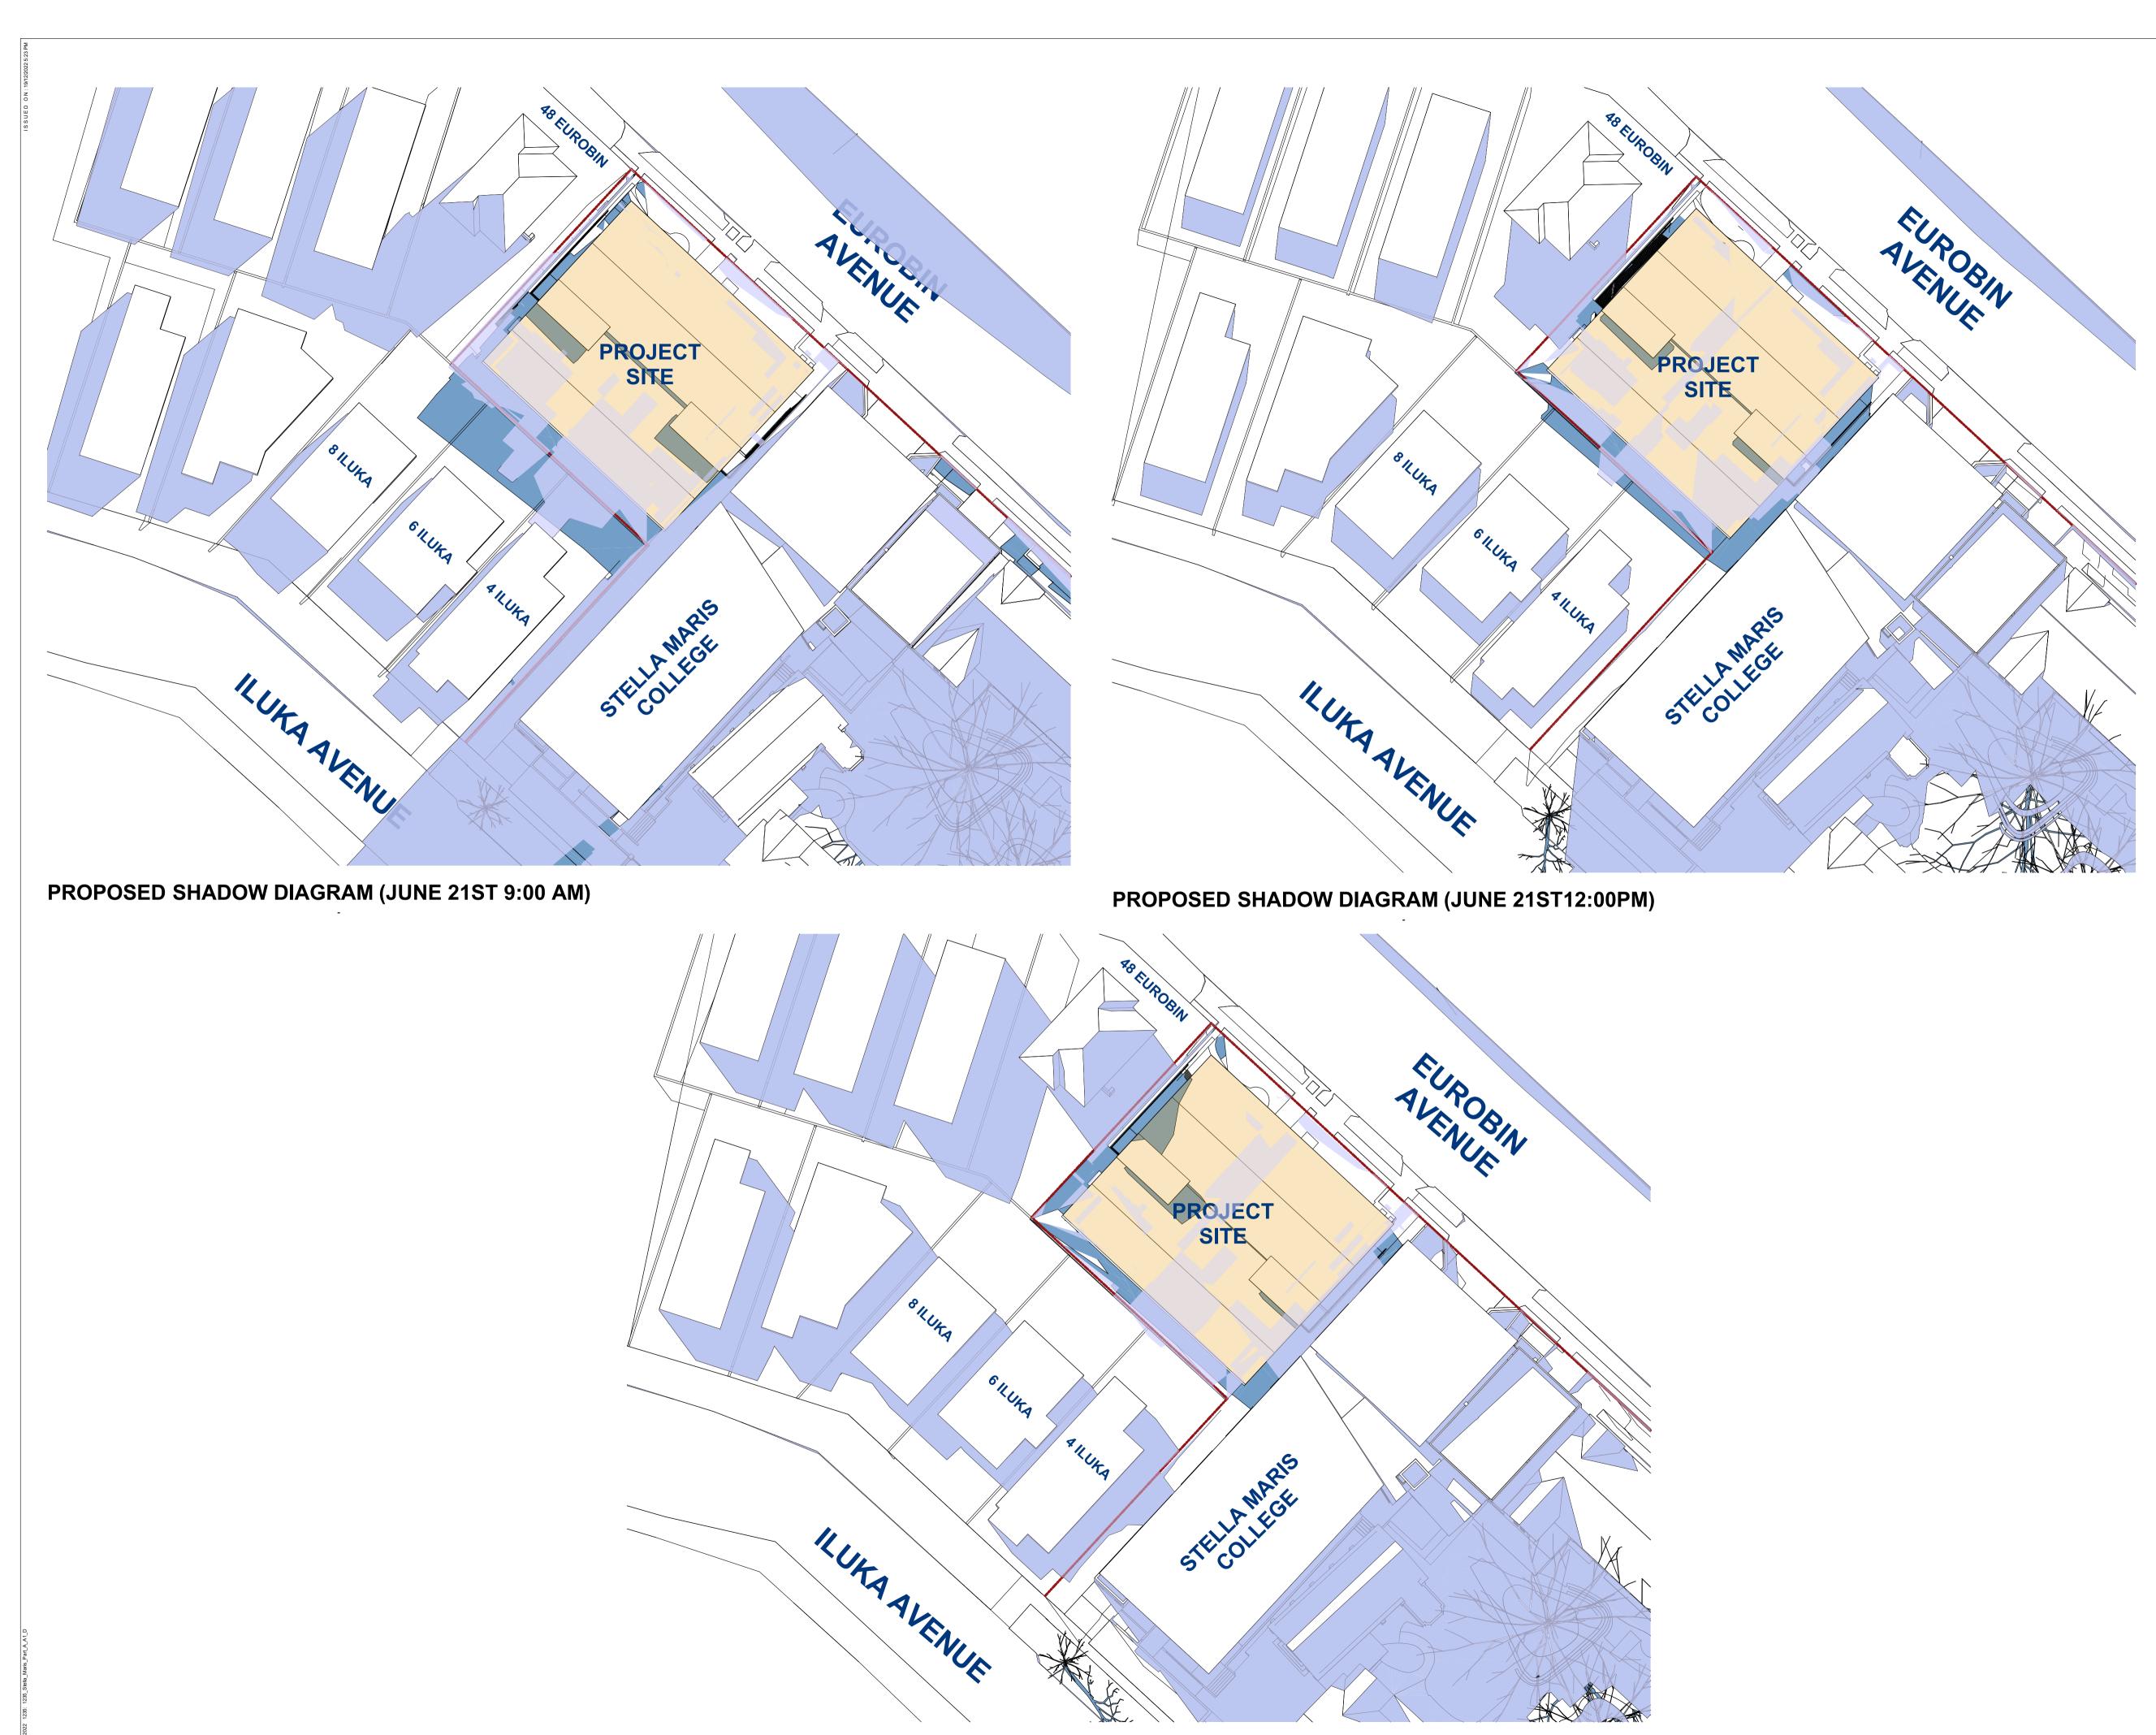
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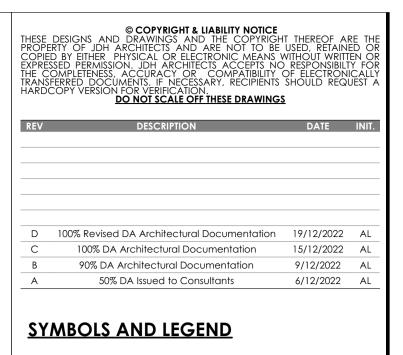
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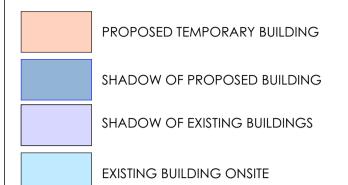
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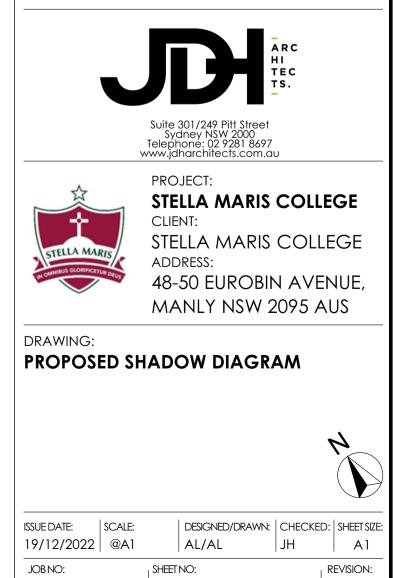
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PROPOSED PLANT SCHEDULE							
KEY	BOTANICAL NAME	COMMON NAME	QTY	MATURE HGT	POT SIZE		
	PALMS						
AR	ARCHONTOPHOENIX CUNNINGHAMIANA	BANGALOW PALM	3	8m	25Ltr		
LA	LIVISTONA AUSTRALIS	CABBAGE TREE PALM	2	10m	45Ltr		
	SHRUBS						
AC	ACMENA SMITHII MINOR 'CHERRY SURPRISE'	CHERRY SURPRISE	20	2.5m	25Ltr		
AZ	ALPINIA ZERUMBET 'VARIEGATA'	VARIEGATED SHELL GINGER	4	2.5m	200mn		
CC	CALLISTEMON 'CANDY PINK'	PINK BOTTLEBRUSH	5	4m	25Ltr		
MP	MURRAYA PANICULATA 'MIN A MIN'	DWARF ORANGE JESSAMINE	1	1m	200mn		
SA	SYZYGIUM AUSTRALE 'STRAIGHT AND NARROW'	NARROW LILLY PILLY	15	5m	25Ltr		
VO	VIBURNUM ODORATISSIMUM 'DENSE FENCE'	DENSE FENCE	8	2.5m	200mn		
	GRASSES / GROUND COVERS						
DC	DIANELLA CAERULEA 'LITTLE JESS'	LITTLE JESS	13	0.4m	140mn		


NOTE: All plants selected and specified are appropriate, non-toxic and non-hazardous. No poisonous or high allergy risk plant species have been selected. Native species have been used where appropriate.









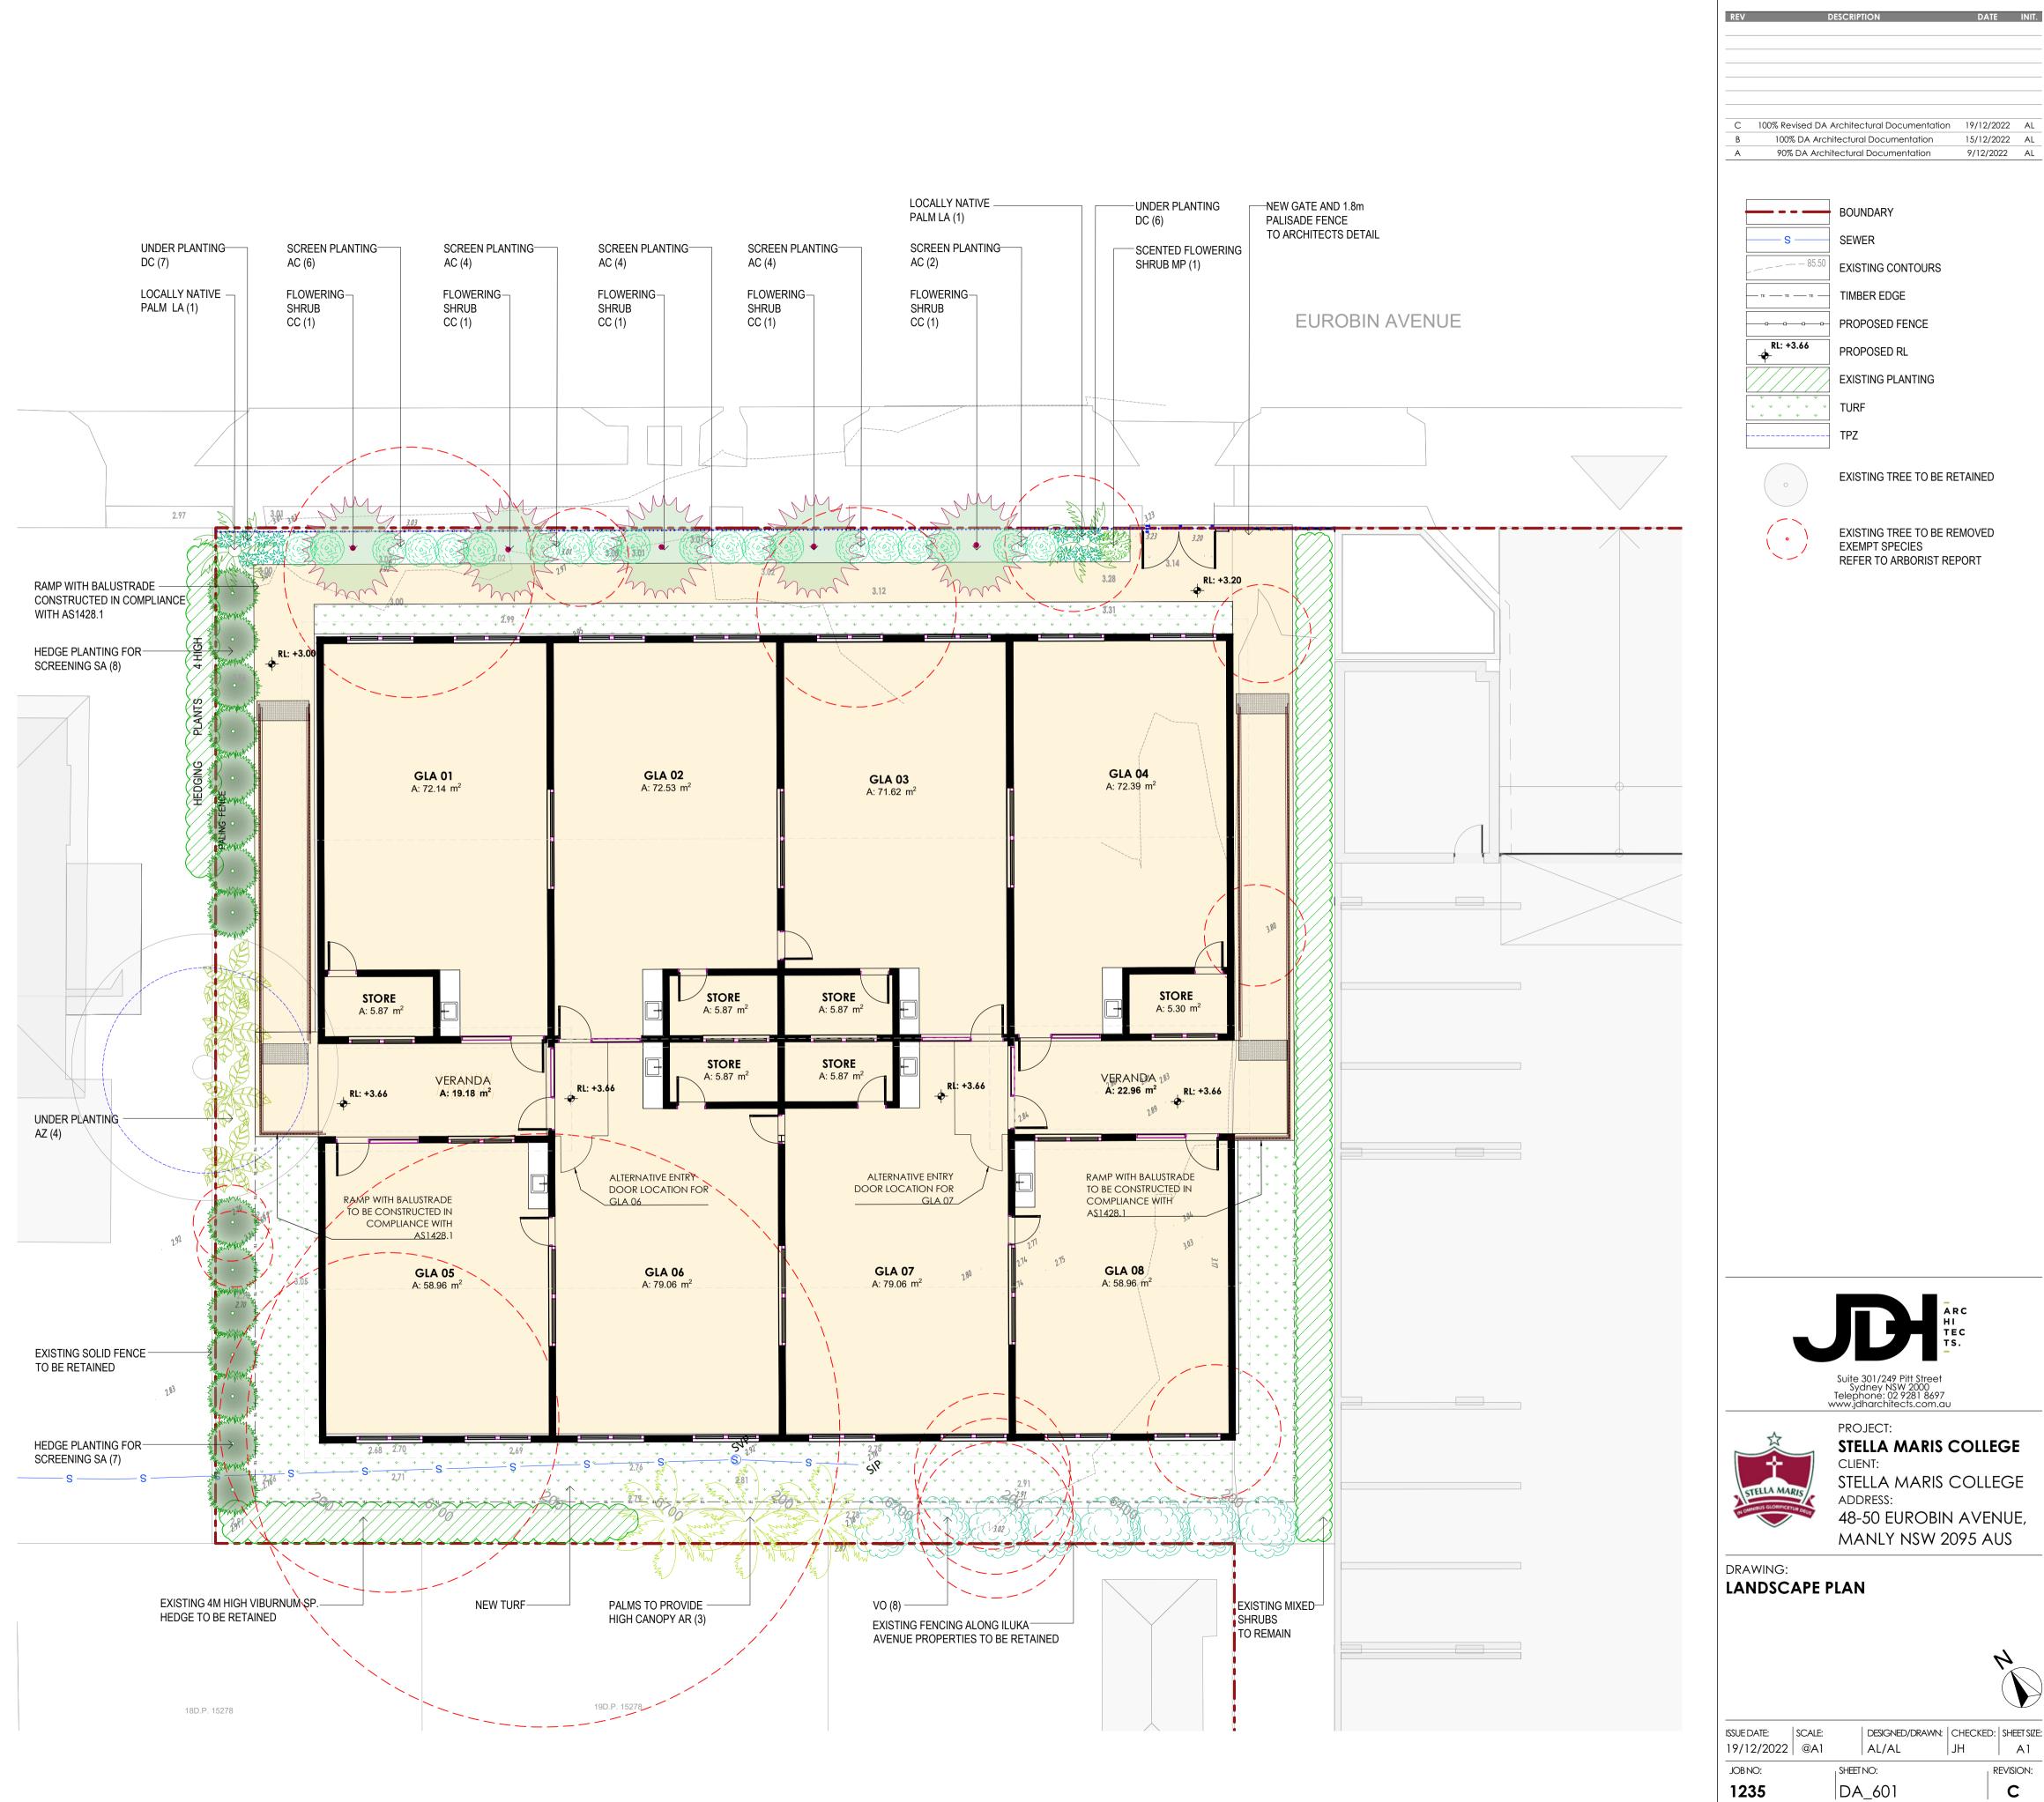


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LANDSCAPE SPECIFICATION NOTES SITE PREPARATION

Locate any underground and overground services & ensure no damage occurs. Levels on plan are nominal only & all dimensions to be checked on site prior to commencement. Final structural integrity of all items shall be the sole responsibility of landscape contractor.

WORKMANSHIP AND MATERIAL QUALITY

Materials and workmanship are to conform to the current applicable Australian Standard Specifications and Codes. Where works are adjacent to existing works, make proper junctions between new and existing works and make good any damage caused to adjoining existing and retained works.

REMOVAL OF EXISTING TREES

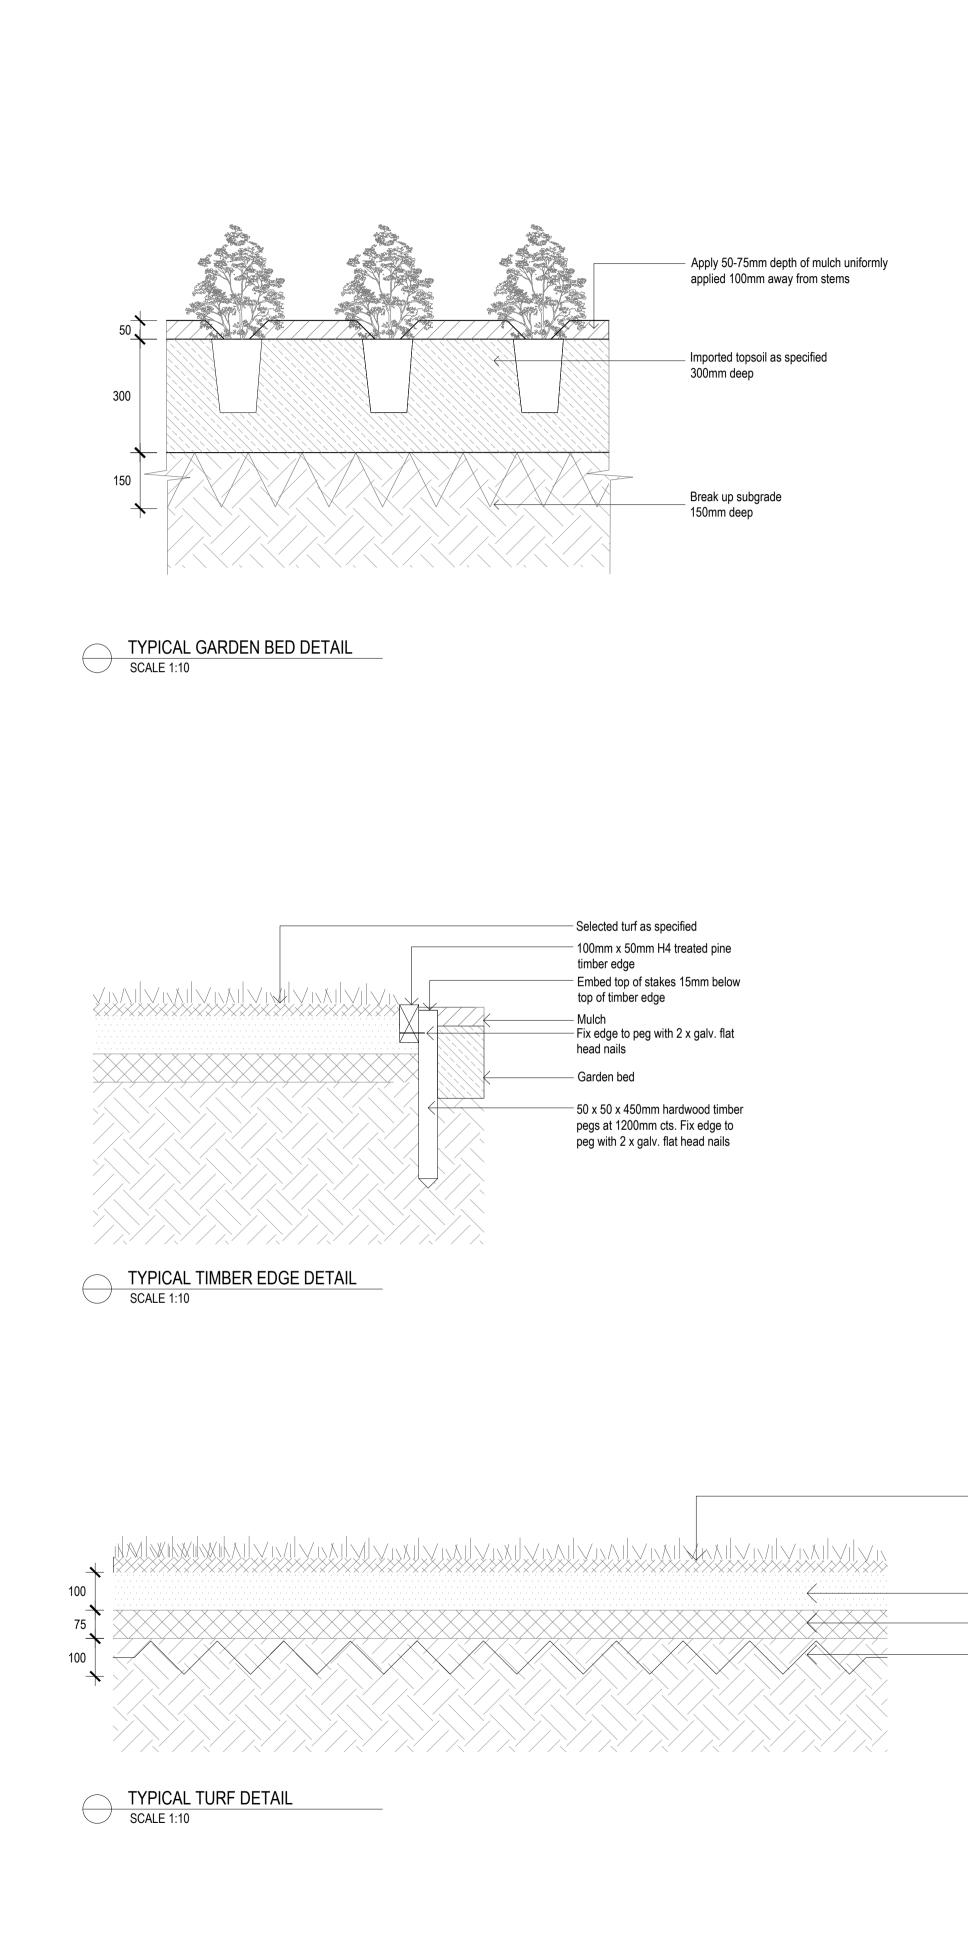All trees to be removed shall be carried out by a qualified arborist and work shall conform to the provisions of AS4373-2007 Australian Standards for The Pruning of AmenityTrees.

ELIMINATE WEEDS

Remove all existing weeds by hand, wiping or spraying with a glyphosate based herbicide. Weed control shall never be performed by mechanical cultivation or by scraping. Herbicide spraying is to be used to eliminate all existing weeds 30 days prior to planting.

EXCAVATION & SUB SOIL PREPARATION

Excavate garden beds to the depth required and rip or scarify base & sides of pit to a minimum depth of 150mm. SUB SOIL DRAINAGE

Install drainage layer where there is surface water runoff draining into garden bed areas & where the existing sub-soil has more than 50% clay composition & there is a risk of subsurface water ponding.

Install perforated corrugated ag. line 75-100mm Dia. with geotextile filter sock & backfill to a minimum 200mm using free draining material, reclaimed/recycled where available. Direct flows at a minimum 0.5% fall to SW system. In areas isolated from stormwater system excavate & backfill an appropriate water dispersion pit.

REUSE EXISTING TOPSOIL

Existing site topsoil should be salvaged & appropriately stockpiled where possible.

IMPORTED TOPSOIL

All construction must comply with AS 4419-2003 Soils for Landscaping and Garden Use. Turf Areas: 'Turf Underlay', Tree Pit and Shrub Planting: 'Premium Garden Mix' as supplied by, ANL p: 02 9450 1444 or approved alternative. Spread the topsoil on the prepared subsoil and grade evenly, making allowances, if appropriate, for the following:

- Required finished levels and contours after light compaction.

- Compact lightly and uniformly in 150 mm layers. Avoid differential subsidence and excess compaction and produce a finished topsoil surface which has the following characteristics:

- Finished to design levels, smooth and free from stones or lumps of soil. Graded to drain freely, without ponding, to catchment points. Grade evenly into adjoining ground surfaces ready for planting.

PLANTING AREA

Remove weeds, rubbish, mulch and other debris. Do not disturb tree roots or services and if necessary cultivate these areas by hand. Spread topsoil on the prepared subsoil and grade evenly, making the necessary allowance to permit the required finished levels and contours after a light compaction. Spread topsoil to the typical depth of 300mm. Feather edges into adjoining undisturbed ground.

PLANT STOCK

Plant stock to be supplied by production nurseries in accordance with AS 2303:2018 Tree Stock for Landscape Use. Health & Vigour: Supply plants with foilage size, texture & colour consistent with that shown in healthy specimens of the species. Balance of Crown: Supply plants with max. variation in crown bulk on opposite sides of stem axis, +/- 20%. Stock selection should also be based on NATSPEC Guide Specifying Trees: a Guide to Assessment of Tree Quality. TIMBER GARDEN EDGING

Supply and install Timber Edge 50 x 100mm (38 x 100mm for curves) as per Landscape Plan. Compact and level the base in the required area as indicated on Landscape Plan. Set edgings flush with adjoining surfaces. Check position of edge is correct before hammering pegs firmly into ground. Drive pegs into the ground at 1200 mm centres on the planting side of the edging and on both sides of joints between boards, with peg tops 15 mm below top of edging. Fix the pegs with galvanized nails, two per fixing.

Curving: Space the pegs to hold edging to a uniform curve. Reduce edging thickness to 15 mm if required for bending. MULCHING

All landscaping must comply with AS 4454-2003 Compost, soil conditioners and mulches. All planting areas to receive 50-75mm of garden Mulch, Droughtmaster, ANL p: 02 9450 1444 or approved alternative. Keep mulch 100mm away from plant stem & form a well to stop excessive water runoff. Finish flush with adjacent surfaces. TURFING

New turf- Sapphire Leafed Buffalo. Excavate / grade all areas to be turfed to 120mm below finished levels. Ensure that all surface runoff is directed away from buildings. Ensure that no pooling or ponding will occur. Further rip the subgrade to 150mm. Install 100mm of imported turf underlay. Rolls to be closely butted and laid in a brickwork pattern. Fill any small gaps with topsoil and water thoroughly.

WATERING

Water in immediately after plant installation & allow for soil settlement. Watering program: Minimum 3 complete waterings, soaking to a depth of 150 mm at fortnightly intervals for the first 6 weeks of plant establishment irrespective of natural rainfall. Manually water all lawn and planting areas in absence of an irrigation system or until the proposed irrigation system is fully operational. Avoid frequent dampening of the surface. Allow the surface of the soil to partially dry out between waterings.

Selected turf laid tightly butted & well tamped down in brickwork pattern across slope

-100mm bedding layer of turf underlay

75mm layer of site topsoil

Break up subgrade 100mm deep

