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SECTION 4.55

THESE PLANS ARE FOR DEVELOPMENT APPROVAL ONLY.

ITEM DETAILS	DEVELOPMENT APPLICATION						
ADDRESS	39 PRINCE EDWARD ROAD, SEAFORTH, NSW, 2092						
LOT & DP/SP	LOT 141 DP 11162						
COUNCIL	NORTHERN BEACHS COUNCIL (MAN	LY)					
SITE AREA	518.50m ²						
FRONTAGE	12.19m						
CONTROLS	PERMISSIBLE / REQUIRED	EXISTING	PROPOSED	COMPLIANCE			
CONTROLS	m / m² / %	m / m² / %	m / m² / %				
<u>LEP</u>							
LAND ZONING	R2 – LOW DENSITY RESIDENTIAL	R2	R2	YES			
MINIMUM LOT SIZE	500m ²	518.50m ²	UNCHANGED	YES			
FLOOR SPACE RATIO	0:45 : 1 (233.325m²)	0.31 : 1 (162.96m²)	0.34 : 1 (174.28m²)	YES			
MAXIMUM BUILDING HEIGHT	8.5m	9.6m	UNCHANGED	NO			
DCP							
RESIDENTIAL OPEN SPACE	AREA OS3						
TOTAL OPEN SPACE (TOS)	55% (285.175m²)	320.98m² (62)	UNCHANGED	YES			
LANDSCAPE AREA	35% OF TOS (55%) : 99.81m ²	315.04m ²	259.01m ²	YES			
OPEN SPACE ABOVE GROUND	MAX. 40% OF TOS (55%) : 114.07m ²	13.40m ²	50.47m ²	YES			
PRINCIPAL PRIVATE OPEN SPACE	18m²	0m²	54.2m ²	YES			
FRONT SETBACK	PREVALING BULDING LINE: 6m	10.9m	8.93m	YES			
REAR SETBACK	8.0m	16.6m	13.103mm	YES			
SIDE SETBACKS	1/3 WALL HEIGHT	N:0.994m	N:UNCHANGED	NO			
	3.050m	S:1.016m	S:UNCHANGED	NO			
CAR PARKING SPACES	Required: 1	2	UNCHANGED	YES			

SHEET NUMBER	SHEET NAME	DATE PUBLISHED
S4.55-00	COVER	23/07/2021
S4.55-01	NOTATION	23/07/2021
S4.55-02	SITE ANALYSIS	23/07/2021
S4.55-03	${\tt SITE/ROOF/SEDIMENT\ EROSION/WASTE\ MANAGEMENT/STORMWATER\ CONCEPT\ PLAN}$	23/07/2021
S4.55-04	EXISTING GARAGE FLOOR PLAN	23/07/2021
S4.55-05	EXISTING GROUND FLOOR PLAN	23/07/2021
S4.55-06	EXISTING FIRST FLOOR PLAN	23/07/2021
S4.55-07	PROPOSED GARAGE FLOOR PLAN	23/07/2021
S4.55-08	PROPOSED GROUND FLOOR PLAN	23/07/2021
S4.55-09	PROPOSED FIRST FLOOR PLAN	23/07/2021
S4.55-10	NORTH / EAST ELEVATION	23/07/2021
S4.55-11	SOUTH / WEST ELEVATION	23/07/2021
S4.55-12	LONG / CROSS SECTION	23/07/2021
S4.55-13	AREA CALCULATIONS / SAMPLE BOARD	23/07/2021
S4.55-14	WINTER SOLSTICE 9 AM	23/07/2021
S4.55-15	WINTER SOLSTICE 12 PM	23/07/2021
S4.55-16	WINTER SOLSTICE 3 PM	23/07/2021
S4.55-17	BASIX COMMITMENTS	23/07/2021

39 PRINCE EDWARD ROAD, SEAFORTH NSW 2092





NCC & AS COMPLIANCES SPECIFICATIONS


- EARTHWORKS PART 3.1.1 OF NCC
- EARTH RETAINING STRUCTURES PART 3.1.2 OF NCC
- DRAINAGE PART 3.1.3 OF NCC
- TERMITE-RISK MANAGEMENT PART 3.1.4 OF NCC
- FOOTINGS & SLAB PART 3.2 OF NCC INCLUDING AS2870
- MASONRY PART 3.3 OF NCC INCLUDING AS3700
- FRAMING PART 3.4 OF NCC
- SUB FLOOR VENTILATION PART 3.4.1 OF NCC
- ROOF CLADDING AND WALL-CLADDING PART 3.5 OF NCC
- GLAZING PART 3.6 OF NCC INCLUDING AS1288
- FIRE SAFETY PART 3.7 OF NCC
- FIRE SEPERATION PART 3.7.2 OF NCC
- FIRE PROTECTION OF SEPERATING WALLS AND FLOORS- PART 3.7.3 OF NCC
- SMOKE ALARMS PART 3.7.5 OF NCC
- WET AREAS AND EXTERNAL WATERPROOFING PART 3.8.1 OF NCC
- ROOM HEIGHTS PART 3.8.2 OF NCC
- FACILITIES PART 3.8.3 OF NCC
- LIGHT PART 3.8.4 OF NCC
- VENTILATION PART 3.8.5 OF NCC
- SOUND INSULATION PART 3.8.6 OF NCC
- STAIRWAYAND RAMP CONSTRUCTION PART 3.9.1 OF NCC
- BARRIERS AND HANDRAILS PART 3.9.2 OF NCC
- SWIMMING POOLS PART 3.10.1 OF NCC
- CONSTRUCTION IN BUSHFIRE PRONE AREAS PART 3.10.5 OF NCC
- FENCING & OTHER PROVISIONS REGS & AS1926
- DEMOLITION WORKS AS2601-1991 THE DEMOLITION OF STRUCTURES.
- ALL WATERPROOF MEMBRANES TO COMPLY WITH WITH AS 3740-2010
- ALL PLUMBING & DRAINAGE WORK TO COMPLY WITH AS 3500
- SITE CLASSIFICATION AS TO AS 2870
- ALL PLASTERBOARD WORK TO COMPLY WITH AS 2588-1998
- ALL STRUCTURAL STEEL WORK TO COMPLY WITH AS 4100 & AS 1554
- ALL CONCRETE WORK TO COMPLY WITH AS 3600
- ALL ROOF SHEETING WORK TO COMPLY WITH AS 1562-1992
- ALL SKYLIGHTS TO COMPLY WITH WITH AS 4285-2007
- ALL CERAMIC TILING TO COMPLY WITH AS 3958.1-2007 & 3958.2-1992
- ALL GLAZING ASSEMBLIES TO COMPLY WITH AS 2047 & 1288
- ALL TIMBER RETAINING WALLS ARE TO COMPLY WITH AS 1720.1-2010, AS 1720.2-2006, AS 1720.4-2006, AS 1170.1-1989 & AS 1170.4-2007
- ALL RETAINING WALLS ARE TO COMPLY WITH 3700 2011 & AS 3600 -2009
- ALL CONSTRUCTION TO COMPLY TO AS3959- 2009

NOTES

- APPROVED MEANS BY THE 'RELEVANT LOCAL AUTHORITY' OR COUNCIL
- THE OWNER WILL DIRECTLY PAYTHE FEES ASSOCIATED WITH THE FOLLOWING:
- BUILDING APPROVAL FROM COUNCIL, FOOTPATH AND KERB DEPOSITS WITH THE LOCAL COUNCIL, INSURANCE FEE TO BUILDING SERVICES CORPORATION, LONG SERVICE LEAVE SERVICE LEVY FEE AND APPROVAL FEE BY WATER AND SEWERAGE AUTHORITY. ALL OTHER FEES ARE TO BE PAID BY THE BUILDER. THE AMOUNT OF ANY LOCAL AUTHORITY DEPOSITS WHICH ARE FORFEITED DUE TO DAMAGE OR OTHER CAUSE WILL BE DEDUCTED FROM THE PAYMENTS DUE TO THE BUILDER.
- THE BUILDER IS TO PROVIDE AT HIS/HER OWN EXPENSE ADEQUATE PUBLIC RISK INSURANCE AND ARRANGE INDEMNIFICATION UNDER THE WORKERS COMPENSATION ACT. WORKS INSURANCE TO BE STATED IN THE CONTRACT CONDITIONS.
- ALL WORK TO BE CARRIED OUT IN A TRADESMEN LIKE MANNER AND IN ACCORDANCE WITH THE STANDARDS CODES AND REGULATIONS OF THE STANDARDS ASSOCIATION OF AUSTRALIA, BUILDING CODE OF AUSTRALIA AND ANY STATUTORY AUTHORITY HAVING JURISDICTION OVER THE WORK.
- ALL TENDERERS ARE TO VISIT THE SITE TO SATISFY THEMSELVES AS TO THE NATURE AND EXTENT OF THE WORKS, FACILITIES AVAILABLE AND DIFFICULTIES ENTAILED IN THE WORKS AS VARIATIONS WILL NOT BE ALLOWED DUE TO WORK ARISING OWING TO NEGLECT OF THIS CLAUSE.
- ALL WORK AND MATERIALS TO COMPLY WITH THE CURRENT AUSTRALIAN STANDARDS AT THE TIME OF COMMENCEMENT WERE APPLICABLE.
- THESE DRAWINGS SHALL BE READ IN CONJUNCTION WITH ALL STRUCTURAL AND OTHER CONSULTANTS DRAWINGS AND SPECIFICATIONS AND WITH ANY SUCH WRITTEN INSTRUCTIONS AS MAY BE ISSUED DURING THE COURSE OF THE CONTRACT.
- SET OUT DIMENSIONS SHOWN ON THIS DRAWING SHALL BE VARIFIED BY THE BUILDER ON SITE BEFORE COMMENCEMENT OF ANY WORK. DIMENSIONS SHOULD NOT BE OBTAINED BY SCALING THE DRAWINGS. USE ONLY FIGURED DIMENSIONS. ALL DIMENSIONS ARE IN MILLIMETRES.
- THE BUILDER IS TO ENSURE ALL CONSTRUCTION. LEVELS AND OTHER ITEMS COMPLY WITH THE CONDITIONS OF THE BUILDING APPROVAL.
- THE BUILDER IS TO COMPLY WITH ALL ORDINANCES, LOCAL AUTHORITY REGULATIONS AND THE REQUIREMENTS OF ALL SERVICES SUPPLY AUTHORITIES HAVING JURISDICTION OVER THE WORKS.
- ALL PLUMBING AND DRAINAGE WORK TO BE INSTALLED AND COMPLETED BY A LICENCED TRADESMAN AND IN ACCORDANCE WITH THE STATUTORY BODY HAVING AUTHORITY OVER THE WORKS. CONNECT ALL WASTE TO SYDNEY WATER SEWER LINE
- ALL NEW DOWNPIPES ARE TO BE CONNECTED TO THE EXISTING STORM WATER SYSTEM.
- ALL POWER AND STORMWATER OUTLET LOCATIONS SHALL BE DETERMINED ONSITE BY THE OWNER.
- SMOKE DETECTOR ALARM TO BE INSTALLED IN ACCORDANCE WITH AS3786 AND THE BUILDING CODE OF AUSTRALIA.
- ELECTRICAL WORK TO BE IN ACCORDANCE WITH SAA WIRING RULES AND BE DONE BY A LICENCED TRADESMAN
- ANY DETAILING IN ADDITION TO WHAT IS SUPPLIED SHALL BE RESOLVED BETWEEN THE OWNER AND THE BUILDER TO THE OWNERS APPROVAL, EXCEPT FOR ANY STRUCTURAL DETAILS OR DESIGN WHICH IS SUPPLIED BY THE ENGINEER.
- ALL TIMBER SIZES AND CONCRETE DETAILS TO BE CONFIRMED BY THE BUILDER PRIOR TO COMMENCEMENT OF ANY WORK.
- ALL STRUCTURAL WORK IS TO BE IN ACCORDANCE WITH THE STRUCTURAL DETAILS PREPARED BY A STRUCTURAL ENGINEER (i.e.) PIERS, FOOTINGS, CONCRETE SLABS, RETAINING WALLS, STEELWORK, FORMWORK, UNDERPINNING, ADDITIONAL STRUCTURAL LOADS, TIMBER FRAMING, WIND BRACING AND ASSOCIATED CONNECTIONS. BUILDER TO OBTAIN PRIOR TO FINALISING TENDER.
- ANY WORK INDICATED ON THE PLANS BUT NOT SPECIFIED, AND ANY ITEM NOT SHOWN ON THE PLAN WHICH IS OBVIOUSLY NECESSARY AS A PART OF CONSTRUCTION AND/OR FINISH IS TO BE CONSIDERED AS SHOWN AND SPECIFIED, AND IS TO BE DONE AS PART OF THE CONTRACT. VARIATIONS WILL NOT BE PERMITTED WITHOUT THE WRITTEN CONSENT OF THE OWNER.
- THE BUILDER SHALL PROVIDE SEDIMENT AND SILTRATION CONTROL MEASURES AS REQUIRED BY COUNCIL AND MAINTAIN THEM THROUGH THE DURATION OF THE WORKS.
- A LEGIBLE COPY OF THE PLANS BEARING APPROVAL STAMPS MUST BE MAINTAINED ON THE JOB AT ALL TIMES. HOURS OF CONSTRUCTION WILL BE RESTRICTED TO THE TIMES AS REQUIRED BY THE BUILDING APPROVAL.
- THE BUILDER IS TO ARRANGE FOR ALL INSPECTIONS REQUIRED BY THE AUTHORITIES AND LENDING INSTITUTIONS TO THEIR REQUIREMENTS.
- THE BUILDER IS TO OBTAIN APPROVAL FOR INTERUPTIONS TO EXISTING SERVICES AND MINIMISE THE DURATION AND NUMBER OF INTERUPTIONS. ANY INTERRUPTIONS WITH EXISTING SERVICES AND EQUIPMENT TO BE ATTENDED TO BY THE APPROPRIATELY SKILLED TRADESMEN.
- THE BUILDER SHALL RESTORE, REINSTATE OR REPLACE ANY DAMAGE CAUSED TO EXISTING STRUCTURES OR LANDSCAPING BY CONSTRUCTION WORK OR WORKMEN. PROVIDE PROTECTION TO EXISTING TREES TO REMAIN AS REQUIRED BY APPROVAL CONDITIONS.
- ALL BRICKWORK IS TO BE SELECTED BY OWNER AND IS TO COMPLY WITH AS1640
- ALL MASONRY TO COMPLY WITH AS3700
- ALL METALWORK AND FLASHING ITEMS NECESSARY TO SATISFACTORY COMLPETE WORK SHALL BE PROVIDED.
- ALL GUTTERS, DOWNPIPES TO BE COLORBOND.
- ALL TIMBER CONSTRUCTION TO BE IN ACCORDANCE WITH THE AUSTRALIAN STANDARD 1684 "TIMBER FRAMING CODE"
- ALL GLAZING INSTALLED TO COMPLY WITH AS1288, 2047 AND IN ACCORDANCE WITH MANUFACTURERS RECOMMENDATION
- ALL WALL AND CEILING LININGS TO BE PLASTERBOARD OR CEMENT RENDER AS SELECTED AND VILLA BOARD IN WET AREAS, TO COMPLY WITH THE RELEVANT AUSTRALIAN STANDARDS OR INSTALLED IN ACCORDANCE WITH MANUFACTURERS SPECIFICATION.
- ALL BATHROOMS AND WET AREAS TO BE ADEQUATELY WATERPROOFED TO MANUFACTURERS SPECIFATION AND AS3740 AND PART 3.8.1 OF THE BUILDING CODE OF AUSTRALIA HOUSING PROVISIONS
- STAIRS AND BALUSTRADES TO COMPLYWITH PART 3.9.1 & 3.9.2 OF THE BUILDING CODE OF AUSTRALIA HOUSING PROVISION.
- TERMITE PROTECTION MEASURES TO COMPLY WITH AS 3660 AND BE INSTALLED TO MANUFACTURERS SPECIFICATION.
- ANY DETAILING ADDITIONAL TO THAT SUPPLIED, SHALL BE RESOLVED BETWEEN THE OWNER AND THE BUILDER TO THE OWNERS APPROVAL. EXCEPT FOR ANY STRUCTURAL DETAILS OR DESIGN WHICH IS TO BE SUPPLIED BY THE STRUCTURAL ENGINEER.

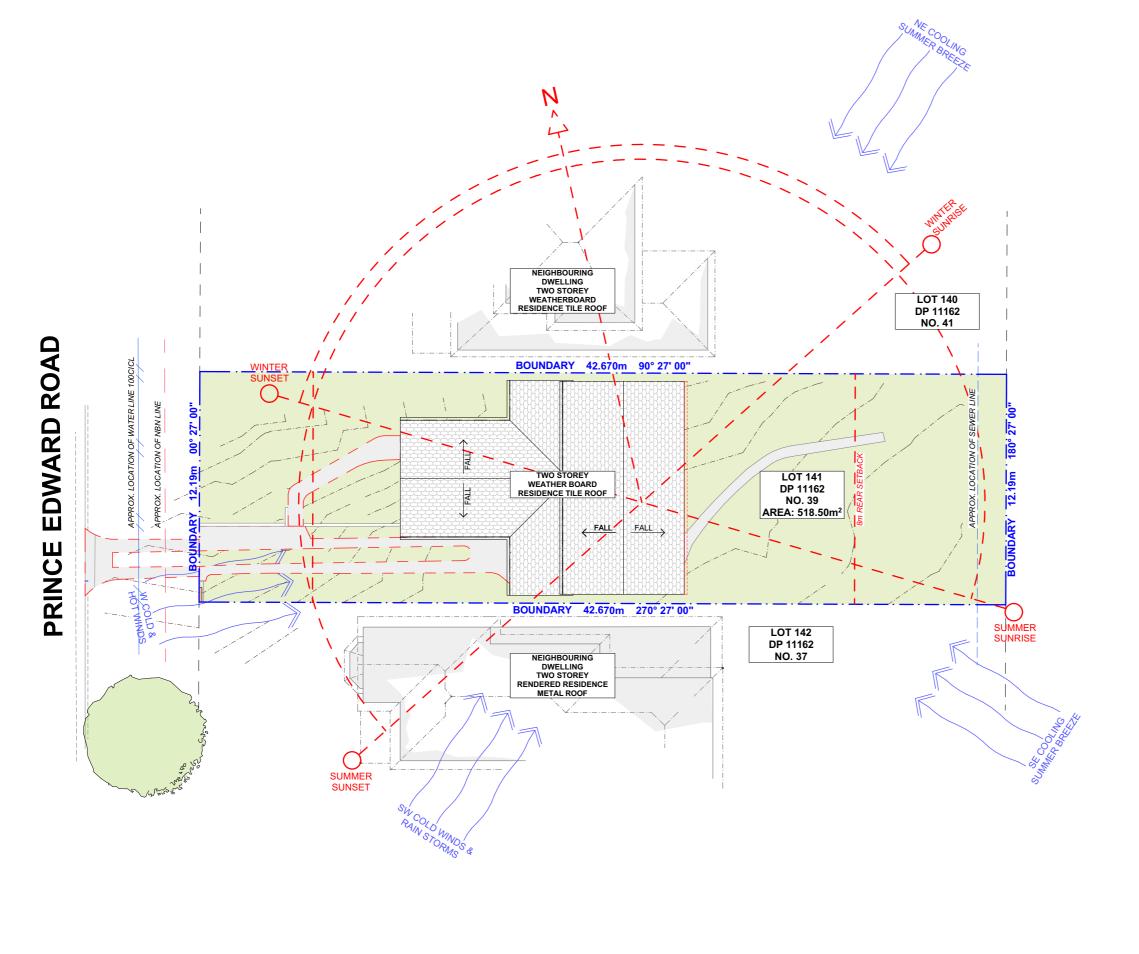

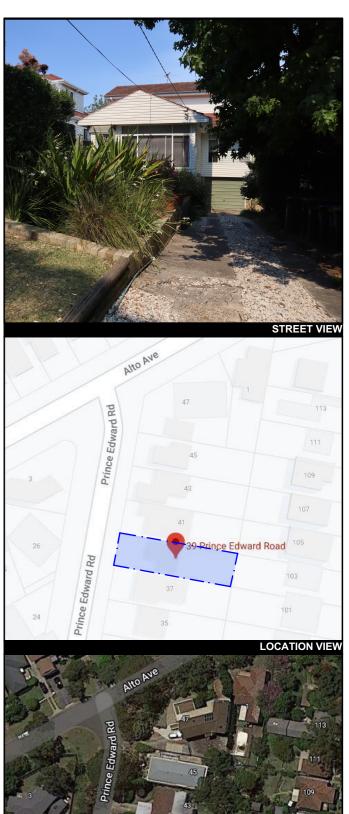


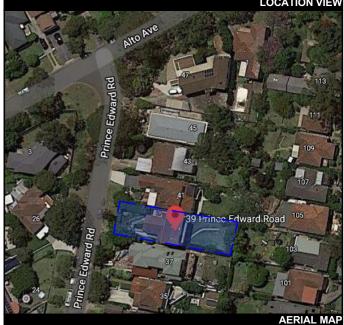

NOTE: ALL DEMOLISHED ELEMENTS TO ENG. SPECIFICATIONS AND AS. 2601 - 2001



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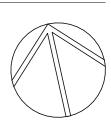


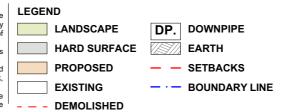
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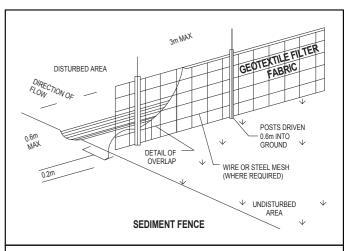
PROJECT ADDRESS 39 PRINCE EDWARD ROAD, SEAFORTH NSW 2092

DRAWING NO. S4.55-02

DATE Friday, 23 July 2021 DRAWING NAME SITE ANALYSIS





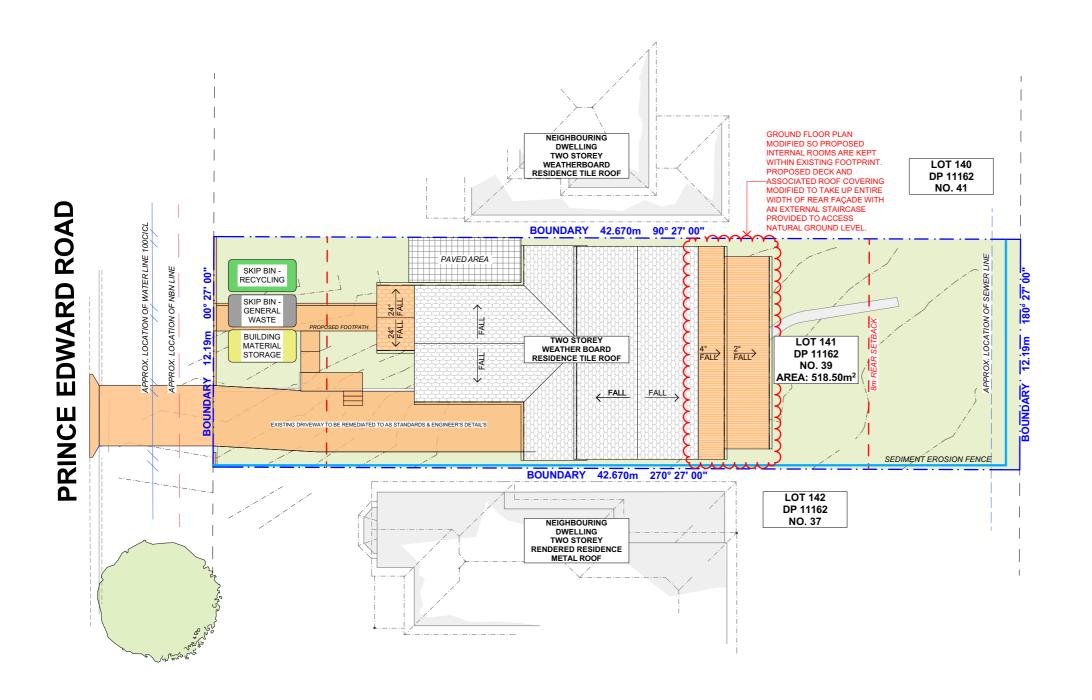

DUST CONTROL:

TO REDUCE DUST GENERATED BY WIND ACTION, THE REMOVAL OF THE TOP SOIL IS TO BE MINIMISED. TO PREVENT DUST GENERATION, WATERING DOWN OF THE SITE, ESPECIALLY DURING THE MOVEMENT OF MACHINERY IS REQUIRED. WHERE EXCAVATING INTO ROCK, KEEP THE SURFACE MOIST TO MINIMISE DUST. CONSTRUCT A GRAVEL ENTRY/EXIT POINT USING BLUE METAL AND RESTRICT ALL VEHICLE MOVEMENTS WITHIN THE SITE TO A MINIMUM. ENSURE WIND BREAKS, SUCH AS EXISTING FENCES ARE MAINTAINED DURING THE CONSTRUCTION PHASE UNTIL NEW LANDSCAPING IS PROVIDED OR REINSTATED. PREVENT DUST BY COVERING STOCKPILES

SEDIMENT NOTE:

- 1. ALL EROSION AND SEDIMENT CONTROL MEASURES TO BE INSPECTED AND MAINTAINED DAILY BY THE SITE MANAGER.
- 2. MINIMISE DISTURBED AREAS, REMOVE EXCESS SOIL FROM EXCAVATEDAREA AS SOON AS POSSIBLE.
 3. ALL MATERIAL STOCKPILE TO BE CLEAR FROM DRAINS, GUTTERS AND FOOTPATHS, OR WITHIN SEDIMENT FENCE AREA.
- 4. DRAINAGE TO BE CONNECTED TO STORMWATER AS SOON AS POSSIBLE. IF STORED ON SITE, IT MUST BE FILTERED BEFORE RELEASING INTO STORMWATER SYSTEM OR WATERWAYS.
- 5. ROADS AND FOOTPATHS TO BE SWEPT DAILY.

STOCKPILES:

ALL STOCKPILES ARE TO BE KEPT ON-SITE WHERE POSSIBLE. ANY MATERIALS PLACED ON THE FOOTPATHS OR NATURE STRIPS REQUIRE COUNCIL'S PERMISSION.

ALL STOCKPILES ARE TO BE PLACED AWAY FROM THE DRAINAGE LINES AND STREET GUTTERS. IT IS BEST TO LOCATE THESE ON THE HIGHEST PART OF THE SITE IF POSSIBLE. PLACE WATERPROOF COVERING OVER STOCKPILES.

IF REQUIRED PROVIDE DIVERSION DRAIN & BANK AROUND STOCKPILES.


GUTTER PROTECTION:

PROVIDE PROTECTION TO DOWNHILL GRATE IN GUTTER BY MEANS OF SAND BAGS OR BLUE METAL WRAPPED IN GEOTEXTILE FABRIC. WHEN SOIL OR SAND BUILDS UP AROUND THIS SEDIMENT BARRIER, THE MATERIAL SHOULD BE RELOCATED BACK TO THE SITE FOR DISPOSAL.

NOTE: ALL PROPOSED STORMWATER TO CONNECT WITH EXISTING



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S4.55-03
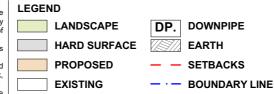
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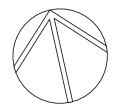
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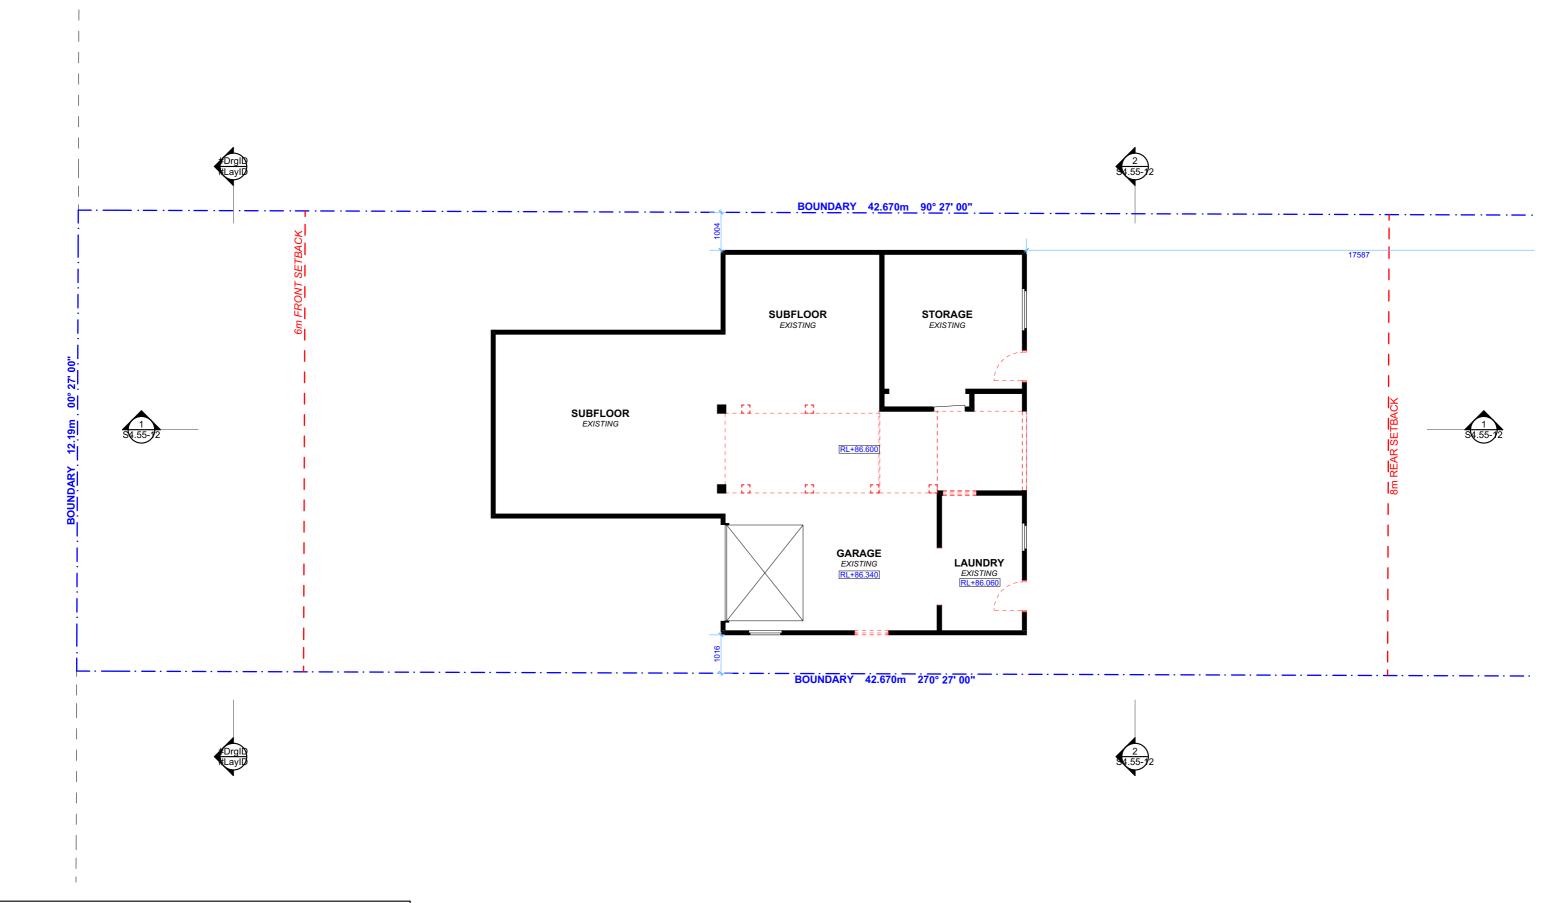
SITE / ROOF / SEDIMENT

FROSION / WASTE

EROSION / WASTE
MANAGEMENT / STORMWATER
CONCEPT PLAN
SCALE







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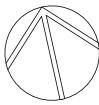
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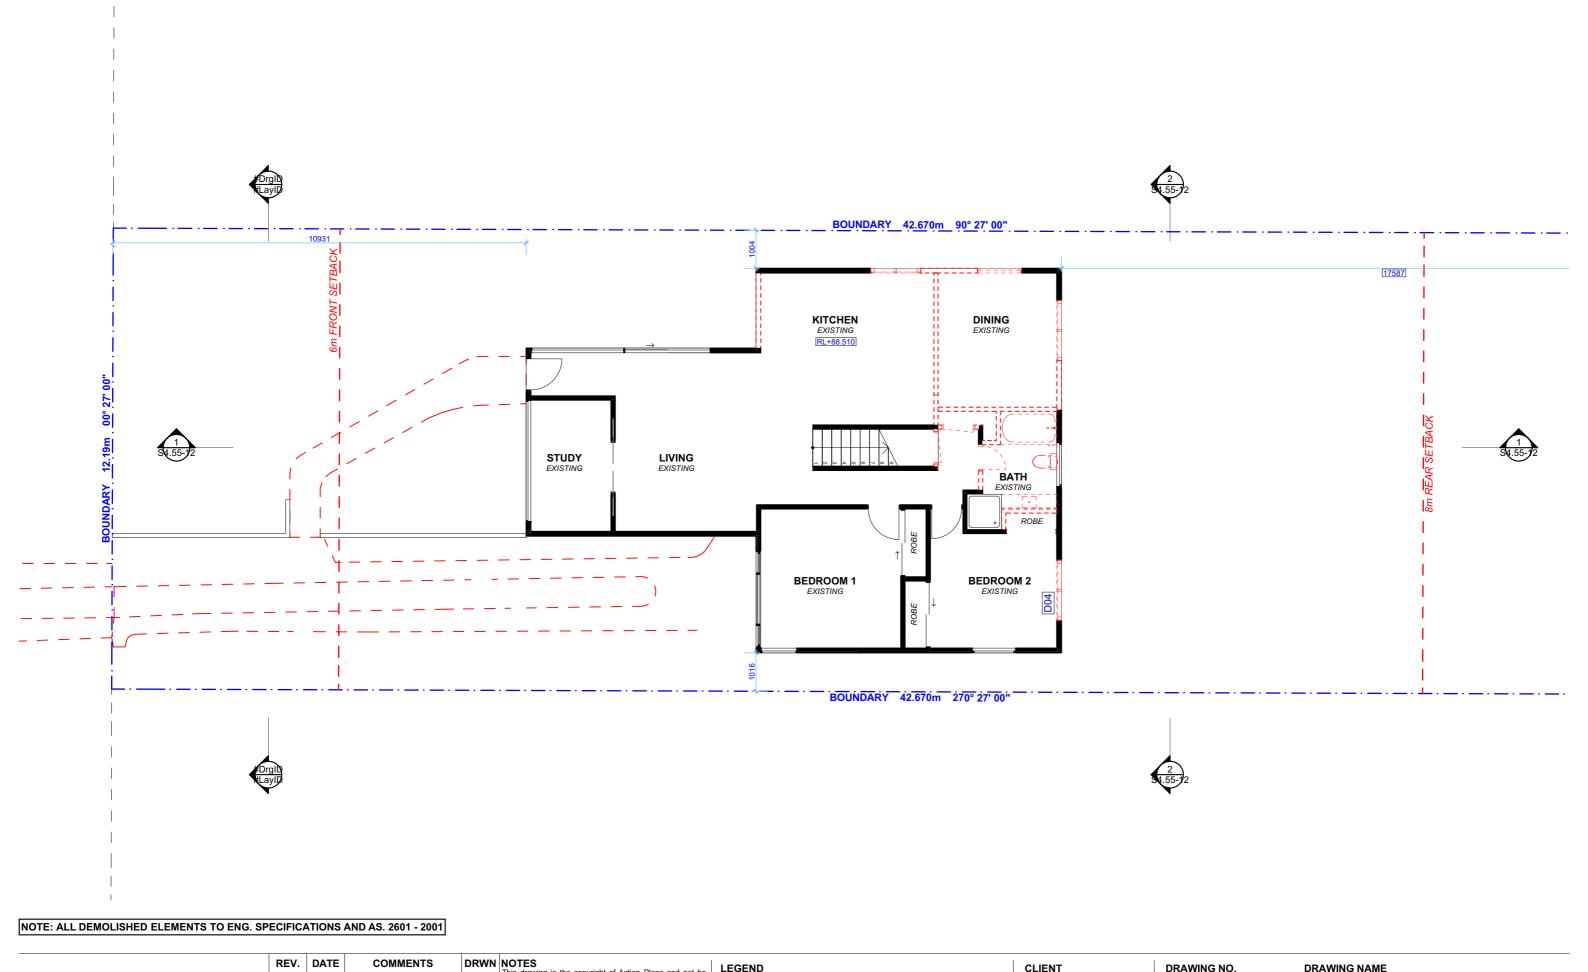
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EXISTING GARAGE FLOOR PLAN

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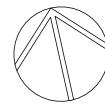
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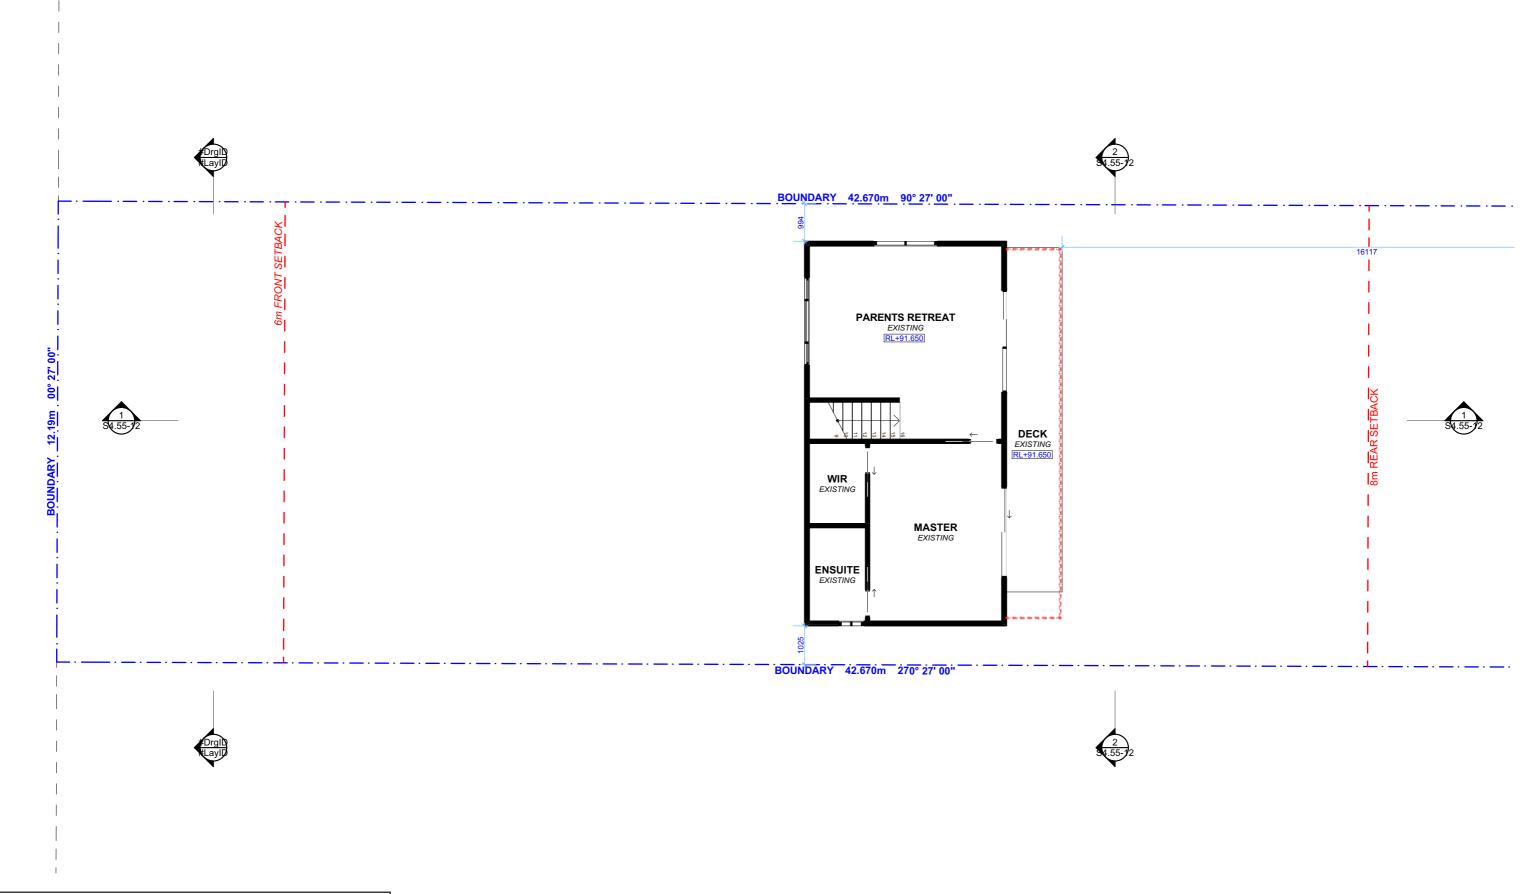
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EXISTING GROUND FLOOR PLAN





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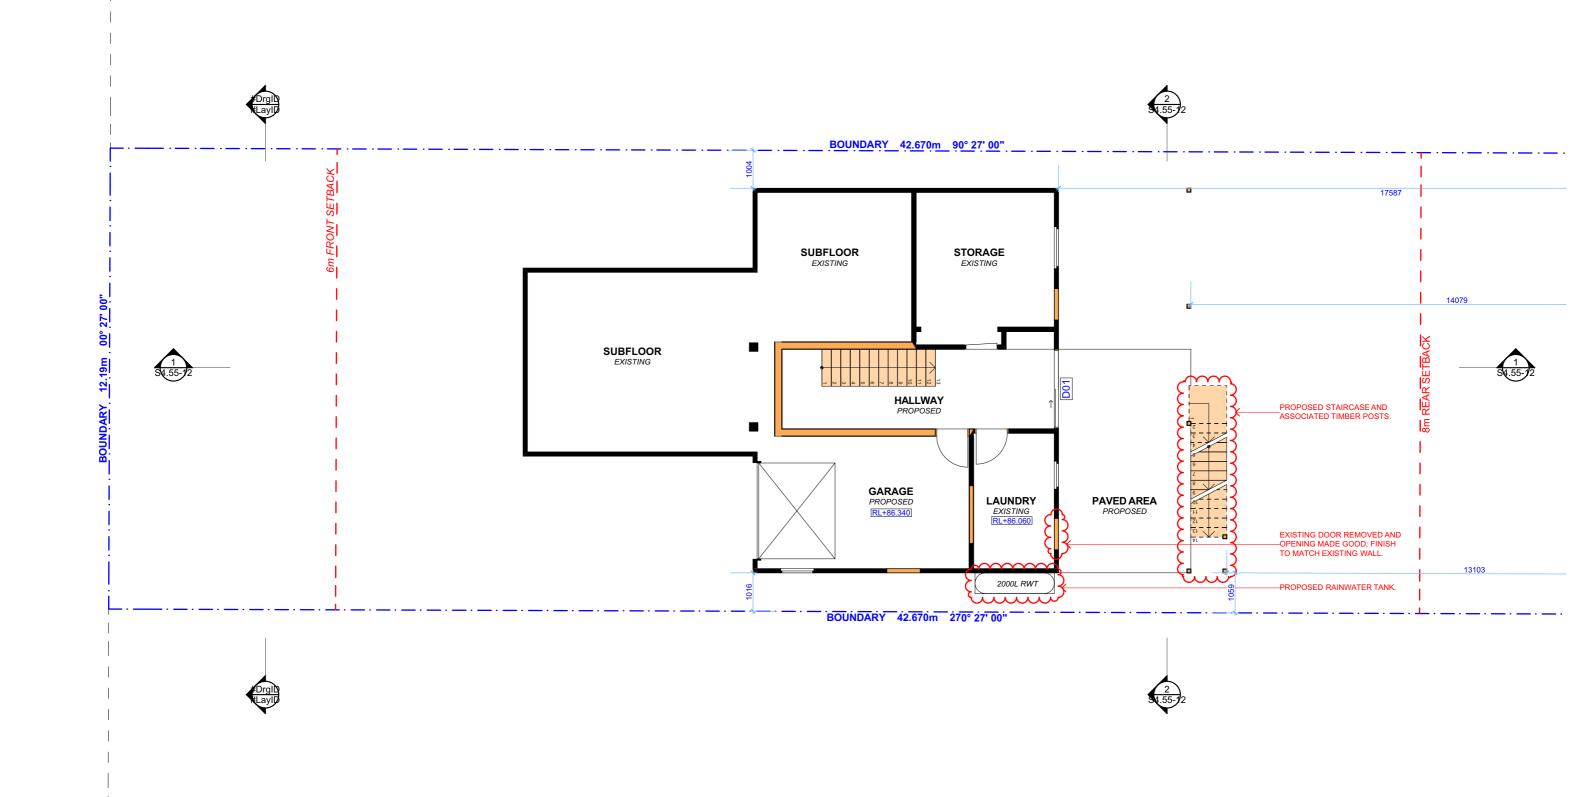
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EXISTING FIRST FLOOR PLAN







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EXISTING

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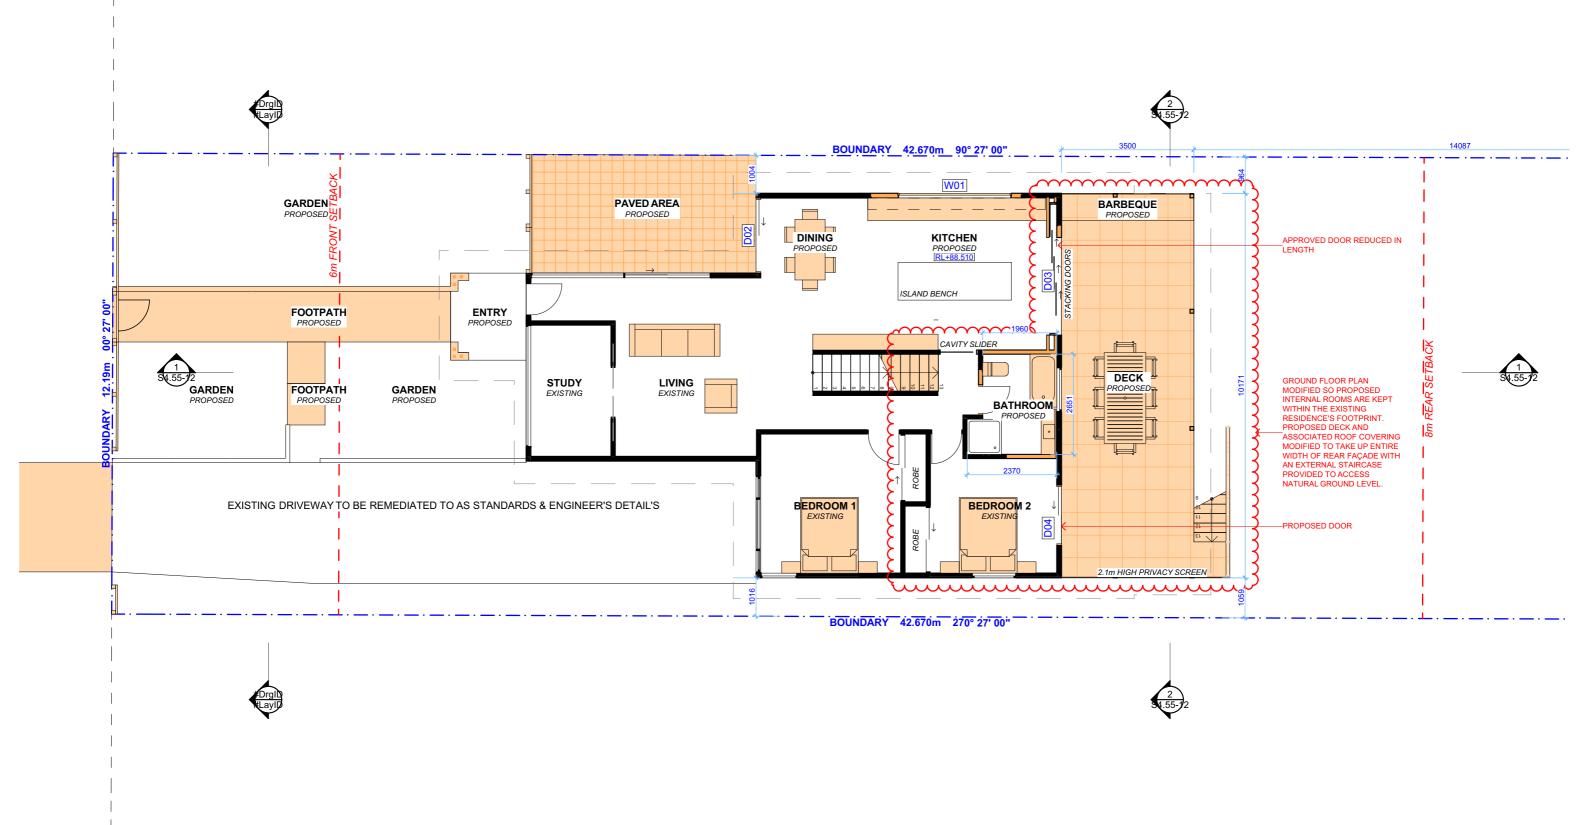
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DRAWING NAME

PROPOSED GARAGE FLOOR PLAN





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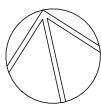
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DRAWING NAME

PROPOSED GROUND FLOOR

PLAN





NO PROPOSED MODFICATION TO APPROVED FIRST FLOOR PLAN



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					commencement of works.	

DRWN NOTES

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CLIENT

CHRIS & SUSIE McCALL

PROJECT ADDRESS

39 PRINCE EDWARD ROAD, SEAFORTH NSW 2092

DRAWING NO.


S4.55-09


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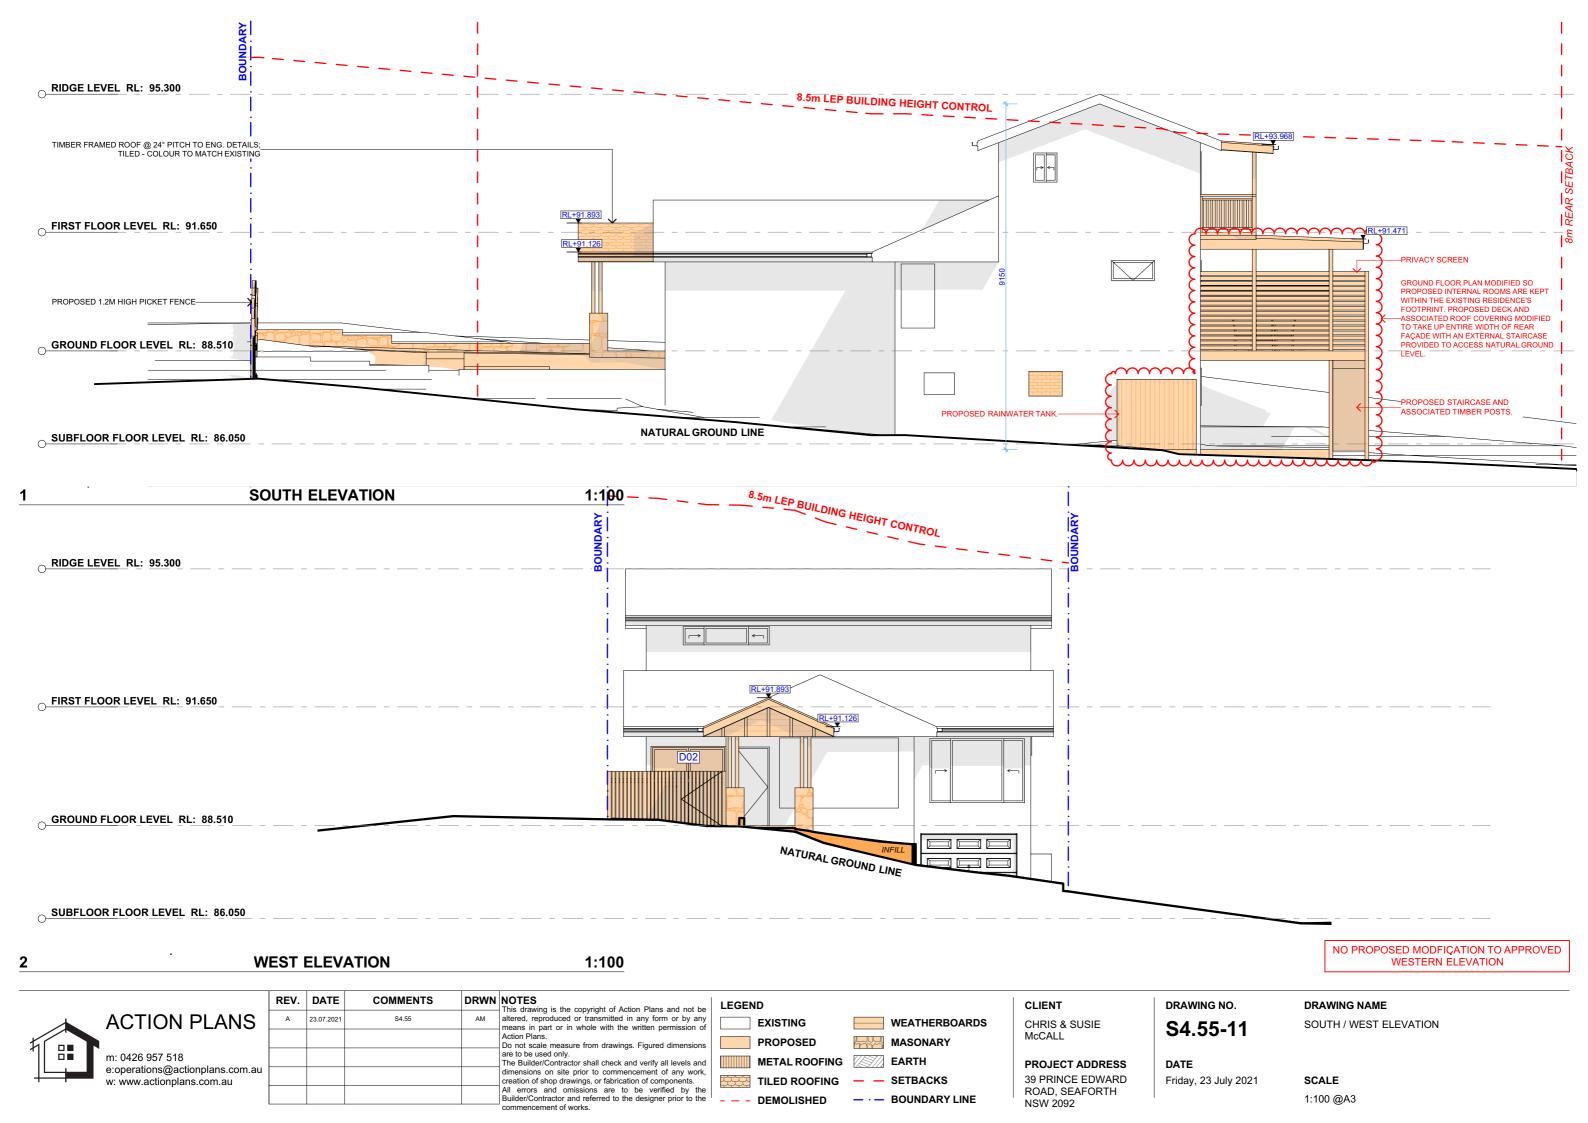
Friday, 23 July 2021


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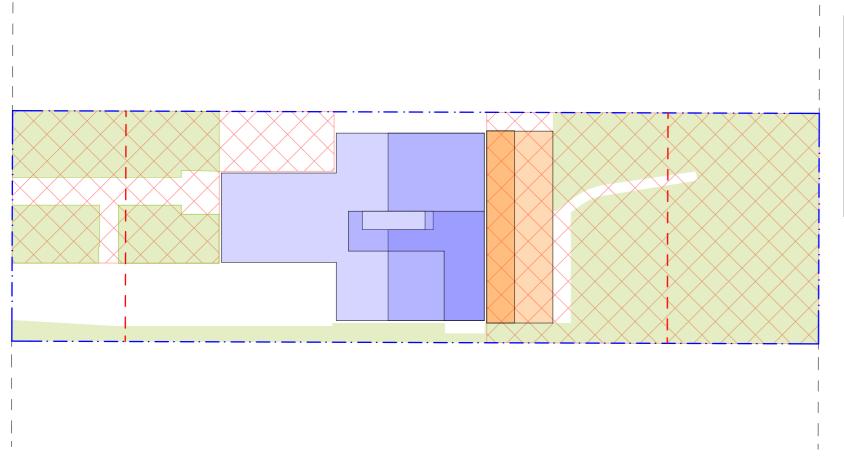
PROPOSED FIRST FLOOR PLAN





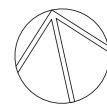

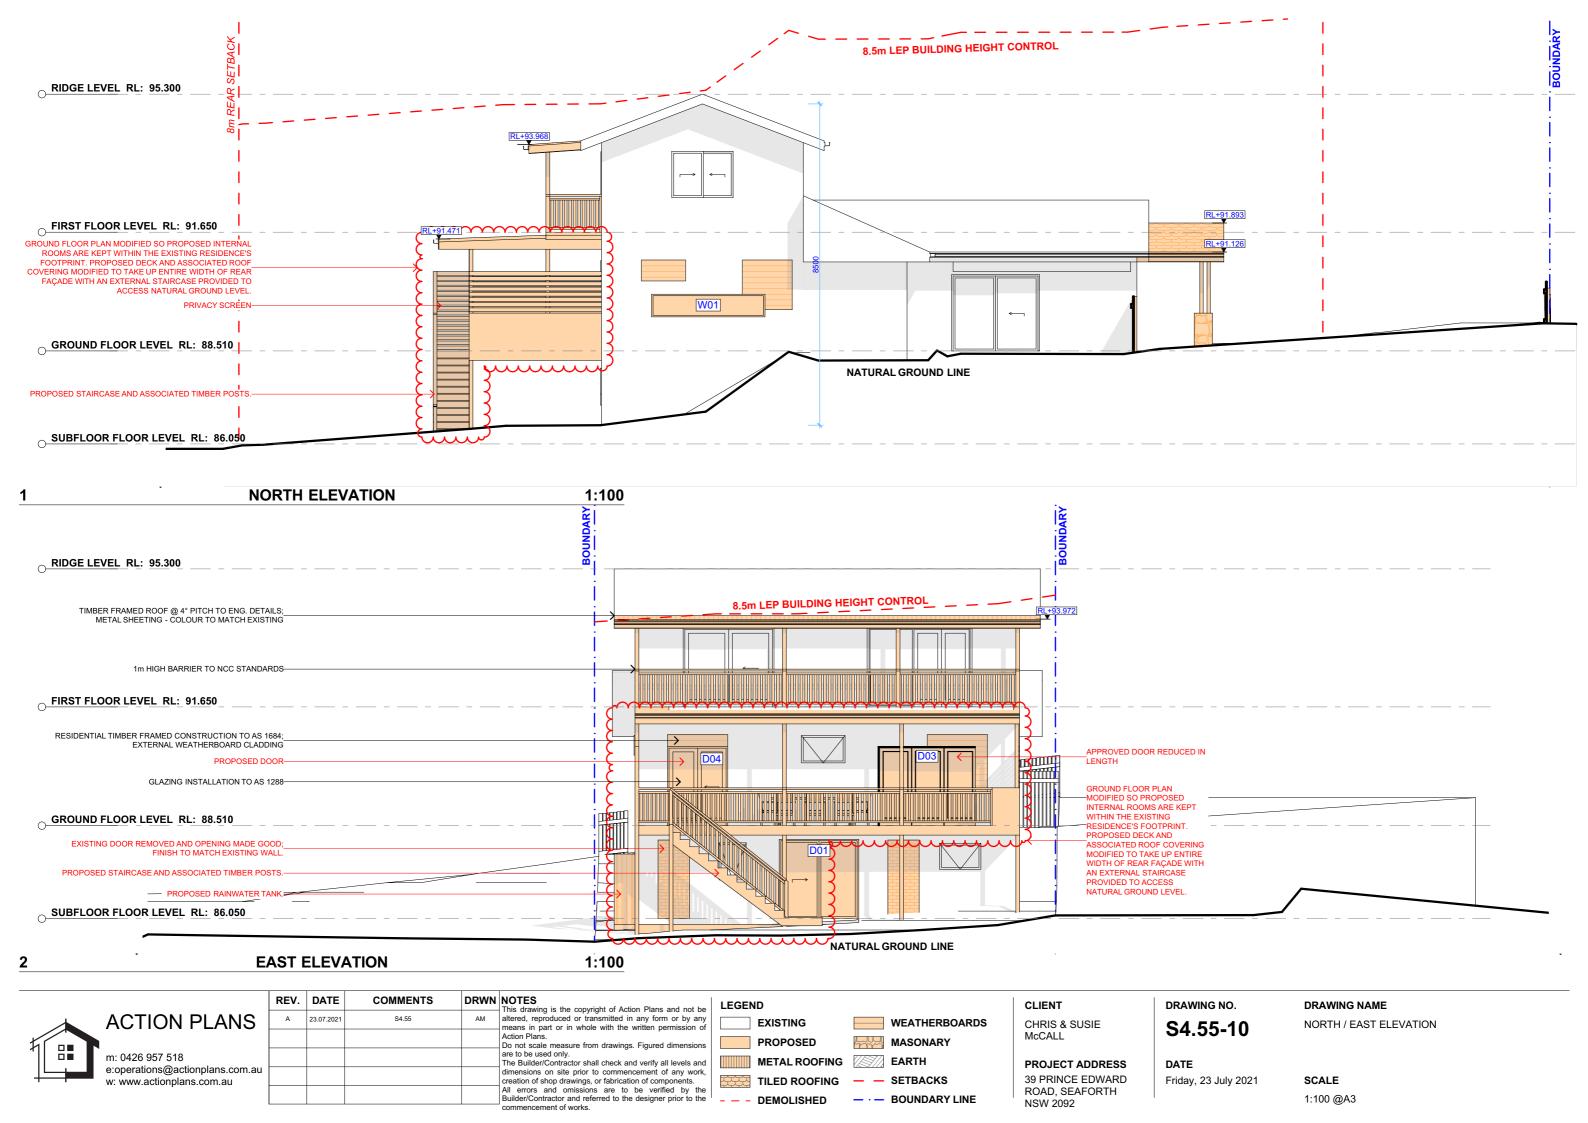

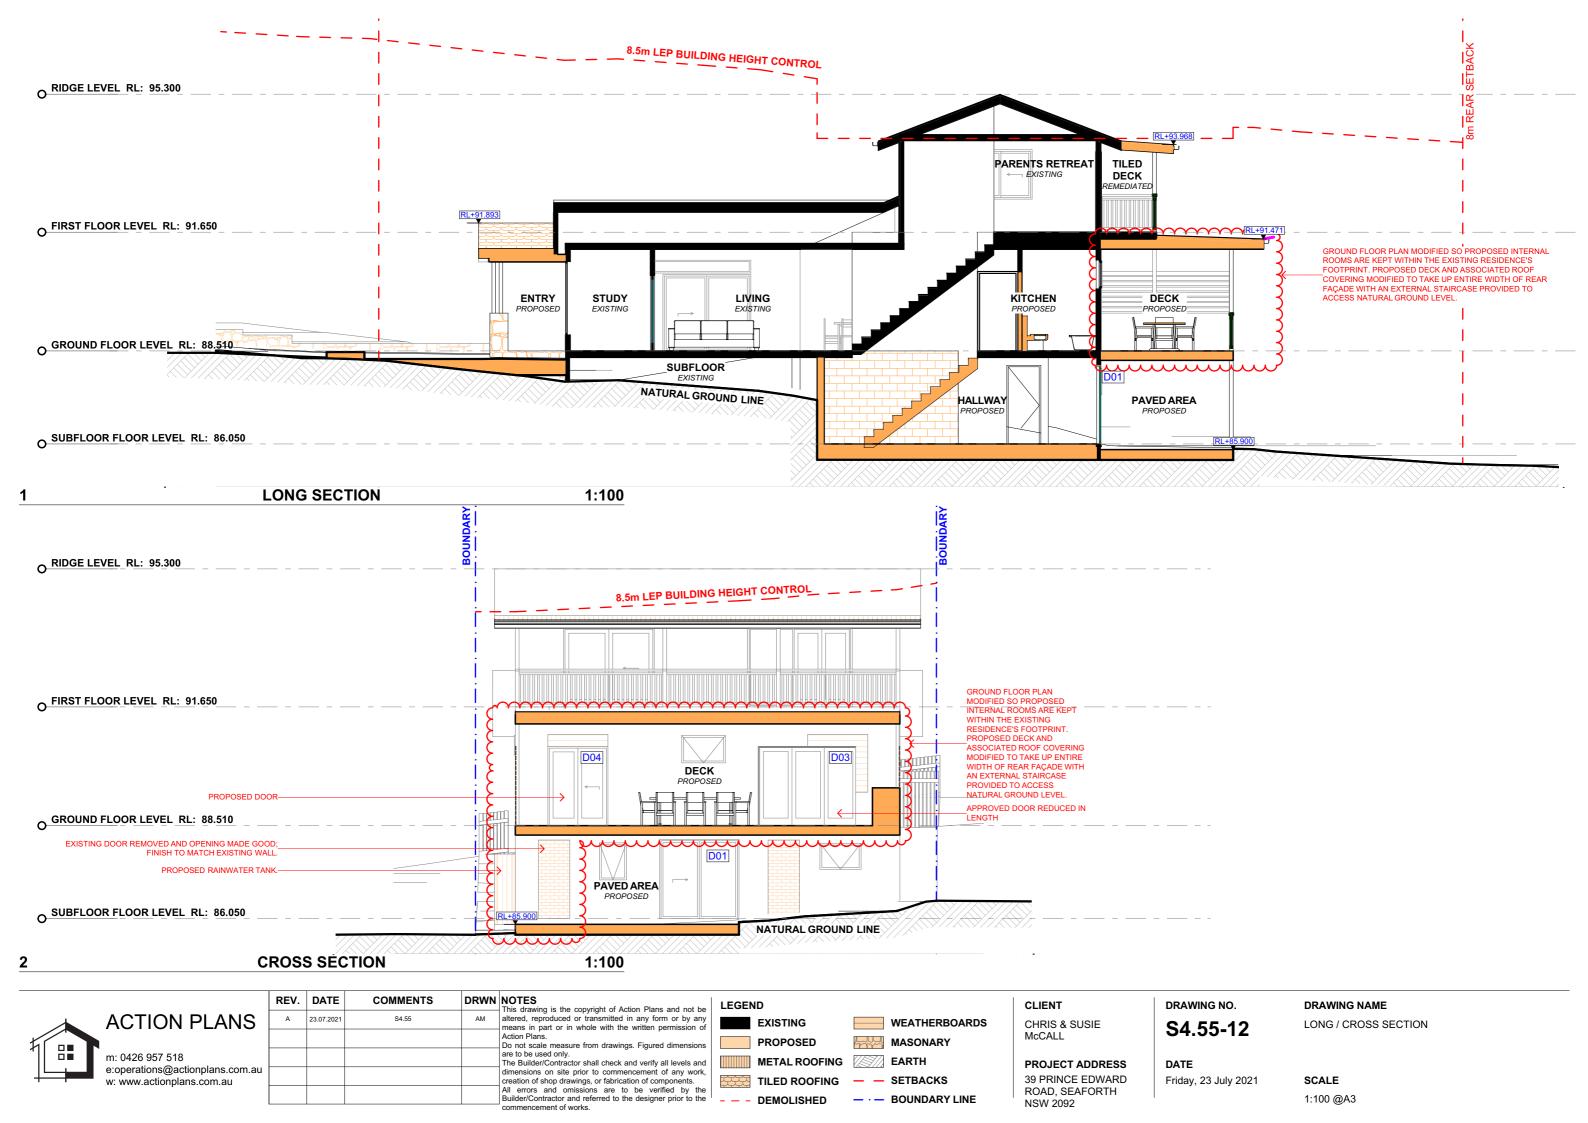

SITE AREA	518.50m ²			
FRONTAGE	12.19m			
CONTROLS	PERMISSIBLE / REQUIRED	EXISTING	PROPOSED	COMPLIANCE
CONTROLS	m / m² / %	m / m² / %	m / m² / %	
MINIMUM LOT SIZE	500m²	518.50m ²	UNCHANGED	YES
FLOOR SPACE RATIO	0:45 : 1 (233.325m²)	0.31 : 1 (162.96m²)	0.34 : 1 (174.28m²)	YES
DCP				
RESIDENTIAL OPEN SPACE	AREA OS3			
TOTAL OPEN SPACE (TOS)	55% (285.175m²)	320.98m² (62)	UNCHANGED	YES
LANDSCAPE AREA	35% OF TOS (55%) : 99.81m ²	315.04m ²	259.01m ²	YES
OPEN SPACE ABOVE GROUND	MAX. 40% OF TOS (55%) : 114.07m ²	13.40m ²	50.47m ²	YES
PRINCIPAL PRIVATE OPEN SPACE	18m²	0m²	54.2m ²	YES

PROPOSED AREA CALCULATIONS

1:200

MT-01 COLOURBOND METAL ROOF SHEETING POWDERCOAT FINISH 'IRONSTONE' OR SIMILAR WHERE MARKED ON ELEVATION.

ALUMINIUM SLIDING DOOR FRAME POWDERCOAT FINISH 'BLACK' OR SIMILAR WHERE MARKED ON ELEVATION.

WHERE MARKED ON ELEVATION.

POWDERCOAT FINISH 'BLACK' OR SIMILAR

ALUMINIUM WINDOW FRAME

SAMPLE BOARD

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ı					The Builder/Contractor shall check and verify all levels dimensions on site prior to commencement of any vereation of shop drawings, or fabrication of components
					All errors and omissions are to be verified Builder/Contractor and referred to the designer prior commencement of works.




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McCALL	04.55-15
PROJECT ADDRESS 39 PRINCE EDWARD ROAD, SEAFORTH NSW 2092	DATE Friday, 23 July 2021

DRAWING NO. DRAWING NAME AREA CALCULATIONS / SAMPLE BOARD S4.55-13


SCALE

1:200, 1:1 @A3



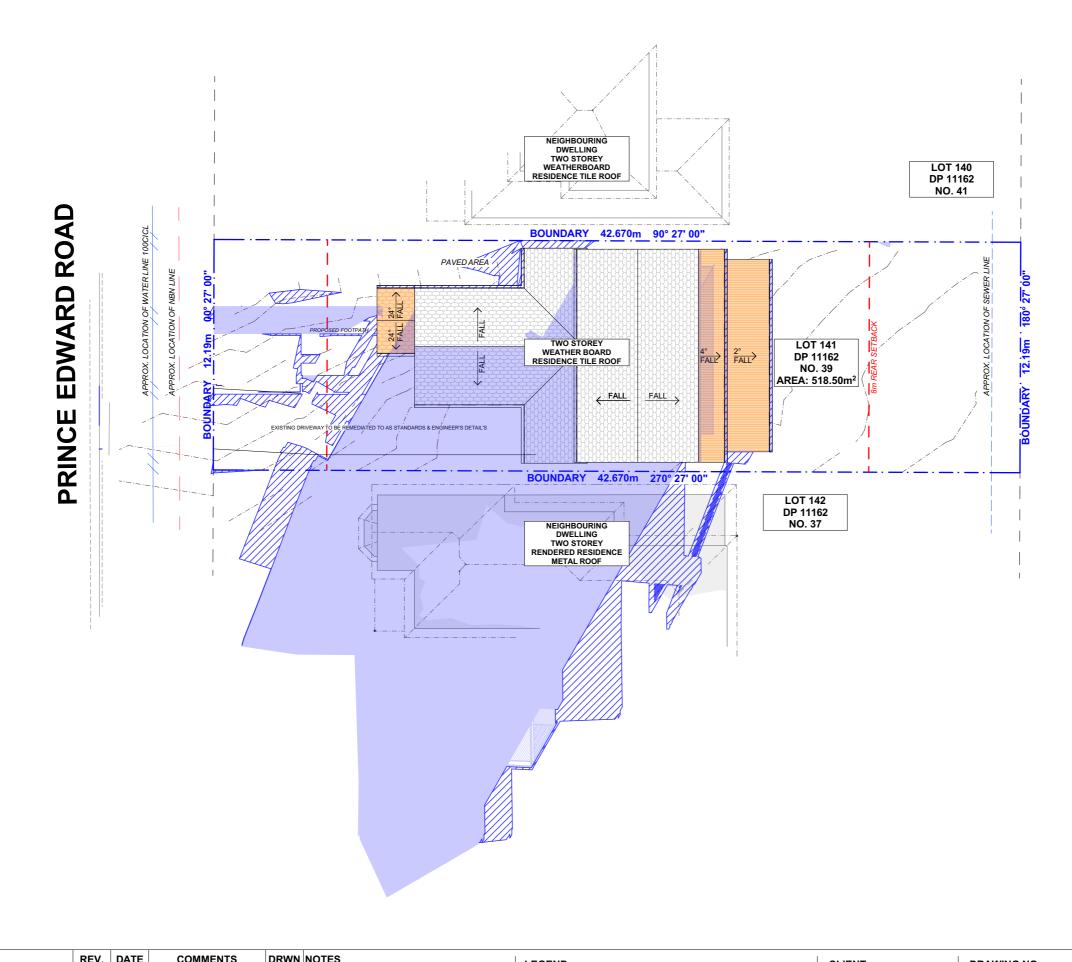

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				are to be used only. The Builder/Contractor shall check and verify all levels and	
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				All errors and omissions are to be verified by the Builder/Contractor and referred to the designer prior to the	

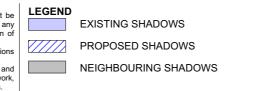

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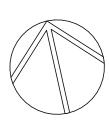
PROJECT ADDRESS 39 PRINCE EDWARD ROAD, SEAFORTH NSW 2092 DRAWING NO.


S4.55-14

DATEFriday, 23 July 2021

DRAWING NAME
WINTER SOLSTICE 9 AM

21 **SCALE** 1:200 @A3



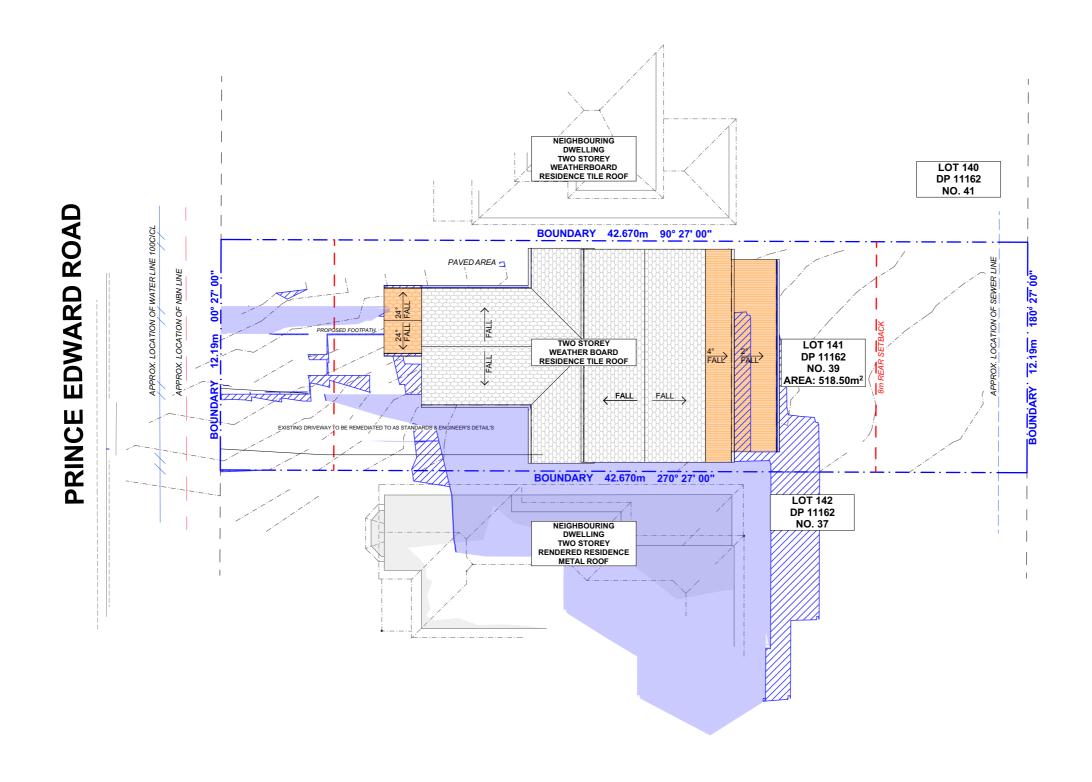



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					Action Plans. Do not scale measure from drawings. Figured dimensions are to be used only. The Builder/Contractor shall check and verify all levels and	
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					commencement of works.	



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39 PRINCE EDWARD)
ROAD, SEAFORTH	
NSW 2092	

S4.55-15 DATE


Friday, 23 July 2021


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5-15 WINTER SOLSTICE 12 PM

SCALE 1:200 @A3


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	•			commencement of works.	

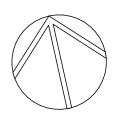

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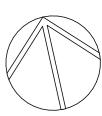
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4.55-10

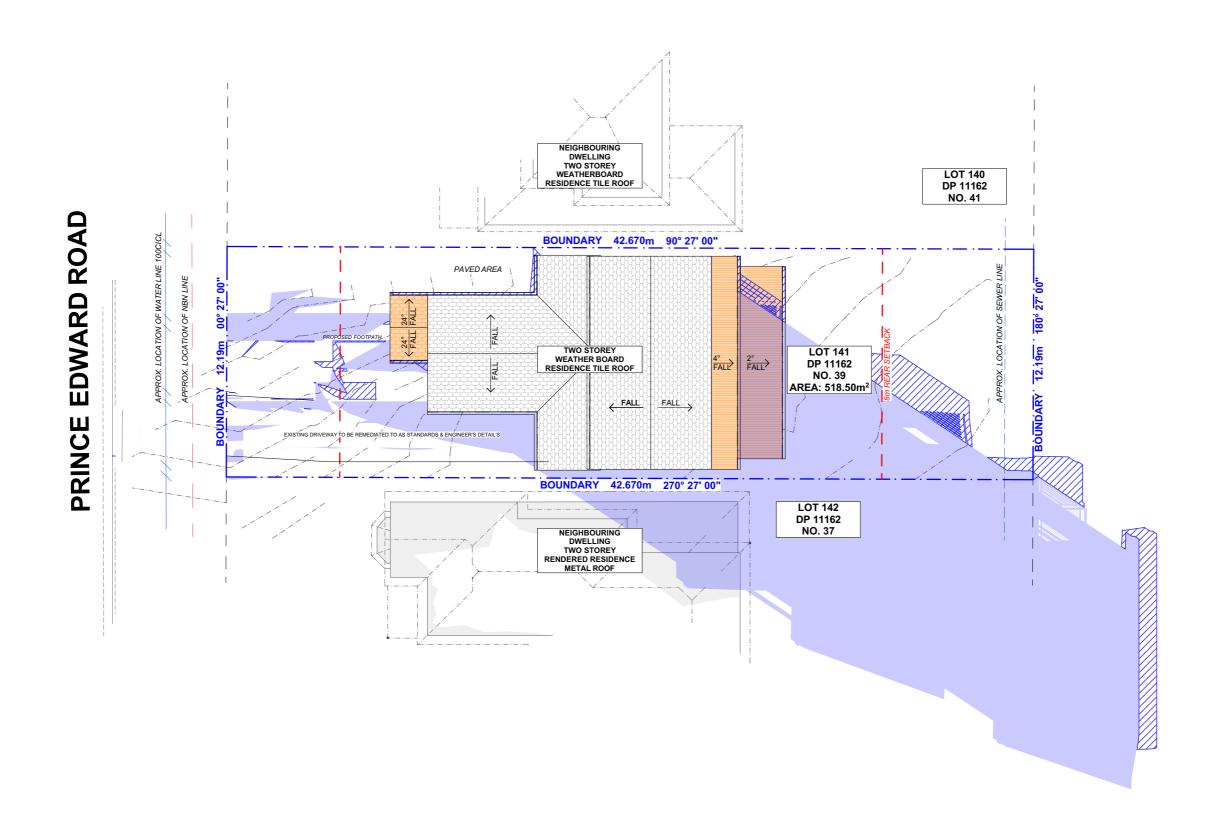DATEFriday, 23 July 2021

WINTER SOLSTICE 3 PM

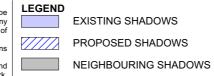DRAWING NAME





BASIX Certificate

Building Sustainability Index www.basix.nsw.gov.au

Alterations and Additions

Certificate number: A373780_03

This certificate confirms that the proposed development will meet the NSW government's requirements for sustainability, if it is built in accordance with the commitments set out below. Terms used in this certificate, or in the commitments, have the meaning given by the document entitled "BASIX Alterations and Additions Definitions" dated 06/10/2017 published by the Department. This document is available at www.basix.nsw.gov.au

Secretary
Date of issue: Thursday, 08, July 2021
To be valid, this certificate must be lodged within 3 months of the date of issue.



Project address	
Project name	39 PRINCE EDWARD ROAD, SEAFORTH_03
Street address	39 PRINCE EDWARD Road SEAFORTH 2092
Local Government Area	Northern Beaches Council
Plan type and number	Deposited Plan 11162
Lot number	141
Section number	
Project type	
Dwelling type	Separate dwelling house
Type of alteration and addition	My renovation work is valued at \$50,000 or morand does not include a pool (and/or spa).

Certificate Prepared by (please complete before submitting to Council or PCA)
Name / Company Name: Action Plans
ABN (if applicable): 17118297587

BASIX Certificate number: A373780_03 page 2 / 6

Fixtures and systems	Show on DA Plans	Show on CC/CDC Plans & specs	Certifier Check
Lighting			
The applicant must ensure a minimum of 40% of new or altered light fixtures are fitted with fluorescent, compact fluorescent, or light-emitting-diode (LED) lamps.		✓	~
Fixtures	'	'	'
The applicant must ensure new or altered showerheads have a flow rate no greater than 9 litres per minute or a 3 star water rating.		✓	✓
The applicant must ensure new or altered toilets have a flow rate no greater than 4 litres per average flush or a minimum 3 star water rating.		✓	✓
The applicant must ensure new or altered taps have a flow rate no greater than 9 litres per minute or minimum 3 star water rating.		✓	

BASIX Certificate number: A373780_03 page 3 / 6

Construction			Show on DA Plans	Show on CC/CDC Plans & specs	Certifier Check
nsulation requirements					
The applicant must construct the new or altered construction (floor(s), walls, and ceilings/roofs) in accordance with the specifications listed in the table below, except that a) additional insulation is not required where the area of new construction is less than 2m2, b) insulation specified is not required for parts of altered construction where insulation already exists.			✓	~	~
is not required for parts of altered construction	where insulation already exists.				
is not required for parts of altered construction Construction	where insulation already exists. Additional insulation required (R-value)	Other specifications			
	,	Other specifications			
Construction	Additional insulation required (R-value)	Other specifications	_		

BASIX Certificate number: A373780_03 page 6 / 6

In these commitments, "applicant" means the person carrying out the development.

Commitments identified with a "\sqrt{"} in the "Show on DA plans" column must be shown on the plans accompanying the development application for the proposed development (if a development application is to be lodged for the proposed development).

Commitments identified with a "\sqrt{"} in the "Show on CC/CDC plans & specs" column must be shown in the plans and specifications accompanying the application for a construction certificate / complying development certificate for the proposed development.

Commitments identified with a "</" in the "Certifier check" column must be certified by a certifying authority as having been fulfilled, before a final occupation certificate for the evelopment may be issued.

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REV.	DATE	COMMENTS	DRWN	NOTES	
А	23.07.2021	S4.55	AM	This drawing is the copyright of Action Plans and not be altered, reproduced or transmitted in any form or by any means in part or in whole with the written permission of Action Plans. Do not scale measure from drawings. Figured dimensions are to be used only.	
				The Builder/Contractor shall check and verify all levels and dimensions on site prior to commencement of any work, creation of shop drawings, or fabrication of components.	
				All errors and omissions are to be verified by the Builder/Contractor and referred to the designer prior to the commencement of works. All window & door dimensions, orientation, glazing materials, opening types, frame types are to be confirmed by a suitably qualified	
				person prior to the ordering of any such materials are to take place. U value takes precedence over glazing type/colour in all cases.	:
				all new glazing must meet the BASIX specified frame and glass type, <u>OR</u> meet the ecified U value and SHGC value.	

BASIX Certificate number: A373780_03

Glazing re	equirements						Show on DA Plans	Show on CC/CDC Plans & specs	Certifier Check
Windows a	and glazed o	doors							
	nt must install ershadowing	~	~	~					
The followin		✓	✓						
Each windown have a U-va		✓	✓						
Each window or glazed door with improved frames, or pyrolytic low-e glass, or clear/air gap/clear glazing, or toned/air gap/clear glazing must have a U-value and a Solar Heat Gain Coefficient (SHGC) no greater than that listed in the table below. Total system U-values and SHGCs must be calculated in accordance with National Fenestration Rating Council (NFRC) conditions. The description is provided for information only. Alternative systems with complying U-value and SHGC may be substituted.								~	✓
For projections described in millimetres, the leading edge of each eave, pergola, verandah, balcony or awning must be no more than 500 mm above the head of the window or glazed door and no more than 2400 mm above the sill.								~	✓
Pergolas with polycarbonate roof or similar translucent material must have a shading coefficient of less than 0.35.								~	✓
	Pergolas with fixed battens must have battens parallel to the window or glazed door above which they are situated, unless the pergola also shades a perpendicular window. The spacing between battens must not be more than 50 mm.								✓
Windows	and glazed	d doors q	lazing r	equiremer	nts				
Window / do	oor Orientatio	on Area of glass inc. frame (m2)	Oversha Height (m)	Distance (m)	Shading device	Frame and glass type			
W01	N	1.8	0	0	eave/verandah/pergola/balcony >=600 mm	standard aluminium, single clear, (or U-value: 7.63, SHGC: 0.75)			
D01	E	4.41	0	0	eave/verandah/pergola/balcony >=900 mm	standard aluminium, single clear, (or U-value: 7.63, SHGC: 0.75)			
D02	W	4.17	0	0	eave/verandah/pergola/balcony >=600 mm	standard aluminium, single pyrolytic low-e, (U-value: 5.7, SHGC: 0.47)			

BASIX Certificate number: A373780_03 page 5 / 6

Glazing requirements								Show on CC/CDC Plans & specs	Certifier Check
Window / door no.	Orientation	Area of glass inc. frame (m2)	Oversha Height (m)	dowing Distance (m)	Shading device	Frame and glass type			
D03	E	5.41	0	0	eave/verandah/pergola/balcony >=900 mm	standard aluminium, single clear, (or U-value: 7.63, SHGC: 0.75)			
D04	E	3.32	0	0	eave/verandah/pergola/balcony >=900 mm	standard aluminium, single clear, (or U-value: 7.63, SHGC: 0.75)			

DRAWING NO.

CHRIS & SUSIE S4.55-17 McCALL

CLIENT

NSW 2092

PROJECT ADDRESS DATE 39 PRINCE EDWARD Friday, 23 July 2021 ROAD, SEAFORTH

DRAWING NAME BASIX COMMITMENTS