

LOCALITY PLAN

DA - DRAWING SCHEDULE:

DA 01: COVER SHEET, LOCALITY AND DRAWING SCHEDULE

DA 02: SITE SURVEY & SITE EVALUATION PLAN, and SITE INFORMATION

DA 03: LANDSCAPE CALCULATION PLAN

DA 04: GROUND FLOOR DEMOLITION PLAN

DA 05: FIRST FLOOR DEMOLITION PLAN

DA 06: PROPOSED GROUND FLOOR PLAN

DA 07: PROPOSED FIRST FLOOR PLAN

DA 08: PROPOSED MEZZANINE FLOOR PLAN

DA 09: ROOF PLAN, CONCEPT DRAINAGE PLAN & TYPICAL SILT FENCE DETAIL


DA 10: NORTH ELEVATION AND SOUTH ELEVATION

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BUILDING DESIGNERS ASSOCIATION OF AUSTRALIA CHARTERED ACCREDITED MEMBER ACCREDITATION No.6120



GM_ ACCREDITED BUILDING DESIGNER No.6120

P.O. Box 4101, North Curl Curl, N.S.W. 2099 Mobile: 0418 662 771 Email: lks1@bigpond.net.au

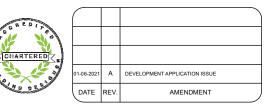Alterations and Additions to an Existing Dwelling

88 QUIRK STREET DEE WHY. N.S.W. 2099 applicant:

Mr. & Mrs. J. & T. Lowry

DA 11:	EAST ELEVATION AND WEST ELEVATION
DA 12:	SECTION S01 & SECTION S03
DA 13:	SECTION S02 & SECTION S04
DA 14:	WINDOW SCHEDULE
DA 15:	DOOR AND SKYLIGHT SCHEDULES
DA 16:	'BASIX' CERTIFICATE A416055 SHTS. 1, 2, & 3
DA 17:	'BASIX' CERTIFICATE A416055 SHTS. 4, 5, & 6.
DA 18:	'BASIX' CERTIFICATE A416055 SHTS. 7, 8, & 9.
DA 19:	WASTE MANAGEMENT & MINIMISE DETAILS &
DA 20:	SHADOW ANALYSIS PLANS 21st JUNE (WINTER
DA 21:	MATERIALS FINISHES SAMPLE SHEET

PROJECT:

PROPOSED ALTERATIONS &

88 QUIRK STREET,

LOT. 4. DP.10683

DEE WHY. N.S.W. 2099

ADDITIONS TO EXISTING DWELLING


DEVELOPMENT APPLICATION

MATERIALS STORAGE R SOLSTICE)


DEVELOPMENT APPLICATION ISSUE

J.& T.Lowry G TITLE: SHEET

PROJECT	REF:2101 DA01	Rev. A
DRAWN:	L.K.S.	
SCALE:	As Shown	
DATE:	1st June, 2021	

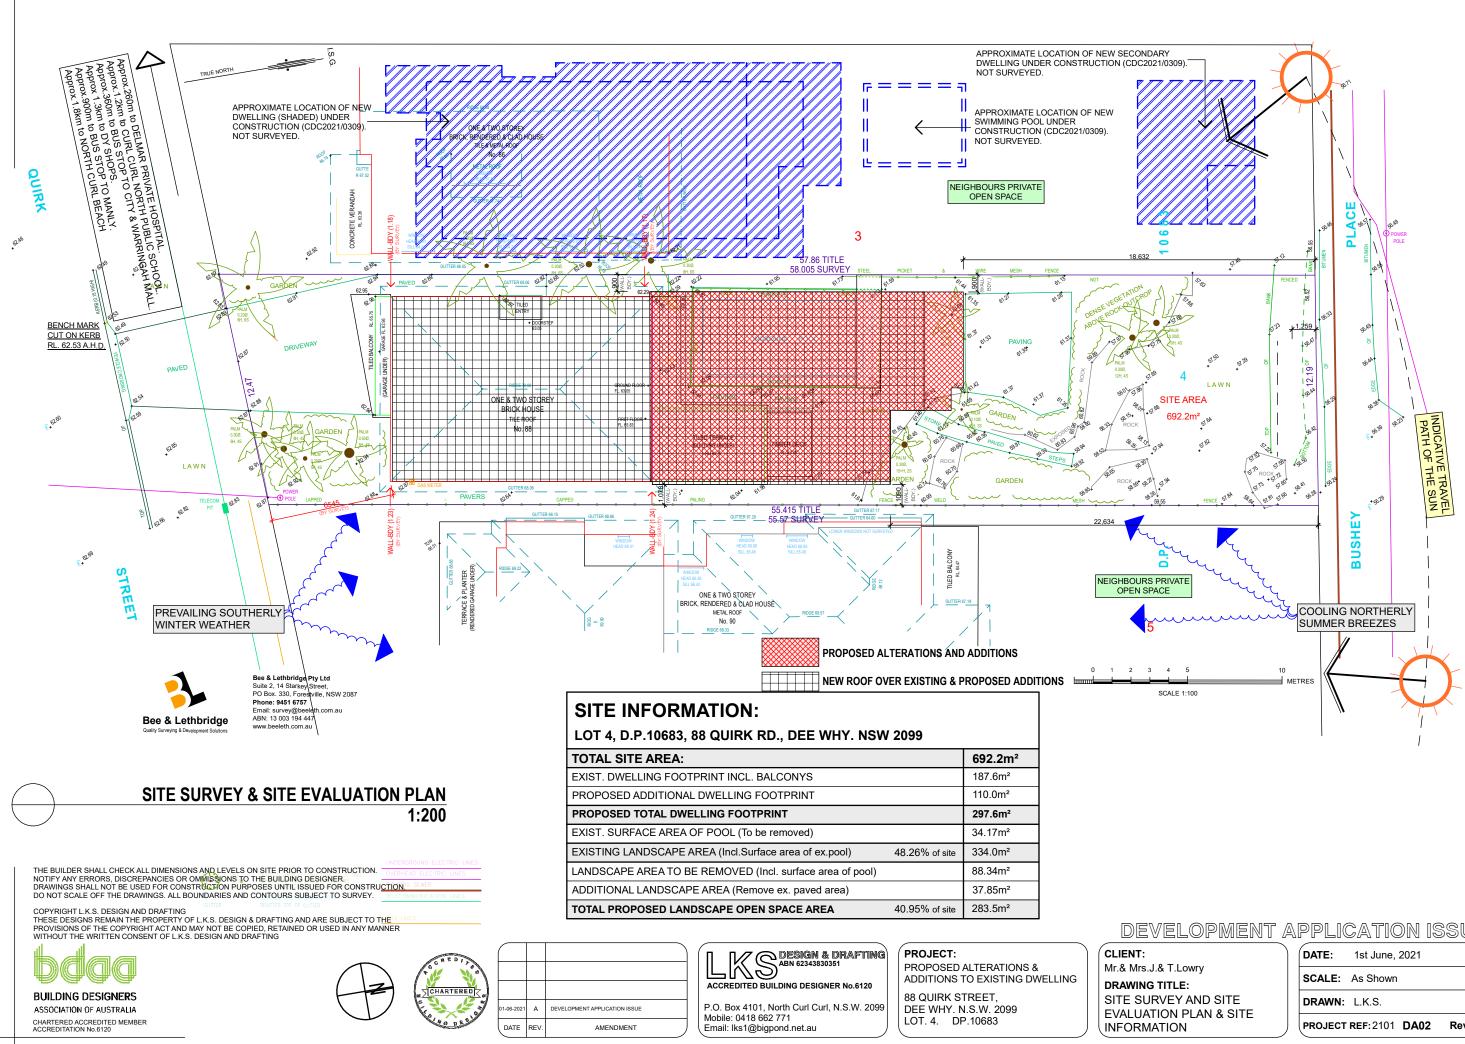

VELOPMEN I A	Application issue
	DATE: 1st June, 2021
J.& T.Lowry G TITLE:	SCALE: As Shown
RVEY AND SITE TION PLAN & SITE	DRAWN: L.K.S.
IATION	PROJECT REF: 2101 DA02 Rev. A

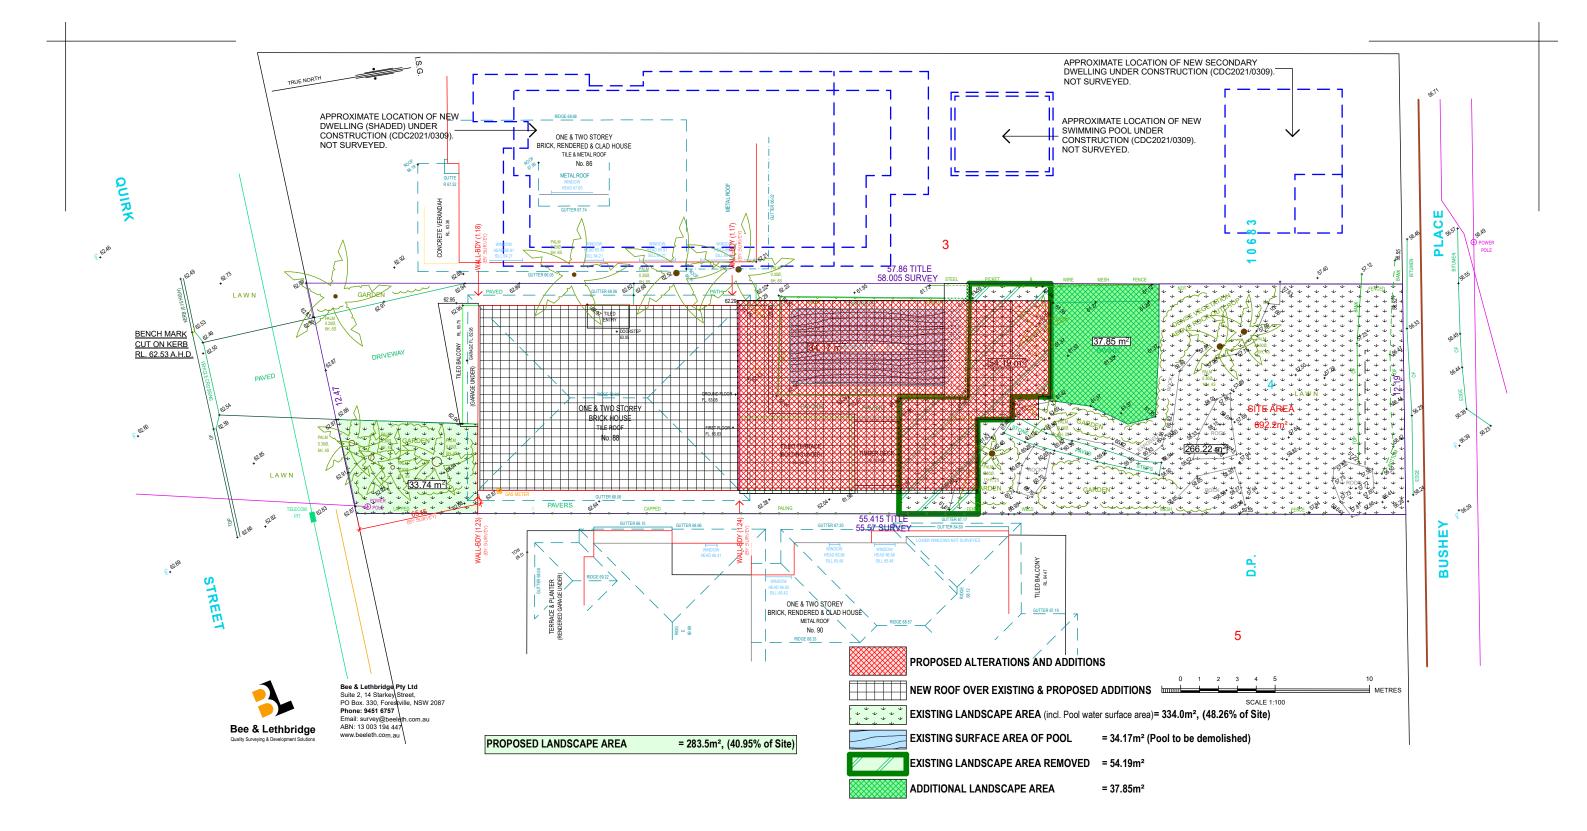

LANDSCAPE PLAN


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DESIGN & DRAFTING ABN 62343830351 ACCREDITED BUILDING DESIGNER No.6120

PROJECT:

PROPOSED ALTERATIONS &

88 QUIRK STREET,

LOT. 4. DP.10683

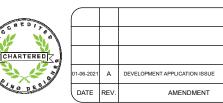DEE WHY. N.S.W. 2099


ADDITIONS TO EXISTING DWELLING


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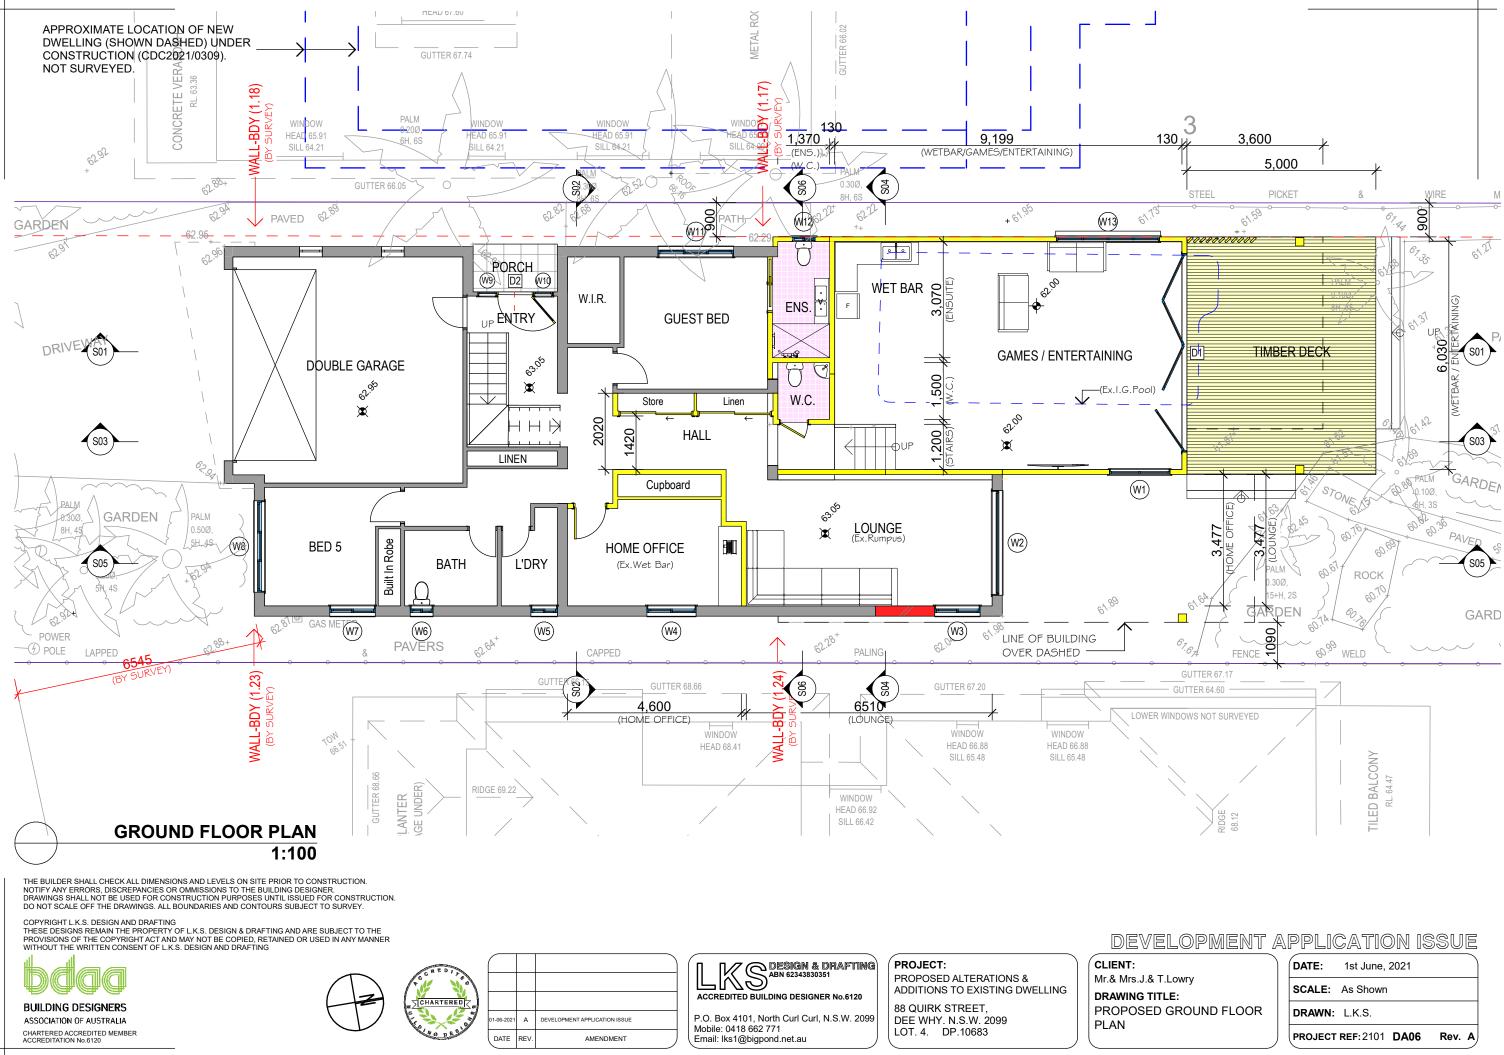
DEVELOPMENT APPLICATION ISSUE


Mr.& Mr DRAWI LANDS PLAN


Г: .	DATE: 1st June, 2021
rs.J.& T.Lowry NG TITLE:	SCALE: As Shown
SCAPE CALCULATION	DRAWN: L.K.S.
	PROJECT REF: 2101 DA03 Rev. A



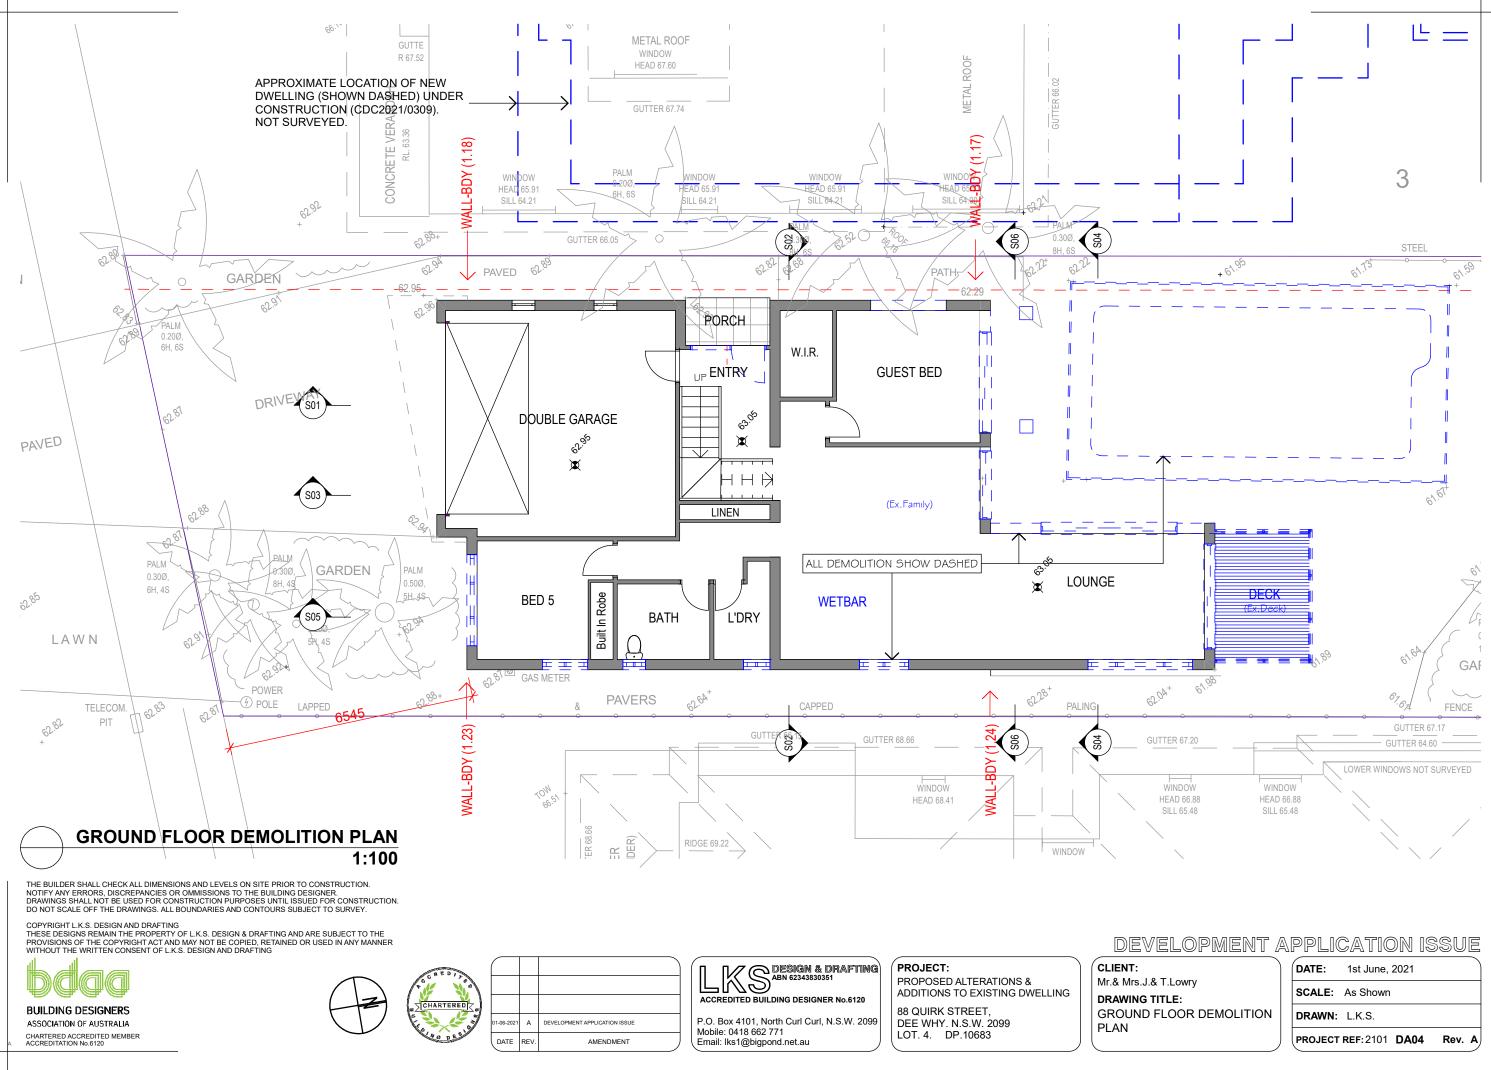

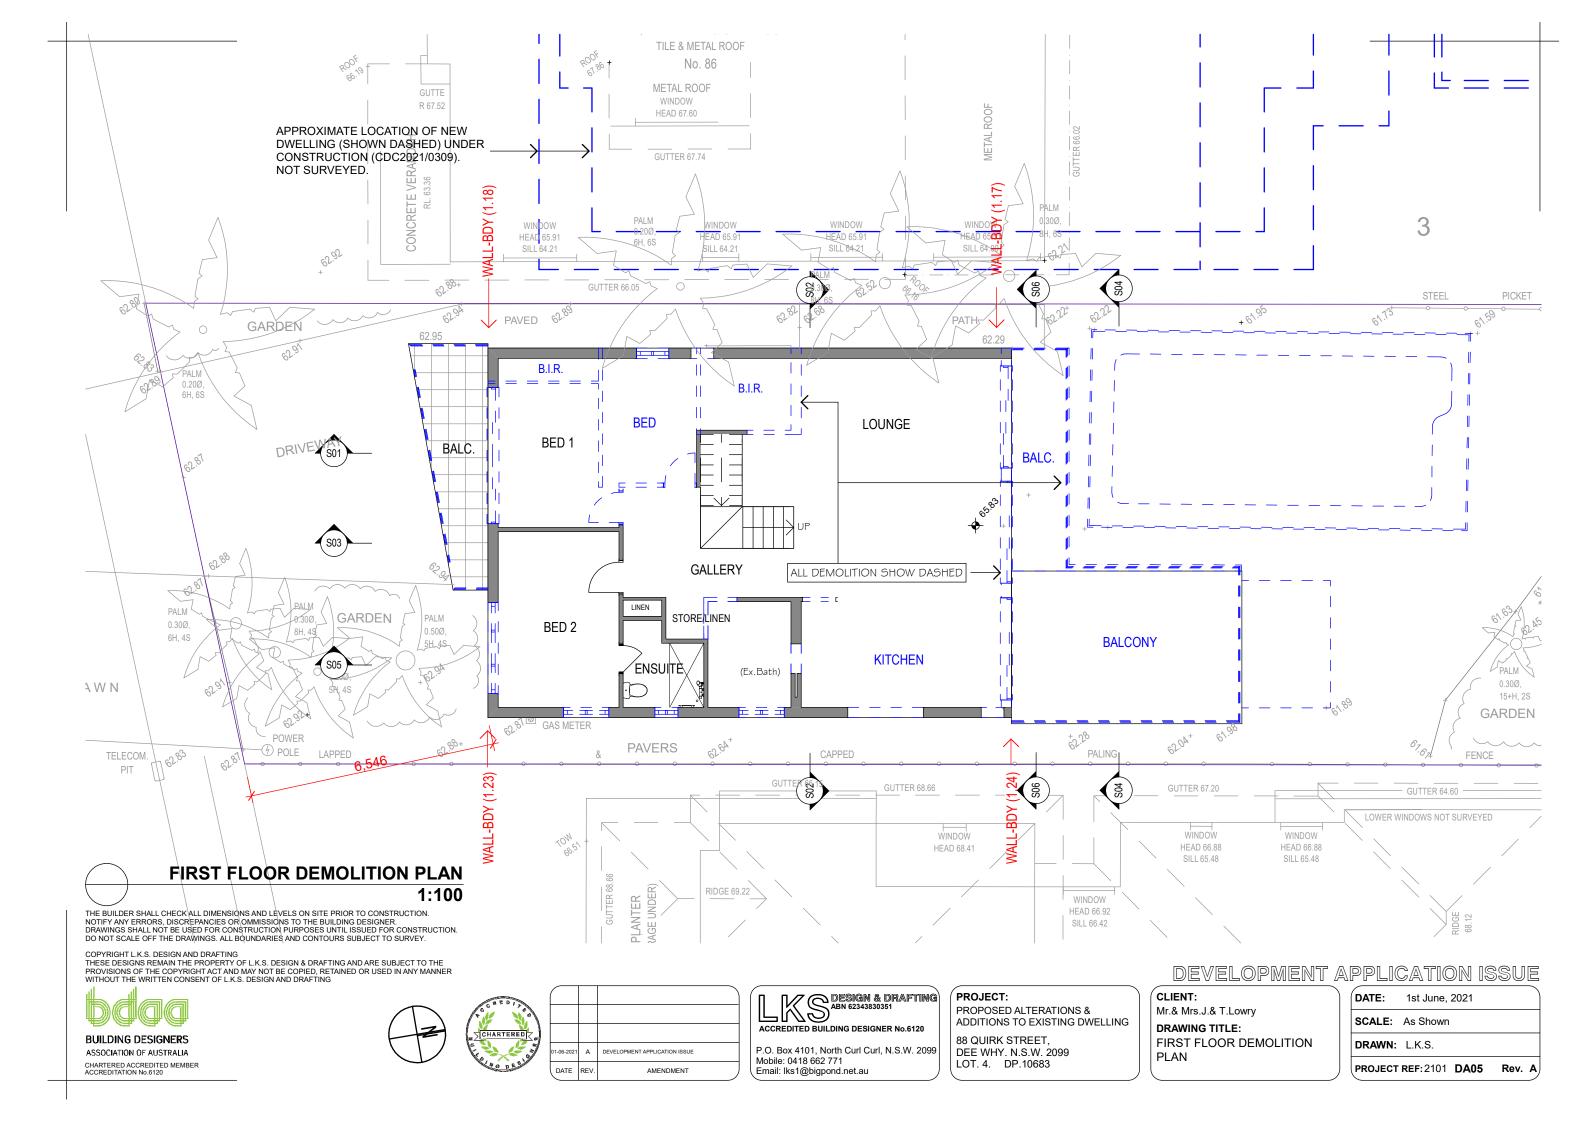

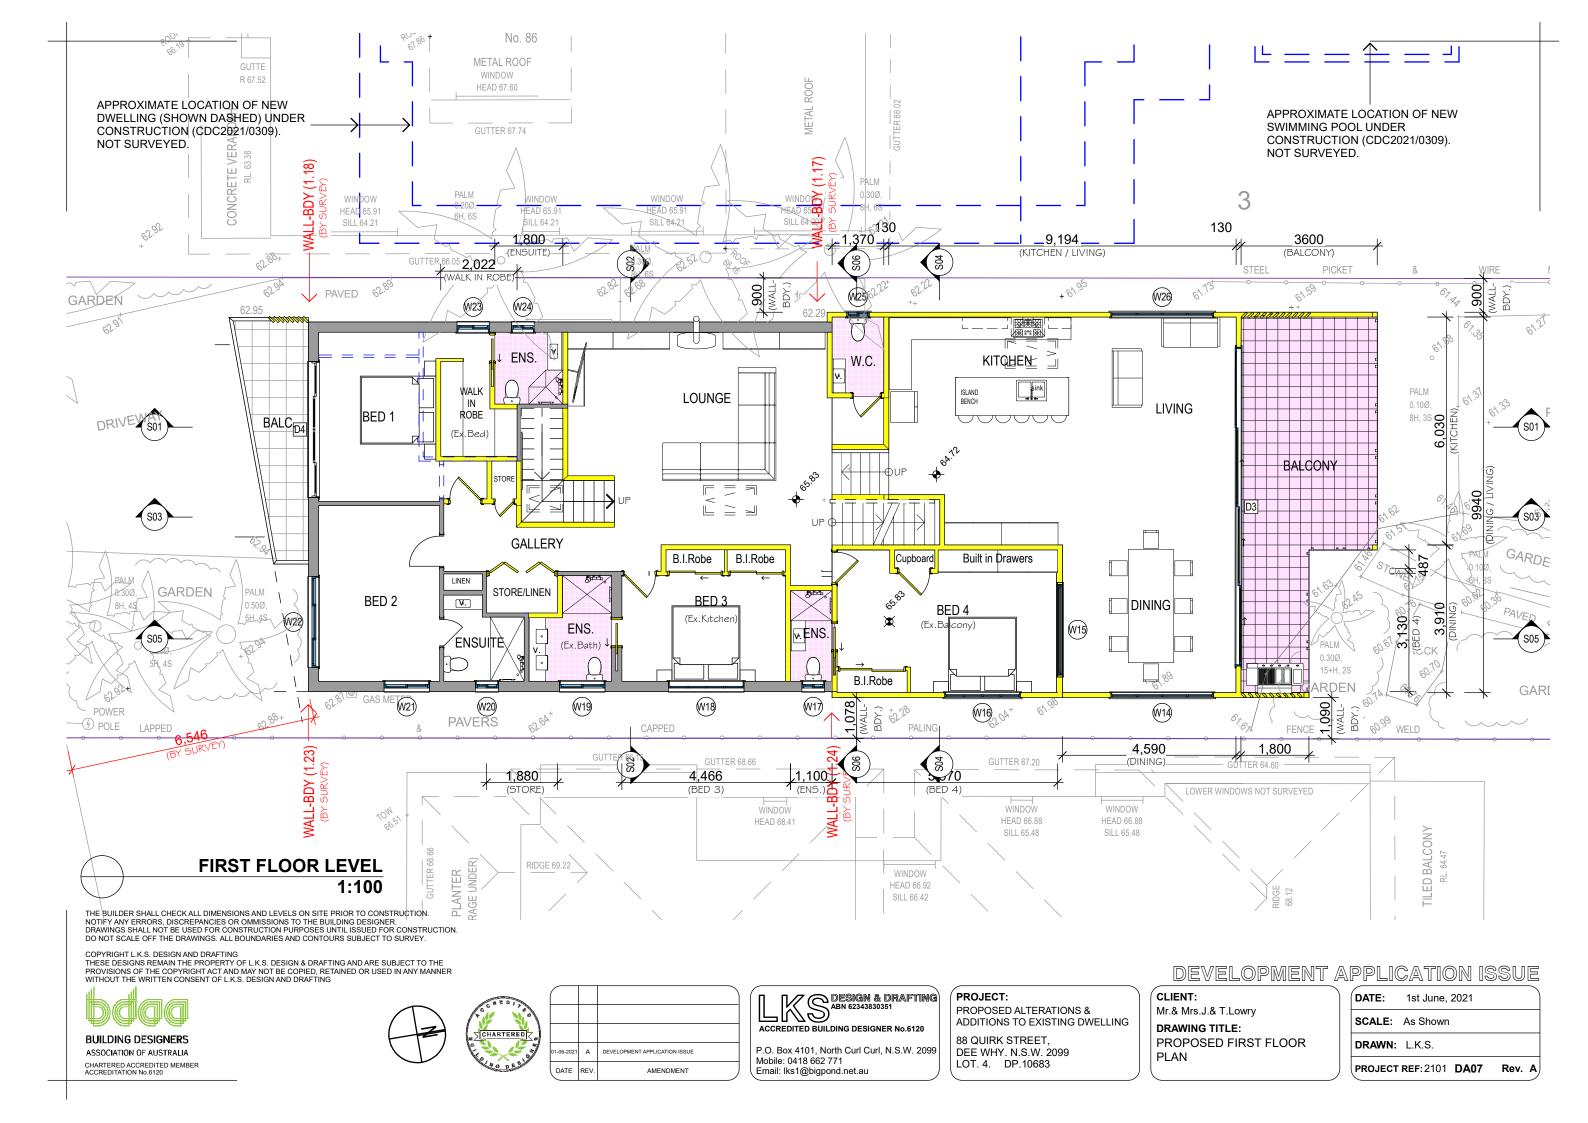

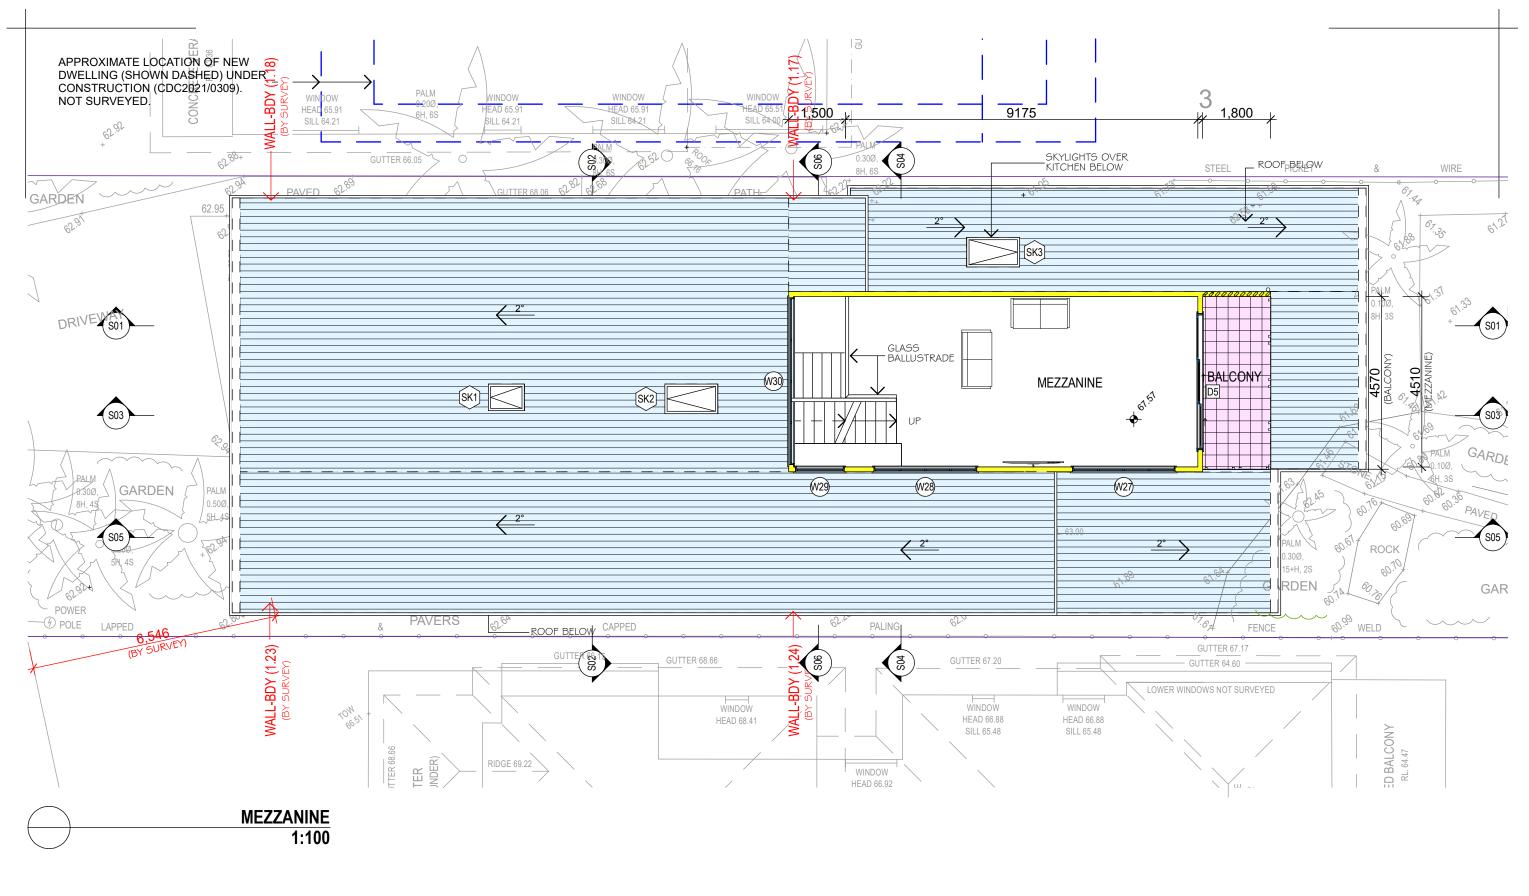

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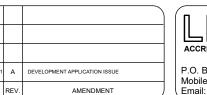
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BUILDING DESIGNERS ASSOCIATION OF AUSTRALIA

CHARTERED ACCREDITED MEMBER ACCREDITATION No.6120





PROJECT: **PROPOSED ALTERATIONS &** -MD ACCREDITED BUILDING DESIGNER No.6120

P.O. Box 4101, North Curl Curl, N.S.W. 2099 Mobile: 0418 662 771 Email: lks1@bigpond.net.au

DEVELOPMENT APPLICATION ISSUE

CLIENT: Mr.& Mrs. DRAWIN PROPO FLOOR


ADDITIONS TO EXISTING DWELLING


88 QUIRK STREET,

LOT. 4. DP.10683

DEE WHY. N.S.W. 2099

DATE: 1st June, 2021
SCALE: As Shown
DRAWN: L.K.S.
PROJECT REF: 2101 DA08 Rev. A

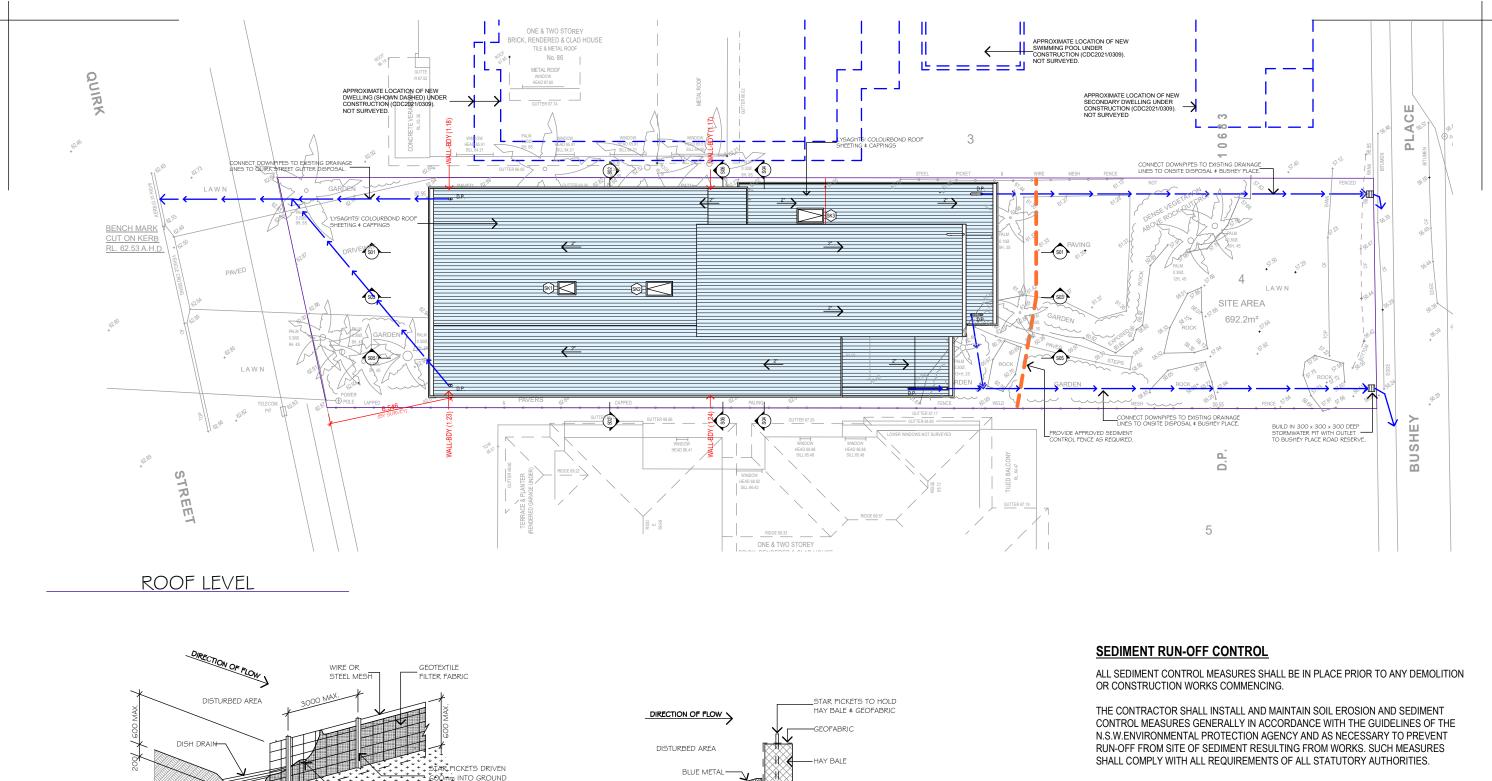

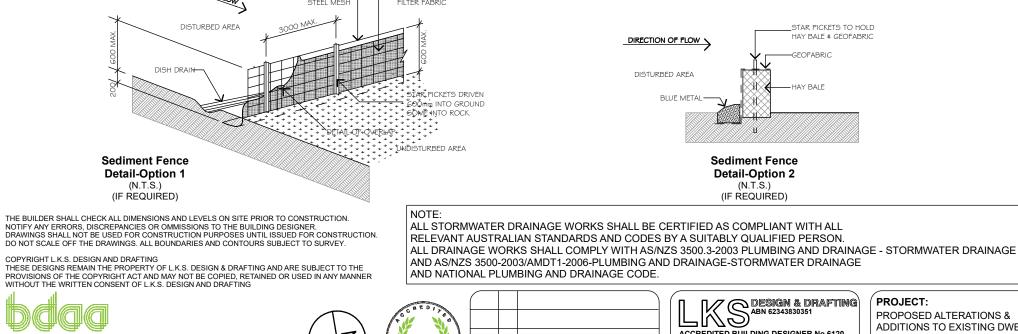

ACCREDITED BUILDING DESIGNER No.6120

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Email: lks1@bigpond.net.au

P.O. Box 4101, North Curl Curl, N.S.W. 2099

PROPOSED ALTERATIONS & ADDITIONS TO EXISTING DWELLING

88 QUIRK STREET, DEE WHY. N.S.W. 2099 LOT. 4. DP.10683

DE

CLIENT: Mr.& Mrs. DRAWIN ROOF F DRAINA SILT FE

(N.T.S.)

(IF REQUIRED)

BUILDING DESIGNERS ASSOCIATION OF AUSTRALIA CHARTERED ACCREDITED MEMBER ACCREDITATION No.6120 CHARTERED. 06-202

EVELOPMENT APPLICATION ISSUE Δ DATE REV AMENDMENT

GRADE FINISHED SURFACES TO SHED WATER EVENLY WITHOUT CHANNELLING UNTIL PIPED STORMWATER SYSTEM IS BUILT IN.

PIPEWORK SHALL BE INSTALLED AS SOON AS PRACTICAL TO ENSURE THAT GUTTERS ETC. ARE NOT CONCENTRATED ONTO DISTURBED SOIL.

VELOPMENT A	APPLICATION ISSUE
	DATE: 1st June, 2021
.J.& T.Lowry G TITLE:	SCALE: As Shown
PLAN, CONCEPT	DRAWN: L.K.S.
NCE DETAIL	PROJECT REF: 2101 DA09 Rev. A





ASSOCIATION OF AUSTRALIA CHARTERED ACCREDITED MEMBER ACCREDITATION No.6120



PROJECT: DESIGN & DRAFTING **PROPOSED ALTERATIONS &** -MD ADDITIONS TO EXISTING DWELLING ACCREDITED BUILDING DESIGNER No.6120 88 QUIRK STREET, DEE WHY. N.S.W. 2099

P.O. Box 4101, North Curl Curl, N.S.W. 2099 Mobile: 0418 662 771 Email: lks1@bigpond.net.au

LOT. 4. DP.10683

DEVELOPMENT APPLICATION ISSUE

CLIENT: Mr.& Mrs.J.& T.Lowry DRAWING TITLE: NORTH ELEVATION and SOUTH ELEVATIONS

DATE: 1st June, 2021

SCALE: As Shown

DRAWN: L.K.S.

PROJECT REF: 2101 DA10

Rev. A




VELOPMENT APPLICATION ISSUE								
	DATE: 1st June, 2021							
.J.& T.Lowry G TITLE:	SCALE: As Shown							
LEVATION and WEST	DRAWN: L.K.S.							
	PROJECT REF:2101 DA11 Rev. A							



BUILDING DESIGNERS ASSOCIATION OF AUSTRALIA CHARTERED ACCREDITED MEMBER ACCREDITATION No.6120



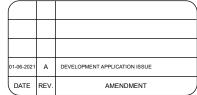


-MD ACCREDITED BUILDING DESIGNER No.6120 88 QUIRK STREET,

DEE WHY. N.S.W. 2099

LOT. 4. DP.10683

P.O. Box 4101, North Curl Curl, N.S.W. 2099 Mobile: 0418 662 771 Email: lks1@bigpond.net.au

DRAWING TITLE: SECTION S01 & SECTION S03 SCALE: As Shown DRAWN: L.K.S. PROJECT REF: 2101 DA12 Rev. A

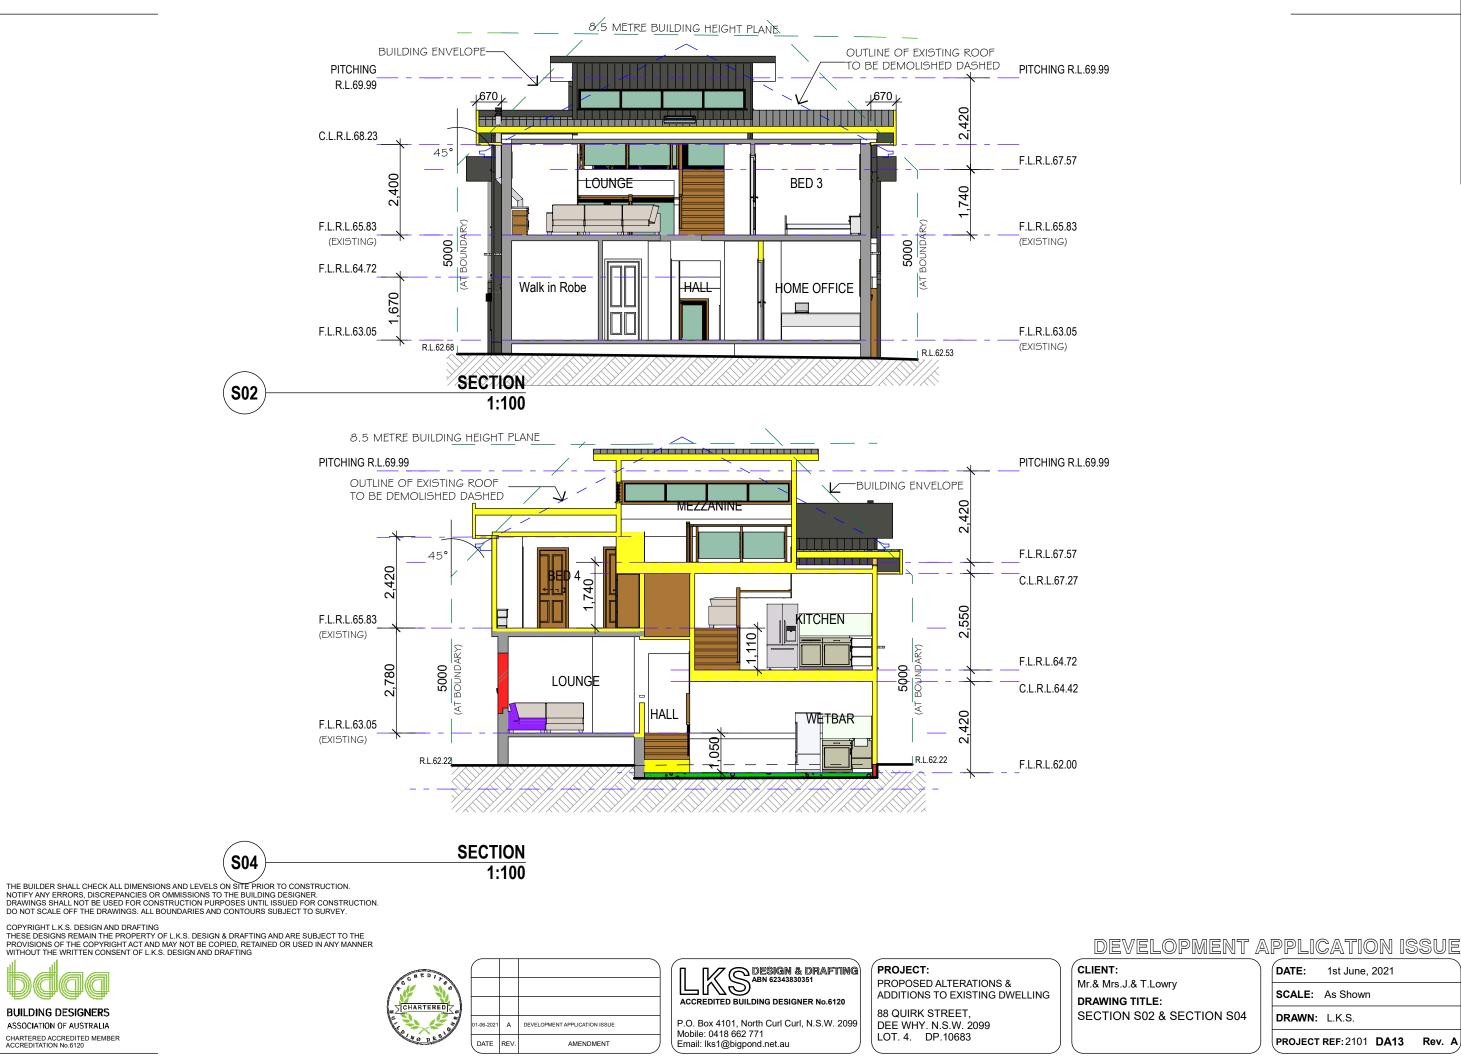

BUILDING DESIGNERS

ASSOCIATION OF AUSTRALIA

CHARTERED ACCREDITED MEMBER ACCREDITATION No.6120


J.& T.Lowry	DATE:	1st June,	2021	
G TITLE:	SCALE:	As Shown		
N S02 & SECTION S04	DRAWN:	L.K.S.		
	PROJECT	REF :2101	DA13	Rev. A

					<u> </u>	WINDOW SCHEDULE			
NO.	SIZE (W x H)	AREA (Fram & Glass)	LOCATION	ТҮРЕ	ORIENTATION	OVERSHADOWING	SHADING DEVICE	FRAME & GLAZING TYPE (Minimum BASIX Requirements)	View from Opening Side
W1	1,600×1,200	1.92m2	GAMES/ ENTERTAINING	SLIDING	EAST	NONE	EAVE/VERANDAH/PERGOLA/ BALCONY>=900mm	STANDARD ALUMINIUM, SINGLE CLEAR, (OR U-VALUE: 7.63, SHGC: 0.75)	
W2	2,770×470	1.30m2	LOUNGE	FIXED	NORTH	NONE	EAVE/VERANDAH/PERGOLA/ BALCONY>=900mm	STANDARD ALUMINIUM, SINGLE CLEAR, (OR U-VALUE: 7.63, SHGC: 0.75)	
W3	1,200×900	1.08m2	LOUNGE	SLIDING	EAST	2.93m(Height) 2.07m(Distance)	PROJECTION/HEIGHT ABOVE SILL RATIO>=0.23	STANDARD ALUMINIUM, SINGLE CLEAR, (OR U-VALUE: 7.63, SHGC: 0.75)	
W4	1,300×900	1.17m2	HOME OFFICE	SLIDING	EAST	4.41m(Height) 2.05m(Distance)	NONE	STANDARD ALUMINIUM, SINGLE CLEAR, (OR U-VALUE: 7.63, SHGC: 0.75)	
W5	700×600	0.42m2	LAUNDRY	SLIDING	EAST	1.58m(Height) 2.05m(Distance)	PROJECTION/HEIGHT ABOVE SILL RATIO>=0.23	STANDARD ALUMINIUM, SINGLE CLEAR, (OR U-VALUE: 7.63, SHGC: 0.75)	
W6	600×400	0.24m2	BATH	SLIDING	EAST	1.74m(Height) 2.13m(Distance)	NONE	STANDARD ALUMINIUM, SINGLE CLEAR, (OR U-VALUE: 7.63, SHGC: 0.75)	
W7	1,200×800	0.96m2	BED 5	SLIDING	EAST	NONE	PROJECTION/HEIGHT ABOVE SILL RATIO>=0.43	STANDARD ALUMINIUM, SINGLE CLEAR, (OR U-VALUE: 7.63, SHGC: 0.75)	
W8	2,417×600	1.45m2	BED 5	SLIDING	SOUTH	NONE	NONE	STANDARD ALUMINIUM, SINGLE CLEAR, (OR U-VALUE: 7.63, SHGC: 0.75)	
W9	500×2,100	1.05m2	ENTRY	FIXED	WEST	2.98m(Height) 3.01m(Distance)	EAVE/VERANDAH/PERGOLA/ BALCONY>=900mm	STANDARD ALUMINIUM, SINGLE CLEAR, (OR U-VALUE: 7.63, SHGC: 0.75)	
W10	500×2,100	1.05m2	ENTRY	FIXED	WEST	2.98m(Height) 3.01m(Distance)	EAVE/VERANDAH/PERGOLA/ BALCONY>=900mm	STANDARD ALUMINIUM, SINGLE CLEAR, (OR U-VALUE: 7.63, SHGC: 0.75)	
W11	2,000×600	1.2m2	GUESTS BED	SLIDING	WEST	1.62m(Height) 1.93m(Distance)	PROJECTION/HEIGHT ABOVE SILL RATIO>=0.23	STANDARD ALUMINIUM, SINGLE CLEAR, (OR U-VALUE: 7.63, SHGC: 0.75)	
W12	600×400	0.24m2	ENSUITE	SLIDING	WEST	1.24m(Height) 1.68m(Distance)	PROJECTION/HEIGHT ABOVE SILL RATIO>=0.36	STANDARD ALUMINIUM, SINGLE CLEAR, (OR U-VALUE: 7.63, SHGC: 0.75)	
W13	2,720×800	2.17m2	GAMES/ ENTERTAINING	SLIDING	WEST	NONE	EXTERNAL LOUVER / BLIND (ADJUSTABLE)	STANDARD ALUMINIUM, SINGLE CLEAR, (OR U-VALUE: 7.63, SHGC: 0.75)	
W14	2,720×800	2.17m2	DINING	LOUVRE/FIXED/FIXED/LOUVRE	EAST	NONE	PROJECTION/HEIGHT ABOVE SILL RATIO>=0.43	STANDARD ALUMINIUM, SINGLE CLEAR, (OR U-VALUE: 7.63, SHGC: 0.75)	
W15	2,400×400	0.96m2	BED 4	FIXED	NORTH	NONE	EAVE/VERANDAH/PERGOLA/ BALCONY>=900mm	STANDARD ALUMINIUM, SINGLE CLEAR, (OR U-VALUE: 7.63, SHGC: 0.75)	
W16	2,000×600	1.2m2	BED 4	LOUVRE/FIXED/FIXED/LOUVRE	EAST	NONE	PROJECTION/HEIGHT ABOVE SILL RATIO>=0.43	STANDARD ALUMINIUM, SINGLE CLEAR, (OR U-VALUE: 7.63, SHGC: 0.75)	
W17	600×400	0.24m2	ENSUITE	SLIDING	EAST	1.13m(Height) 2.05m(Distance)	PROJECTION/HEIGHT ABOVE SILL RATIO>=0.43	STANDARD ALUMINIUM, SINGLE CLEAR, (OR U-VALUE: 7.63, SHGC: 0.75)	•
W18	2,000×600	1.2m2	BED 3	LOUVRE/FIXED/FIXED/LOUVRE	EAST	1.33m(Height) 2.05m(Distance)	PROJECTION/HEIGHT ABOVE SILL RATIO>=0.43	STANDARD ALUMINIUM, SINGLE CLEAR, (OR U-VALUE: 7.63, SHGC: 0.75)	
W19	1,200×600	0.72m2	ENSUITE	SLIDING	EAST	1.31m(Height) 2.05m(Distance)	PROJECTION/HEIGHT ABOVE SILL RATIO>=0.43	STANDARD ALUMINIUM, SINGLE CLEAR, (OR U-VALUE: 7.63, SHGC: 0.75)	
W20	610×940	0.57m2	ENSUITE	SLIDING	EAST	NONE	PROJECTION/HEIGHT ABOVE SILL RATIO>=0.43	STANDARD ALUMINIUM, SINGLE CLEAR, (OR U-VALUE: 7.63, SHGC: 0.75)	
W21	1,200×1,200	1.44m2	BED 2	SLIDING	EAST	NONE	PROJECTION/HEIGHT ABOVE SILL RATIO>=0.43	STANDARD ALUMINIUM, SINGLE CLEAR, (OR U-VALUE: 7.63, SHGC: 0.75)	
W22	2,410×1,200	2.89m2	BED 2	SLIDING	SOUTH	NONE	PROJECTION/HEIGHT ABOVE SILL RATIO>=0.43	STANDARD ALUMINIUM, SINGLE CLEAR, (OR U-VALUE: 7.63, SHGC: 0.75)	
W23	850×1,200	1.02m2	BED 1	SLIDING	WEST	NONE	PROJECTION/HEIGHT ABOVE SILL RATIO>=0.43	STANDARD ALUMINIUM, SINGLE CLEAR, (OR U-VALUE: 7.63, SHGC: 0.75)	
W24	600×600	0.36m2	ENSUITE	SLIDING	WEST	NONE	PROJECTION/HEIGHT ABOVE SILL RATIO>=0.43	STANDARD ALUMINIUM, SINGLE CLEAR, (OR U-VALUE: 7.63, SHGC: 0.75)	
W25	600×400	0.24m2	W.C.	SLIDING	WEST	NONE	PROJECTION/HEIGHT ABOVE SILL RATIO>=0.43	STANDARD ALUMINIUM, SINGLE CLEAR, (OR U-VALUE: 7.63, SHGC: 0.75)	-
W26	2,720×800	2.17m2	LIVING	LOUVRE/FIXED/FIXED/LOUVRE	WEST	NONE	PROJECTION/HEIGHT ABOVE SILL RATIO>=0.43	STANDARD ALUMINIUM, SINGLE CLEAR, (OR U-VALUE: 7.63, SHGC: 0.75)	
W27	2,720×1,800	4.89m2	MEZZANINE	FIXED/FIXED/FIXED/FIXED	EAST	NONE	PROJECTION/HEIGHT ABOVE SILL RATIO>=0.29	STANDARD ALUMINIUM, TONED/AIR GAP/CLEAR, (OR U-VALUE: 5.31, SHGC: 0.48)	
W28	2,720×550	1.49m2	MEZZANINE	LOUVRE/FIXED/FIXED/LOUVRE	EAST	NONE	PROJECTION/HEIGHT ABOVE SILL RATIO>=0.43	STANDARD ALUMINIUM, SINGLE CLEAR, (OR U-VALUE: 7.63, SHGC: 0.75)	
W29	1,290×550	0.70m2	MEZZANINE	FIXED	EAST	NONE	PROJECTION/HEIGHT ABOVE SILL RATIO>=0.43	STANDARD ALUMINIUM, SINGLE CLEAR, (OR U-VALUE: 7.63, SHGC: 0.75)	
W30	4,415×550	2.42m2	MEZZANINE	FIXED/FIXED/FIXED/FIXED	SOUTH	NONE	PROJECTION/HEIGHT ABOVE SILL RATIO>=0.43	STANDARD ALUMINIUM, SINGLE CLEAR, (OR U-VALUE: 7.63, SHGC: 0.75)	


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CHARTERED ACCREDITED MEMBER ACCREDITATION No.6120



AMENDMENT

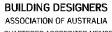

PROJECT:

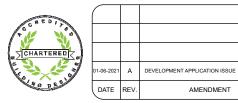88 QUIRK STREET,

DEE WHY. N.S.W. 2099 LOT. 4. DP.10683

PROPOSED ALTERATIONS & ADDITIONS TO EXISTING DWELLING

P.O. Box 4101, North Curl Curl, N.S.W. 2099 Mobile: 0418 662 771 Email: lks1@bigpond.net.au

DEVELOPMENT APPLICATION ISSUE

CLIENT:

Mr.& Mrs.J.& T.Lowry DRAWING TITLE: WINDOW SCHEDULE DATE: 1st June, 2021 SCALE: As Shown DRAWN: L.K.S.

PROJECT REF: 2101 DA14 Rev. A

	DOOR SCHEDULE											
NO.	SIZE (W x H)	AREA (Frame & Glass)	LOCATION	TYPE	ORIENTATION	OVERSHADOWING	SHADING DEVICE	FRAME & GLAZING TYPE (Minimum BASIX Requirements)	View from Opening Side			
D1	5,250×2,100	11.02m2	GAMES/ ENTERTAINING	BIFOLD	NORTH	NONE	EAVE/VERANDAH/PERGOLA/ BALCONY>=900mm	STANDARD ALUMINIUM, SINGLE CLEAR, (OR U-VALUE: 7.63, SHGC: 0.75)				
D2	976×2,100	1.02m2	ENTRY	HINGED ENTRY	WEST	2.98m(Height) 3.01m(Distance)	EAVE/VERANDAH/PERGOLA/ BALCONY>=900mm	STANDARD ALUMINIUM, SINGLE CLEAR, (OR U-VALUE: 7.63, SHGC: 0.75)				
D3	8,440×2,100	17.72m2	LIVING/DINING	STACKING SLIDING	NORTH	NONE	EAVE/VERANDAH/PERGOLA/ BALCONY>=900mm	STANDARD ALUMINIUM, SINGLE CLEAR, (OR U-VALUE: 7.63, SHGC: 0.75)				
D4	3,600×2,100	7.56m2	BED 1	STACKING SLIDING	SOUTH	NONE	EAVE/VERANDAH/PERGOLA/ BALCONY>=600mm	STANDARD ALUMINIUM, SINGLE CLEAR, (OR U-VALUE: 7.63, SHGC: 0.75)				
D5	3,600×2,100	7.56m2	MEZZANINE	STACKING SLIDING	NORTH	NONE	EAVE/VERANDAH/PERGOLA/ BALCONY>=900mm	STANDARD ALUMINIUM, SINGLE CLEAR, (OR U-VALUE: 7.63, SHGC: 0.75)				


	SKYLIGHT SCHEDULE										
NO. SIZE (W x H) Area(Frame & LOC. Glass)			LOCATION	TYPE ORIENTATION		SHADING DEVICE	FRAME & GLAZING TYPE (Minimum BASIX Requirements)				
SK1	700×950	0.66m2	GALLERY	FIXED	SOUTH	NONE	TIMBER, DOUBLE CLEAR / AIR FILL (OR U-VALUE:4.3, SHGC:0.5)				
SK2	780×1,400	1.09m2	LOUNGE	FIXED	SOUTH	NONE	TIMBER, LOW-E INTERNAL / ARGON FILL / CLEAR EXTERNAL (OR U-VALUE:2.5, SHGC: 0.456)				
SK3	780×1,400	1.09m2	KITCHEN	FIXED	NORTH	NONE	TIMBER, LOW-E INTERNAL / ARGON FILL / CLEAR EXTERNAL (OR U-VALUE:2.5, SHGC: 0.456)				

THE BUILDER SHALL CHECK ALL DIMENSIONS AND LEVELS ON SITE PRIOR TO CONSTRUCTION. NOTIFY ANY ERRORS, DISCREPANCIES OR OMMISSIONS TO THE BUILDING DESIGNER. DRAWINGS SHALL NOT BE USED FOR CONSTRUCTION PURPOSES UNTIL ISSUED FOR CONSTRUCTION. DO NOT SCALE OFF THE DRAWINGS. ALL BOUNDARIES AND CONTOURS SUBJECT TO SURVEY.

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BUILDING DESIGNERS ASSOCIATION OF AUSTRALIA CHARTERED ACCREDITED MEMBER ACCREDITATION No.6120



LKS DESIGN & DRAFTING ABN 62343830351 ACCREDITED BUILDING DESIGNER No.6120

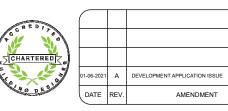PROJECT:

88 QUIRK STREET,


LOT. 4. DP.10683

DEE WHY. N.S.W. 2099

PROPOSED ALTERATIONS & ADDITIONS TO EXISTING DWELLING

P.O. Box 4101, North Curl Curl, N.S.W. 2099 Mobile: 0418 662 771 Email: Iks1@bigpond.net.au

CLIENT: Mr.& Mrs. DRAWING DOOR A SCHEDU

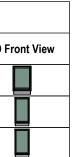

DEVELOPMENT APPLICATION ISSUE

.J.& T.Lowry	
G TITLE:	
AND SKYLIGHT	
ULES	

DATE: 1st June, 2021

SCALE: As Shown

DRAWN: L.K.S.

PROJECT REF: 2101 DA15 Rev. A

BASIX Certificate number: A416055

page 1/9

Fixtures and systems	Show on DA Plans	Show on CC/CDC Plans & specs	Certifier Check
Hot water			
The applicant must install the following hot water system in the development: gas instantaneous.	\checkmark	\checkmark	\checkmark
Lighting			
The applicant must ensure a minimum of 40% of new or aftered light fixtures are fitted with fluorescent, compact fluorescent, or light-emitting-diode (LED) lamps.		~	~
Fixtures			
The applicant must ensure new or altered showerheads have a flow rate no greater than 9 litres per minute or a 3 star water rating.		<	<
The applicant must ensure new or altered toilets have a flow rate no greater than 4 litres per average flush or a minimum 3 star water rating.		\checkmark	\checkmark
The applicant must ensure new or aftered taps have a flow rate no greater than 9 litnes per minute or minimum 3 star water rating.		×	

Certificate Prepared by (please complete before submitting to Council or PCA) Name / Company Name: Iks design & drafting ABN (if applicable): 62343830351

Lowry

4

88 Quirk Street Dee Why 2099

Northern Beaches Council

Separate dwelling house

My renovation work is valued at \$50,000 or more,

and does not include a pool (and/or spa).

Deposited Plan 10683

Planning, Industry & Environment

Construction			Show on DA Plans	Show on CC/CDC Plans & specs	Certifier Check
sulation requirements					
	t construction (floor(s), walls, and ceilings/roots) i tion is not required where the area of new constr where insulation already exists.		~	~	~
Construction	Additional insulation required (R-value)	Other specifications			
concrete slab on ground floor.	าป				
suspended floor with open subfloor: framed R0.7).	R0.8 (down) (or R1.50 including construction)				
suspended floor with enclosed subfloor: framed (R0.7).	R0.60 (down) (or R1.30 including construction)				
external wall: cavity brick	ึกป				
external wall: framed (weatherboard, fibro, netal clad)	R1.30 (or R1.70 including construction)				
aked ceiling, pitched/skillion roof: framed	ceiling: R2.24 (up), roof: foil backed blanket (55 mm)	medium (solar absorptance 0.475 - 0.70)			
lat ceiling, flat roof: framed	ceiling: R2.08 (up), roof: foil backed blanket (55 mm)	medium (solar absorptance 0.475 - 0.70)			

THE BUILDER SHALL CHECK ALL DIMENSIONS AND LEVELS ON SITE PRIOR TO CONSTRUCTION. NOTIFY ANY ERRORS, DISCREPANCIES OR OMMISSIONS TO THE BUILDING DESIGNER. DRAWINGS SHALL NOT BE USED FOR CONSTRUCTION PURPOSES UNTIL ISSUED FOR CONSTRUCTION. DO NOT SCALE OFF THE DRAWINGS. ALL BOUNDARIES AND CONTOURS SUBJECT TO SURVEY.

BASIX[®]Certificate

Building Sustainability Index www.basix.nsw.gov.au

Date of issue: Thursday, 27, May 2021 To be valid, this certificate must be indged within 3 months of the date of issue

This certificate confirms that the proposed development will meet the NSW government's requirements for sustainability, if it is built in accordance with the commitments set out below. Terms used in this certificate, or in the commitments, have the meaning given by the document entitled "BASIX Attentions and Additione Definitions" dated 06/10/2017 published by the Department. This document is available at wave heating are an

Alterations and Additions

Certificate number: A416055

available at www.basix.nsw.gov.au

Planning, Industry & Environment

Secretary

NSW

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BUILDING DESIGNERS ASSOCIATION OF AUSTRALIA CHARTERED ACCREDITED MEMBER ACCREDITATION No.6120

ect

proj

of

ption

Crij

Desi

Project address

Projectname

Lot number

Section numb

Project type Dwelling type

Street address

Local Government Area

Plan type and number

Type of alteration and addition

DESIGN & DRAFTING PROJECT: PROPOSED ALTERATIONS & ACCREDITED BUILDING DESIGNER No.6120

P.O. Box 4101, North Curl Curl, N.S.W. 2099 Email: lks1@bigpond.net.au

Building Sustainability Index www.basix.naw.gov.au

ADDITIONS TO EXISTING DWELLING

88 QUIRK STREET,

LOT. 4. DP.10683

DEE WHY. N.S.W. 2099

CLIENT: Mr.& Mrs.J.& T.Lowry DRAWING TITLE: 'BASIX' CERTIFICATE A416055 Sht's 1, 2, and 3

Planning, Industry & Environment

А DEVELOPMENT APPLICATION ISSUE 06-202 DATE REV AMENDMENT

Mobile: 0418 662 771

Building Gastainability Index www.basix.nsw.gov.au

DEVELOPMENT APPLICATION ISSUE

DATE: 1st June, 2021 SCALE: As Shown DRAWN: L.K.S.

PROJECT REF: 2101 DA16

Rev. A

Slazing requirements	Show on DA Plans	Show on CC/CDC Plans & specs	Certifier Check
Vindows and glazed doors	l l		1
The applicant must install the windows, glazed doors and shading devices, in accordance with the specifications listed in the table belo Relevant overshadowing specifications must be satisfied for each window and glazed door.	w. 🗸	~	~
The following requirements must also be satisfied in relation to each window and glazed door:		× .	\sim
Each window or glazed door with standard aluminium or timber frames and single clear or toned glass may either match the description nave a U-value and a Solar Heat Gain Coefficient (SHGC) no greater than that listed in the table below. Total system U-values and SH nust be calculated in accordance with National Fenestration Rating Council (NFRC) conditions.		~	~
Each window or glazed door with improved frames, or pyrolytic low-e glass, or clear/air gap/clear glazing, or toned/air gap/clear glazing nave a U-value and a Solar Heat Gain Coefficient (SHGC) no greater than that listed in the table below. Total system U-values and SH nust be calculated in accordance with National Fenestration Rating Council (NFRC) conditions. The description is provided for informa only. Alternative systems with complying U-value and SHGC may be substituted.	GCs	~	~
For projectione described in millimetres, the leading edge of each eave, pergola, verandah, balcony or awning must be no more than 50 above the head of the window or glazed door and no more than 2400 mm above the sill.	ענ mm 🗸	~	~
For projections described as a ratio, the ratio of the projection from the wall to the height above the window or glazed door sill must be a east that shown in the table below.	at 🗸	~	~
Pergolas with polycarbonate roof or similar transfucent material most have a shading coefficient of less than 0.36.		× .	\checkmark
External louvres and blinds must fully shade the window or glazed door beside which they are situated when fully drawn or closed.		\checkmark	\checkmark
Pergolas with fixed battens must have battens parallel to the window or glazed door above which they are situated, unless the pergola shades a perpendicular window. The spacing between battens must not be more than 50 mm.	also	\checkmark	\checkmark
Dvershadowing buildings or vegetation must be of the height and distance from the centre and the base of the window and glazed door specified in the 'overshadowing' column in the table below.	r, aə 🗸	~	~

BASIX Certificate number: A416035

Glazing requirements

Shading device ow / do Area of eiaht Distance verandah/perg .92 >=900 mm W2 1.3 eave/verandah/pergola/balcony >=900 mm W3 1.082.932.0 projection/height above sill ratio >=0.23 W4 1.17 4.41 2.05 none projection/height above sill ratio >=0.23 1.58 W5 0.42 2.05 W n 24 74 2 13 none projection/height above sill ratio >=0.43 W 0.96 1.45 none eave/verandah/pergola/balcony >=900 mm 1.06 .98 3.01W10 1.05 2,98 3.01 eave/verandah/pergola/balcony >=980 mm W11 eight above sill ratio 62 projection/ >=0.23 W12 0.24 1.24 projection/height above sill ratio >=0.36 1.68W13 external louvre/blind (adjustable) 2.17

Planning, Industry & Environment

Building Sustainability Index www.basix.nsw.gov.au

Planning, Industry & Environment

Glazing requ	irements						Show on DA Plans	Show on CC/CDC Plans & specs	Certifier Check
Window / door	Orientation		Oversha	Idowing	Shading device	Frame and glass type			
no.		glass ínc. frame (m2)	Height (m)	Distance (m)					
W14	E	2.17	Q	0	projection/height above sill ratio >=0.43	standard aluminium, single olear, (or U-value: 7.63, SHGC: 0.75)			
W15	N	0.96	٥	0	eave/verandah/pergola/balcony >=900 mm	standard aluminium, single clear, (or U-value: 7.63, SHGC: 0.75)	1		
W16	E	1.2	0	0	projection/height above sill ratio >=0.43	standard aluminium, single clear, (or U-value: 7.63, SHGC: 0.75)			
W17	E	0.24	1.13	2.05	projection/height above sill ratio >=0.43	standard aluminium, single clear, (or U-value: 7.63, SHGC: 0.75)			
W18	E	1.2	1.38	2.05	projection/height above sill ratio >=0.43	standard aluminium, single clear, (or U-value: 7.63, SHGC: 0.75)			
W19	E	0.72	1.31	2.05	projection/height above sill ratio >=0.43	standard aluminium, single clear, (or U-value: 7.63, SHGC: 0.75)	1		
W20	E	0.87	a	a	projection/height above sill ratio >=0.43	standard atuminium, single clear, (or U-value: 7.63, SHGC: 0.75)	1		
W21	E	1.44	٥	٥	projection/height above sill ratio >=0.43	standard aluminium, single clear, (or U-value: 7.63, SHGC: 0.75)			
W22	S	2.89	٥	٥	projection/height above sill ratio >=0.43	standard aluminium, single clear, (or U-value: 7.03, SHGC: 0.76)	1		
W23	w	1.02	a	0	projection/height above sill ratio >=0.43	standard aluminium, single clear, (or U-value: 7.63, SHGC: 0.75)	11		
W24	w	0.36	٥	0	projection/height above sill ratio >=0.43	standard aluminium, single olear, (or U-value: 7.63, SHGC: 0.75)	1		
W25	w	0.24	٥	0	projection/height above sill ratio >=0,43	standard aluminium, single clear, (or U-value: 7,63, SHGC; 0,75)	11		
W26	VV	2.17	Q	Q	projection/height above sill ratio	standard aluminium, single clear, (or U-value: 7.63, SHGC: 0.75)	11		

THE BUILDER SHALL CHECK ALL DIMENSIONS AND LEVELS ON SITE PRIOR TO CONSTRUCTION. NCTIFY ANY ERRORS, DISCREPANCIES OR OMMISSIONS TO THE BUILDING DESIGNER. DRAWINGS SHALL NOT BE USED FOR CONSTRUCTION PURPOSES UNTIL ISSUED FOR CONSTRUCTION. DQ NOT SCALE OFF THE DRAWINGS. ALL BOUNDARIES AND CONTOURS SUBJECT TO SURVEY.

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BUILDING DESIGNERS ASSOCIATION OF AUSTRALIA

CHARTERED ACCREDITED MEMBER ACCREDITATION No.6120



Planning, Industry & Environment

Mobile: 0418 662 771 Email: lks1@bigpond.net.au Building Sustainability Index www.basix.nsw.gov.au

PROJECT:

PROPOSED ALTERATIONS &

88 QUIRK STREET,

LOT. 4. DP.10683

DEE WHY. N.S.W. 2099

ADDITIONS TO EXISTING DWELLING

CLIENT: Mr.& Mrs. DRAWING 'BASIX' Sht's. 4,

-06-2021 A DEVELOPMENT APPLICATION ISSUE DATE REV AMENDMENT

DESIGN & DRAFTING ACCREDITED BUILDING DESIGNER No.6120 P.O. Box 4101, North Curl Curl, N.S.W. 2099

	Show on DA Plans	Show on CC/CDC Plans & specs	Certifier Check
me and glass type			
ndard aluminium, single clear, (or alue: 7.03, SHGC: 0.70)	1		
ndard aluminium, single clear, (or value: 7.63, SHGC: 0.75)	1		
ndard aluminium, single clear, (or ralue: 7.63, SHGC: 0.75)	1		
ndard aluminium, single clear, (or alue: 7.63, SHGC: 0.75)	1		
ndard aluminium, single clear, (or value: 7.63, SHGC: 0.75)			
ndard aluminium, single clear, (or alue: 7.63, SHBC: 0.75)	1		
ndard aluminium, single clear, (or value: 7.63, SHGC: 0.76)	1		
ndard aluminium, single clear, (or alue: 7.63, SMGC: 0.76)			
ndard aluminium, single clear, (or value: 7.63, SHGC: 0.76)	1		
ndard aluminium, single clear, (or value: 7.63, SHGC: 0.76)	1		
ndard aluminium, single clear, (or value: 7.63, SHGC: 0.75)	11		
ndard aluminium, single clear, (or alue: 7.63, SHCC: 0.76)	11		
ndard aluminium, single clear, (or value: 7.63, SHGC: 0.75)]		

Building Sustainability Index www.basix.nsw.gov.au

DEVELOPMENT APPLICATION ISSUE

DATE: 1st June, 2021 SCALE: As Shown

DRAWN: L.K.S.

PROJECT REF: 2101 DA17 Rev. A

<u> </u>	·			_			01	<u>a</u>	Certifier						
Slazing requ	irements						Show on DA Plans	Show on CC/CDC Plans & specs	Check	Glazing require	ements				
Window / door no.	Orientation	Area of glass inc. frame	Oversha Height (m)	adowing Distance (m)	Shading device	Frame and glass type				Skylight number	Area of glazing inc. frame (m?)	S			
W27	F	.(m2) 4.89	0	0	projection/height above sill ratio	standard aluminium, foned/air gap/dear,				3K1 3K2	1.09	ns DS			
W28	E	1.49	0	0	>=0.29 projection/height above sill ratio	(U-value: 5.31, SHGC: 0.48) standard aluminium, single clear, (or				SK3	1.09	no			
W29		0.7	0	0	>=0.43 projection/height above sill ratio	U-value: 7.63, SHGC: 0.75) standard aluminium, single clear, (or						_			
N30	S	2.42	Q	0	>=0.43 projection/height above sill ratio	U-value: 7.63, SHGC: 0.75) standard aluminium, single clear, (or									
D1	N	11.02	o	o	>=0.43 eave/verandah/pergola/balcony >=900 mm	U-value: 7.63, SHGC: 0.75) standard aluminium, single clear, (or U-value: 7.62, SHCC: 0.75)									
D2	w	1.02	2.98	3.01	<pre>>=900 mm eave/verandah/pergola/balcony >=900 mm</pre>	U-value: 7.63, SHGC: 0.75) standard aluminium, single clear, (or U-value: 7.63, SHBC: 0.75)									
D8	N	17.72	0	0	eave/verandah/pergola/balcony >=900 mm	standard aluminium, single clear, (or U-value: 7.63, SHGC: 0.75)									
D4	S	7.56	0	0	projection/height above sill ratio	standard aluminium, single clear, (or U=value: 7.63, SMGC: 0.75)									
D6	N	7.56	0	0	eave/verandah/pergola/balcony >=900 mm	standard aluminium, single clear, (or U-value: 7.63, SHGC: 0.76)									
Skylights				1											
					he specifications listed in the table	below.	~	\checkmark	\checkmark						
-					rto each skylight: Lualue and a Solar Heat Gain Coe	ifficient (SHGC) no greater than that listed in		1	~ ~						
he table below		ton the at	Joinpaon,	, or, nave a c		andera (orred) no greater than that isses in		×	×						
anning, Industry &	Environment					Đ	tuilding Sustainab	ility (ndex www.)	basix.nsw.gov.au	Planning, Industry & Fo	vironment				
					1	5ASIX Øertificate number: A416055									
						Legend									
						In these commitments, "applicant" means the p	erson carrying	g out the dev	elopment.						
						Commitments identified with a " " in the "Sho</td <td>w on DA plans</td> <td>a colamu un</td> <td>st be shown or</td> <td>the plans accompanyin</td> <td>g the development</td> <td>app</td>	w on DA plans	a colamu un	st be shown or	the plans accompanyin	g the development	app			

Mr.& Mrs. ADDITIONS TO EXISTING DWELLING DRAWIN 'BASIX (Shts7, 8

THE BUILDER SHALL CHECK ALL DIMENSIONS AND LEVELS ON SITE PRIOR TO CONSTRUCTION. NOTIFY ANY ERRORS, DISCREPANCIES OR OMMISSIONS TO THE BUILDING DESIGNER. DRAWINGS SHALL NOT BE USED FOR CONSTRUCTION PURPOSES UNTIL ISSUED FOR CONSTRUCTION. DO NOT SCALE OFF THE DRAWINGS. ALL BOUNDARIES AND CONTOURS SUBJECT TO SURVEY.

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BUILDING DESIGNERS ASSOCIATION OF AUSTRALIA CHARTERED ACCREDITED MEMBER ACCREDITATION No.6120

Planning, Industry & Environment

-06-2021 A DEVELOPMENT APPLICATION ISSUE DATE REV AMENDMENT

LKS DESIGN & DRAFTING ADD 62343830351 ACCREDITED BUILDING DESIGNER No.6120

P.O. Box 4101, North Curl Curl, N.S.W. 2099 Mobile: 0418 662 771 Email: lks1@bigpond.net.au

Building Systainability Index www.basix.nsw.gov.au

PROJECT:

PROPOSED ALTERATIONS &

88 QUIRK STREET,

LOT. 4. DP.10683

DEE WHY. N.S.W. 2099

page 9 / 9

CLIENT:

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no shadino

no shading

pment application for the proposed development (if a

development application is to be lodged for the proposed development).

Commitments identified with a "v" in the "Show on CC/CDC plans & specs" column must be shown in the plans and specifications accompanying the application for a construction certificate / complying development certificate for the proposed development.

Commitments identified with a "

			page 6 / 9
	Show on DA Plans	Show on CC/CDC Plans & specs	Certifier Check
Frame and glass type			
timber, double clear/air fill, (or U-value: 4.3, SHGC: 0.6)			
timber, low-E internal/argon fill/clear external, (or U-value: 2.5, SHGC: 0.456)			
timber, low-E internal/argon fill/clear external, (or U-value: 2.6, SHGC: 0.486)			


Ruilding Sustainability Index www.basix.nsw.gav.au

DEVELOPMENT APPLICATION ISSUE

J.& T.Lowry	
G TITLE:	
CERTIFICATE' A416055	
and 9	

DATE: 1st June, 2021 SCALE: As Shown DRAWN: L.K.S.

PROJECT REF: 2101 DA18 Rev. A

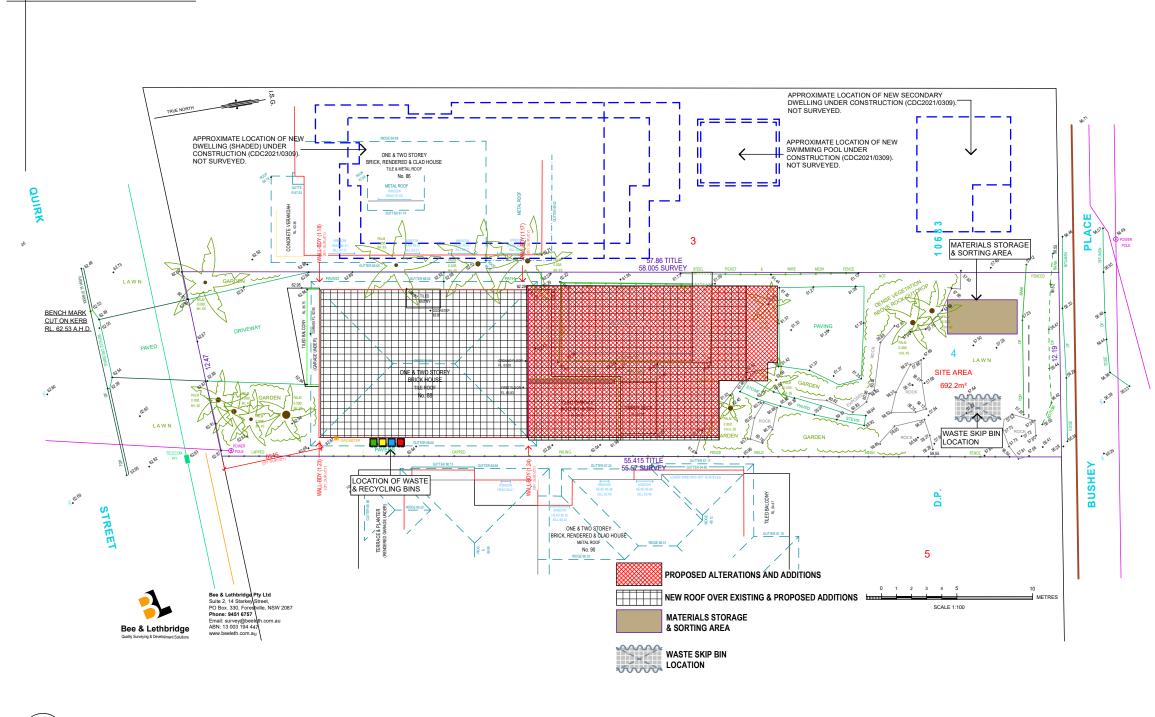

WASTE MANAGEMENT PLAN 1:250

			ON-GOING WASTE	MANAGEMENT			Describe how you intend to ensure ongoing management of waste
THE BUILDER SHALL CHECK ALL DIMENSIONS AND LEVELS ON SITE PRIOR TO CONSTRUCTION.			Type Of Waste To Be Generated	Expected Vol. Per Week	Proposed On-Site Storage And Treatment Fascilities	Destination	on-site (eg. Lease conditions, caretaker/ manager on site)
NOTIFY ANY ERRORS, DISCREPANCIES OR OMMISSIONS TO THE BUILDING DESIGNER. DRAWINGS SHALL NOT BE USED FOR CONSTRUCTION PURPOSES UNTIL ISSUED FOR CONSTRUCTI DO NOT COME FOR THE DRAWINGCA AND DESIGNATION OF THE DESIGN OF THE DESIG	ON.		General Household Waste	120 lt / week	Council's Bin	Council's Contractor	Owner Occupier
DO NOT SCALE OFF THE DRAWINGS. ALL BOUNDARIES AND CONTOURS SUBJECT TO SURVEY.			Glass, Paper & Metal	120 lt / alternate weeks	Council's Recycling Bin	Council's Contractor	Owner Occupier
COPYRIGHT L.K.S. DESIGN AND DRAFTING THESE DESIGNS REMAIN THE PROPERTY OF L.K.S. DESIGN & DRAFTING AND ARE SUBJECT TO THE PROVISIONS OF THE COPYRIGHT ACT AND MAY NOT BE COPIED, RETAINED OR USED IN ANY MANNE WITHOUT THE WRITTEN CONSENT OF L.K.S. DESIGN AND DRAFTING			Garden Waste, Grass Clippings	240 lt / fortnight	Council's Bin	Council's Contractor	Owner Occupier
bdaa					DESIGN & DRAFTING ABN 62343830351	PROJECT: PROPOSED ALTERA ADDITIONS TO EXIS	
BUILDING DESIGNERS ASSOCIATION OF AUSTRALIA		2021 A DEVELOP	MENT APPLICATION ISSUE	P.O. Box 4101,	North Curl Curl, N.S.W. 2099	88 QUIRK STREET, DEE WHY. N.S.W. 2	
CHARTERED ACCREDITED MEMBER ACCREDITATION No.6120	DAT	E REV.	AMENDMENT	Mobile: 0418 66 Email: lks1@big		LOT. 4. DP.10683	,

DE

CLIENT: Mr.& Mrs. DRAWING WASTE MINIMIS MATERI

WASTE MINIMISATION AND SORTING

THE AIM OF THIS SECTION IS TO ASSIST IN REDUCING THE AMOUNT OF MATERIAL GOING TO LANDFILL, AND TO INCREASE THE AMOUNT OF MATERIAL RECYCLED, THUS REDUCING ITS EMBODIED ENERGY AND INCREASING ITS USEFULNESS. THIS WILL ALSO RESULT IN SIGNIFICANT SAVINGS FOR THE PROJECT. WASTE MINIMISATION BEST PRACTICE SHALL BE ADHERED TO DURING THE COURSE OF THE WORKS.

 THE BUILDER SHALL KEEP THE WORKS CLEAN AND TIDY. THE BUILDER SHALL ISSUE A DIRECTIVE TO ALL PERSONS WORKING ON THE SITE, USING AN A3 (420mm x 300mm) SIGN IN THE MOST PROMINENT POSITION AS POSSIBLE, AS FOLLOW;

'DON'T GET WASTED - GET SORTED' EACH SUBCONTRACTOR IS RESPONSIBLE FOR THEIR WASTE AND RECYCLABLE MATERIAL IN THE APPROPRIATE CONTAINERS PROVIDED.

- 2. THE BUILDER SHALL PROVIDE RUBBISH CONTAINERS OR SKIPS AND REMOVE FROM THE SITE TO A SUITABLE RECYCLING STATION AS SOON AS THE CONTAINER IS FULL, IF THE MATERIAL IN NON-RECYCLABLE IT SHALL BE TAKEN TO A LICENCED LANDFILL. THE BUILDER IS RESPONSIBLE FOR PAYING ALL FEES AND CHARGES ASSOCIATED WITH DISPOSING MATERIALS NAD MUST KEEP RECEIPTS TO DOCUMENT WHERE THE MATERIAL HAS BEEN RECYCLED/DISPOSED OF. RUSBISH MUST NOT BE HEAPED ON THE GROUND OR PLACED ON THE GARDEN.
- 3. THE BUILDER SHALL ENSURE THAT ALL RUBBISH, WASTE AND OFFCUTS FROM EACH TRADE SUBCONTRACTOR SHALL BE PLACED BY THAT TRADE SUBCONTRACTOR INTO A CONTAINER OR SKIP BIN TO BE PROVIDED BY THE BUILDER.


ALL WASTE SHALL BE SORTED BY THE RELEVANT TRADE SUBCONTRACTORS INTO THE FOLLOWING CATAGORIES, AND DISPOSED OF AS SPECIFIED:

- FOOD SCRAPS & NON-RECYCLABLE FOOD CONTAINERS FROM WORKERS ON SITE: - RUBBISH BIN FOR CARRYING TO EITHER AN APPROVED LOCAL TRANSFER STATION, LICENCED LANDFILL, OR FOR WEEKLY COLLECTION BY COUNCIL IN AN APPROVED BIN. (THE BUILDER SHALL ENQUIRE OF COUNCIL AS TO WHICH DAYS COLLECTIONS ARE MADE).
- PAPER, BOTTLES AND CANS FROM WORKER'S PERSONAL WASTE: -RECYCLING CONTAINERS FOR WEEKLY COLLECTION BY COUNCIL AS ABOVE, OR TAKEN TO A LOCAL RECYCLING DEPOT IF NO PICKUP SERVICE IS AVAILABLE.
- PLASTIC PALLET WRAP: TO BE PLACED IN A DEDICATED AREA FOR PLASTIC RECYCLING WHERE AVAILABLE, OR PLACED IN THE GENERAL WASTE CONTAINER OR SKIP BIN IF NO OTHER OPTION EXISTS.
- STEEL PALLET STRAPS, STEEL OFF CUTS, ROOFING SHEETS, ALUMINIUM OFF CUTS ETC: - TO BE PLACED IN A DEDICATED SKIP BIN OR CONTAINER FOR RECYCLING.
- USED PALLETS: SHALL BE STACKED BY TYPE IN A LOCATION ALLOWING EASY TRUCK ACCESSFOR PICKUP BY SPECIALIST CONTRACTOR. THIS SHALL BE ORGANISED BY THE BUILDER.
- MASONRY WASTE, OFF CUTS: SHALL BE SENT IN PURE LOADS TO THE NEAREST LOCAL CRUSHER OR OTHER APPROVED RECYCLING CENTRE.
- TIMBER OFF CUTS: IF NOT CHEMICALLY TREATED OR PAINTED SHALL BE SENT FOR RECYCLING EITHER BY GRINDING INTO MULCH OR BY OTHER APPROVED METHOD. TREATED TIMBER SHALL BE SENT TO A LICENCED LANDFILL.
- PLASTERBOARD OFF CUTS: SHALL BE STACKED IN AN UNDERCOVER LOCATION THAT ALLOWS EASY TRUCK ACCESS FOR PICKUP BY A SPECIALIST CONTRACTOR. THIS SHALL BE ORGANISED BY THE PLASTERING CONTRACTOR OR THE BUILDER.
- ALL OTHER NON-RECYCLABLE WASTE: SHALL BE PLACED IN A SPECIFIED CONTAINER AND TAKEN TO A LICENCED LANDFILL STATION AT REGULAR INTERVALS.

ALL DEMOLITION MATERIALS, AND WASTE AND OFF CUTS SHALL BECOME THE PROPERTY OF THE BUILDER, AND SHALL BE PLACED IN THE CORRECT CONTAINER OR SKIP BIN PROVIDED, OR REMOVED FROM THE SITE BY THE CONTRACTOR AS SOON AS PRACTICABLE.

WITH THE EXCEPTION OF METALS, MASONRY MATERIALS AND TIMBER, AD HOC RUBBISH PILES ON THE GROUND ARE NOT PERMITTED, AND ALL RUBBISH AS DEFINED ABOVE SHALL BE SORTED IN AN ENCLOSED CONTAINER OR SKIP UNTIL FULL, AND THEN REMOVED. NO SUCH CONTAINER OR SKIP BIN MAY BE STORED IN ANY PLACE THAT CONTRAVENES COUNCIL DIRECTIVES.

VELOPMENT A	NPPLIC.	ATION	ISSUE
	DATE: 1	1st June, 2021	
.J.& T.Lowry G TITLE:	SCALE: A	s Shown	
MANAGEMENT & SE DETAILS &	DRAWN: L	K.S.	
ALS STORAGE		EF:2101 DA1	9 Rev. A

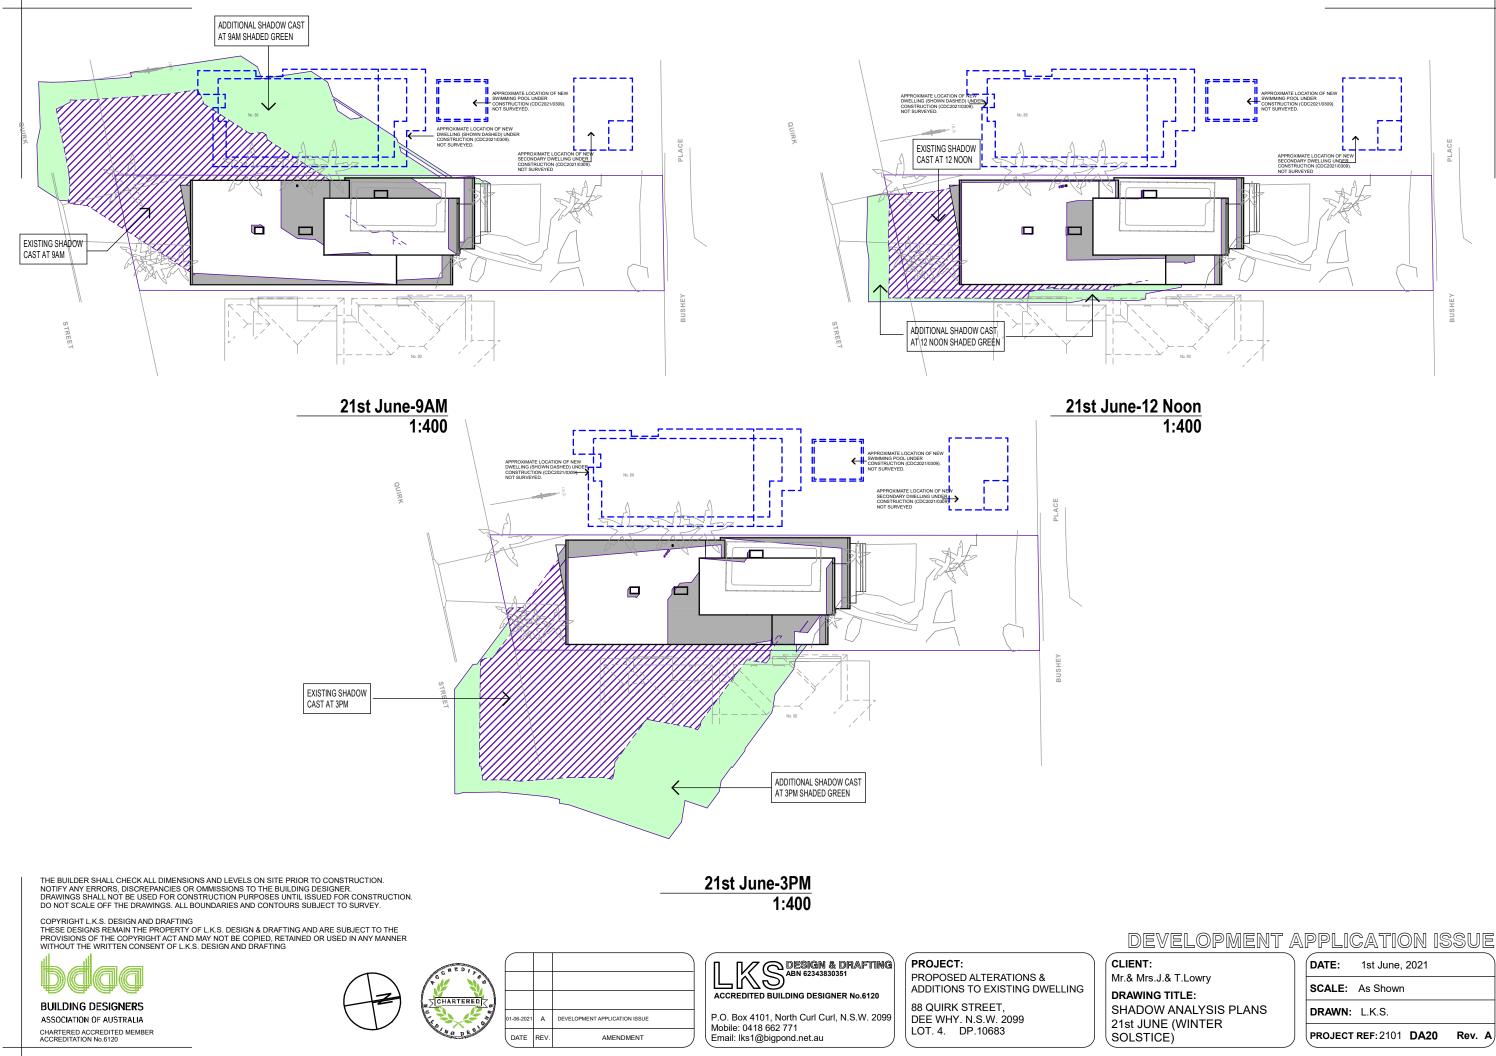

MATERIALS SPECIFICATION - SCHEDULE OF FINISHES - Existing Dwelling)

- ROOF COVERING :	LYSAGHTS, COLOURBOND KLIP & BARGE CAPPINGS. COLOUR E 'BASIX' MEDIUM SOLAR ABSORF
- ROOF INSULATION:	'KNAUF EARTHWOOL' 55MM FOI ROOF SHEETING. 'KNAUF EART
- ROOF GUTTERS:	SELECT COLOURBOND STEEL.
- RAINWATER PIPES:	SELECT COLOURBOND STEEL.
- CEILING LININGS:	GYPSUM PLASTERBOARD OVER
- WALL FRAMING:	90 x 45 TIMBER FRAMING TO A.S
- WALL COVERING :	SELECT CLADDING FIXED OVER VAPOUR PERMEABLE BUILDING
- WALLS INTERNAL:	GYPSUM PLASTERBOARD LININ FINISH AS DIRECTED.
- WALL INSULATION:	R2.5 'EARTHWOOL' WALL INSUL
- FLOOR FRAMING:	TIMBER FLOOR FRAMING THRO
- FLOORING :	REINFORCED CONCRETE FLOO 19MM STRUCTA FLOOR 'R FLOO 'SCYON SECURA' SHEET FLOOF CARPET TO OTHER AREAS AS D
- SOFFITT LININGS:	F.C.SHEET LININGS
- CORNICE:	GYPSUM PLASTERBOARD OR A
- SKIRTING & ARCHITRAVES:	AS SELECTED BY THE OWNERS
- INTERNAL DOORS:	TIMBER PANELLED & AS SELEC
- WINDOWS & DOORS:	ALUMINIUM FRAMED WINDOWS HAVE WEATHER STRIPPING ALL THE ATTACHED 'BASIX' CERTIFIC





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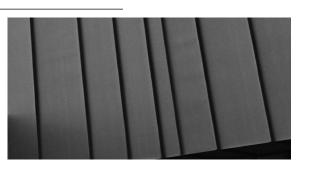
MATCHING FACE BRICKWORK



'ENVIROSEAL PROCTORWRAP' RESIDENTIAL VAPOUR PERMEABLE BUILDING WRAP



KNAUF EARTHWOOL ROOFING BLANKET WITH FOIL FACING 55mm THICK TO COMPLY WITH THE 'BASIX' CERTIFICATE No.A416055



SELECT CLADDING FIXED OVER VAPOUR PERMEABLE BUILDING WRAP TO MANUFACTURERS SPECIFICATIONS.



ALUMINIUM FRAMED WINDOWS & EXTERNAL DOORS. GLAZING SHALL COMPLY WITH THE ATTACHED 'BASIX' CERTIFICATE No.A416055.



SHADE PROJECTIONS OVER WINDOWS AS REQUIRED BY THE BASIX CERTIFICATE.



SELECT GLAZED BALLUSTRADE TO BALCONYS TO COMPLY WITH A.S.1288, A.S.1657 & A.S. 2047, NCC.-B.C.A. PART 3.6, 3.9.1 & 3.9.2


THE BUILDER SHALL CHECK ALL DIMENSIONS AND LEVELS ON SITE PRIOR TO CONSTRUCTION. NOTIFY ANY ERRORS, DISCREPANCIES OR OMMISSIONS TO THE BUILDING DESIGNER. DRAWINGS SHALL NOT BE USED FOR CONSTRUCTION PURPOSES UNTIL ISSUED FOR CONSTRUCTION. DO NOT SCALE OFF THE DRAWINGS. ALL BOUNDARIES AND CONTOURS SUBJECT TO SURVEY.

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BUILDING DESIGNERS ASSOCIATION OF AUSTRALIA CHARTERED ACCREDITED MEMBER ACCREDITATION No.6120





'KNAUFINSULATION' GLASSWOOL-EARTHWOOL BATTS

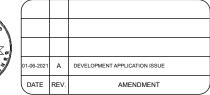& R3.5 CEILING INSULATION BATTS BETWEEN RAFTERS

R2.5 EXTERNAL WALL INSULATION BATTS

Π	DESIGN & DRAFTING	
ACC	REDITED BUILDING DESIGNER No 6120	

88 QUIRK STREET, P.O. Box 4101, North Curl Curl, N.S.W. 2099 DEE WHY. N.S.W. 2099 Mobile: 0418 662 771 LOT. 4. DP.10683 Email: lks1@bigpond.net.au

PROJECT:

PROPOSED ALTERATIONS &

ADDITIONS TO EXISTING DWELLING

SHEET



KLIPLOK ROOF SHEETING, RIDGE, HIP PUR BCA CLASSIFICATION - MEDIUM. ORPTANCE - 0.475 - 0.7

FOIL BACKED INSULATION BLANKET UNDER ARTHWOOL' R2.5 INSULATION CEILINGS BATTS

OVER R2.5 'EARTHWOOL' CEILING INSULATION.

A.S.1684.4.2010

VER 'ENVIROSEAL PROCTORWRAP' DING WRAP. COLOUR AS SELECTED BY OWNERS

ININGS TO NEW FRAMED WALLS. PAINT

SULATION THROUGHOUT.

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LOOR TO LOWER LEVEL. LOOR' SHEET FLOORING. 19MM JAMES HARDIE OOR TO WET AREAS. TILES TO WET AREAS. AS DIRECTED.

OR AS SELECTED BY THE OWNERS

IERS

LECTED BY THE OWNERS.

OWS & DOORS. WINDOWS & DOORS SHALL ALL ROUND, & GLAZING SHALL COMPLY WITH FIFICATE A416055 DATED 27th MAY, 2021



BLUESCOPE STEEL COLOURBOND TRIMDECK ROOF SHEETING AND CAPPINGS. COLOUR TO COMPLY WITH BCA CLASSIFICATION OF MEDIUM (SOLAR ABSORPTANCE 0.475 - 0.70)

DEVELOPMENT APPLICATION ISSUE

MATERIALS FINISHES SAMPLE

DATE: 1st June, 2021 SCALE: As Shown

DRAWN: L.K.S.

PROJECT REF: 2101 DA21

Rev. A