

EXISTING SITE IMAGES



TREE SURVEY					
Existing Trees based on Visual recognition by Conzept Landscape Architects					
No.#	Species	Size (Ht x Sp)	Condition	Action	
1	Frangipani	3x3	Good	Retain	
2	Frangipani	3x3	Good	Retain	
3	Hibiscus hedges	2x2	Good	Remove	
4	3x Cordyline	3x0.5	Good	Retain	
5	Kentia palm	5x1.5	Good	Remove	
6	Kentia palm	5x1.5	Good	Remove	
7	Kentia palm	5x1.5	Good	Retain	
8	Kentia palm	5x1.5	Good	Retain	
9	Kentia palm	5x1.5	Good	Retain	
10	Kentia palm	5x1.5	Good	Retain	
11	Banksia integrifolia	5x7	Good	Retain	
12	Kentia palm			Remove	
13	Banksia integrifolia	5x4	Good	Retain	
14	9x Kentia	3-6x1-2	Good	Remove	
15	Banksia integrifolia	3x2	Good	Retain	
16	Kentia palm	5x1.5	Good	Retain	
17	Viburnum hedges	1-1.5	Good	Remove	

General Notes:
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DIAL 1100 BEFORE YOU DIG

SCALE:

Bar Scale
0 1 2 3 4 5m

1:150 @ A3

REV	DATE	NOTATION/AMENDMENT
A	11.8.2023	Preliminary plan prepared for review
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COUNCIL
NORTHERN BEACHES

CLIENT
KALLOGLIAN INVESTMENTS PTY LTD

ARCHITECT
BJB ARCHITECTS

STATUS / ISSUE
DA - ISSUE E

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TITLE:
SITE CONDITIONS

PROPOSED RESIDENTIAL DEVELOPMENT
15 OCEAN ROAD
PALM BEACH


DWG.No:
LPDA 24 - 029 / 1

DATE:
MARCH 2024

DRAWN:
L.Z/K.Z

CHECKED:
R.F

TITLE: HARDSCAPE PLAN PROPOSED RESIDENTIAL DEVELOPMENT 15 OCEAN ROAD PALM BEACH	DWG No: LPDA 24 - 029 / 2	
	DATE: MARCH 2024	
	DRAWN: L.Z./K.Z	CHECKED: R.F

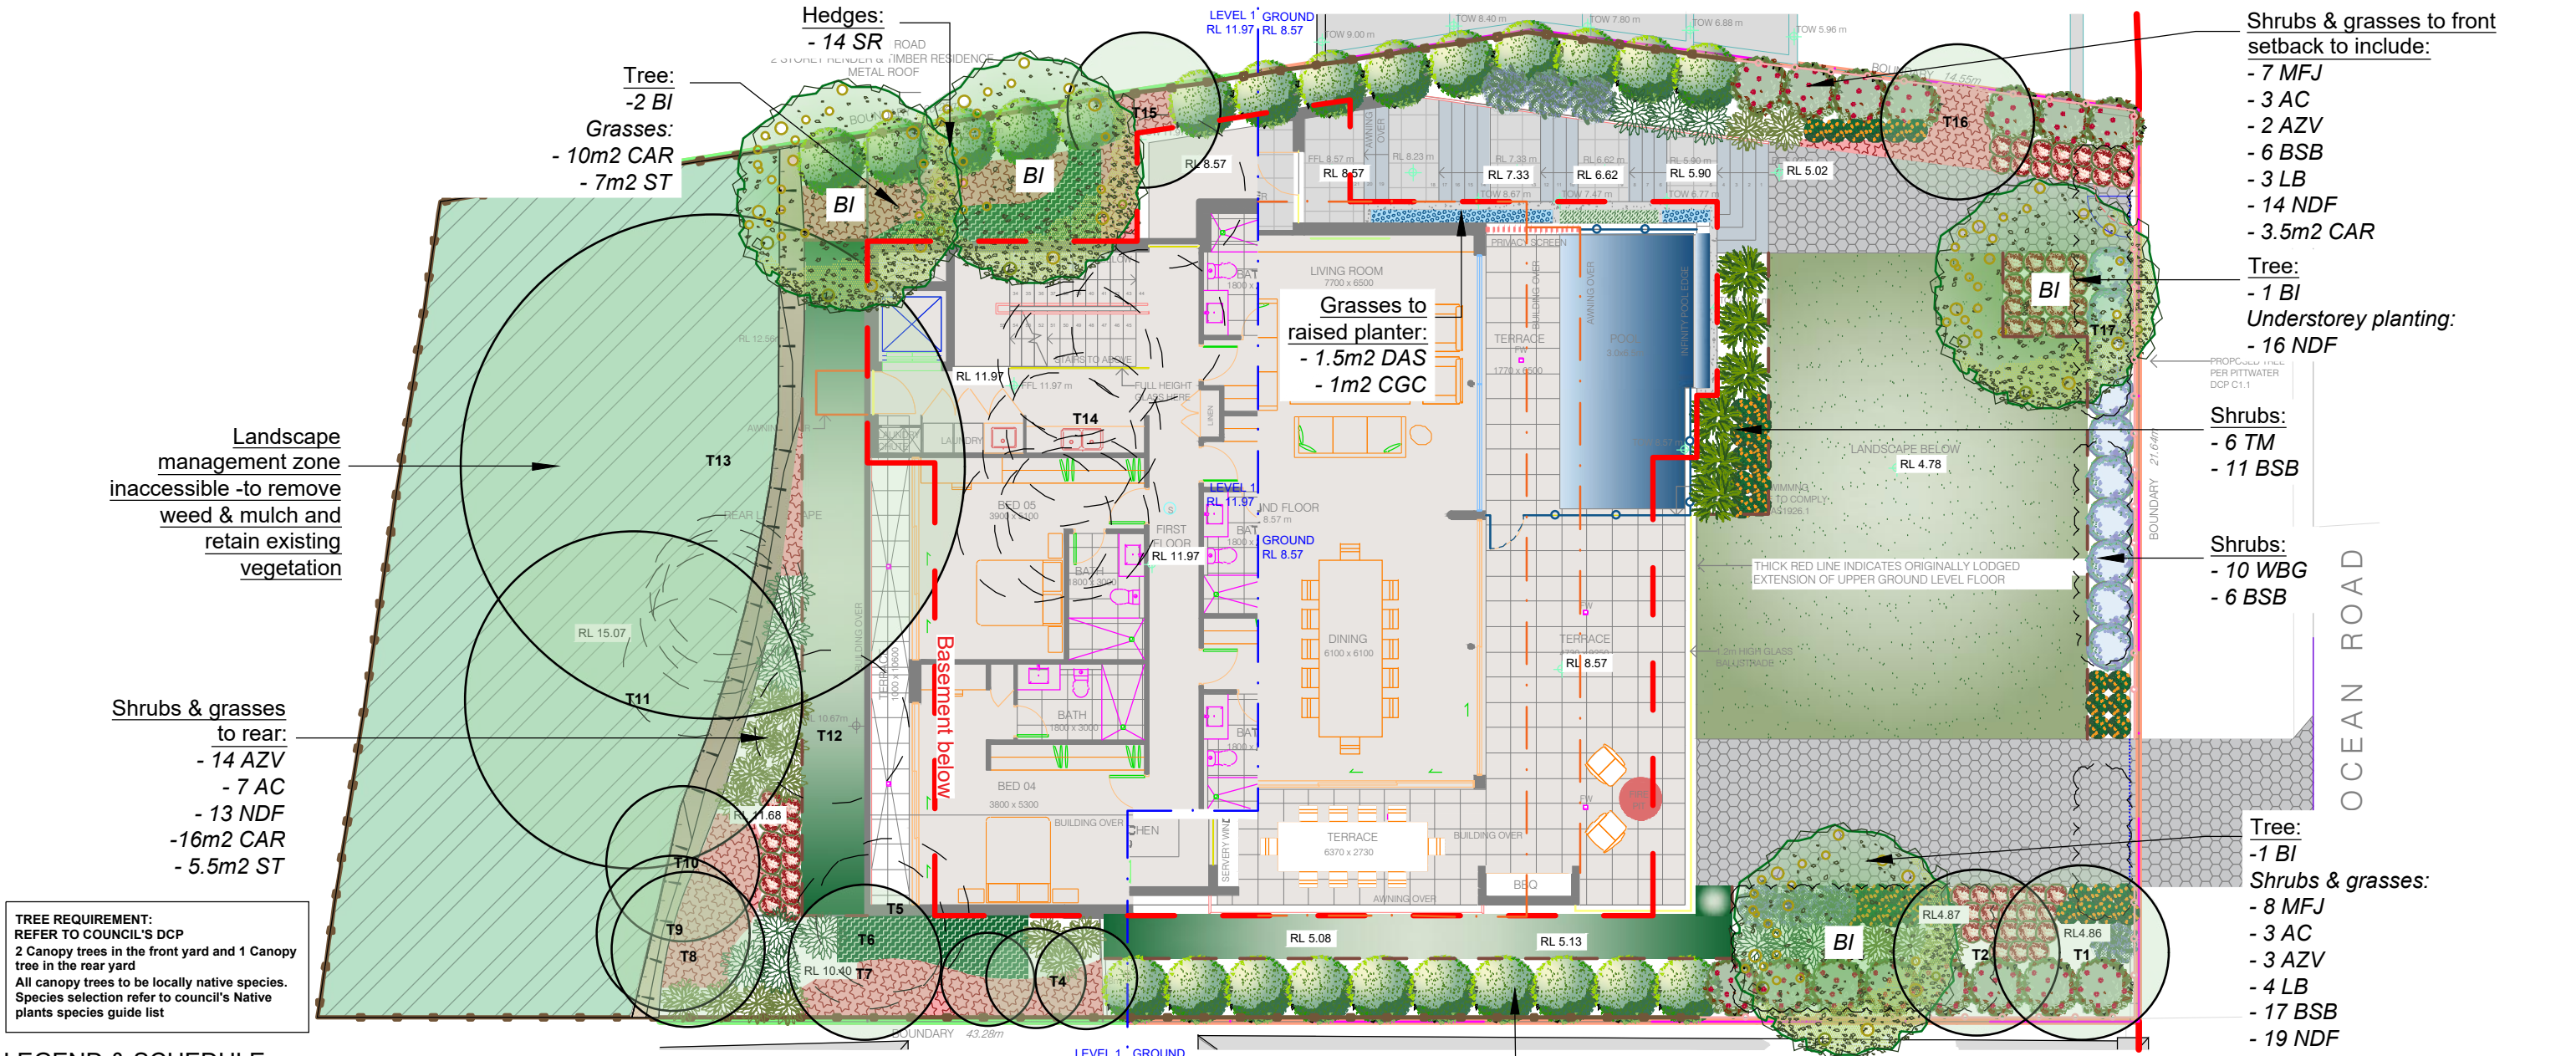

LEGEND & SCHEDULE

NOTES:

1. ALL FINAL PLANT QUANTITIES INDICATED ON PLANS SHALL BE CHECKED AND VERIFIED BY SUCCESSFUL LANDSCAPE CONTRACTOR.
2. ANY PLANT SUBSTITUTES REQUIRED DUE TO UNAVAILABILITY SHALL BE RECOMMENDED BY THE LANDSCAPE CONTRACTOR TO BEST MATCH SUBSTITUTED PLANTS AND APPROVED PRIOR TO PURCHASING BY THE LANDSCAPE ARCHITECT.
3. WORKS CERTIFIED FOR FINAL OCCUPANCY CERTIFICATE ARE TO MATCH APPROVED LANDSCAPE PLANS.
4. LANDSCAPE CONTRACTOR SHALL LOCATE AND AVOID SITE STORM WATER & DRAINAGE SERVICES. LOCATE TREES A MINIMUM 1.25M FROM PITS
5. ALL PLANTING AROUND EXISTING TREES SHALL BE ADJUSTED TO AVOID DAMAGE AND CLASHING WITH SURFACE ROOTS.
6. THE NATURE STRIP (STREET FRONTAGE) FOR THE SITE IS PUBLIC LAND, AND ONLY AUTHORIZED WORKS MAY OCCUR HERE. EXISTING CONDITIONS SUCH AS STREET TREES, COUNCIL PLANTING ETC SHALL BE RETAINED AND PROTECTED DURING CONSTRUCTION, UNLESS SPECIFIC APPROVAL HAS BEEN GRANTED FOR NEW WORK IN THIS AREA.

TREES	
BI	Botanical Name: <i>Banksia integrifolia</i> Common Name: Coastal Banksia (Native) Pot size: 75Lt Mature H x S: 6-8m x 4-5m Qty Required: 4
SHRUBS AND HEDGES	
WBG	Botanical Name: <i>Westringia 'Blue Gem'</i> Common Name: B. Gem Coastal Rosemary (Native) Pot size: 200mm Mature H x S: 1.5m x 1.3m Qty Required: 10
SR	Botanical Name: <i>Syzygium 'Resilience'</i> Common Name: Resilience Lilly Pilly (Native) Pot size: 200mm Mature H x S: 3m x 2m Qty Required: 24
BSB	Botanical Name: <i>Banksia spinulosa 'Birthday Candles'</i> Common Name: Banksia Birthday Candles (Native) Pot size: 200mm Mature H x S: 0.6m x 0.6m Qty Required: 40
NDF	Botanical Name: <i>Nandina domestica 'Flirt'</i> Common Name: Heavenly Bamboo (Exotic) Pot size: 200mm Mature H x S: 0.3-0.6m x 0.5m Qty Required: 62
LB	Botanical Name: <i>Leucophyta brownii</i> Common Name: Cushion Bush (Native) Pot size: 200mm Mature H x S: 1.2m x 1.2m Qty Required: 7
TM	Botanical Name: <i>Thysanolaena maxima</i> Common Name: Tiger Grass (Exotic) Pot size: 300mm Mature H x S: 2m x 2m Qty Required: 6
MFJ	Botanical Name: <i>Metrosideros 'Fiji Fire'</i> Common Name: NZ Christmas Bush (Exotic) Pot size: 200mm Mature H x S: 2m x 1.8m Qty Required: 15
AC	Botanical Name: <i>Alpinia caerulea</i> Common Name: Native Ginger (Native) Pot size: 200mm Mature H x S: 1.8m x 0.8m Qty Required: 13
AZV	Botanical Name: <i>Alpinia zerumbet 'Variegata'</i> Common Name: Variegated Shell Ginger (Exotic) Pot size: 200mm Mature H x S: 1.8m x 0.8m Qty Required: 16
DAS	Botanical Name: <i>Dichondra argentea 'Silver Falls'</i> Common Name: Silver Falls Dichondra (Exotic) Pot size: 140mm Mature H x S: 0.15m x spreading Qty Required: 9/m2 (1.5m2 total)
CGC	Botanical Name: <i>Casuarina glauca 'Cousin It'</i> Common Name: Cousin It Casuarina (Native) Pot size: 140mm Mature H x S: 0.1m x 1.5m Qty Required: 5/m2 (1m2 total)
CAR	Botanical Name: <i>Carpobrotus 'Aussie Rambler'</i> Common Name: Aussie Rambler Pigface (Native) Pot size: 140mm Mature H x S: 0.25m x spreading Qty Required: 7/m2 (29.5m2 total)
ST	Botanical Name: <i>Sanseveria trifasciata</i> Common Name: Snake Plant (Exotic) Pot size: 140mm Mature H x S: 0.8m x 0.5m Qty Required: 5/m2 (12.5m2 total)

General Notes:


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COUNCIL	NORTHERN BEACHES
CLIENT	KALLOGLIAN INVESTMENTS PTY LTD
ARCHITECT	BJB ARCHITECTS
STATUS / ISSUE	DA - ISSUE E



TITLE:	LANDSCAPE PLAN - GF & LEVEL 1	DWG.No:	LPDA 24 - 029 / 3
	PROPOSED RESIDENTIAL DEVELOPMENT	DATE:	MARCH 2024
	15 OCEAN ROAD	DRAWN:	L.Z/K.Z
	PALM BEACH	CHECKED:	R.F

LEGEND & SCHEDULE

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SUCCULENTS & GRASSES

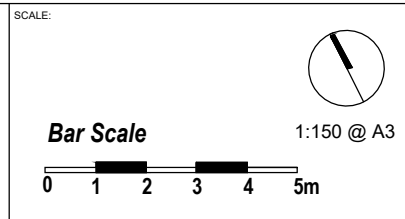- APB

Botanical Name: *Aloe 'Pink Brush'*
Common Name: Pink Brush Aloe (Exotic)
Pot size: 200mm
Mature H x S: 0.3m x 0.3m
Qty Required: 39
- ABG

Botanical Name: *Agave 'Blue Glow'*
Common Name: Blue Glow Agave (Exotic)
Pot size: 45Lt
Mature H x S: 0.6m x 0.75m
Qty Required: 19
- ES

Botanical Name: *Echinocactus spp*
Common Name: Golden barrel cactus (Exotic)
Pot size: 200mm
Mature H x S: 0.3m x 0.3m
Qty Required: 27
- LG


Botanical Name: *Lomandra.f glauca*
Common Name: Blue fescue (Exotic)
Pot size: 100mm
Mature H x S: 0.25m x 0.3m
Qty Required: 57
- DAS

Botanical Name: *Dichondra argentea 'Silver Falls'*
Common Name: Silver Falls Dichondra (Exotic)
Pot size: 140mm
Mature H x S: 0.15m x spreading
Qty Required: 9/m2 (**9.0m2 total**)
- CAR

Botanical Name: *Carpobrotus 'Aussie Rambler'*
Common Name: Aussie Rambler Pigface (Native)
Pot size: 140mm
Mature H x S: 0.25m x spreading
Qty Required: 7/m2 (**8.0m2 total**)
- SS

Botanical Name: *Senecio serpens*
Common Name: Blue Chalk sticks (Exotic)
Pot size: 140mm
Mature H x S: 0.2m x 0.4m
Qty Required: 5/m2 (**5.0m2 total**)
- RP

Botanical Name: *Rosmarinus prostratus*
Common Name: Creeping Rosemary (Native)
Pot size: Tube stock
Mature H x S: 0.15m x spreading
Qty Required: 9/m2 (**8.0m2 total**)

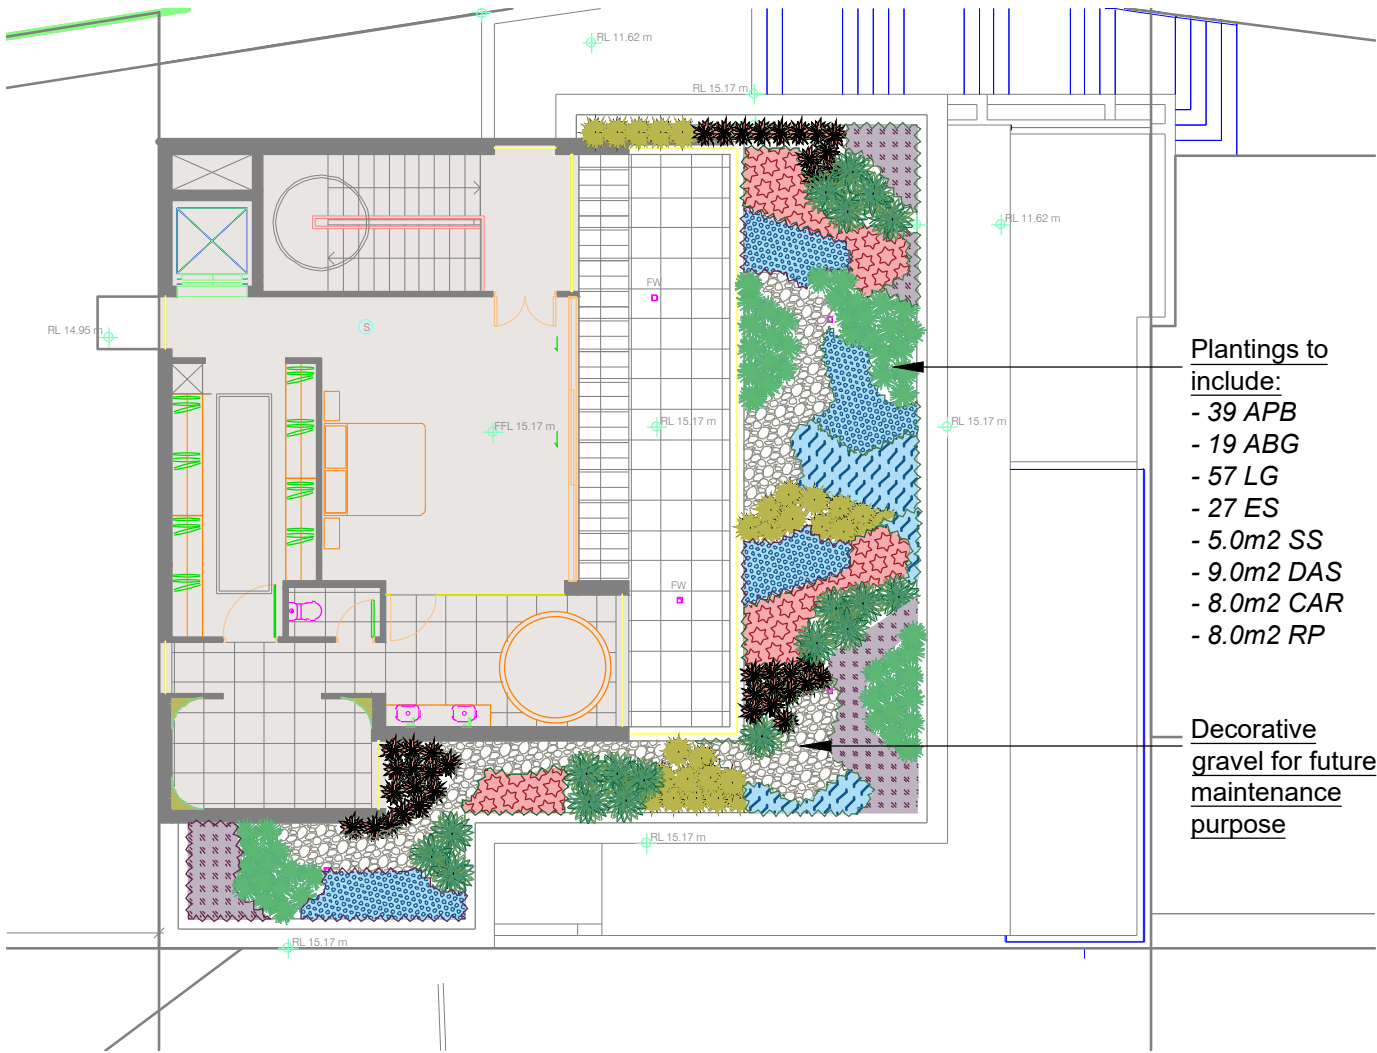

Plantings to include:

- 39 APB
- 19 ABG
- 57 LG
- 27 ES
- 5.0m2 SS
- 9.0m2 DAS
- 8.0m2 CAR
- 8.0m2 RP

Decorative gravel for future maintenance purpose

SAMPLE IMAGES

IMAGES ARE FOR DESIGN INTENT ONLY, FINAL PLANTING SPECIES & PRODUCTS MAY VARY, AS DETERMINED BY COUNCIL APPROVAL.



Banksia integrifolia



Metrosideros 'Fiji Fire'



Syzygium 'Resilience'



Banksia spinulosa 'Birthday Candles'



Alpinia zerumbet 'Variegata'



Thysanolaena maxima



Alpinia caerulea



Nandina domestica 'Flirt'



Dichondra argentea 'Silver Falls'




Leucophyta brownii



IMAGE: FYTOGREEN

DETAILS TO BE REVIEWED BY ENGINEER. PROPRIETARY ITEM TO SUPPLIER'S DETAILS. SHOP DRAWINGS TO BE PROVIDED BY SUCCESSFUL CONTRACTOR/SUPPLIER

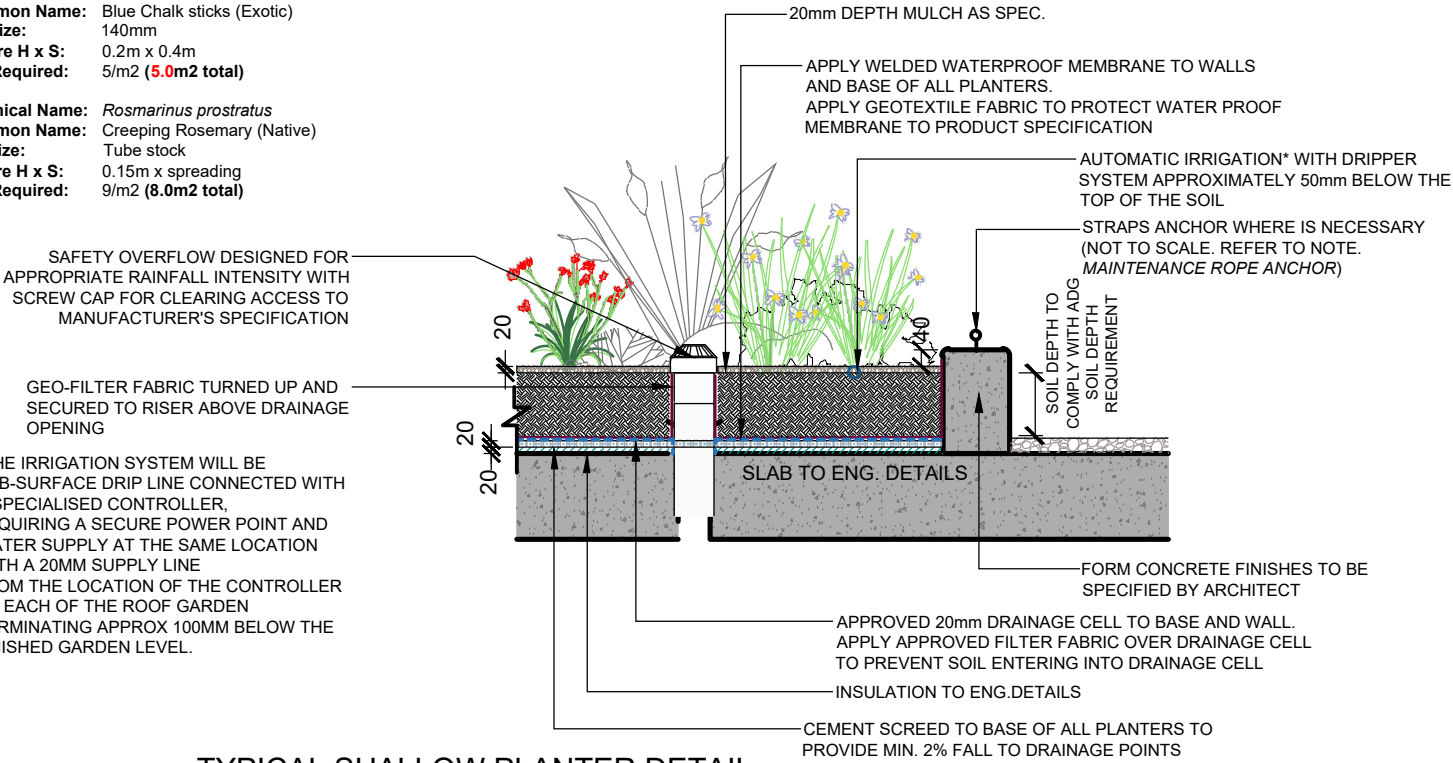

TYPICAL SHALLOW PLANTER DETAIL
SCALE: n.t.s

General Notes:

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AILA Associate

Australian Institute of Landscape Architects

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DIAL 1100 BEFORE YOU DIG

SCALE:

Bar Scale

1:150 @ A3

0 1 2 3 4 5m

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COUNCIL

NORTHERN BEACHES

CLIENT

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ARCHITECT

BJB ARCHITECTS

STATUS / ISSUE

DA - ISSUE E

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TITLE:

LANDSCAPE PLAN
- LEVEL 2

PROPOSED RESIDENTIAL
DEVELOPMENT
15 OCEAN ROAD
PALM BEACH

DWG.No:

LPDA 24 - 029 / 4

DATE:

MARCH 2024

DRAWN:

L.Z/K.Z

CHECKED:

R.F




1. CHAIN WIRE MESH PANELS WITH SHADE CLOTH (IF REQUIRED) ATTACHED, HELD IN PLACE WITH CONCRETE FEET
2. ALTERNATIVE PLYWOOD OR WOODEN PALING FENCE PANELS. THE FENCING MATERIAL ALSO PREVENTS BUILDING MATERIALS OR SOIL ENTERING THE TPZ
3. MULCH INSTALLATION ACROSS SURFACE OF TPZ (AT THE DISCRETION OF THE PROJECT ARBORIST). NO EXCAVATION, CONSTRUCTION ACTIVITY, GRADE CHANGES, SURFACE TREATMENT OR STORAGE OF MATERIALS OF ANY KIND IS PERMITTED WITHIN THE TPZ
4. BRACING IS PERMISSIBLE WITHIN THE TPZ. INSTALLATION OF SUPPORTS TO AVOID DAMAGING ROOTS

PROVIDE FENCING AS DETAILED TO ALL TREES PROPOSED TO BE RETAINED ON THE SUBJECT SITE. FENCING TO BE LOCATED TO THE DRIP LINE OF TREES OR AS INDICATED ON PLANS OR DIRECTED ON-SITE BY ARBORIST. NO STOCKPILING WITHIN FENCE PERIMETERS.

TREE PROTECTION ZONE

N.T.S

TYPICAL SETBACK FROM LAWN/GARDEN EDGE

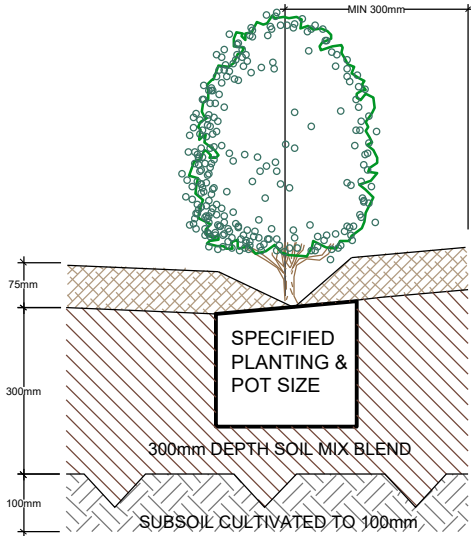

NOTE
THIS DETAIL IS ONLY APPLICABLE FOR PLANTING AREA OUTSIDE TREE PROTECTION ZONE OF TREES TO BE RETAINED. NO CHANGES ARE TO OCCUR TO EXISTING LEVELS, INCLUDING RIPPING/CULTIVATING OF THE SOIL WITHIN THE TPZ OF TREES TO BE RETAINED ON SITE

75mm DEPTH "FOREST FINE" MULCH OR EQUIVALENT


SOIL MIX:

50% OF STOCKPILED SITE TOPSOIL FREE FROM ALL BUILDER'S RUBBISH AND DELETERIOUS MATERIALS. TOPSOIL TO BE MIXED WITH MINIMUM 50% IMPORTED GARDEN MIX OR SOIL CONDITIONER/ COMPOSTED ORGANIC MATTER - SEE SPEC. USE 100% IMPORTED SOIL MIX WHEN SITE TOPSOIL RUNS OUT.

TYPICAL GARDEN PREPARATION DETAIL


SCALE 1:10

NOTE: TYPICAL DETAIL ONLY. ALL WALLS WHICH FORM PART OF DRAINAGE WORKS MUST BE BUILT AS DETAILED BY THE HYDRAULIC ENGINEER. ALL WALLS EXCEEDING 1m HEIGHT SHALL BE DETAILED BY A QUALIFIED ENGINEER. INSTALL WALL TO SUIT SITE LEVELS AND TO MANUFACTURE'S SPECIFICATION.

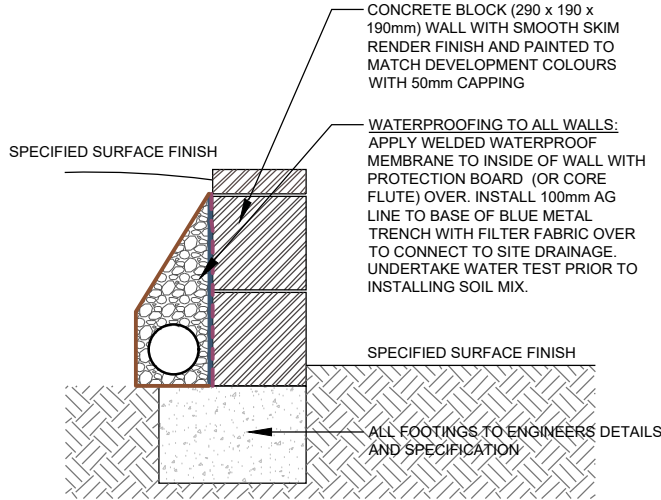

TYPICAL RETAINING WALL DETAIL


SCALE 1:10

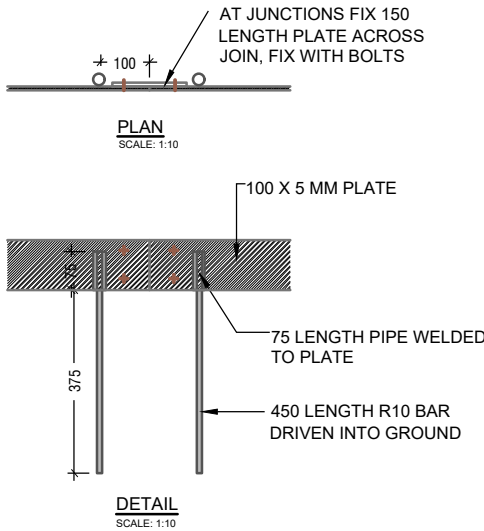

STEEL EDGE & TURF DETAIL

SCALE: 1:10

REFER GARDEN PREP DETAIL

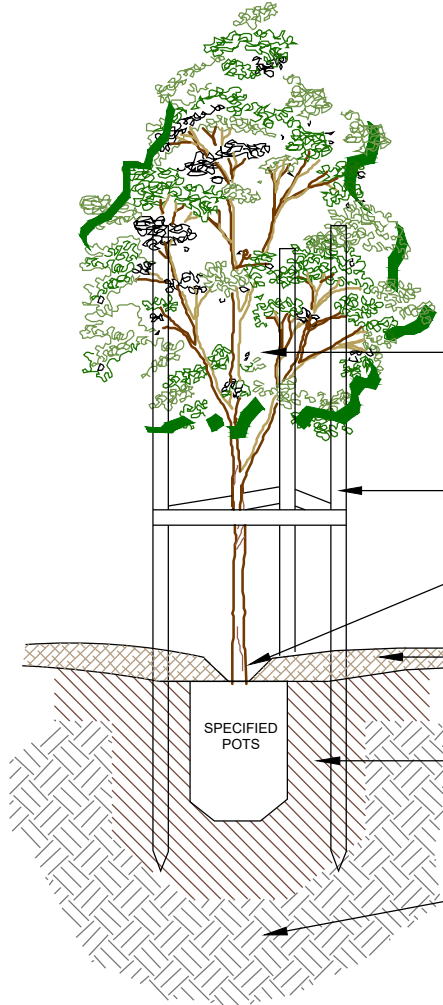

NOTE: DRIP IRRIGATION MAY BE REQUIRED AS NOMINATED BY CLIENT & DESIGNED BY LICENCED CONTRACTOR. PLANT STOCK SHALL BE SOURCED FROM GROWERS CONFORMING TO AS2303:2019. 'TREE STOCK FOR LANDSCAPE USE'. THOROUGHLY WATER IN ALL NEWLY PLANTED STOCK IMMEDIATELY AFTER PLANTING.

QUALITY OF PLANT TO BE APPROVED BY PROJECT MANAGER OR LANDSCAPE ARCHITECT

PROVIDE 3 HARDWOOD STAKES 1.8m X 50mm X 50mm FOR ALL TREES. USE 50mm HESSIAN TIES TO SECURE LOWER TRUNK TO STAKES

PROVIDE SLIGHT DEPRESSION TO ALLOW FOR EFFECTIVE WATERING

75mm 'FOREST FINE' MULCH OR EQUAL

BACKFILL HOLE WITH CLEAN, TESTED SITE TOP-SOIL BLEND OR IMPORTED SOIL MIX APPROVED BY LANDSCAPE ARCHITECT

CULTIVATE/ RIP SUBGRADE

TREE PLANTING DETAIL

SCALE: NTS

(ONLY APPLICABLE FOR PLANTING AREA OUTSIDE TREE PROTECTION ZONE OF TREES TO BE RETAINED. NO CHANGES ARE TO OCCUR TO EXISTING LEVELS, INCLUDING RIPPING/CULTIVATING OF THE SOIL WITHIN THE TPZ OF TREES TO BE RETAINED ON SITE)

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ARCHITECT	BJB ARCHITECTS
STATUS / ISSUE	DA - ISSUE E



TITLE:
DETAILS 1

PROPOSED RESIDENTIAL DEVELOPMENT
**15 OCEAN ROAD
PALM BEACH**

DWG.No:	LPDA 24 - 029 / 5
DATE:	MARCH 2024
DRAWN:	L.Z/K.Z
CHECKED:	R.F

PRELIMINARIES

1.01 GENERAL

The following general conditions should be considered prior to the commencement of landscape works:

- The landscape plans should be read in conjunction with the architectural plans, hydraulic plans, service plans and survey prepared for the proposed development.
- All services including existing drainage should be accurately located prior to the commencement of landscape installation. Any proposed tree planting which falls close to services will be relocated on site under the instruction of the landscape architect.
- Installation of conduit for required irrigation, electrical and other services shall be completed prior to the commencement of hardscape works and hardstand pours.
- All outdoor lighting specified by architect or client to be installed by qualified electrician
- Anomalies that occur in these plans should be brought to our immediate attention.
- Where an Australian Standard applies for any landscape material testing or installation technique, that standard shall be followed.

1.02 PROTECTION OF ADJACENT FINISHES

The Contractor shall take all precautions to prevent damage to all or any adjacent finishes by providing adequate protection to these areas / surfaces prior to the commencement of the Works

1.03 PROTECTION OF EXISTING TREES

Existing trees identified to be retained shall be done so in accordance with AS 4970-2009 Protection of trees on development sites as well as in accordance with the tree protection measures prepared by project arborist.

Where general works are occurring around such trees, or pruning is required, a qualified Arborist shall be engaged to oversee such works and manage tree health. Existing trees designated on the drawing for retention shall be protected at all times during the construction period. Any soil within the drip-line of existing trees shall be excavated and removed by hand only. No stockpiling shall occur within the root zone of existing trees to be retained.

Any roots larger in diameter than 50mm shall only be severed under instruction by a qualified arborist. Roots smaller than 50mm diameter shall be cut cleanly with a saw.

Temporary fencing shall be installed around the base of all trees to be retained prior to the commencement of landscape works. Where possible this fencing will be located around the drip line of these trees, or a minimum of 3m from the trunk. The fencing shall be maintained for the full construction period.

1.04 EROSION & POLLUTION CONTROL

The Contractor shall take all proper precautions to prevent the erosion of soil from the subject site. The contractor shall install erosion & sediment control barriers and as required by council, and maintain these barriers throughout the construction period. Note that the sediment control measures adopted should reflect the soil type and erosion characteristics of the site.

- Erosion & pollution control measures shall incorporate the following:
 - Construction of a sediment trap at the vehicle access point to the subject site.
 - Sediment fencing using a geotextile filter fabric in the location indicated on the erosion control plan or as instructed on site by the landscape architect.
 - Earth banks to prevent scour of stockpiles
 - Sandbag kerb sediment traps
 - Straw bale & geotextile sediment filter.
 - Exposed banks shall be pegged with an approved Jute matting in preparation for mass planting

Refer to 'Guidelines for Erosion and Sediment Control on Building Sites' by DLWC (2000) for construction techniques

SOIL WORKS

2.01 MATERIALS

Specified Soil Conditioner (Generally to improve site soil)

The specified soil conditioner for site top-soil improvement shall be an organic mix complies with **AS 4454-2012 Composts, soil conditioners and mulches**. Note that for sites where soil testing indicates toxins or extremes in pH, or soils that are extremely poor, allow to excavate and supply 300mm of imported soil mix.

New gardens & proposed Planting

New garden and planting areas shall consist of a 50/50 mix of clean site soil (refer d) below) and imported soil. All mixes are to comply with **AS4419-2003 Soils for Landscaping and garden use**, & AS 4454 Composts, Soil conditioners & mulches.

Specified Soil Mix - Turf

The specified soil mix for all turf areas shall be a min 75mm layer of imported soil mix consisting of 80% washed river sand (reasonably coarse), and 20% composted organic matter equivalent to mushroom compost or soil conditioner, or other approved lawn top dress.

Site Topsoil

Site topsoil is to be clean and free of unwanted matter such as gravel, clay lumps, grass, weeds, tree roots, sticks, rubbish and plastics, and any deleterious materials and materials toxic to plants. The topsoil must have a pH of between 5.5 and 7. Use 100% imported soil mix when site when site topsoil runs out.

2.02 INSTALLATION

Note: No level changes (Cut or Fill), soil ripping within the Tree Protection Zones of trees to be retained

a) Testing

All testing is to be conducted in accordance with AS4419-2003 Soils for Landscaping and garden use Methods for testing soils for engineering purposes. Site soil shall be given a pH test prior to modifying to ensure conditions are appropriate for planting as stated above. Tests shall be taken in several areas where planting is proposed, and the pH shall be adjusted accordingly with sulphur or lime to suit.

Note that a soil test conducted by the Sydney Environmental & Soil Laboratory or approved equal shall be prepared for all commercial, industrial and multi-unit residential sites. The successful landscape contractor shall implement the recommendations of this test.

b) Set Out of Individual Trees & Mass Planting Areas

All individual tree planting positions and areas designated for mass planting shall be set out with stakes or another form of marking, ready for inspection and approval. Locate all services.

c) Establishing Subgrade Levels

Subgrade levels are defined as the finished base levels prior to the placement of the specified material (i.e. soil conditioner). The following subgrade levels shall apply:

- Mass Planting Beds - 300mm below existing levels with specified imported soil mix.
- Turf areas - 100mm below finished surface level.

Note that all subgrades shall consist of a relatively free draining natural material, consisting of site topsoil placed previously by the Civil Contractor. No builders waste material shall be acceptable.

d) Subgrade Cultivation

Cultivate all subgrades to a minimum depth of 100mm in all planting beds and all turf areas, ensuring a thorough breakup of the subgrade into a reasonably coarse tilth. Grade subgrades to provide falls to surface and subsurface drains, prior to the placement of the final specified soil mix.

e) Drainage Works

Install surface and subsurface drainage where required and as detailed on the drawing. Drain subsurface drains to outlets provided, with a minimum fall of 1:100 to outlets and / or service pits.

f) Placement and Preparation of Specified Soil Conditioner & Mixes.

- Trees in turf & beds - Holes shall be twice as wide as root ball and minimum 100mm deeper - backfill hole with 50/50 mix of clean site soil and imported "Organic Garden Mix" as supplied by ANL or approved equal.
- Mass Planting Beds - Install specified soil conditioner to a compacted depth of 100mm

Place the specified soil conditioner to the required compacted depth and use a rotary hoe to thoroughly mix the conditioner into the top 300mm of garden bed soil. Ensure thorough mixing and the preparation of a reasonably fine tilth and good growing medium in preparation for planting.

- Turf Areas - Install specified soil mix to a minimum compacted depth of 75mm.
- Place the specified soil mix to the required compacted depth and grade to required finished soil levels, in preparation for planting and turfing.

PLANTING

3.01 MATERIALS

a) Quality and Size of Plant Material

All trees supplied above a 25L container size must be grown and planted in accordance with AS 2303:2019 *Tree stock for landscape use*. Certification that trees have been grown to AS2303:2018 guidelines is to be provided upon request of Council's Tree Management Officer.

Above - Ground Assessment:

The following plant quality assessment criteria should be followed:

Plant true to type, Good vigour and health, free from pest & disease, free from injury, self-supporting, good stem taper, has been pruned correctly, is apically dominant, has even crown symmetry, free from included bark & stem junctions, even trunk position in pot, good stem structure

Below - Ground Assessment:

Good root division & direction, rootball occupancy, rootball depth, height of crown, non-suckering For further explanation and description of these assessment criteria, refer to AS2303:2019.

All Plant material shall be to the type and size specified. No substitutions of plant material shall be permitted without written prior approval by the Landscape Architect. No plant shall be accepted which does not conform to the standards listed above.

b) Stakes and Ties

Provide min. 3 No. Stakes and ties to all plants identified as trees in the plant schedule. Stakes shall be sound, unpainted, straight hardwood, free of knots and pointed at one end. They shall be 2200mm x 50mm x 50mm Hardwood, or approved alternative. Ties shall be 50mm wide hessian webbing material.

c) Fertilisers

Fertilisers shall be approved slow release fertilisers suitable for the proposed planting types. Note that for native plants, specifically Proteaceae family plants including Grevillea species, low phosphorus fertilizers shall be used.

d) Mulch

Mulch shall be an approved equal to "FOREST FINE" as supplied by ANL. Mulch shall be completely free from any soil, weeds, rubbish or other debris.

e) Turf

Turf shall be soft leaf Buffalo or equivalent (unless stated otherwise), free from any weeds and other grasses, and be in a healthy growing condition.

3.02 INSTALLATION

a) Setting Out

All planting set out shall be in strict accordance with the drawings, or as directed. Note that proposed tree planting located near services should be adjusted at this stage. Notify Landscape Architect for inspection for approval prior to planting.

b) Planting

All plant material shall be planted as soon after delivery as possible. Planting holes for trees shall be excavated as detailed and specified. Plant containers shall be removed and discarded, and the outer roots gently teased from the soil mass. Immediately set plant in hole and backfill with specified soil mix, incorporating the approved quantity of fertiliser for each plant type. Ensure that plants are set plumb vertically and root balls set to the consolidated finished grades detailed on the drawings. Compact the backfilled soil and saturate by hand watering to expel any remaining air pockets immediately after planting.

c) Staking and Tying

Staking and tying shall be in strict accordance with the drawings and shall occur immediately following plant placement and soil backfilling. All plants identified as "Trees" on the planting schedule shall be staked with a min. 3 stakes.

d) Mulching

Mulch for general planter bed shall be an approved equal to "FOREST FINE" as supplied by ANL. Mulch shall be completely free from any soil, weeds, rubbish or other debris. Mulch for bio-retention/rain garden area where is required shall be non-floatable materials that could include crushed rock, gravel, coarse river sand, scoria or river pebbles. 4-7mm screenings or similar.

e) Turfing

Moisten soil prior to the turf being laid. Turf shall be neatly butt jointed and true to grade to finish flush with adjacent surfaces. Incorporate a lawn fertilizer and thoroughly water in. Keep turf moist until roots have taken and sods/rolls cannot be lifted. Keep all traffic off turf until this has occurred. Allow for top dressing of all turf areas. All turf shall be rolled immediately following installation.

f) Steel edging

Where is required, the Contractor shall install steel edging as detailed on the drawings, to all mass planting beds adjoining turf or gravel mulched areas, and where required. The resultant edge shall be true to line and flush with adjacent surfaces. However, no edging shall be used within the Structural Root Zone (SRZ) of trees to be retained.

g) Nature Strip and public domain works

The nature strip (street frontage) for the site is public land, and only authorized works may occur here.

Existing Conditions such as street trees, council planting etc shall be retained and protected during construction, unless specific approval has been granted for new work in this area. Where council policy specifies a particular unit paver, material finish, pattern or treatment, it shall be the contractors responsibility to check and verify that this material & treatment is correct and current prior to undertaking construction works'

f) Drainage pit

Drainage pits and drainage lines should be located within garden areas to allow for site drainage while minimising impact on the proposed planting scheme. where possible, pits and linework should be located at the edge of landscape strips to avoid precluding planting centrally in garden areas. where pits and linework occur within garden beds, the landscape contractor shall take all precautions to avoid damaging storm water when planting shrubs and trees. landscape contractors shall not alter the form of swales designed to direct overland flow.

HARDSCAPE WORKS

4.01 GENERAL

The Contractor shall undertake the installation of all hardscape works as detailed on the drawing, or where not detailed, by manufacturers specification.

- Paving - refer to typical details provided, and applicable Australian Standards. *Permeable paving may be used as a suitable means of satisfying Council permeable surface requirements, while providing a useable, hardwearing, practical surface.* In most instances, the client shall nominate the appropriate paving material to be used.

Australian Standards shall be adhered to in relation to all concrete, masonry & metal work. Some details are typical and may vary on site. All hardscape works shall be setout as per the drawings, and inspected and approved by the Landscape Architect prior to installation. All workmanship shall be of the highest standard. Any queries or problems that arise from hardscape variations should be bought to the attention of the Landscape Architect.

Your attention is directed to any obligations or responsibilities under the Dividing Fences Act, 1991 in respect of adjoining property owner/s which may arise from this application. Any enquiries in this regard may be made to the Crown Lands on 1300 886 235.

IRRIGATION WORKS

5.01 GENERAL (PERFORMANCE SPECIFICATION)

This is a general Irrigation Performance Specification only, as a guide for projects requiring irrigation systems as part of consent requirements or building contractual arrangements.

An automated irrigation system is recommended for the effective establishment of new gardens, and to assist with the success of planting areas on terraces, over slabs and in Communal Open Spaces.

The inclusion of this general specification is no guarantee that an irrigation system forms part of the landscape scope of works, which will be determined by the building contract.

New irrigation systems to planting areas shall be a Commercial Grade Irrigation System conforming to all relevant Australian standards, including AS 3500 & the Gas and Electricity (Consumer Safety) Act 2017, Workplace Health & Safety Act 2011, & the latest Sydney Water Code

An automated drip-irrigation system is to be installed to all gardens, planters and lawn areas in accordance with the approved Irrigation Design. This system shall be designed and installed by a qualified and licensed irrigation specialist, to the highest industry standards and to maximise the efficient usage of water.

Drawings:

- The Landscape Contractor nominated Licensed Irrigation Specialist shall provide irrigation drawings for approval upon engagement.

Design Requirements:

- The irrigation system shall be installed prior to all planting works. It shall incorporate a commercially available irrigation system, with sub-surface dripper lines to irrigate all gardens, planters and lawn areas.
- It shall incorporate a suitable back flow prevention device for the scale of works, an in-line filter, check valves, and suitable high and low density poly hose fittings and PVC piping to achieve flow rates suitable for specified planting.
- The irrigation application rate shall not exceed the infiltration rate of the soil or creates run-off.
- The landscape contractor shall check the existing pressure available from the ring mains and size irrigation piping to suit. Supply shall be from local hose cock where available.
- All piping and fittings shall be buried 50mm below the finished soil levels in garden and lawn areas, and secured in position at 500mm centres with galv wire pins.
- Size of pipes shall be selected to ensure the working pressure at the end of the line does not decrease by more than 5%.

Services Co-ordination:

- Co-ordination required by Landscape Contractor or Project Manager to provide required conduit, pipe work and penetration through slabs and planter walls for water and power provisions.
- The Landscape Contractor shall be engaged with the Irrigation Specialist to co-ordinate with the Project Manager to identify the preferred service and conduit locations.
- Project Manager and Landscape Contractor to establish area suitable for irrigation control system with required area, power provision and water supply.

Testing & Defects:

Upon completion of installation, the system shall be tested, including:

- Main Line Pressure Test: The main line is pressurised to test for leaks. All valves are shut and the pressure is taken over a determined length of time.
- Dripper Pressure Test: Measurement at flushing valves are taken and the pressure gauged to make sure it conforms to the manufacturer recommendations. The inlet pressure is then tested under the same conditions to check it does not exceed 300Kpa.
- All components are to be satisfactorily functional and operational prior to approval. Should any defect develop, or the capacity or efficiency of the system decline during the agreed maintenance system, then these faults shall be immediately rectified.

Warranty :

- A full 12 month warranty shall be included to cover labour and all parts.

Further Documentation:

- On request, a detailed irrigation performance specification report can be issued.

CONSOLIDATION AND MAINTENANCE

6.01 GENERAL

The consolidation and maintenance period shall be either


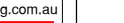
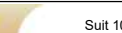
- 6 months beginning from the approved completion of the specified construction work (Practical Completion)
- as agreed to in the landscape contractors contractual obligations.
- or as specified by Council in the Determination.

A qualified landscape maintenance contractor shall undertake the required landscape maintenance works. Consolidation and maintenance shall mean the care and maintenance of Contracted works by accepted landscaping or horticultural practices, ensuring that all plants are in optimum growing conditions and appearance at all times, as well as rectifying any defects that become apparent in the contracted works.

This shall include, but not be limited to, the following items where and as required:

- Watering all planting and lawn areas / irrigation maintenance.
- Clearing litter and other debris from landscaped areas.
- Removing weeds, pruning and general plant maintenance.
- Replacement of damaged, stolen or unhealthy plants.
- Make good areas of soil subsidence or erosion.
- Topping up of mulched areas.
- Spray / treatment for Insect and disease control.
- Fertilizing with approved fertilizers at correct rates.
- Mowing lawns & trimming edges each 14 days in summer or 18 days in winter
- Adjusting ties to Stakes
- Maintenance of all paving, retaining and hardscape elements.

On the completion of the maintenance period, the landscape works shall be inspected and at the satisfaction of the superintendent or landscape architect, the responsibility will be signed over to the client.

<div>General Notes:</div> <div>Figured dimensions take precedence to scale readings. Verify all dimensions on site. PDF'd plans may vary slightly in scale for that indicated on plans. Report any discrepancies to the Landscape Architect before proceeding with the work.</div> <div>© Copyright Sulphurcrest Enterprises Pty Ltd Trading as CONCEPT</div> <div>(ABN: 75 623 405 630)</div> <div>This drawing is protected by copyright. All rights are reserved. Unless permitted under the Copyright Act 1968, no part of this drawing may in any form or by any means be reproduced, published, broadcast or transmitted without the prior written permission of the copyright owner.</div> <div>If the Status of this drawing is not signed off For Construction it may be subject to change, alteration or amendment at the discretion of our office. If so, Concept is not liable for any loss, damage, harm or injury whether special, consequential, direct or indirect, suffered by you or any other person as a result of your use of this drawing for construction purposes.</div> <div>These plans and associated IP remain the property of Sulphurcrest Enterprises (T/A Concept) until such time as all agreed payments are made in full. We retain the right to withdraw this information from the assessment process if such payments are not made following the notification period.</div>	<div><div>AILA Associate</div><div></div><div>Australian Institute of Landscape Architects</div></div> <div><div>www.dialbeforeyoudig.com.au</div><div></div></div>	SCALE:	REV	DATE	NOTATION/AMENDMENT	COUNCIL	<div></div> <div>Suit 101, 506 Miller Street, CAMMERAY NSW 2062</div> <div>Phone: 9922 5312 Fax: 8209 4982 Mob: 0413 861 351</div> <div>www.conzept.net.au enquiries@conzept.net.au</div>	TITLE: SPECIFICATION PROPOSED RESIDENTIAL DEVELOPMENT 15 OCEAN ROAD PALM BEACH	DWG.No: LPDA 24 - 029 / 6	
			A	11.8.2023	Preliminary plan prepared for review	NORTHERN BEACHES				DATE: MARCH 2024
			B	18.9.2023	Coordinated with architectural updates	CLIENT				
			C	22.9.2023	Final submission for DA	KALLOGLIAN INVESTMENTS PTY LTD				
			D	22.3.2024	Co-ordinated with amended architectural plan	ARCHITECT				
			E	25.3.2024	Co-ordinated with architect's comments	BJB ARCHITECTS				
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						DA - ISSUE E				
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