


SITE / ROOF / SEDIMENT EROSION / WASTE MANAGEMENT / STORMWATER CONCEPT PLAN

1:200

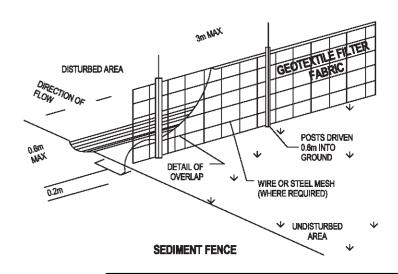

DUST CONTROL:

TO REDUCE DUST GENERATED BY WIND ACTION, THE REMOVAL OF THE TOP SOIL IS TO BE MINIMISED. TO PREVENT DUST GENERATION, WATERING DOWN OF THE SITE, ESPECIALLY DURING THE MOVEMENT OF MACHINERY IS REQUIRED. WHERE EXCAVATING INTO ROCK, KEEP THE SURFACE MOIST TO MINIMISE DUST. CONSTRUCT A GRAVEL ENTRY/EXIT POINT USING BLUE METAL AND RESTRICT ALL VEHICLE MOVEMENTS WITHIN THE SITE TO A MINIMUM, ENSURE WIND BREAKS, SUCH AS EXISTING FENCES ARE MAINTAINED DURING THE CONSTRUCTION PHASE UNTIL NEW LANDSCAPING IS PROVIDED OR REINSTATED. PREVENT DUST BY COVERING STOCKPILES

SEDIMENT NOTE:

1. ALL EROSION AND SEDIMENT CONTROL MEASURES TO BE INSPECTED AND MAINTAINED DAILY BY THE SITE MANAGER.

2. MINIMISE DISTURBED AREAS, REMOVE EXCESS SOIL FROM EXCAVATEDAREA AS SOON AS POSSIBLE. B. ALL MATERIAL STOCKPILE TO BE CLEAR FROM DRAINS, GUTTERS AND FOOTPATHS, OR WITHIN SEDIMENT FENCE AREA.

4. DRAINAGE TO BE CONNECTED TO STORMWATER AS SOON AS POSSIBLE. IF STORED ON SITE, IT MUST BE FILTERED BEFORE RELEASING INTO STORMWATER SYSTEM OR WATERWAYS

5. ROADS AND FOOTPATHS TO BE SWEPT DAILY.

STOCKPILES:

ALL STOCKPILES ARE TO BE KEPT ON-SITE WHERE POSSIBLE, ANY MATERIALS PLACED ON THE FOOTPATHS OR NATURE STRIPS REQUIRE COUNCIL'S PERMISSION.

ALL STOCKPILES ARE TO BE PLACED AWAY FROM THE DRAINAGE LINES AND STREET GUTTERS. IT IS BEST TO LOCATE THESE ON THE HIGHEST PART OF THE SITE IF POSSIBLE, PLACE WATERPROOF COVERING OVER STOCKPILES

IF REQUIRED PROVIDE DIVERSION DRAIN & BANK AROUND STOCKPILES.

GUTTER PROTECTION:


PROVIDE PROTECTION TO DOWNHILL GRATE IN GUTTER BY MEANS OF SAND BAGS OR BLUE METAL WRAPPED IN GEOTEXTILE FABRIC. WHEN SOIL OR SAND BUILDS UP AROUND THIS SEDIMENT BARRIER, THE MATERIAL SHOULD BE RELOCATED BACK TO THE SITE FOR DISPOSAL.

NOTE: ALL PROPOSED STORMWATER TO CONNECT WITH EXISTING




REV.	DATE	COMMENTS	DRWN	П
A	12/12/17	INITIAL DESIGN PLAN	AL	
В	21/12/17	FIRST DESIGN AMENDMENT	AL	ij
С	27/02/18	DA DOCUMENTATION	LR-P	;
				i



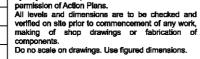



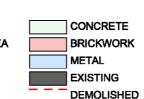

CLIENT CHRIS AND DANIELLE

PROJECT ADDRESS 141 RICKARD ROAD,

DATE NORTH NARRABEEN, NSW. 2101

DRAWING NO.

DA02


Thursday, 1 March

DRAWING NAME

SITE / ROOF / SEDIMENT **EROSION / WASTE** MANAGEMENT / STORMWATER CONCEPT PLAN

SCALE

1:200 @A3

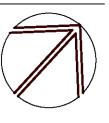


NORTHERN BEACHES COUNCIL

THIS PLAN IS TO BE READ IN **CONJUNCTION WITH**

Endorsement Date: 17/05/2018

DA2018/0376

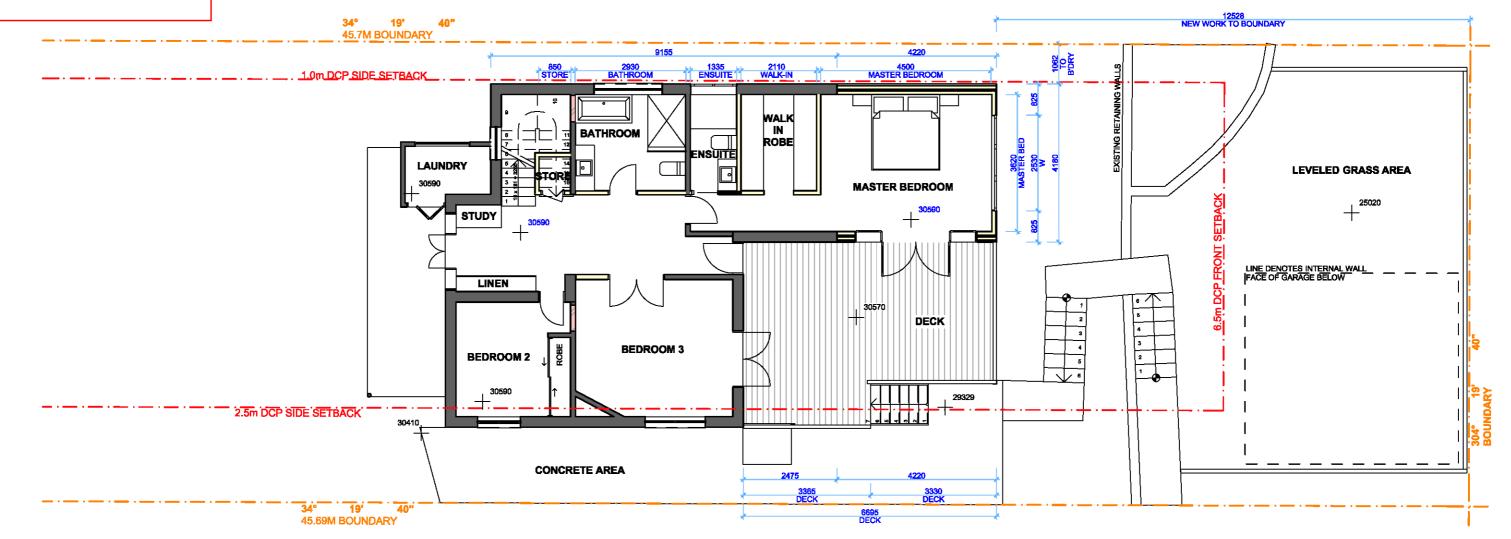





REV.	DATE	COMMENTS	DRWN
A	12/12/17	INITIAL DESIGN PLAN	AL
В	21/12/17	FIRST DESIGN AMENDMENT	AL
С	27/02/18	DA DOCUMENTATION	LR-P

IOTES	
his drawing is the copyright of Action Plans and not	
e altered, reproduced or transmitted in any form or	
y any means in part or in whole with the written	
ermission of Action Plans.	
Il levels and dimensions are to be checked and	
ertilled on site prior to commencement of any work	



	CLIENT
CONCRETE BRICKWORK	CHRIS AND DANIELLE
_	
METAL	PROJECT ADDRESS

NSW, 2101

DEMOLISHED


141 RICKARD ROAD,

NORTH NARRABEEN,

DRAWING NO.	
DA04	

PROPOSED GROUND FLOOR PLAN



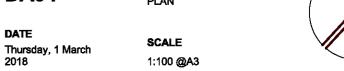


DRAWING NAME

NORTHERN BEACHES COUNCIL

THIS PLAN IS TO BE READ IN **CONJUNCTION WITH**

Endorsement Date: 17/05/2018

DA2018/0376

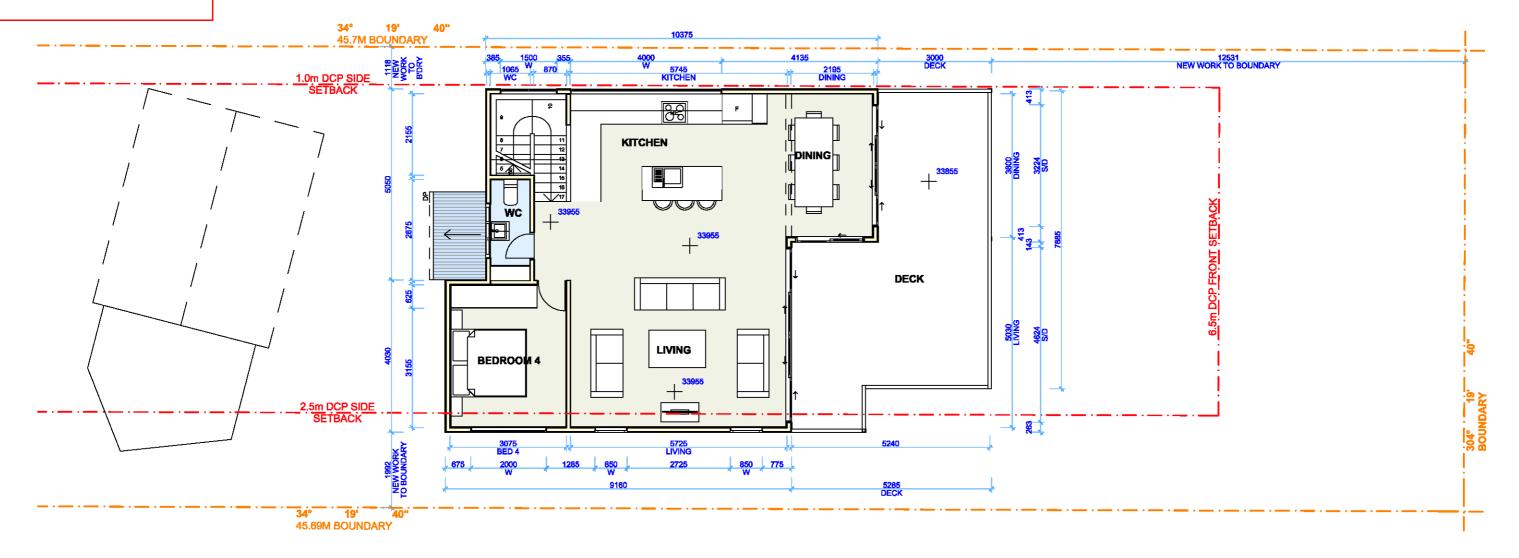






REV.	DATE	COMMENTS	DRWN	ı
A	12/12/17	INITIAL DESIGN PLAN	AL	
В	21/12/17	FIRST DESIGN AMENDMENT	AL	i
С	27/02/18	DA DOCUMENTATION	LR-P	1
				;
				ì

NOTES
This drawing is the copyright of Action Plans and not be altered, reproduced or transmitted in any form or
by any means in part or in whole with the written learnission of Action Plans.
All levels and dimensions are to be checked and

	LEGEND	l	
t		NEW FLOOR AREA	
'n		NEW WET FLOOR AREA	
d		METAL ROOFING	
r, ef		TILED ROOFING	
		TIMBER	_

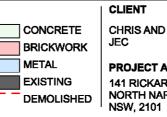

CHRIS AND DANIELLE

1
PROJECT ADDRESS
141 RICKARD ROAD, NORTH NARRABEEN
NORTH NARRABEEN

DRAWING NO.


DA05





PROPOSED FIRST FLOOR PLAN

DRAWING NAME



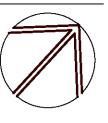

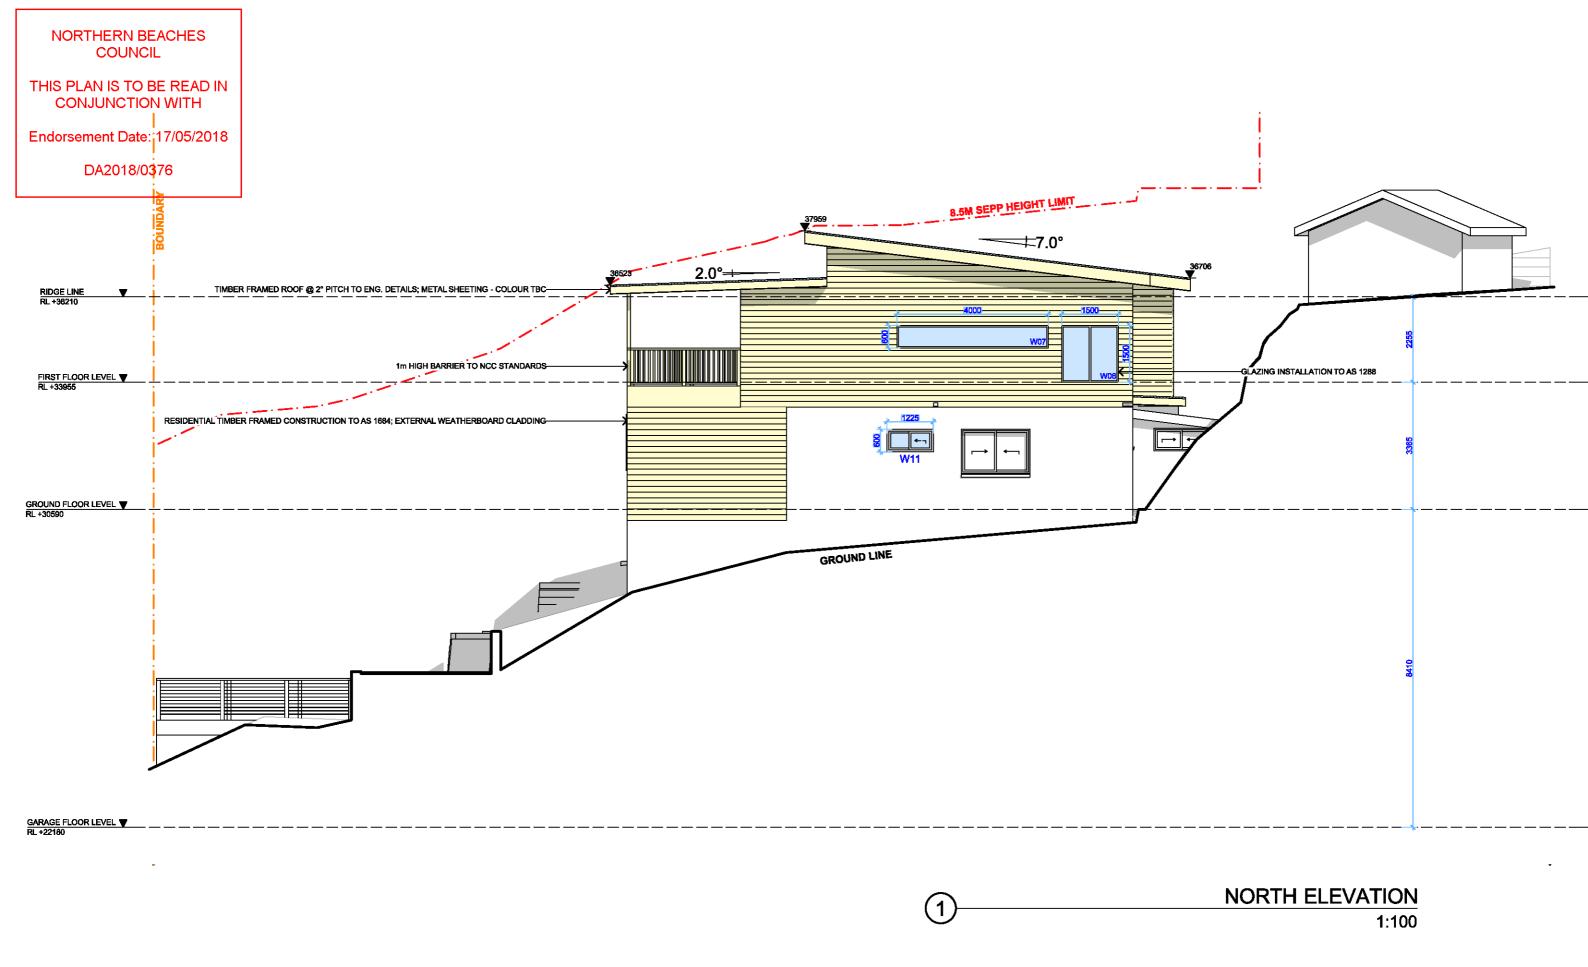

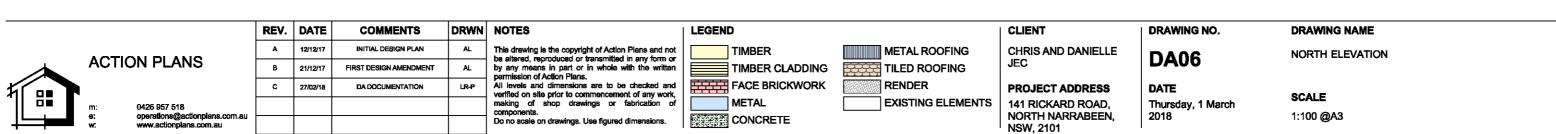


NORTHERN BEACHES COUNCIL

THIS PLAN IS TO BE READ IN CONJUNCTION WITH

Endorsement Date: 17/05/2018

DA2018/0376

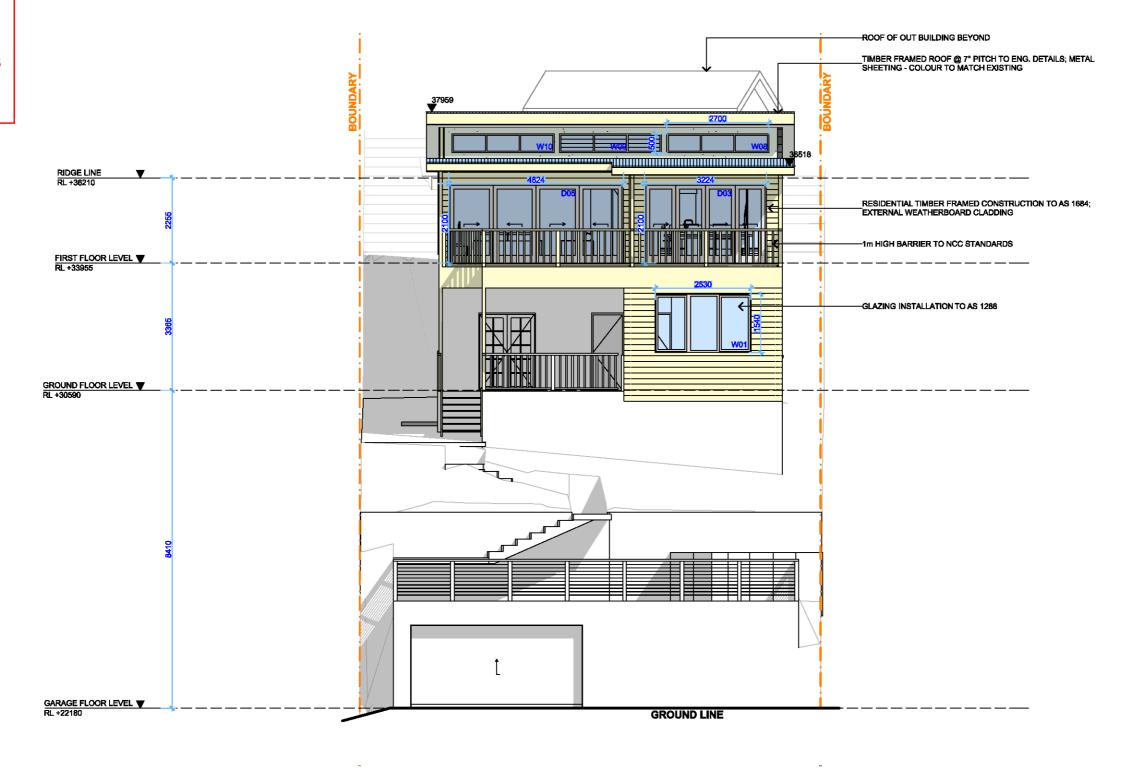





REV.	DATE	COMMENTS	DRWN
A	12/12/17	INITIAL DESIGN PLAN	AL
В	21/12/17	FIRST DESIGN AMENDMENT	AL
С	27/02/18	DA DOCUMENTATION	LR-P

NOTES
This drawing is the copyright of Action Plans and not
be altered, reproduced or transmitted in any form or
by any means in part or in whole with the written
permission of Action Plans.
All levels and dimensions are to be checked and
verified on site prior to commencement of any work,

	LEGEND	
not or	TIMBER	
en	TIMBER CLADDING	
nd rk.	FACE BRICKWORK	
of	METAL	
	CONCRETE	

METAL ROOFING
TILED ROOFING
RENDER
EXISTING ELEMENTS

CLIENT CHRIS AND DANIELLE JEC


PROJECT ADDRESS 141 RICKARD ROAD, NORTH NARRABEEN, NSW, 2101 DA07

)7 EAST

DATE Thursday, 1 March 2018 EAST ELEVATION

DRAWING NAME

SCALE 1:100 @A3

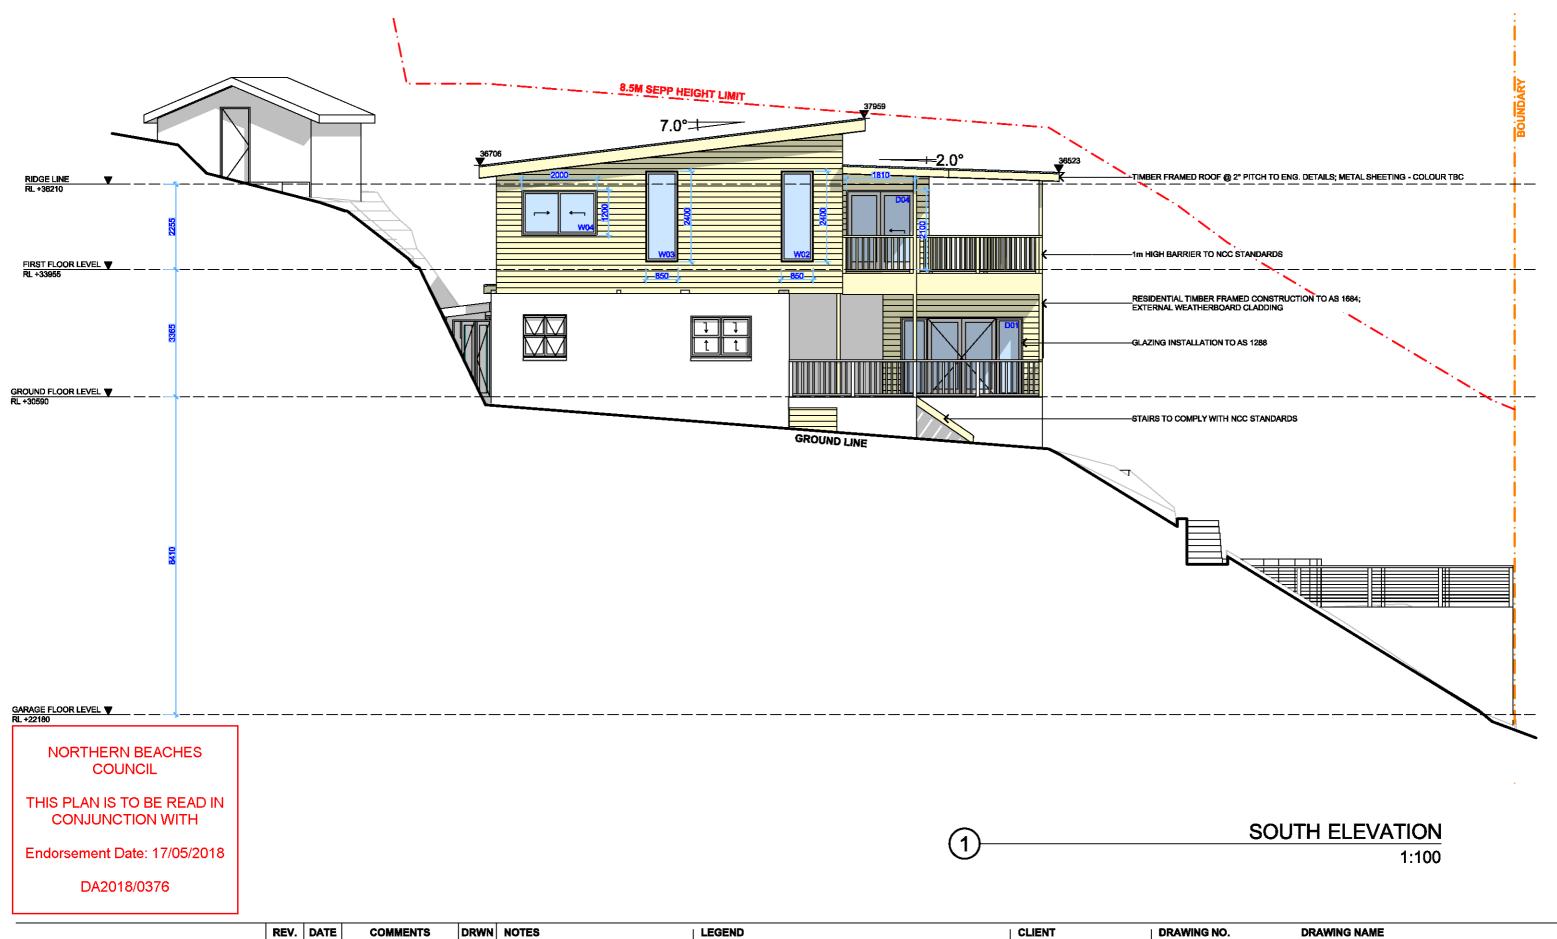



ACTION PLANS

0426 957 518 operations@actionplans.com.au www.actionplans.com.au

REV.	DATE	COMMENTS DRW		
A	12/12/17	INITIAL DESIGN PLAN	AL	
В	21/12/17	FIRST DESIGN AMENDMENT	AL	
С	27/02/18	DA DOCUMENTATION	LR-P	

This drawing is the copyright of Action Plans and not
be altered, reproduced or transmitted in any form or
by any means in part or in whole with the written
permission of Action Plans.
All levels and dimensions are to be checked and

permission of				
All levels and	dimensions	are to b	e checked	and
verified on site	prior to cor	nmencem	ent of any w	ork,
making of	shop draw	ings or	fabrication	of
components.		•		
Do no scale o	n drawings I	lee figure	d dimensions	



CONCRETE

CHRIS AND DANIELLE

PROJECT ADDRESS 141 RICKARD ROAD, NORTH NARRABEEN, NSW, 2101 DA08

DRAWING NAME
SOUTH ELEVATION

JAUO

2018

DATE
Thursday, 1 March

SCALE


1:100 @A3

NORTHERN BEACHES COUNCIL

THIS PLAN IS TO BE READ IN **CONJUNCTION WITH**

Endorsement Date: 17/05/2018

DA2018/0376

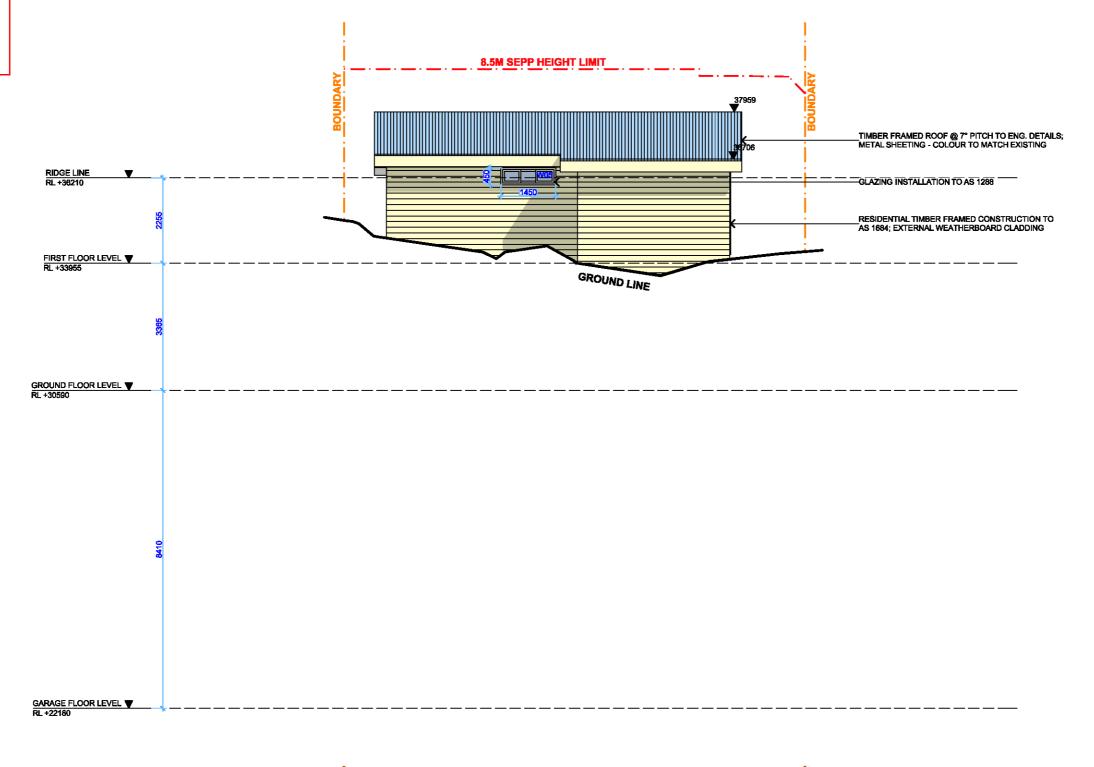





REV.	DATE	COMMENTS	DRWN	ı
A	12/12/17	INITIAL DESIGN PLAN	AL]
В	21/12/17	FIRST DESIGN AMENDMENT	AL	ì
С	27/02/18	DA DOCUMENTATION	LR-P	7
				j
				Ì

NOTES
This drawing is the copyright of Action Plans and not
be altered, reproduced or transmitted in any form or
by any means in part or in whole with the written
permission of Action Plans.
All levels and dimensions are to be checked and
worlded on olfo prior to commoncement of one work

	NUIES	LEGEND	
This drawing is the copyright of Action Plans and not be altered, reproduced or transmitted in any form or		TIMBER	
by any means in part or in whole with the written permission of Action Plans. All levels and dimensions are to be checked and verified on site prior to commencement of any work.	TIMBER CLADDING	Z	
	FACE BRICKWORK		
	making of shop drawings or fabrication of components.	METAL	
	Do no scale on drawings. Use figured dimensions.	CONCRETE	
ı			

LEGEND	
TIMBER	METAL ROOFING
TIMBER CLADDING	TILED ROOFING
FACE BRICKWORK	RENDER
METAL	EXISTING ELEMEN
	TIMBER TIMBER CLADDING FACE BRICKWORK

CLIENT	
CHRIS AND DANIELL JEC	E.
PROJECT ADDRESS	

141 RICKARD ROAD, NORTH NARRABEEN,

NSW, 2101


DA09	
DATE	


Thursday, 1 March 2018


DRAWING NO.

DRAWING NAME WEST ELEVATION

SCALE 1:100 @A3

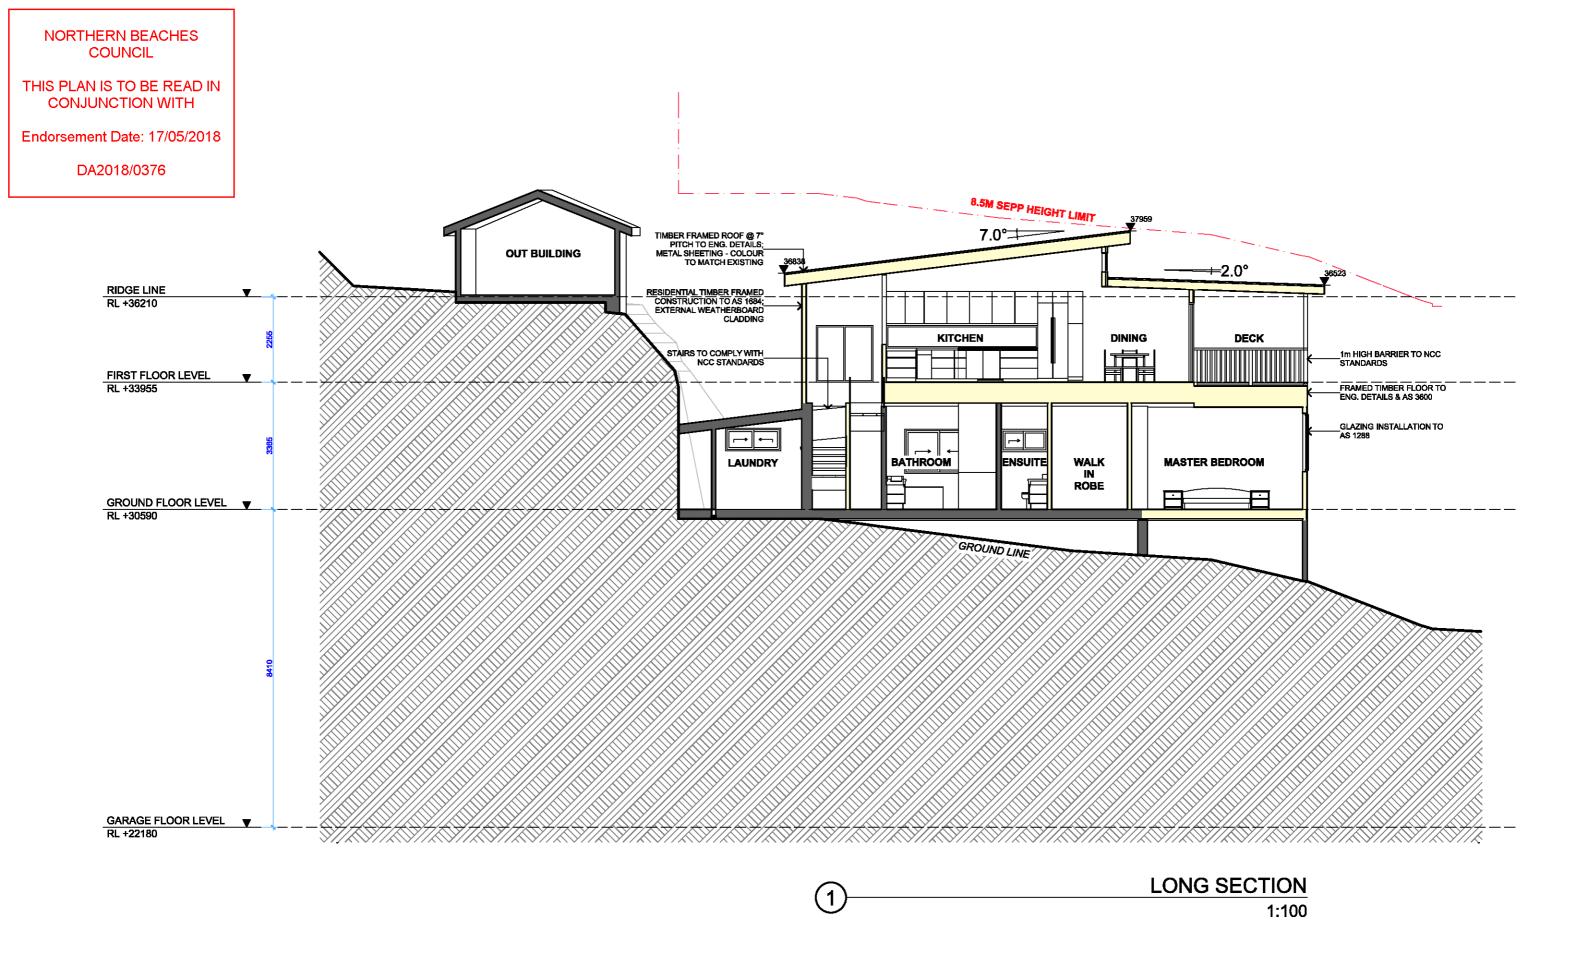

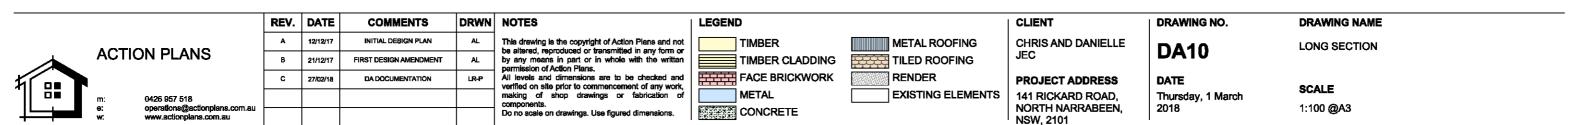

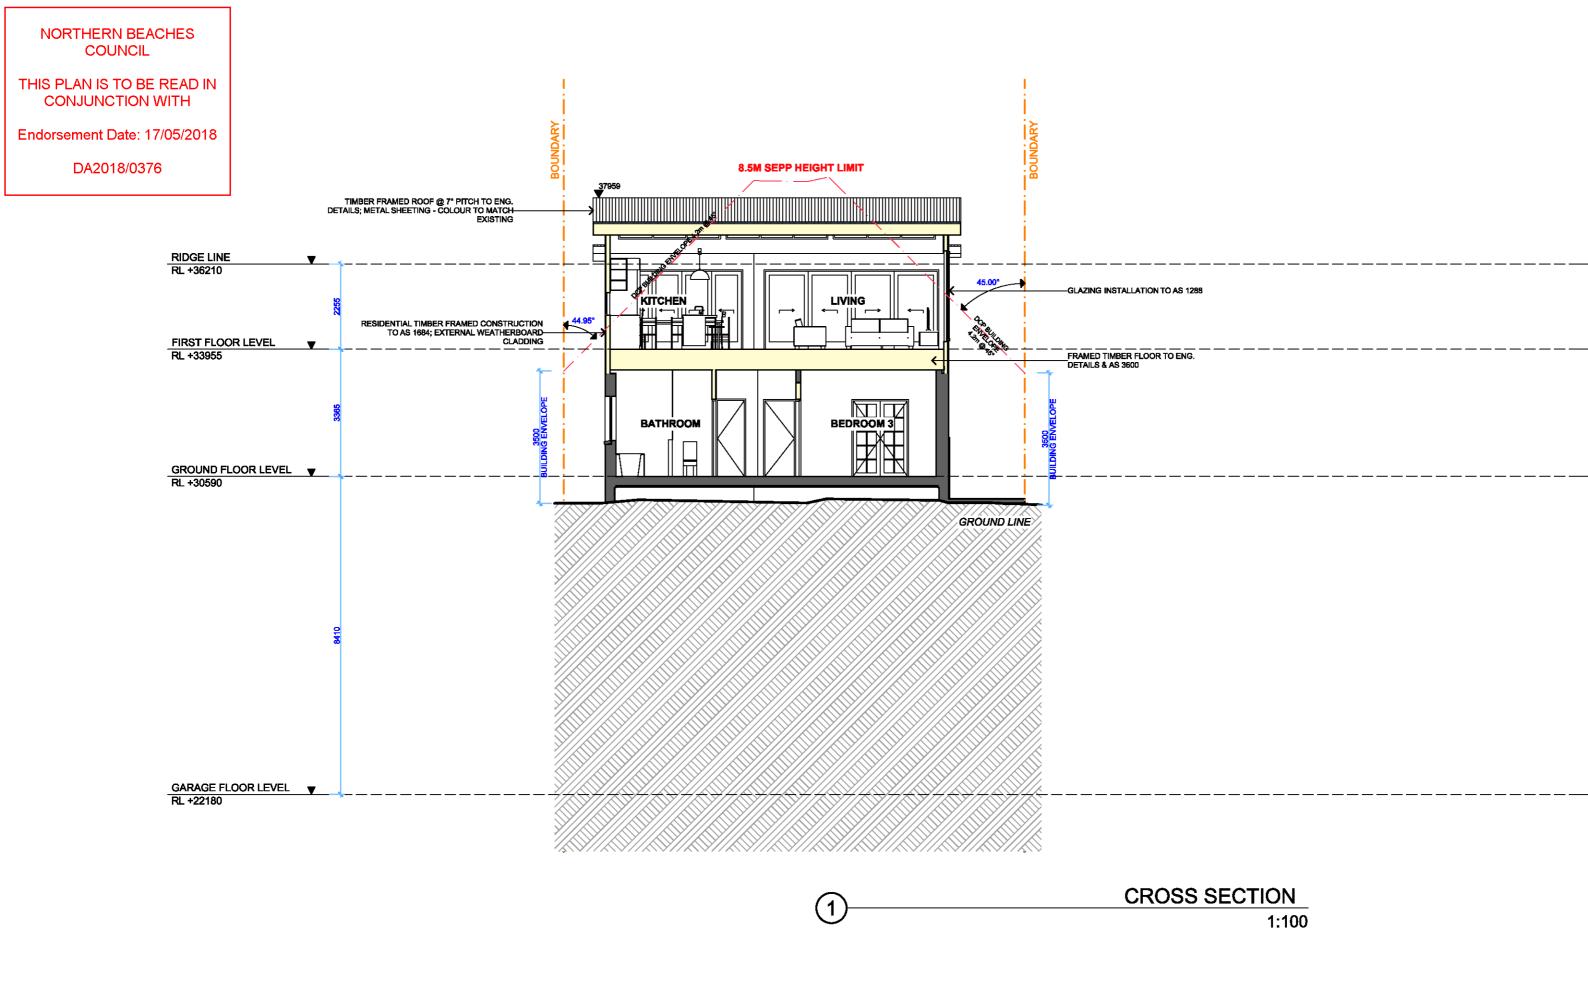



	REV.	DATE	COMMENTS	DRWN	NOTES
	A	12/12/17	INITIAL DESIGN PLAN	AL	This drawing
	В	21/12/17	FIRST DESIGN AMENDMENT	AL	by any mea
	С	27/02/18	DA DOCUMENTATION	LR-P	All levels a verified on s
					making of components
ш					Do no scale

NOILS
This drawing is the copyright of Action Plans and not
be altered, reproduced or transmitted in any form or by any means in part or in whole with the written
permission of Action Plans.
All levels and dimensions are to be checked and

y means in part or in whole with the written ssion of Action Plans.	TIMBER CL
vels and dimensions are to be checked and do no site prior to commencement of any work.	FACE BRIC
g of shop drawings or fabrication of onents.	METAL
scale on drawings. Use figured dimensions.	CONCRETE

LEGEND	
TIMBER	METAL ROOFING
TIMBER CLADDING	TILED ROOFING
FACE BRICKWORK	RENDER
METAL	EXISTING ELEMENTS
CONCRETE	

CLIENT
CHRIS AND DANIELLE

PROJECT ADDRESS 141 RICKARD ROAD, NORTH NARRABEEN,

NSW, 2101

DA11

CROSS SECTION

DATE Thursday, 1 March 2018 SCALE 1:100 @A3

DRAWING NAME