


Direction of flov Self-supporting 1.5m star pickets geotextile fabric at max.2.5m ctr 500mm to Geotextile filter fabric Direction of flow 600mm m Sediment fence detail

- 2. Silt barriers to be maintained regularly & after heavy rain by removal of built up silt & spreading silt on existing site when 50% capacity.
- 3. Repair any damages to fence immediately.
- 4. Clean up spillages outside silt fence immediately.
- 5. Sediment control measures to be left in place until works completed.
- 6. Topsoil from the work's area will be stockpiled for later use in landscaping
- 7. Approved bins for building waste, concrete and mortar slurries, paints and acid washings will be provided by contractor.

Site Analysis Legend

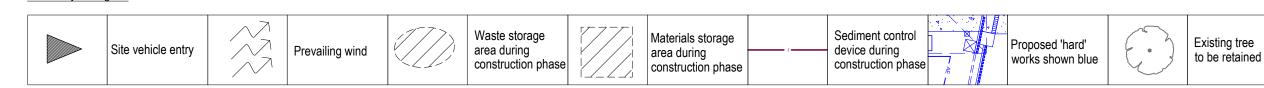

Note: Landscape works to previous application.

- Contractors to check and verify all dimensions and all levels on site prior to any works.
- Any discrepancies should be immediately referred to Serenescapes Landscape Designs
 All work to comply with B.C.A. Statutory Authorities and relevant Australian Standards.

Dimensions recognised over scaling. All measurements are in millimetres

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Anthony Quigley	Drawing Title:	Lan

8 Yarrabin Street

Belrose

Landscape Site Plan

22/07/2021 Preliminary Issue

Tree to be

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removed




STREET

MARKABIN

Serenscapes Landscape Designs ABN 71 611 726 222

EC 28/07/2021 DA Issue EC Project Number: Scale: Sheet Number: Drawn by: Ben Farrar 21799-Pool As shown @ A3 L-01 of 8

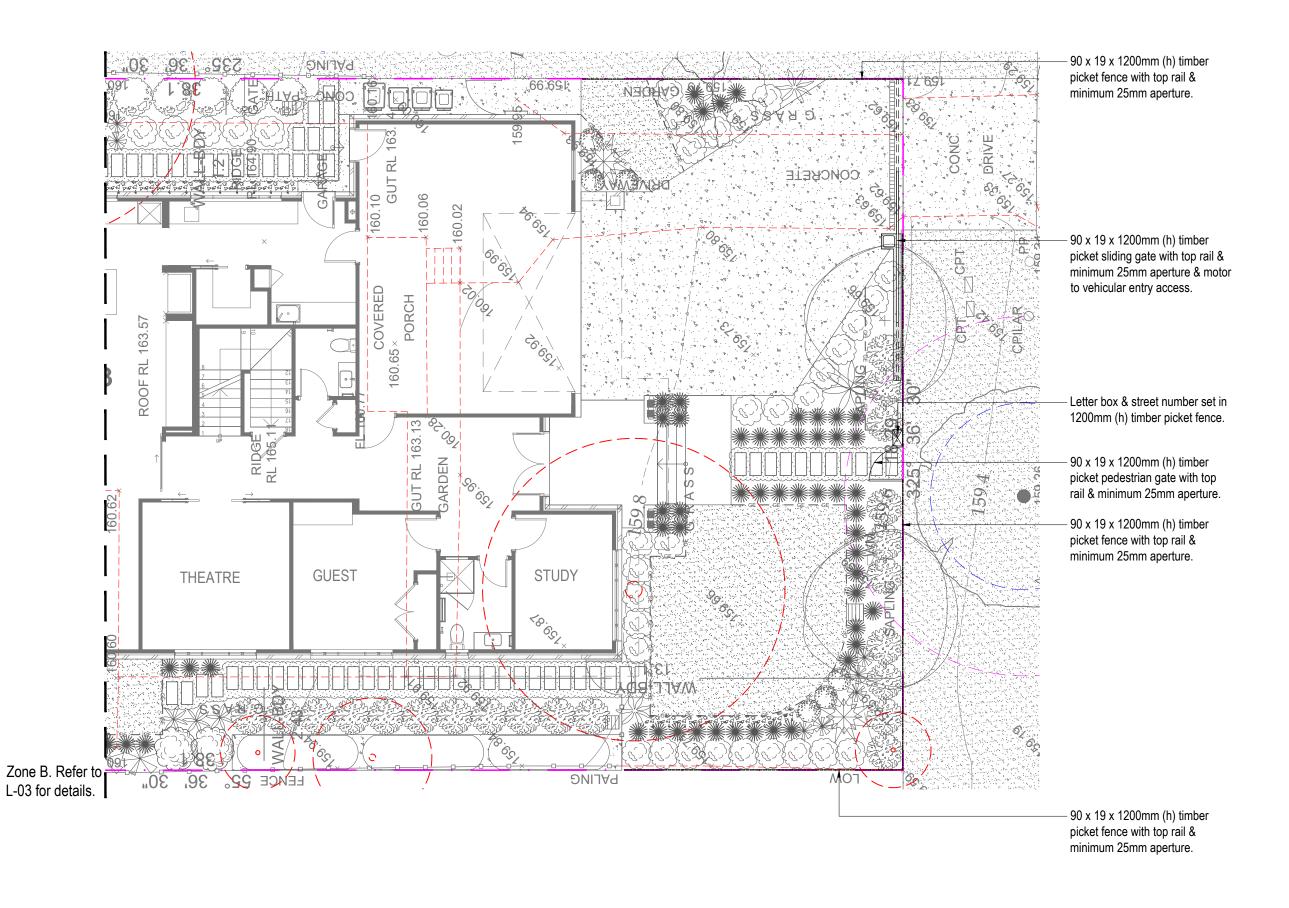

Note: Landscape works to previous application.

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	Anthony Quigley				
Site Address:	8 Yarrabin Street				
	Belrose				

Zone A Detail Plan Project Number: Scale:

Drawing Title:


Drawn by:

Ben Farrar

22/07/2021 Preliminary Issue EC 28/07/2021 DA Issue EC Sheet Number: 21799-Pool 1:100 @ A3 L-02 of 8



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Drawing Title: **Anthony Quigley** Site Address: Drawn by: 8 Yarrabin Street Ben Farrar

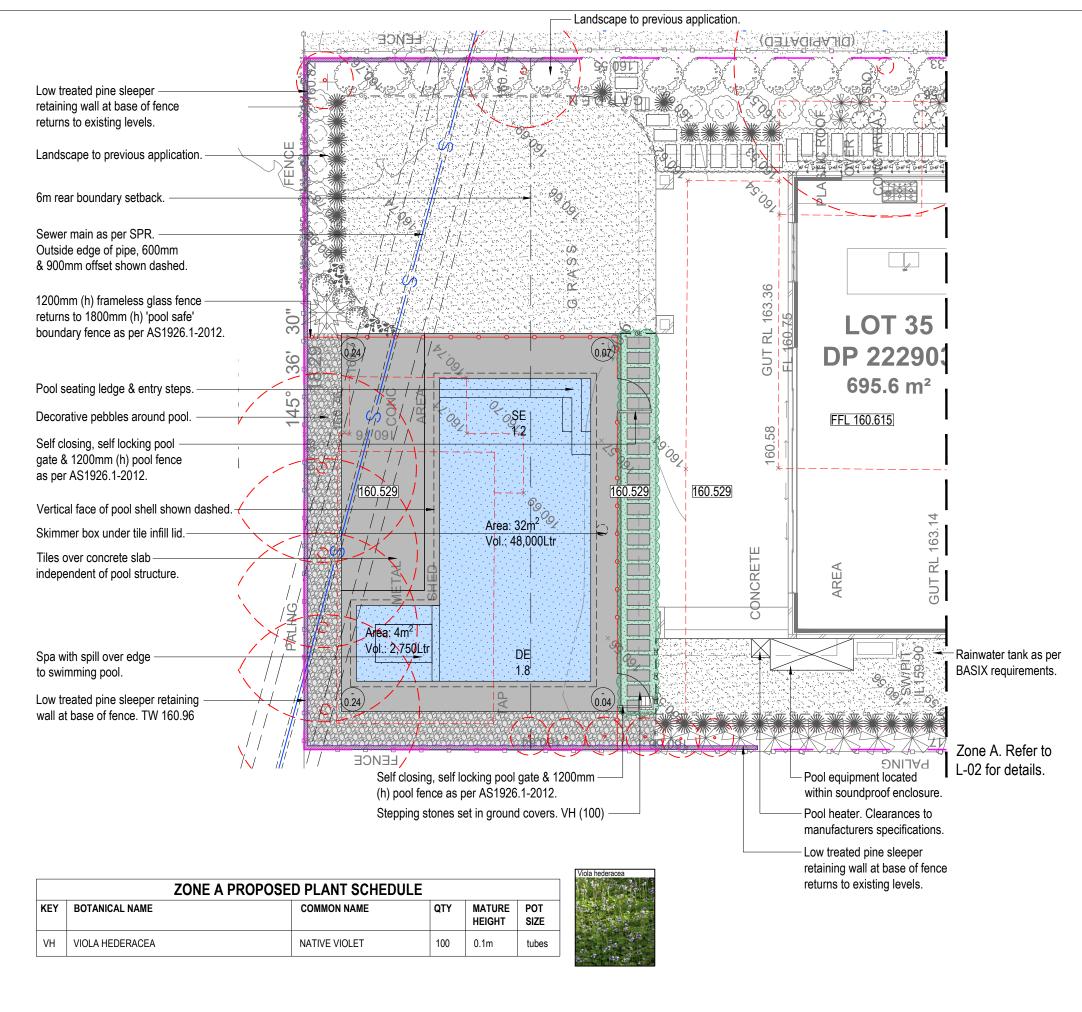Belrose

Zone B Detail Plan Project Number: Scale:

22/07/2021 Preliminary Issue EC 28/07/2021 DA Issue Sheet Number: 21799-Pool 1:100 @ A3 L-03 of 8

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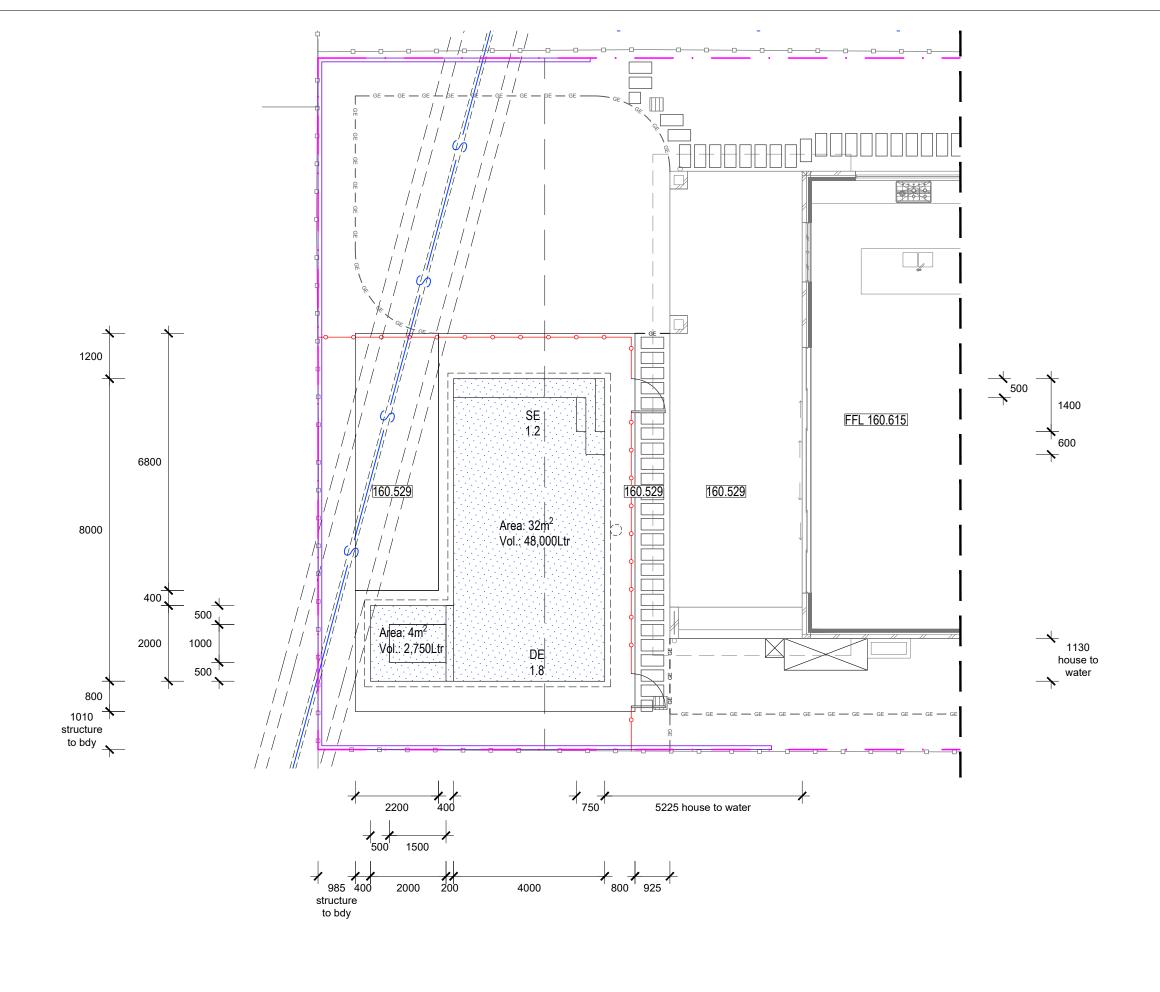


Denotes difference between

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EC

coping & existing ground level



Note: Landscape works to previous application.

Note:

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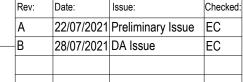
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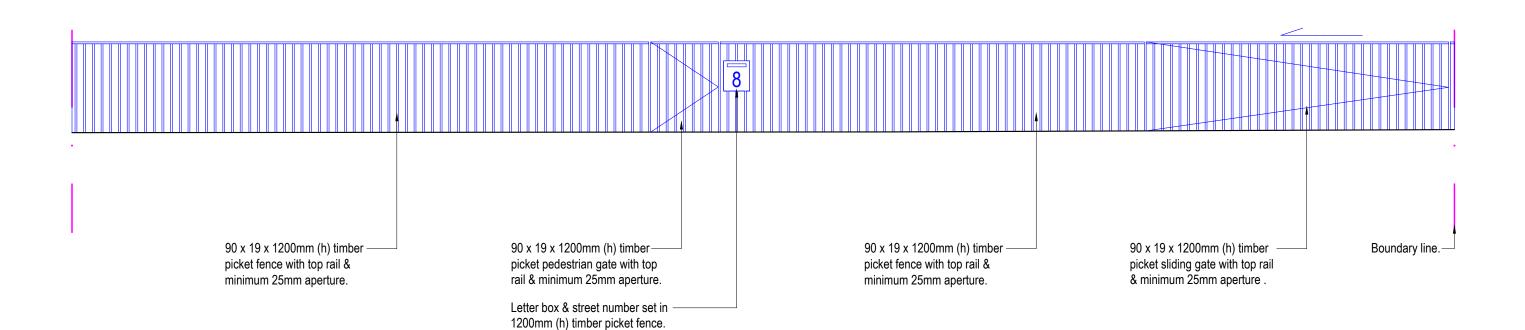
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	Belrose	Ben Farrar TLA Member	21799-Pool	1.100 @ A3	L-04 of 8		







Sectional Elevation AA

Scale 1:50

Note:

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- Any discrepancies should be immediately reterred to Serenescapes Landscape Designs.

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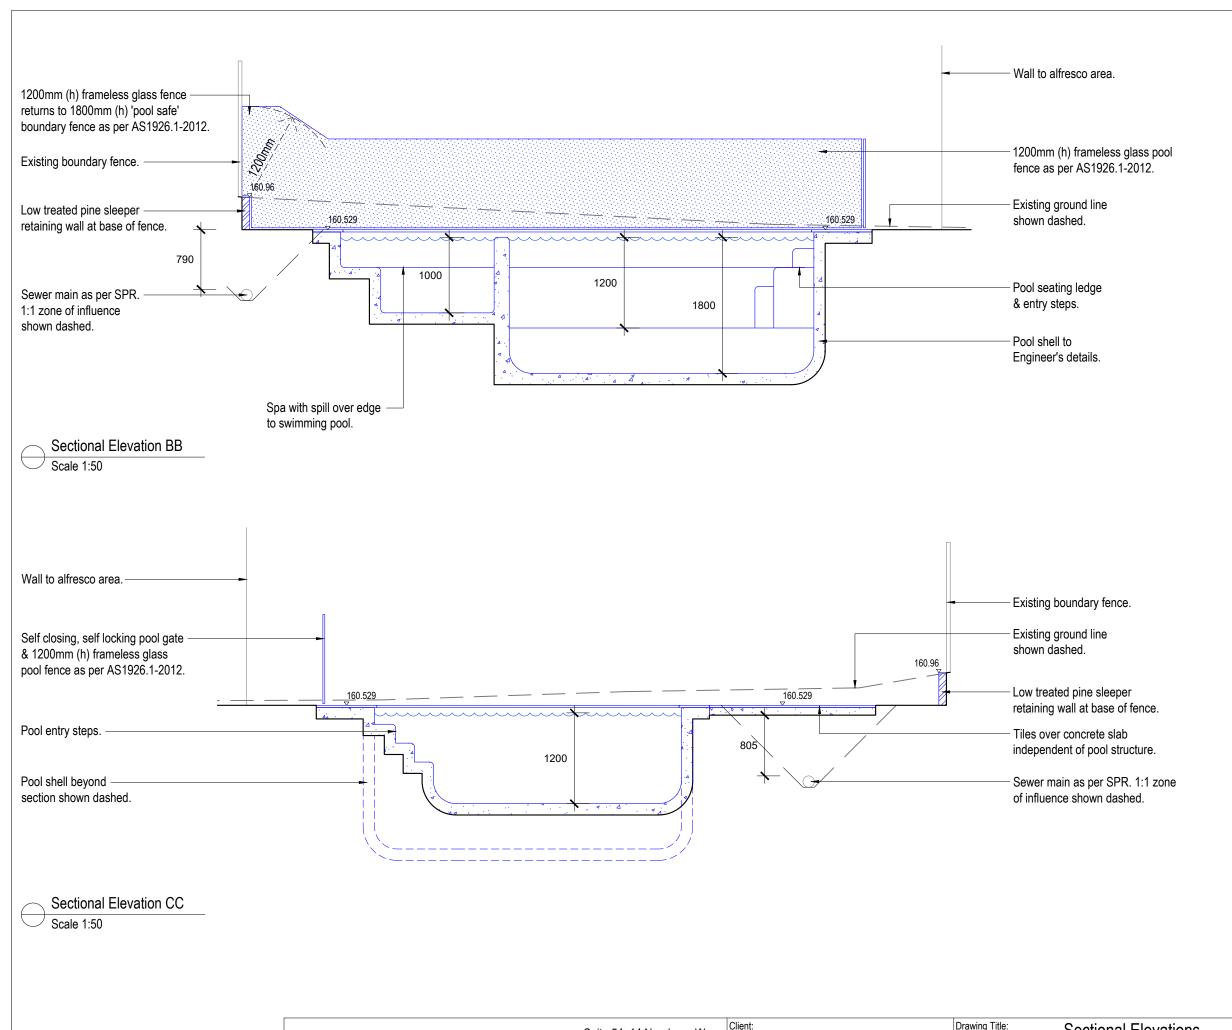
Tel: 02 9986 2157 info@serenescapes.com.au Serenscapes Landscape Designs www.serenescapes.com.au

Client: Suite 54, 14 Narabang Way Belrose NSW 2085

Anthony Quigley Site Address: Project Number: Scale: Drawn by: 8 Yarrabin Street Ben Farrar Belrose

Drawing Title:

Checked: Sectional Elevation 22/07/2021 Preliminary Issue EC 28/07/2021 DA Issue EC Sheet Number: 21799-Pool 1:50 @ A3 L-05 of 8



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- Contractors to check and verify all dimensions and all levels on site prior to any works.

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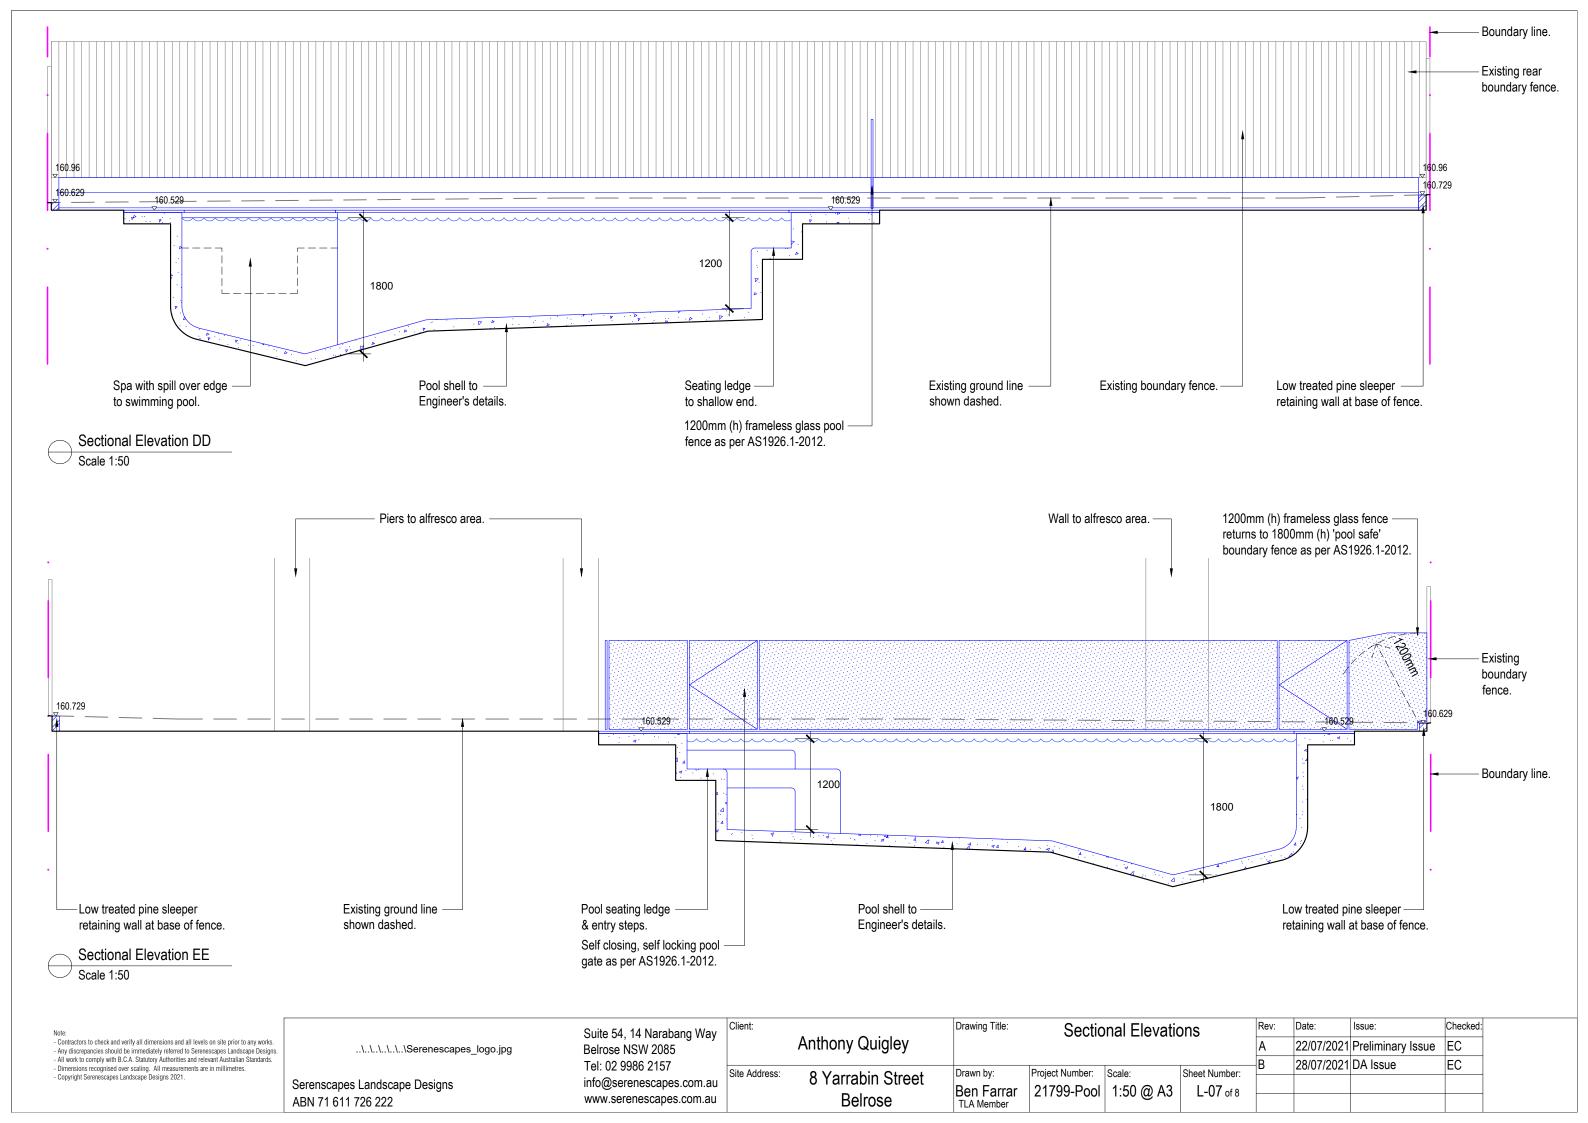
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Client:			Sectional Elevations			Rev:	Date:	Issue:	Checked:	
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LANDSCAPE SPECIFICATION NOTES

SITE PREPARATION

Locate any underground and overground services & ensure no damage occurs. Levels on plan are nominal only & all dimensions to be checked on site prior to commencement. Final structural integrity of all items shall be the sole responsibility of landscape contractor.

PROTECTION OF EXISTING TREES:

All tree protection is to be undertaken in accordance with the guidelines provided in AS4970-2009 Protection of trees on development sites.

Prior to construction, the builder shall erect tree protection fencing for each protected tree. Tree protection fencing setbacks are to be determined by multiplying the diameter at breast height by twelve (12). Fencing is to consist of Chain wire mesh panels at least 1.8m in height, anchored with concrete feet. Signage stating "Tree Protection Zone – No Access" is to be displayed on the fencing.

According to AS 4970-2009, activities excluded from the TPZ include but are not limited to:

- machine excavation including trenching
- excavation for silt fencing
- cultivation
- storage
- preparation of chemicals, including preparation of cement products
- parking of vehicles and plant and/or refuelling
- dumping of waste and/or wash down and cleaning of equipment
- soil level changes and/or placement of fill
- lighting of fires
- temporary or permanent installation of utilities and signs
- physical damage to the tree.

REMOVAL OF EXISTING TREES

All trees to be removed shall be carried out by a qualified arborist and work shall conform to the provisions of AS4373-2007 Australian Standards for The Pruning of Amenity Trees.

ELIMINATE WEEDS

Remove all existing weeds by hand, wiping or spraying with a glyphosate based herbicide. Weed control shall never be performed by mechanical cultivation or by scraping. Herbicide spraying is to be used to eliminate all existing weeds 30 days prior to planting.

EXCAVATION & SUB SOIL PREPARATION

Excavate garden beds to the depth required and rip or scarify base & sides of pit to a minimum depth of 150mm.

SUB SOIL DRAINAGE

Install drainage layer where there is surface water runoff draining into garden bed areas & where the existing sub-soil has more than 50% clay composition & there is a risk of subsurface water ponding. Install perforated corrugated ag. line 75-100mm Dia. with geotextile filter sock & backfill to a minimum 200mm using free draining material, reclaimed/recycled where available. Direct flows at a minimum 0.5% fall to sw system. In areas isolated from stormwater system excavate & backfill an appropriate water dispersion pit.

REUSE EXISTING TOPSOIL

Existing site topsoil should be salvaged & appropriately stockpiled where possible. IMPORTED TOPSOIL

Quality System: AS 4419 or as specified below.

Turf Areas: 'Turf Underlay' as supplied by, ANL p: 02 9450 1444 or approved alternative. Tree Pit and Shrub Planting: 'Premium Garden Mix' as supplied by, ANL p: 02 9450 1444 or approved alternative.

PLANTING

Health & Vigour: Supply plants with foliage size, texture & colour consistent with that shown in healthy specimens of the species. Crowns must contain no epicormic shoots or dieback.

Balance of Crown: Supply plants with max, variation in crown bulk on opposite sides of stem axis. +/- 20% All plants supplied should be consistent with the guidelines provided in AS2303-2015 Tree stock for landscape use.

ALUMINIUM GARDEN EDGING

Supply and install Link Edge 75mm as per Landscape Plan. Compact and level the base in the required area as indicated on Landscape Plan. Half hammer spikes into pre-punched holes (approx. 4 spikes every 3m length) starting from the first hole in the end of the Link Edge. Use spike washers supplied by manufacturer. Half hammer subsequent spikes in pivotal areas along the length. (Especially at points where a curve is required). Connect lengths together by using fish-plate connectors supplied by manufacturer. Check position of Link Edge is correct before hammering spikes firmly into ground.

IRRIGATION SYSTEM

New dripline irrigation system to be installed with backflow preventer and with timers. Irrigation system to be designed and installed to local codes.

The entire irrigation system shall be fully automated and provide drip irrigation to all tree, shrub and ground cover zones. It is the Contractor's responsibility to verify water pressure available and determine all design-built parameters prior to any installation and sizing of irrigation components. Irrigation system to be connected to water tank to supplement water from mains.

MULCHING

Quality system: AS 4454


All planting area impacted by building works to receive 50-75mm of garden Mulch, Hort-Bark, ANL p: 02 9450 1444 or approved alternative. Keep mulch 100mm away from plant stem & form a well to stop excessive water runoff. Finish flush with adjacent surfaces.


WATERING

Water in immediately after plant installation & allow for soil settlement. For the first 2 to 4 weeks after planting, the root zone & immediate surrounds must be kept moist. Continue watering until plants have


RETAINING WALLS & PLANTER BOXES

All retaining walls & planter boxes to be constructed to Engineer's details. Ensure all internal surfaces are waterproofed. Geotextile wrapped ag. drainage line backfilled with aggregate is to be installed behind all retaining walls & connected to stormwater in accordance with Sydney Water regulations. All planter boxes are to have Atlantis drainage cell (or approved alternative) installed & connected to stormwater in accordance with Sydney Water regulations.

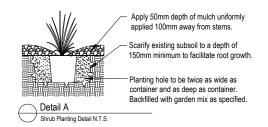

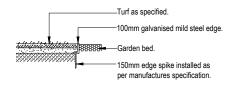



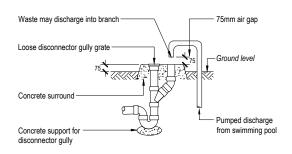

Note: Overflow relief gully (ORG) to be constructed to AS/NZS 3500



BASIX REQUIREMENTS

RAINWATER TANK

THE APPLICANT MUST INSTALL A RAINWATER TANK OF AT LEAST 1695 LITRES ON THE SITE. THIS RAINWATER TANK MUST MEET, AND BE INSTALLED IN ACCORDANCE WITH, THE REQUIREMENTS OF ALL APPLICABLE REGULATORY AUTHORITIES. THE APPLICANT MUST CONFIGURE THE RAINWATER TANK TO COLLECT RAINWATER RUNOFF FROM AT LEAST 270 SQUARE METRES OF ROOF AREA. THE APPLICANT MUST CONNECT THE RAINWATER TANK TO A TAP LOCATED WITHIN 10 METRES OF THE EDGE OF THE POOL.

OUTDOOR SWIMMING POOL

THE SWIMMING POOL MUST BE OUTDOORS.

THE SWIMMING POOL MUST NOT HAVE A CAPACITY GREATER THAN 48 KILOLITRES.

THE SWIMMING POOL MUST HAVE A POOL COVER.

THE APPLICANT MUST INSTALL A POOL PUMP TIMER FOR THE SWIMMING POOL. THE APPLICANT MUST INSTALL THE FOLLOWING HEATING SYSTEM FOR THE

SWIMMING POOL THAT IS PART OF THIS DEVELOPMENT: GAS

OUTDOOR SPA

THE SPA MUST NOT HAVE A CAPACITY GREATER THAN 2.75 KILOLITRES.

THE SPA MUST HAVE A SPA COVER.

THE APPLICANT MUST INSTALL A SPA PUMP TIMER.

THE APPLICANT MUST INSTALL THE FOLLOWING HEATING SYSTEM FOR THE SPA THAT IS PART OF THIS DEVELOPMENT: GAS

 Contractors to check and verify all dimensions and all levels on site prior to any works. Any discrenancies should be immediately referred to Serenescanes Landscane Design

All work to comply with B.C.A. Statutory Authorities and relevant Australian Standards Dimensions recognised over scaling. All measurements are in millimetres

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