

ACTION PLANS

6 KEMPBRIDGE AVE, SEAFORTH 2092

m: 0426 957 518

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DEVELOPMENT APPLICATION

These plans are for Development Approval only.


SHEET NUMBER	SHEET NAME	DATE PUBLISHED
DA00	COVER	23/10/2020
DA01	SITE ANALYSIS	23/10/2020
DA02	${\tt SITE/ROOF/SEDIMENT\ EROSION/WASTE\ MANAGEMENT/STORMWATER\ CONCEPT\ PLAN}$	23/10/2020
DA03	EXISTING GROUND FLOOR PLAN	23/10/2020
DA04	PROPOSED GROUND FLOOR PLAN	23/10/2020
DA05	PROPOSED FIRST FLOOR PLAN	23/10/2020
DA06	NORTH / EAST ELEVATION	23/10/2020
DA07	SOUTH / WEST ELEVATION	23/10/2020
DA08	LONG / CROSS SECTION	23/10/2020
DA09	DRIVEWAY PLAN / LONG SECTION / FRONT FENCE ELEVATION	23/10/2020
DA10	POOL PLAN	23/10/2020
DA11	POOL SECTIONS	23/10/2020
DA12	AREA CALCULATIONS	23/10/2020
DA13	FSR CALCULATIONS	23/10/2020
DA14	SAMPLE BOARD	23/10/2020
DA15	WINTER SOLSTICE 9 AM	23/10/2020
DA16	WINTER SOLSTICE 12 PM	23/10/2020
DA17	WINTER SOLSTICE 3 PM	23/10/2020
DA18	BASIX COMMITMENTS	23/10/2020

ITEM DETAILS	DEVELOPMENT APPLICATION			
ADDRESS	6 KEMPBRIDGE AVENUE, SEAFORTH NSW 20	92		
LOT & DP/SP	LOT 59 DP 12499			
COUNCIL	NORTHERN BEACHES COUNCIL (MANLY)			
SITE AREA	494.91m²			
FRONTAGE	12.192m			
CONTROLS	PERMISSIBLE / REQUIRED	EXISTING	PROPOSED	COMPLIANCE
CONTROLS	m / m² / %	m / m² / %	m / m² / %	
<u>LEP</u>				
LAND ZONING	R1 – GENERAL RESIDENTIAL	R1	R1	YES
MINIMUM LOT SIZE	300m²	494.91m²	UNCHANGED	YES
FLOOR SPACE RATIO	0:50 : 1 (247.45m²)	0.21 : 1 (107.00m²)	0.37 : 1 (185.58m²)	YES
MAXIMUM BUILDING HEIGHT	8.5m	5.57m	8.123m	YES
<u>HAZARDS</u>				
ACID SULFATE SOILS	CLASS 5			PLEASE READ IN CONJUNCTION WITH STATEMENT OF ENVRIONMENTAL EFFECTS
DCP				
RESIDENTIAL OPEN SPACE	AREA OS3			
TOTAL OPEN SPACE (TOS)	55% (272.20m²)	46.5% (230.41m²)	43.0% (212.86m²)	NO
LANDSCAPE AREA	35% OF TOS (55%): 95.27m ²	73.2% (199.33m²)	57.6% (156.84m²)	YES
OPEN SPACE ABOVE GROUND	MAX. 25% OF TOS (55%): 68.05m ²	3.5% (9.66m²)	9.2% (25.29m²)	YES
PRINCIPAL PRIVATE OPEN SPACE	18m²	83.61m ²	73.81m²	YES
FRONT SETBACK	PREVALING BULDING LINE: 8.645m	BUILDING: 17.265m DECK: 17.356m	BUILDING: 19.827m DECK: 17.265m	YES
REAR SETBACK	8.0m	5.945m	UNCHANGED	No (EXISTING)
SIDE SETBACKS	1/3 WALL HEIGHT: N: 2.104m S: 2.116m Residential Density Area: D4 = 0.9m <3m high	N: 0.603m S: 2.238m	N: UNCHANGED S: UNCHANGED	NO (EXISTING) YES
CAR PARKING SPACES	Required: 1	1	2	YES




NCC & AS COMPLIANCES SPECIFICATIONS

- EARTHWORKS PART 3.1.1 OF NCC
- EARTH RETAINING STRUCTURES PART 3.1.2 OF NCC
- DRAINAGE PART 3.1.3 OF NCC
- TERMITE-RISK MANAGEMENT PART 3.1.4 OF NCC
- FOOTINGS & SLAB PART 3.2 OF NCC INCLUDING AS2870
- MASONRY PART 3.3 OF NCC INCLUDING AS3700
- FRAMING PART 3.4 OF NCC
- SUB FLOOR VENTILATION PART 3.4.1 OF NCC
- ROOF CLADDING AND WALL-CLADDING PART 3.5 OF NCC
- GLAZING PART 3.6 OF NCC INCLUDING AS1288
- FIRE SAFETY PART 3.7 OF NCC
- FIRE SEPERATION PART 3.7.2 OF NCC
- FIRE PROTECTION OF SEPERATING WALLS AND FLOORS- PART 3.7.3 OF NCC
- SMOKE ALARMS PART 3.7.5 OF NCC
- WET AREAS AND EXTERNAL WATERPROOFING PART 3.8.1 OF NCC
- ROOM HEIGHTS PART 3.8.2 OF NCC
- FACILITIES PART 3.8.3 OF NCC
- LIGHT PART 3.8.4 OF NCC
- VENTILATION PART 3.8.5 OF NCC
- SOUND INSULATION PART 3.8.6 OF NCC
- STAIRWAYAND RAMP CONSTRUCTION PART 3.9.1 OF NCC
- BARRIERS AND HANDRAILS PART 3.9.2 OF NCC
- SWIMMING POOLS PART 3.10.1 OF NCC
- CONSTRUCTION IN BUSHFIRE PRONE AREAS PART 3.10.5 OF NCC
- FENCING & OTHER PROVISIONS REGS & AS1926
- DEMOLITION WORKS AS2601-1991 THE DEMOLITION OF STRUCTURES.
- ALL WATERPROOF MEMBRANES TO COMPLY WITH WITH AS 3740-2010
- ALL PLUMBING & DRAINAGE WORK TO COMPLY WITH AS 3500
- SITE CLASSIFICATION AS TO AS 2870
- ALL PLASTERBOARD WORK TO COMPLY WITH AS 2588-1998
- ALL STRUCTURAL STEEL WORK TO COMPLY WITH AS 4100 & AS 1554
- ALL CONCRETE WORK TO COMPLY WITH AS 3600
- ALL ROOF SHEETING WORK TO COMPLY WITH AS 1562-1992
- ALL SKYLIGHTS TO COMPLY WITH WITH AS 4285-2007
- ALL CERAMIC TILING TO COMPLY WITH AS 3958.1-2007 & 3958.2-1992
- ALL GLAZING ASSEMBLIES TO COMPLY WITH AS2047 & 1288
- ALL TIMBER RETAINING WALLS ARE TO COMPLY WITH AS 1720.1-2010, AS 1720.2-2006, AS 1720.4-2006, AS 1170.1-1989 & AS 1170.4-2007
- ALL RETAINING WALLS ARE TO COMPLY WITH 3700 2011 & AS 3600 -2009
- ALL CONSTRUCTION TO COMPLY TO AS3959- 2009

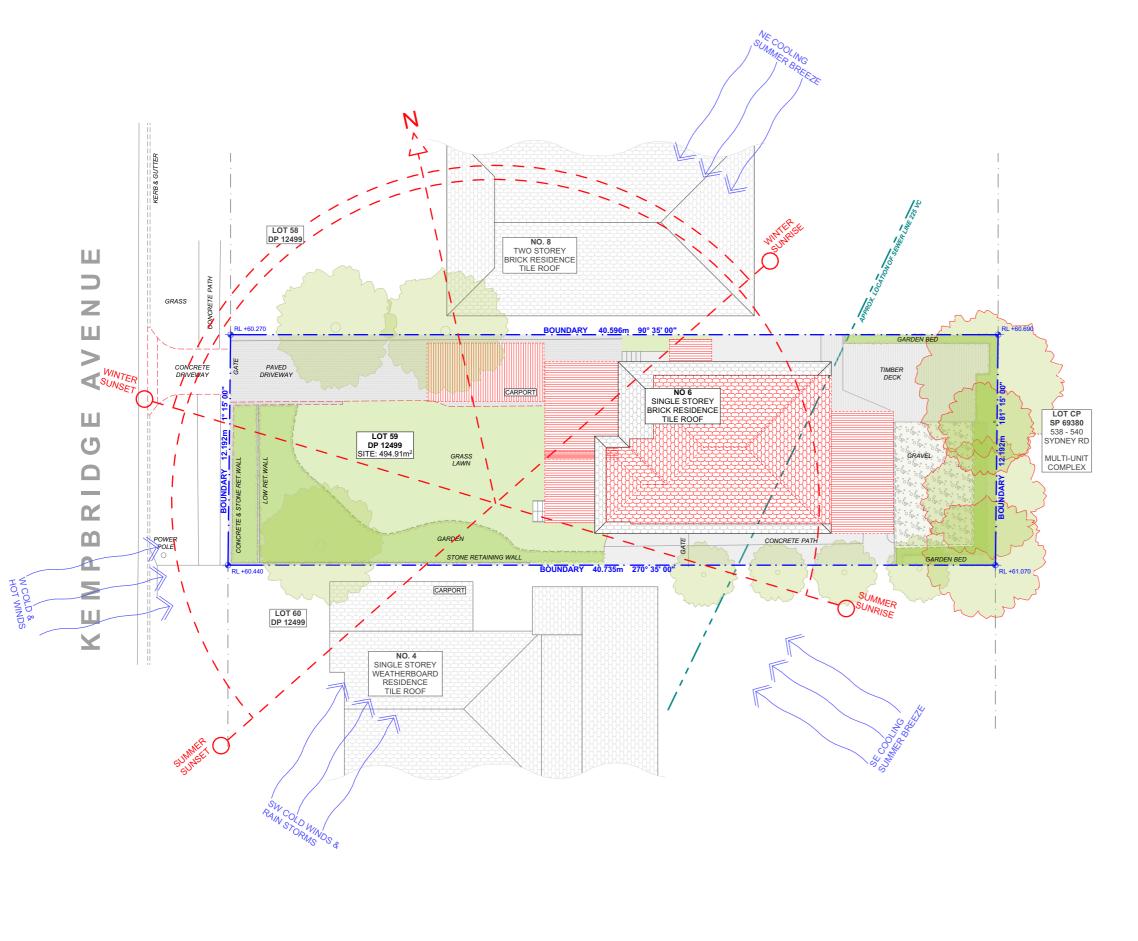





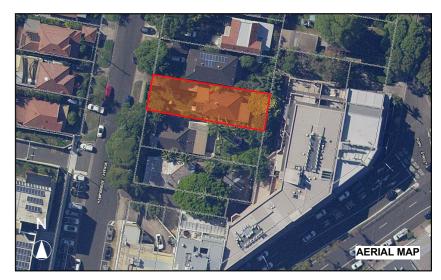

1:200 **SITE ANALYSIS**

NOTE: ALL DEMOLISHED ELEMENTS TO ENG. SPECIFICATIONS AND AS. 2601 - 2001

DRAWING NAME



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ıu					Action Plans. Do not scale measure from drawings. Figured dimensions are to be used only. The Builder/Contractor shall check and verify all levels and dimensions on site prior to commencement of any work, creation of shop drawings, or fabrication of components. All errors and omissions are to be verified by the	HARD LANDSCA PROPOSED EXISTING DEMOLISHED
					Builder/Contractor and referred to the designer prior to the commencement of works.	

LEGEND

SOFT LANDSCAPE HARD LANDSCAPE PROPOSED **EXISTING**

EX. **EXISTING** DP. DOWNPIPE PROP. PROPOSED DP. DOWNPIPE

CLIENT

THOMAS & VANESSA MILES

PROJECT ADDRESS 6 KEMPBRIDGE AVE, SEAFORTH 2092


DRAWING NO.

DA01

SITE ANALYSIS

DATE

Friday, 23 October 2020 **SCALE** 1:200 @A3

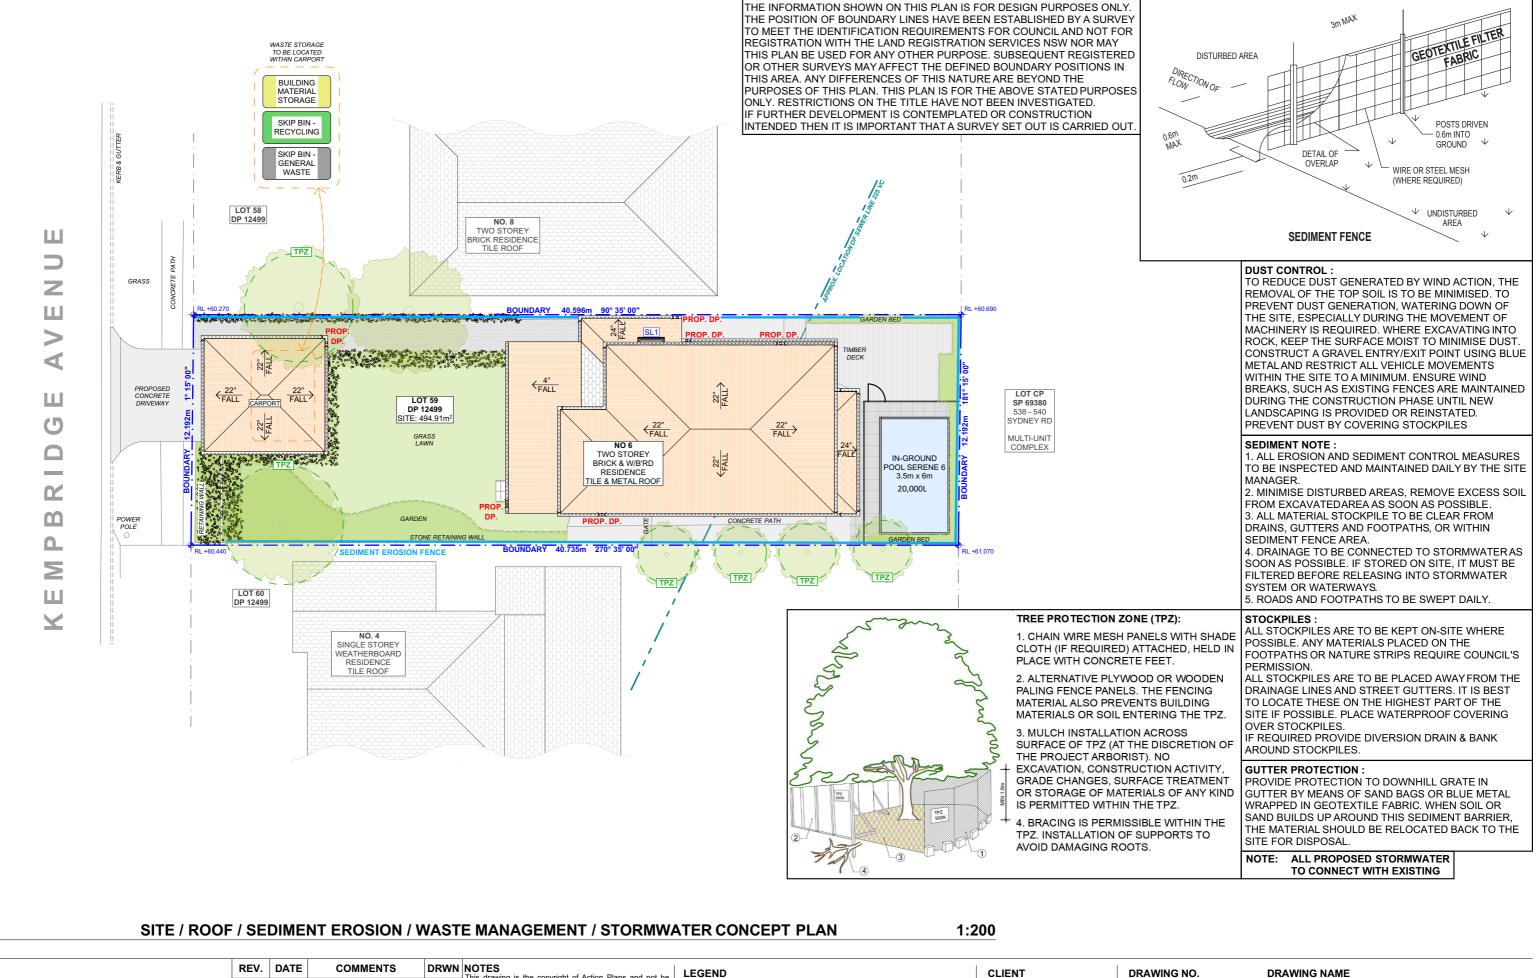

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					All errors and omissions are to be verified by the Builder/Contractor and referred to the designer prior to the
					commencement of works.



EX. **EXISTING** DP. DOWNPIPE PROPOSED PROP. DOWNPIPE DP.

THOMAS & VANESSA MILES

PROJECT ADDRESS 6 KEMPBRIDGE AVE. SEAFORTH 2092

DA02


DATE Friday, 23 October 2020


DRAWING NAME


SITE / ROOF / SEDIMENT EROSION / WASTE MANAGEMENT / STORMWATER CONCEPT PLAN

SCALE

1:200 @A3

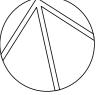

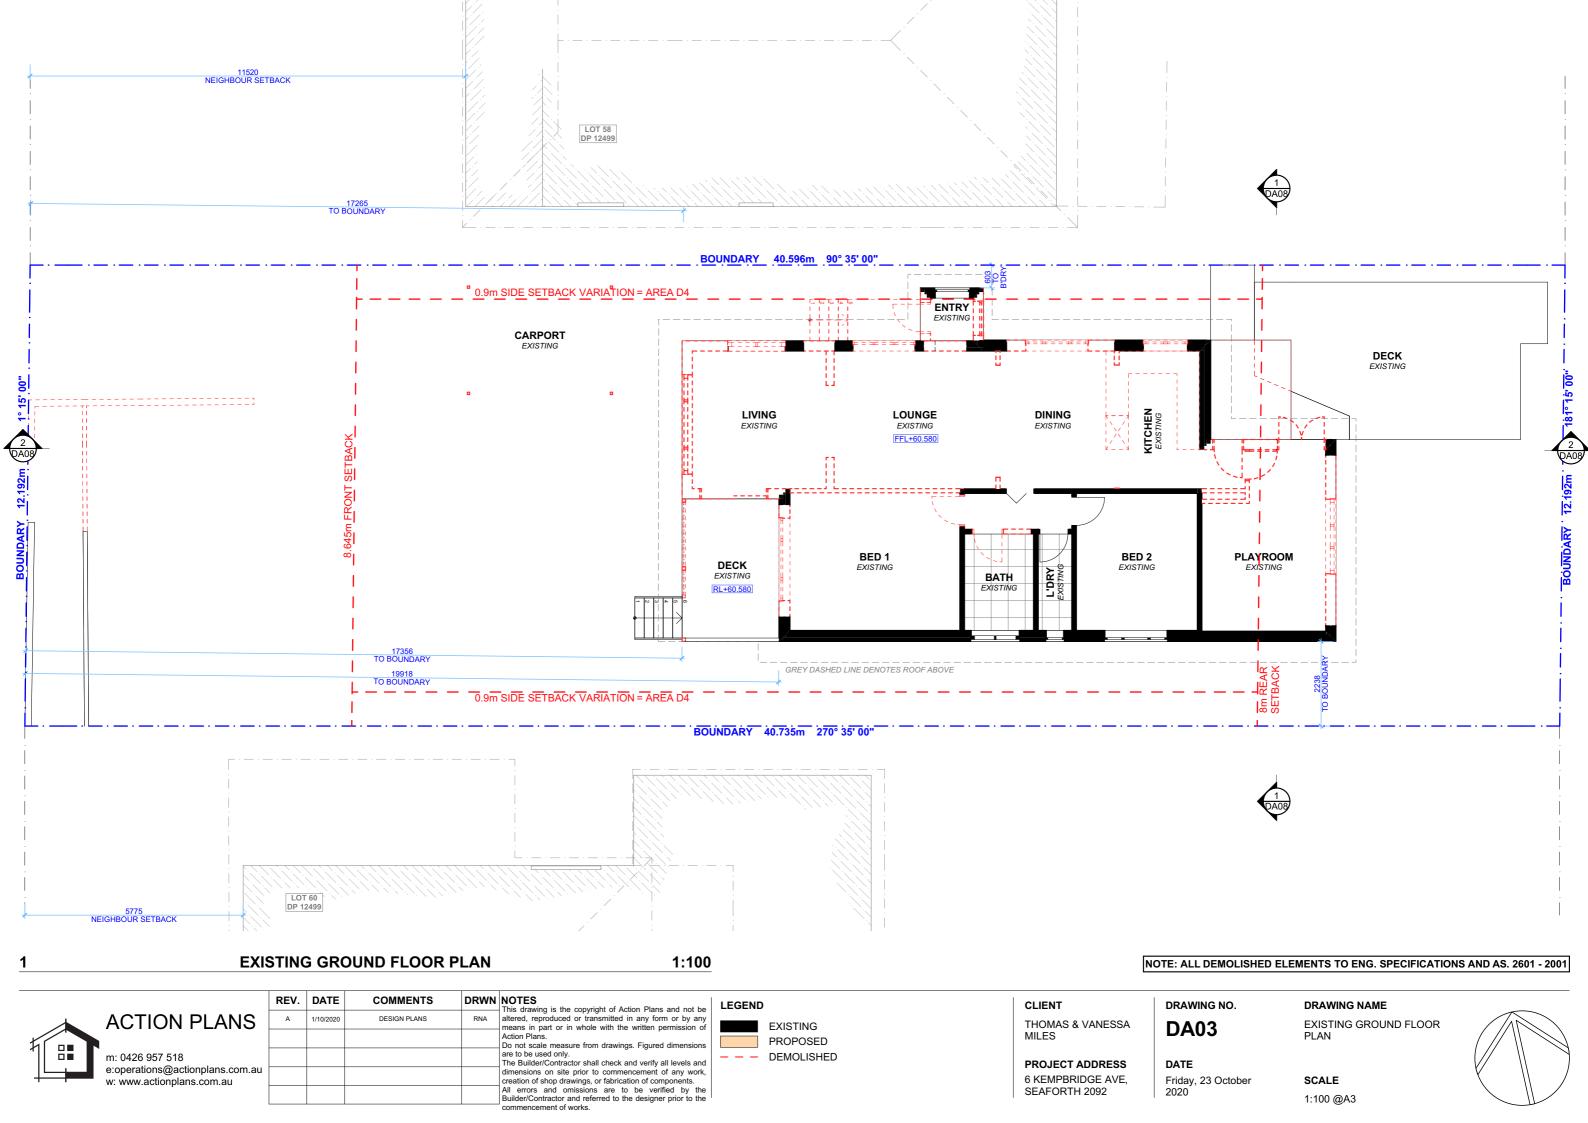

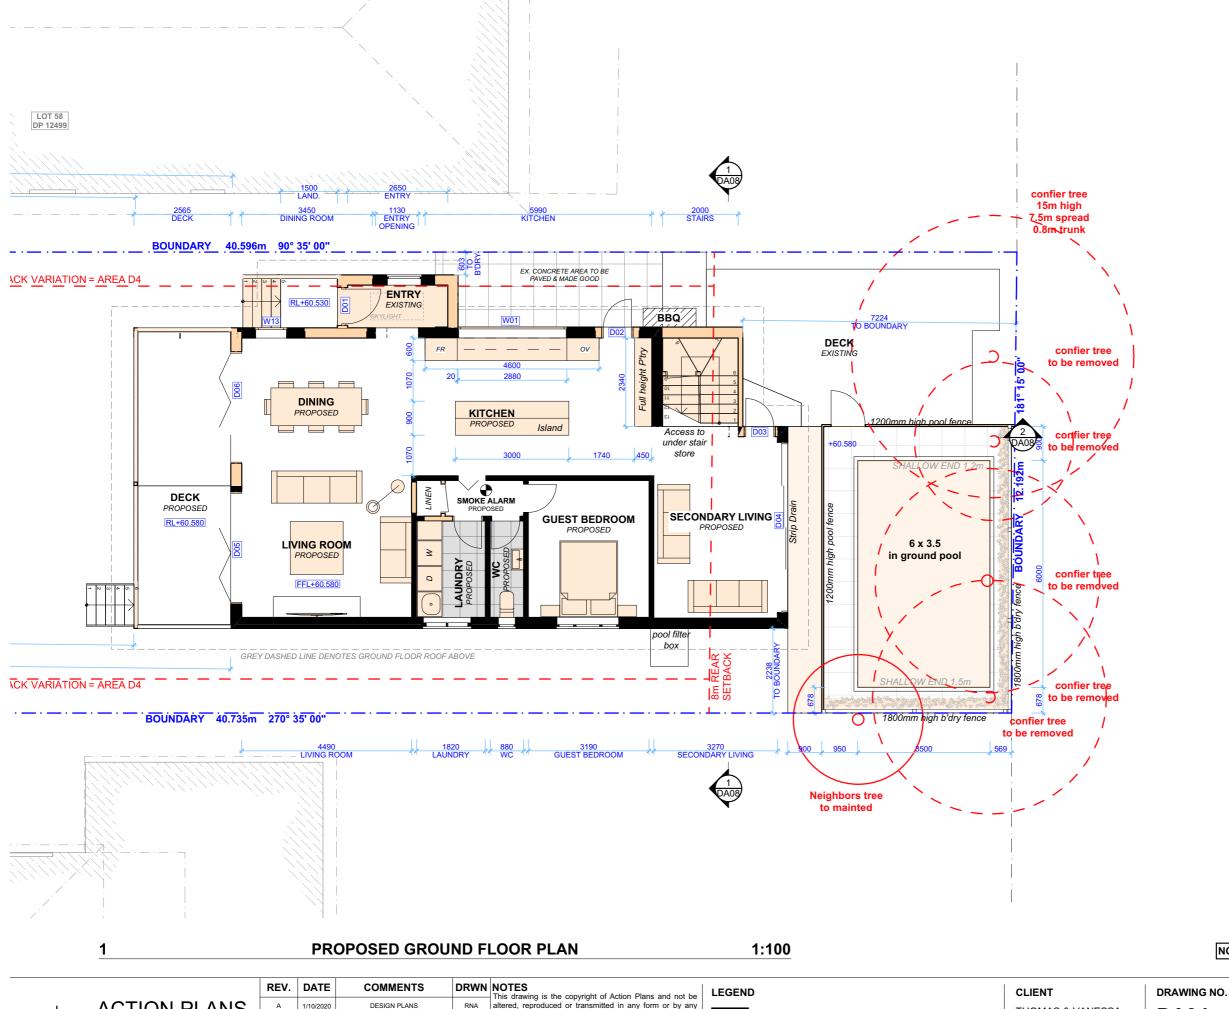

NOTE: SMOKE ALARMS TO COMPLY WITH PART 3.7.2 OF THE NCC



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EXISTING PROPOSED — — DEMOLISHED

THOMAS & VANESSA MILES

PROJECT ADDRESS 6 KEMPBRIDGE AVE, SEAFORTH 2092

DA04

DATE


Friday, 23 October 2020


DRAWING NAME


PROPOSED GROUND FLOOR


PLAN

SCALE 1:100 @A3

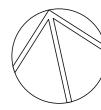


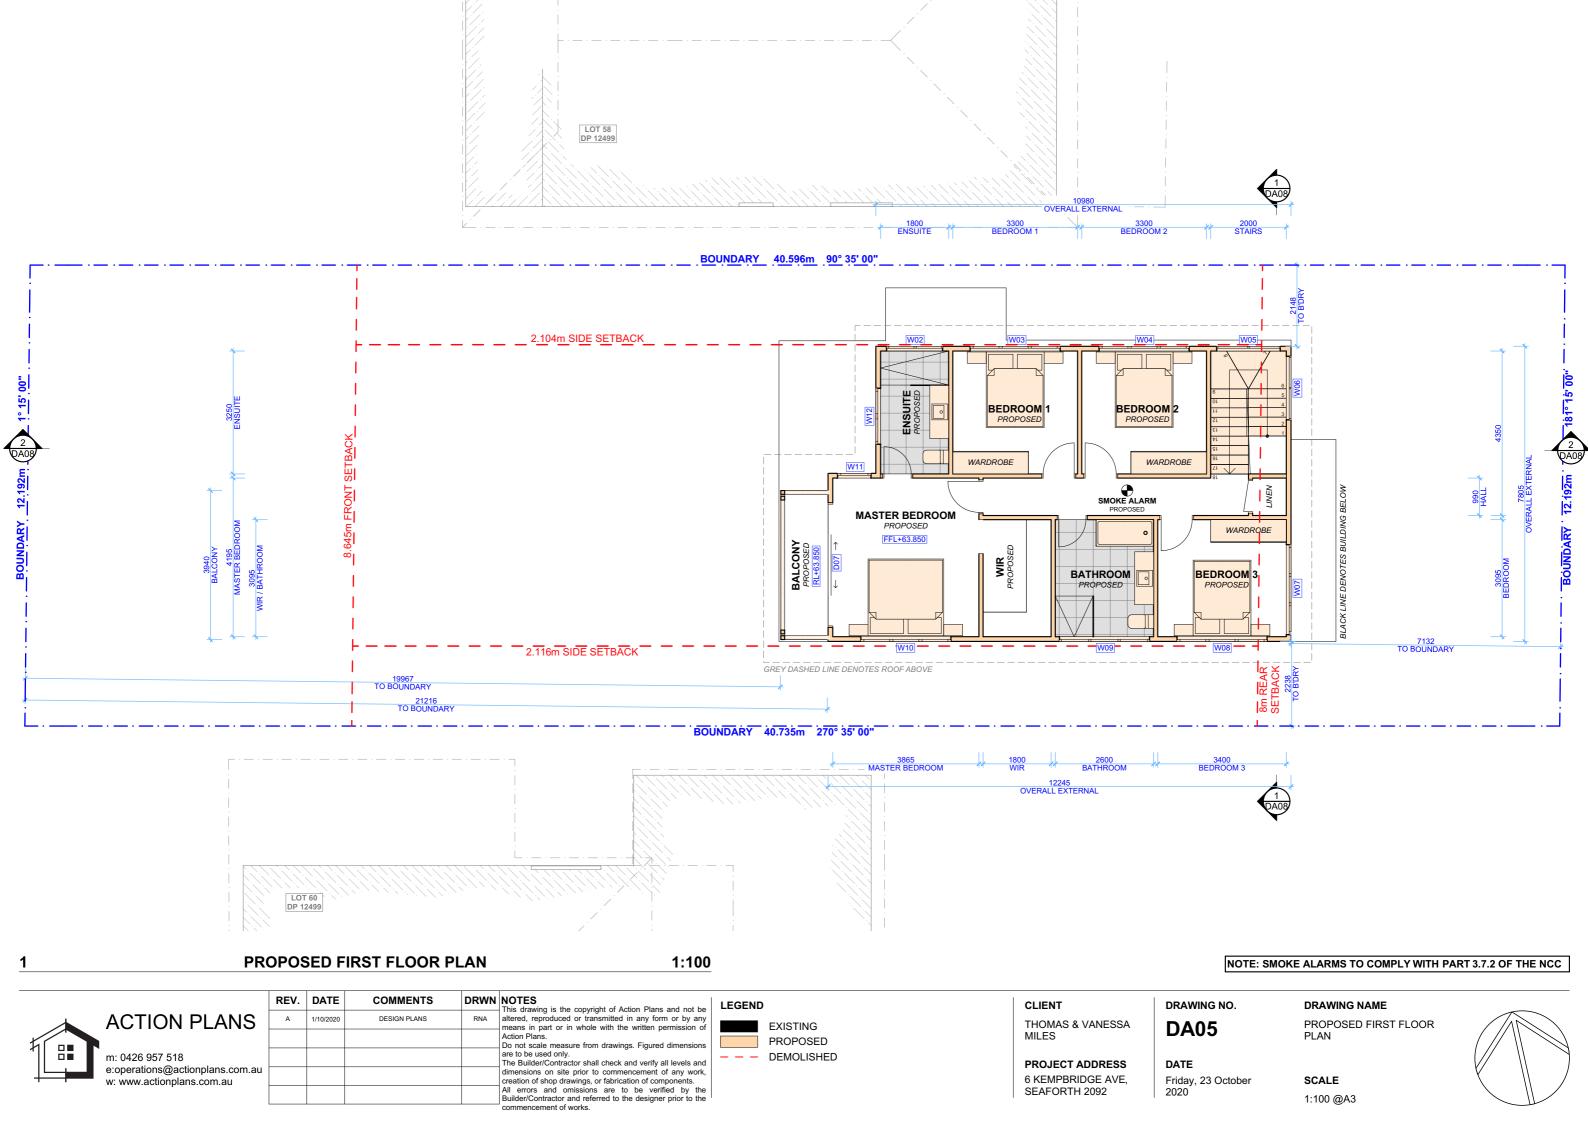


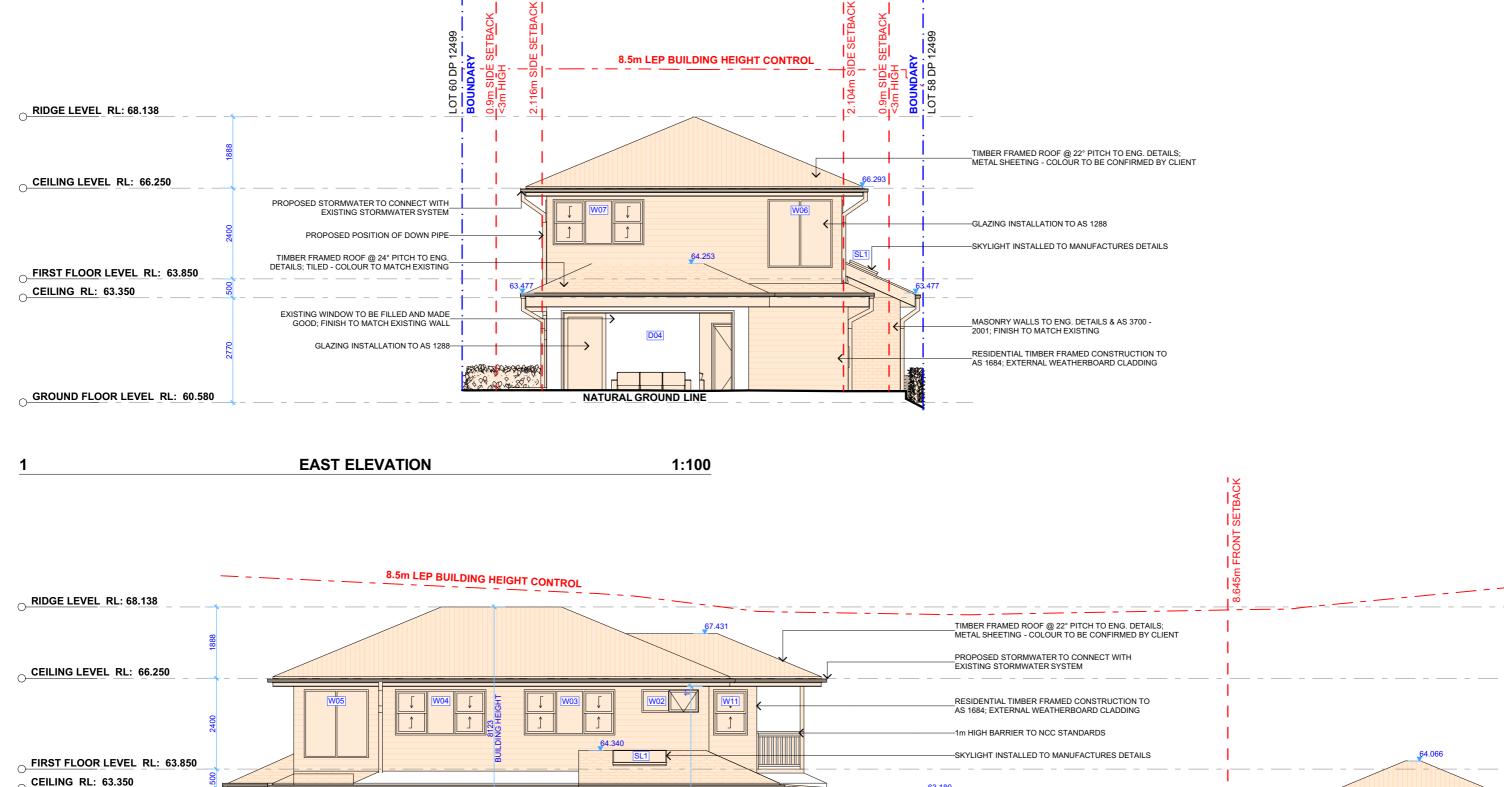


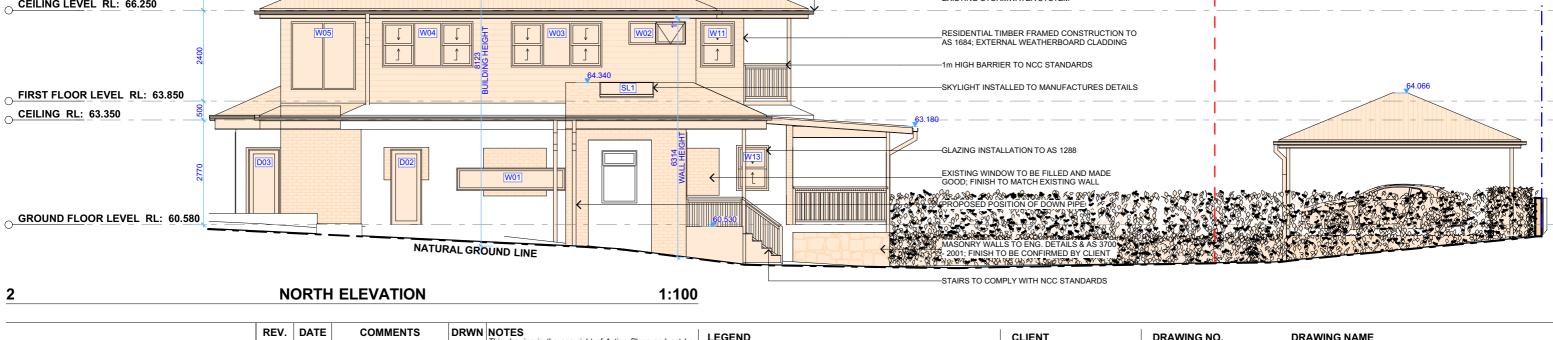


BOUNDARY KEMPBRIDGE AVENUE

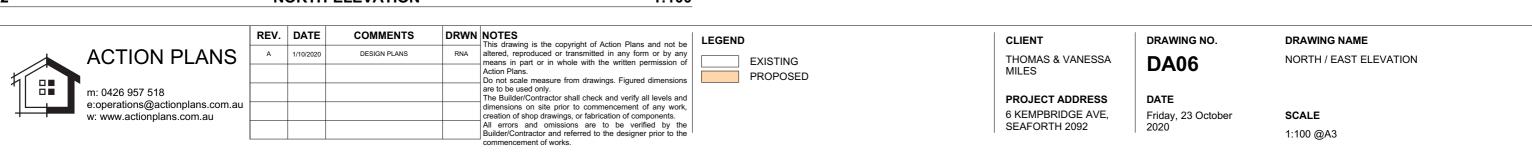

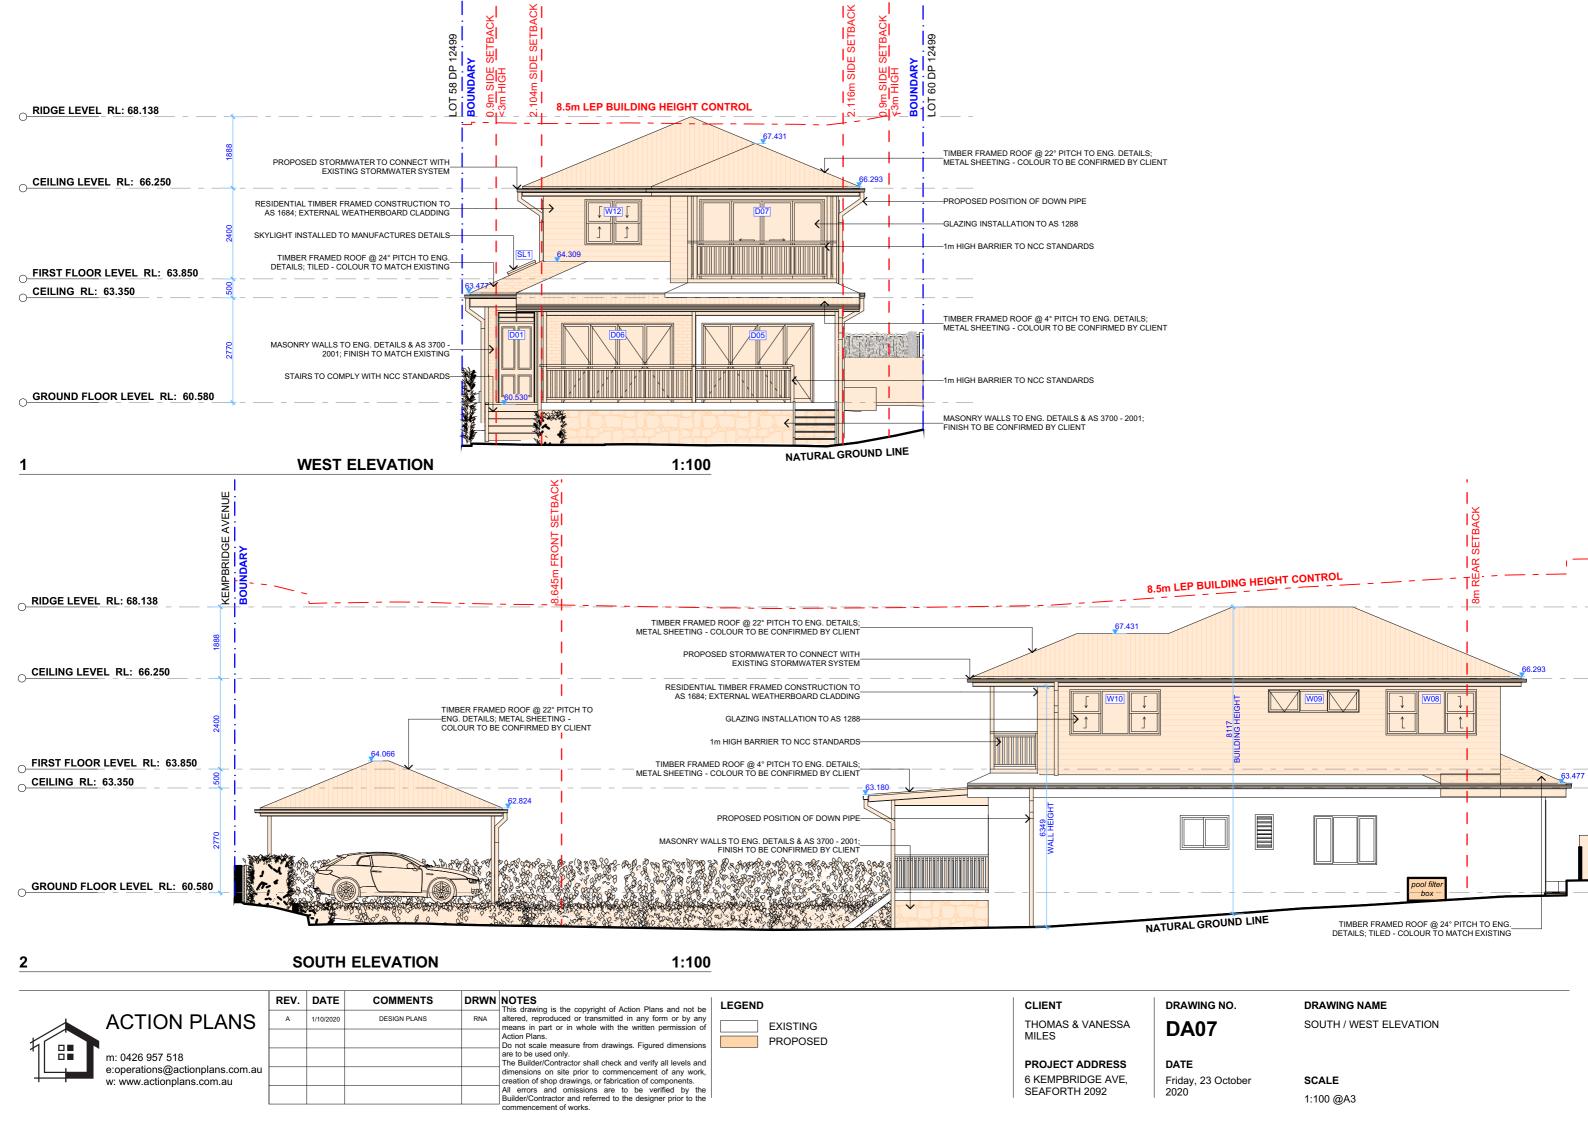

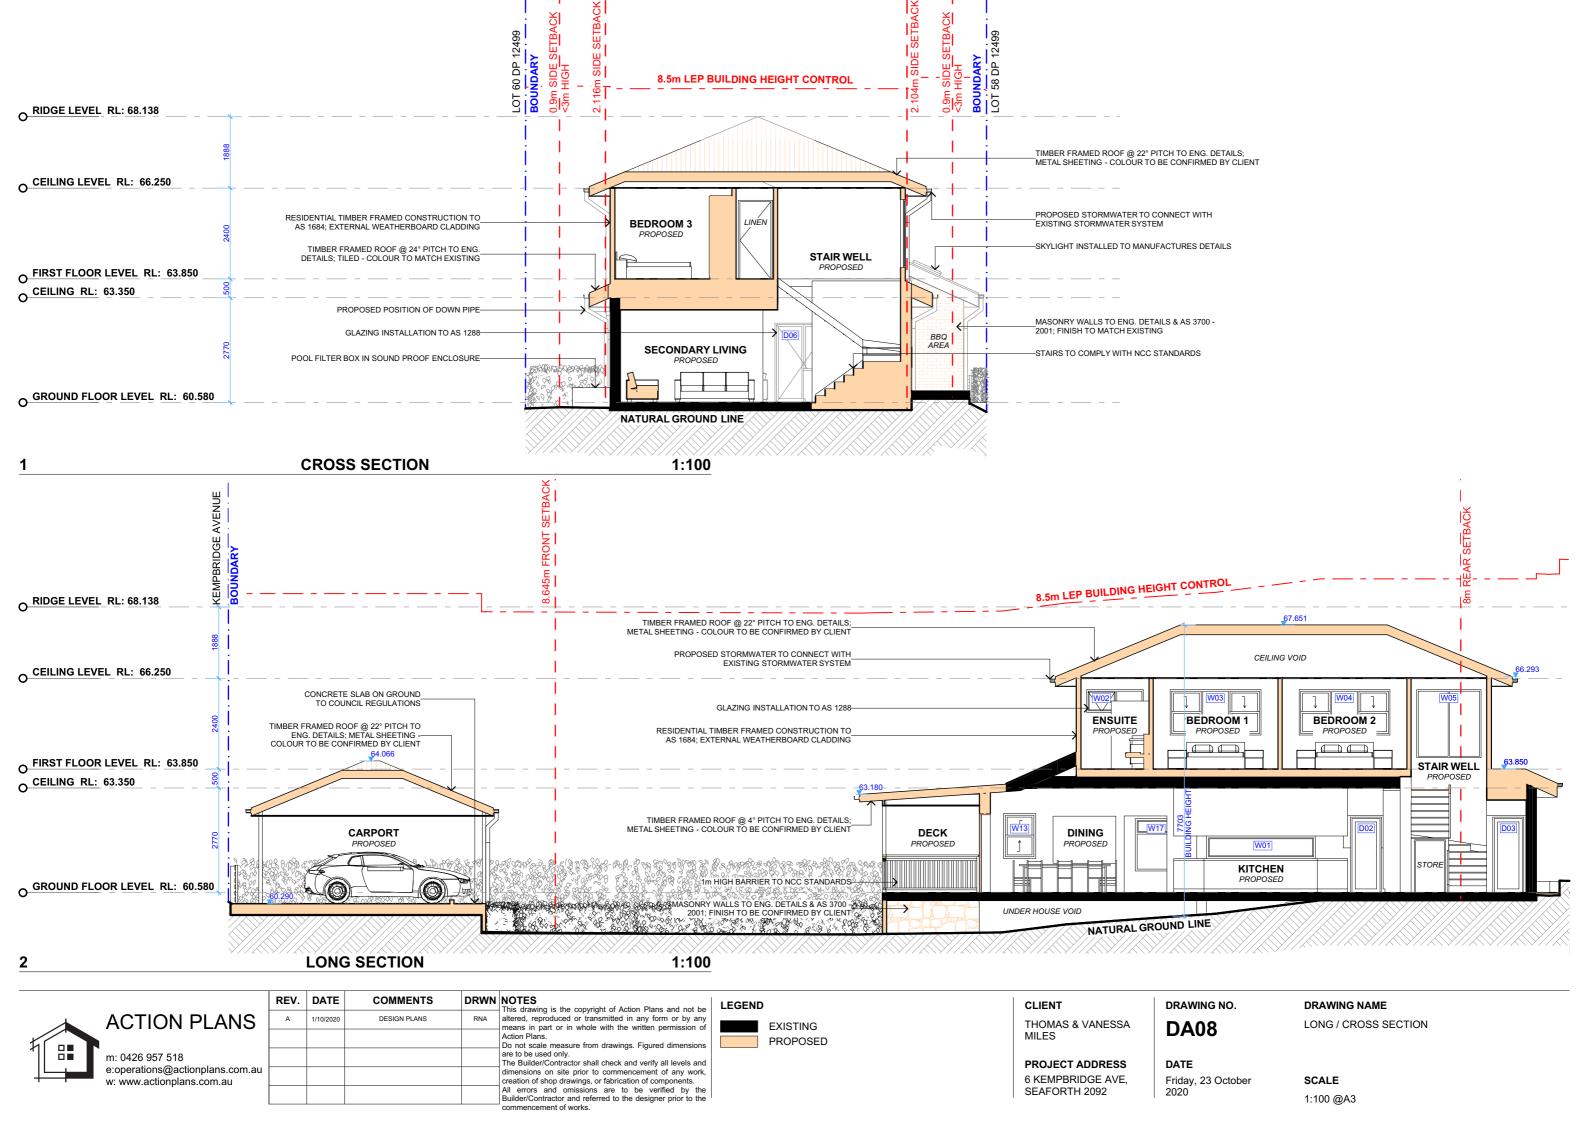

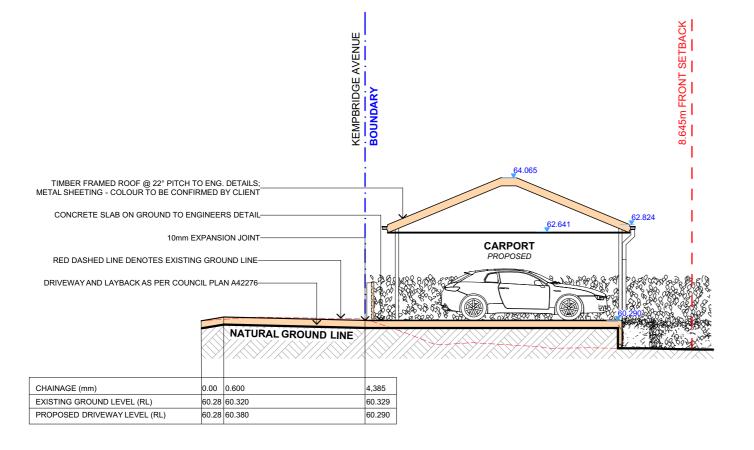

DRIVEWAY LONG SECTION

ш GRASS ENTRY GATE Ш 4 Ш 2 DRIVEWAY CARPORT RL+60.290 PROPOSED X \mathbf{m} <u>_</u> Ш PROPOSED DRIVEWAY PLAN 1:100

RIDGE LEVEL RL: 68.138

Sept. 40 Sept. 10 Sept.

1:100

2 FRONT BOUNDARY FENCE ELEVATION 1:100



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NATURAL GROUND LINE

3


CLIENT
THOMAS & VANESSA
MILES


PROJECT ADDRESS 6 KEMPBRIDGE AVE, SEAFORTH 2092 DA09

DATE Friday, 23 October 2020 DRAWING NAME

DRIVEWAY PLAN / LONG SECTION / FRONT FENCE ELEVATION

SCALE 1:100 @A3

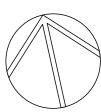

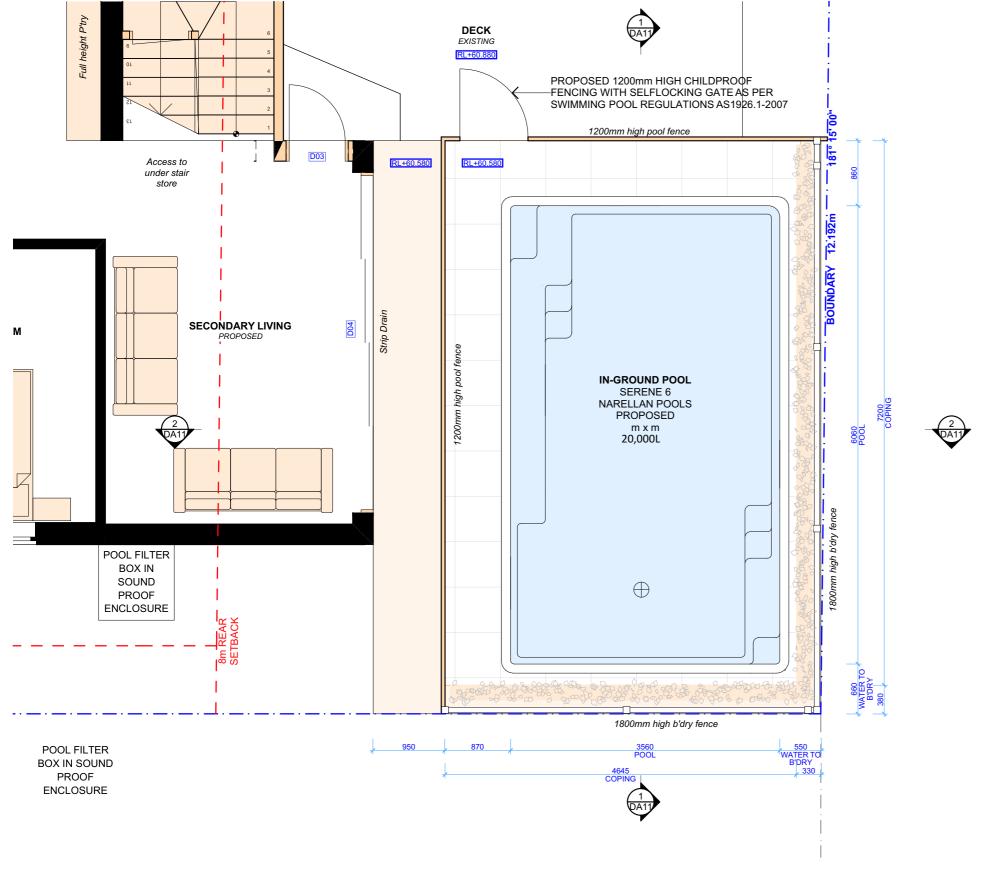

POOL PLAN 1:50

Builder/Contractor and referred to the designer prior to the

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LEGEND **EXISTING** PROPOSED — — DEMOLISHED

THOMAS & VANESSA

MILES

PROJECT ADDRESS 6 KEMPBRIDGE AVE. SEAFORTH 2092

DRAWING NO.

DA10

DRAWING NAME POOL PLAN

Building Code of Australia (BCA) requirement (for version of BCA applicable as on the date of

Part 3.6 Glazing, requires all glazing to comply with AS 1288-

members to comply with Structural Loading Code AS 2280.1-

Part 3.9.3, of the BCA specifies all requirements of swimming

Part 3.9.4. of the BCA specifies all requirements of swimming

pool and spa recirculation systems. AS1926.3-2010 shall be

2002. Glass with a high potential for human impact shall strictly comply with the human impact safety requirements of

pool safety fencing. Compliance with As1926.1-2012,

fence/barriers. 1200mm high pool fence/barriers shall surround the pool with no doors of building permitted to open onto pool areas. Any windows shall be sufficiently protected in accordance with AS1926.1-2012. NCZ shall be provided to all swimming pool safety fence/barriers in accordance with

AS1926.1-2012. AS 1288 2006 specifies glazing requirements when glass is incorporated into a pool fence/barrier. Certification post construction will be required.

complied with and certified post construction

including 1800mm high boundary fencing acting as pool

2006 and AS 2047-1999. The BCA requires glazing

submission of CC or CDC)

the BCA

Friday, 23 October

CLIENT

Design Specification

All glazing including decals shall

comply with AS 1288.1-2006, AS

2047-1999 and AS 1170.1-2002

Swimming Pool Safety Fencing

Swimming Pool Recirculation

PLANTING WITHIN THE VICINITY OF THE POOL ENCLOSURE

MUST BE OF A SPECIES / STYLE THAT WILL COMPLY WITH

(AS 1926.1) TO ENSURE THAT THERE AREA


NO

CLIMABLE / FOOTHOLD FEATURES. BOUNDARY FENCES MUST BE 1.8M HIGH ABOVE FINISHED POOL ENCLOSURE LEVEL MEASURED 500MM OUTWARDS FROM THE BASE OF THIS FENCE.

Systems

DATE

SCALE 1:50 @A3

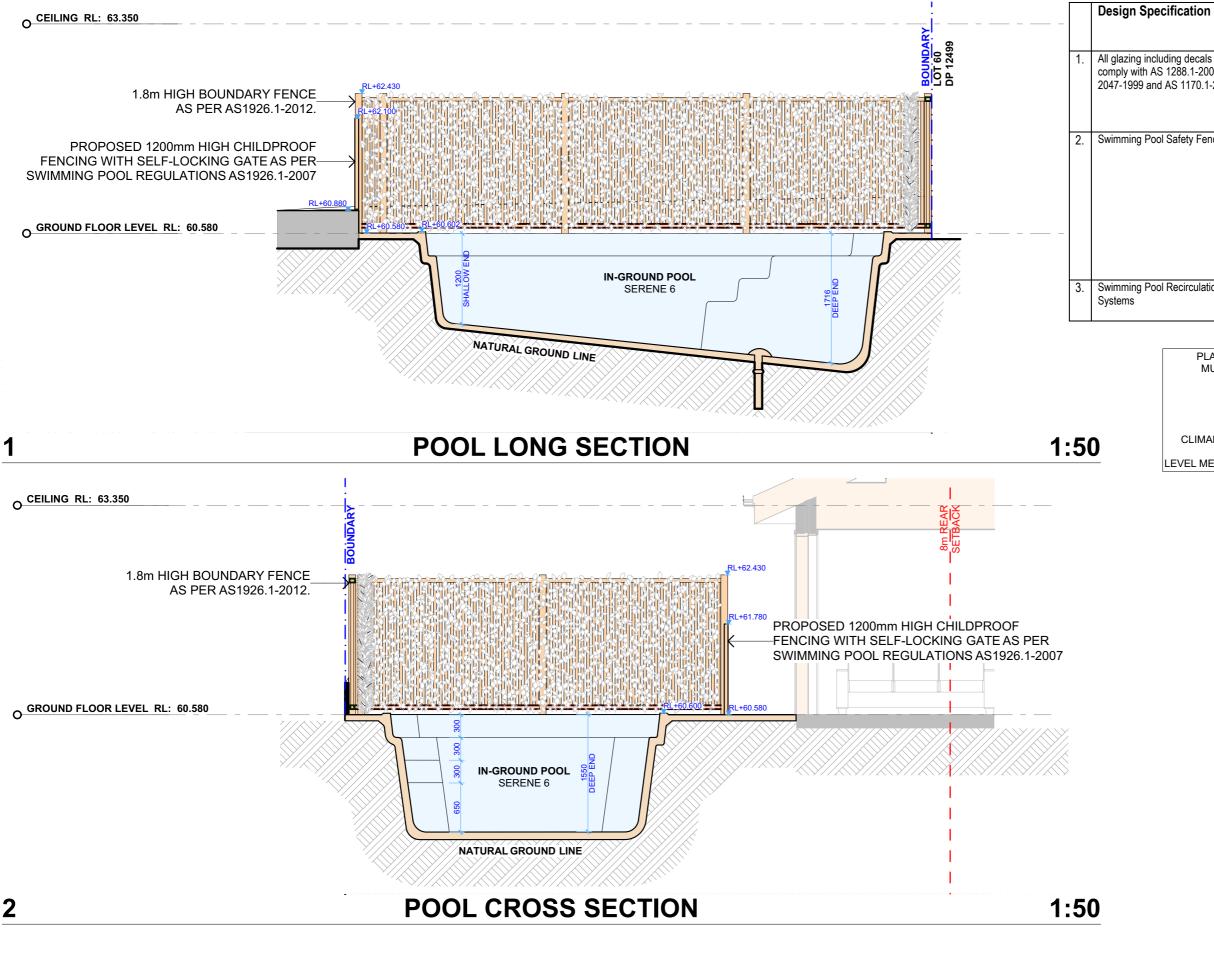

	Design Specification	Building Code of Australia (BCA) requirement (for version of BCA applicable as on the date of submission of CC or CDC)
1.	All glazing including decals shall comply with AS 1288.1-2006, AS 2047-1999 and AS 1170.1-2002	Part 3.6 Glazing, requires all glazing to comply with AS 1288-2006 and AS 2047-1999. The BCA requires glazing members to comply with Structural Loading Code AS 2280.1-2002. Glass with a high potential for human impact shall strictly comply with the human impact safety requirements of the BCA
2.	Swimming Pool Safety Fencing	Part 3.9.3, of the BCA specifies all requirements of swimming pool safety fencing. Compliance with As1926.1-2012, including 1800mm high boundary fencing acting as pool fence/barriers. 1200mm high pool fence/barriers shall surround the pool with no doors of building permitted to open onto pool areas. Any windows shall be sufficiently protected in accordance with AS1926.1-2012. NCZ shall be provided to all swimming pool safety fence/barriers in accordance with AS1926.1-2012. AS 1288 2006 specifies glazing requirements when glass is incorporated into a pool fence/barrier. Certification post construction will be required.
3.	Swimming Pool Recirculation Systems	Part 3.9.4. of the BCA specifies all requirements of swimming pool and spa recirculation systems. AS1926.3-2010 shall be complied with and certified post construction

PLANTING WITHIN THE VICINITY OF THE POOL ENCLOSURE MUST BE OF A SPECIES / STYLE THAT WILL COMPLY WITH (AS 1926.1) TO ENSURE THAT THERE AREA

NO


CLIMABLE / FOOTHOLD FEATURES. BOUNDARY FENCES MUST BE 1.8M HIGH ABOVE FINISHED POOL ENCLOSURE LEVEL MEASURED 500MM OUTWARDS FROM THE BASE OF THIS FENCE.




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REV. DATE

COMMENTS

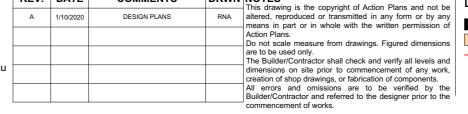

DRWN NOTES

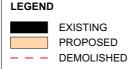

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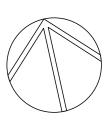
DA11


DATE Friday, 23 October 2020


POOL SECTIONS

DRAWING NAME


SCALE 1:50 @A3



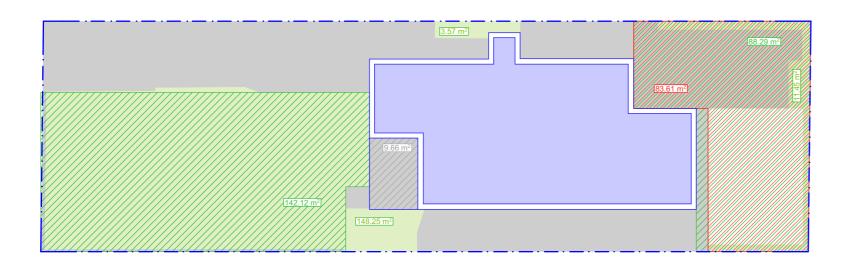

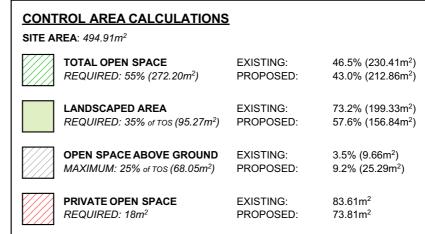

EXISTING AREA CALCULATIONS

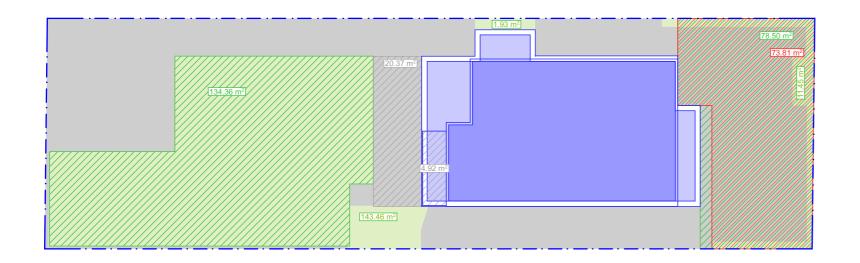

PROPOSED AREA CALCULATIONS 1:200



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LEGEND

1:200

THOMAS & VANESSA MILES

CLIENT

PROJECT ADDRESS6 KEMPBRIDGE AVE,


SEAFORTH 2092


DA12

DRAWING NO.

DATE Eriday 2 DRAWING NAME
AREA CALCULATIONS


Friday, 23 October SCALE 2020 1:200 @A3

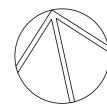


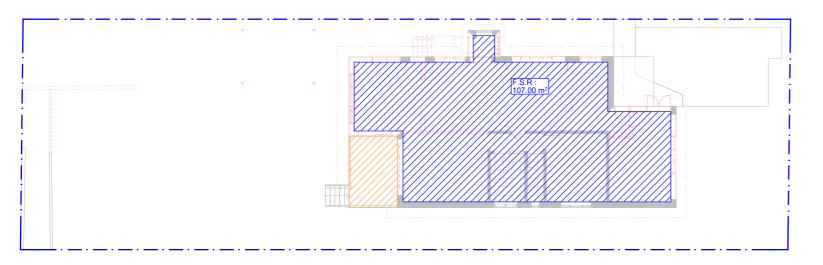

CONTROL F.S.R CALCULATIONS SITE AREA: 494.91m² FLOOR SPACE RATIO EXISTING: 0.21:1 (107.00m²) MAXIMUM: 0.50 : 1 (247.45m²) 0.37 : 1 (185.58m²) PROPOSED: **FSR - EXCLUDED AREAS** MAXIMUM: N/A

EXISTING FSR CALCULATIONS: GROUND FLOOR LEVEL

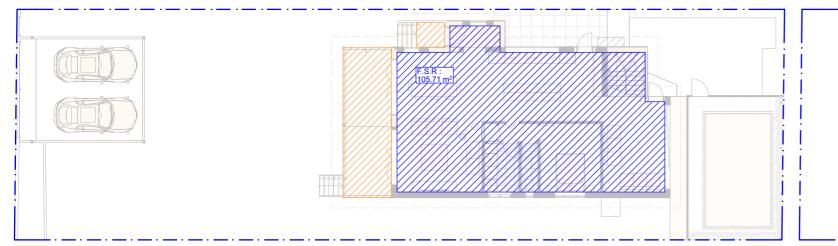

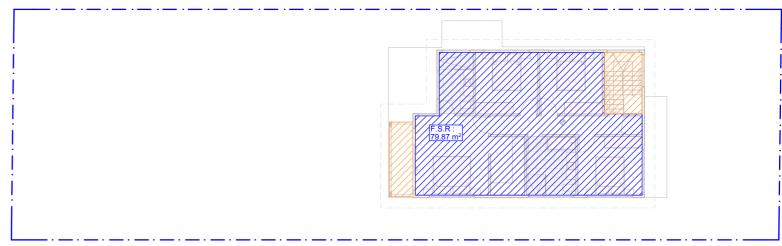

PROPOSED FSR CALCULATIONS: GROUND FLOOR LEVEL

1:200

1:200

PROPOSED FSR CALULATIONS: FIRST FLOOR LEVEL

1:200

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LEGEND

3

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PROJECT ADDRESS

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6 KEMPBRIDGE AVE, SEAFORTH 2092

DRAWING NO. **DA13**

DATE Friday, 23 October


2020

SCALE

DRAWING NAME

1:200 @A3

FSR CALCULATIONS

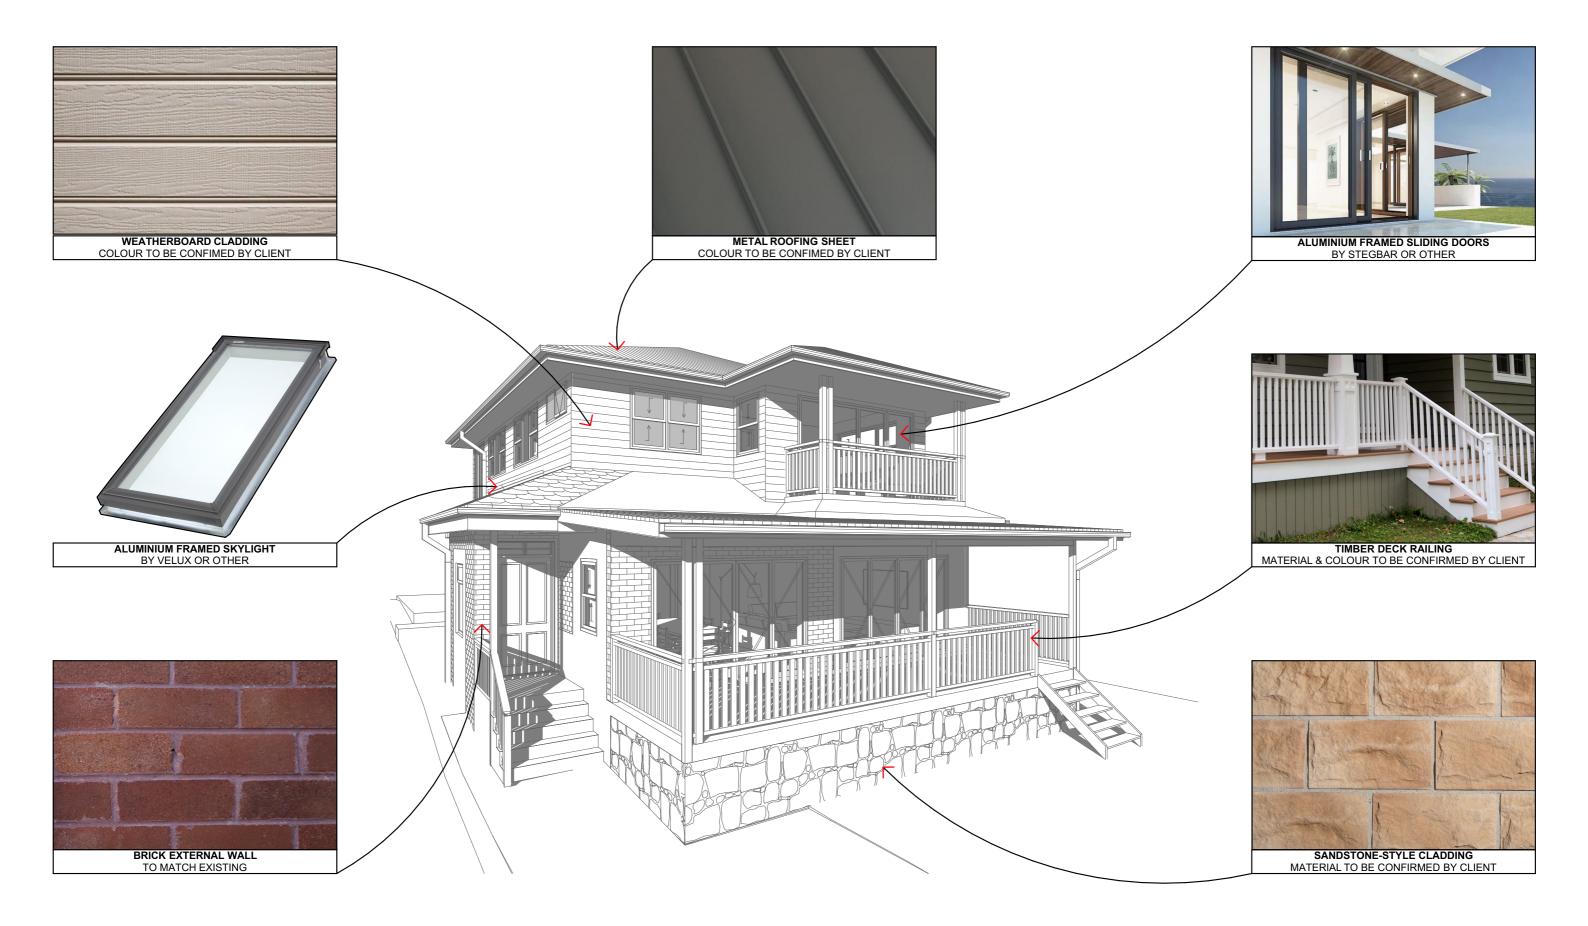

SAMPLE BOARD



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LEGEND

CLIENT THOMAS & VANESSA MILES

PROJECT ADDRESS

6 KEMPBRIDGE AVE, SEAFORTH 2092 DRAWING NO.


DA14

4 SAMPLE BOARD

DATE


Friday, 23 October 2020 SCALE @A3

DRAWING NAME

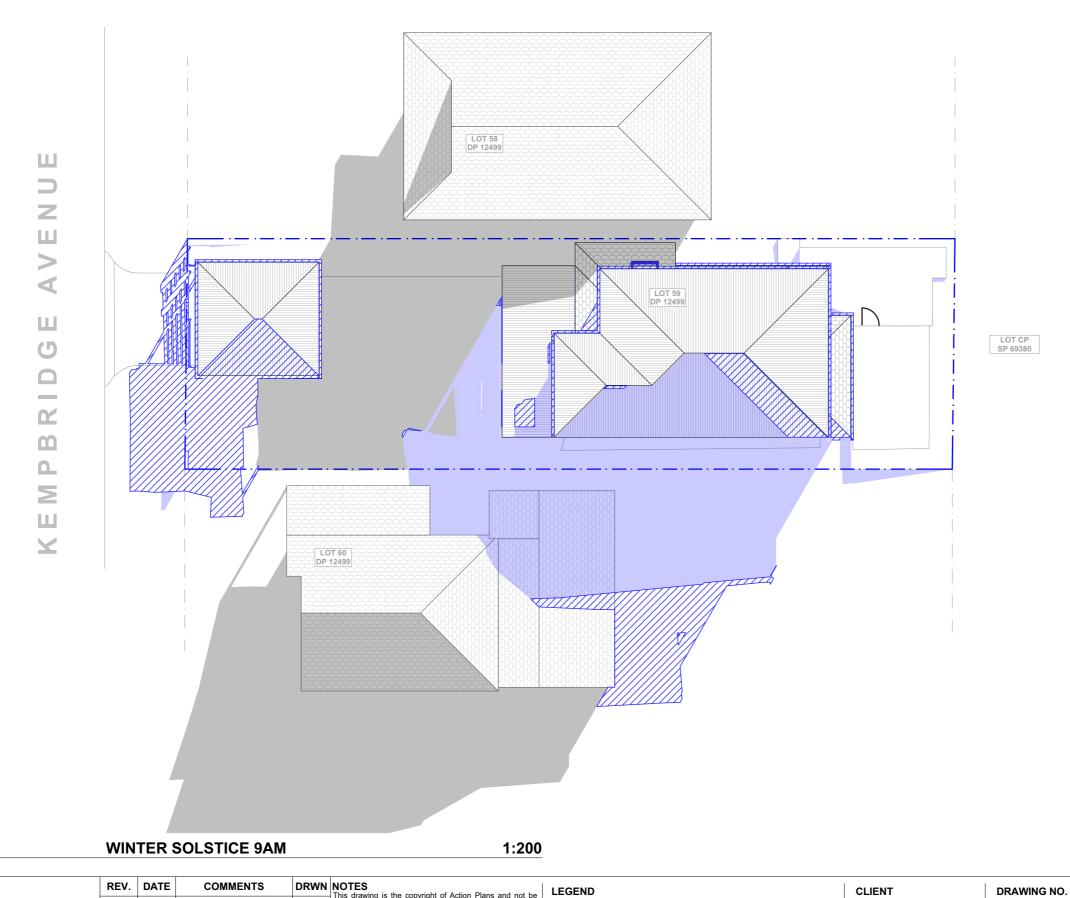

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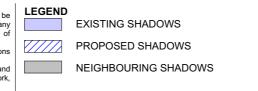
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All errors and omissions are to be verified by the Builder/Contractor and referred to the designer prior to the commencement of works. DRAWING NAME **ACTION PLANS** EXISTING SHADOWS 1/10/2020 DESIGN PLANS THOMAS & VANESSA MILES WINTER SOLSTICE 9 AM **DA15** PROPOSED SHADOWS m: 0426 957 518 e:operations@actionplans.com.au NEIGHBOURING SHADOWS PROJECT ADDRESS DATE Friday, 23 October 2020 6 KEMPBRIDGE AVE, SCALE w: www.actionplans.com.au SEAFORTH 2092 1:200 @A3 commencement of works.

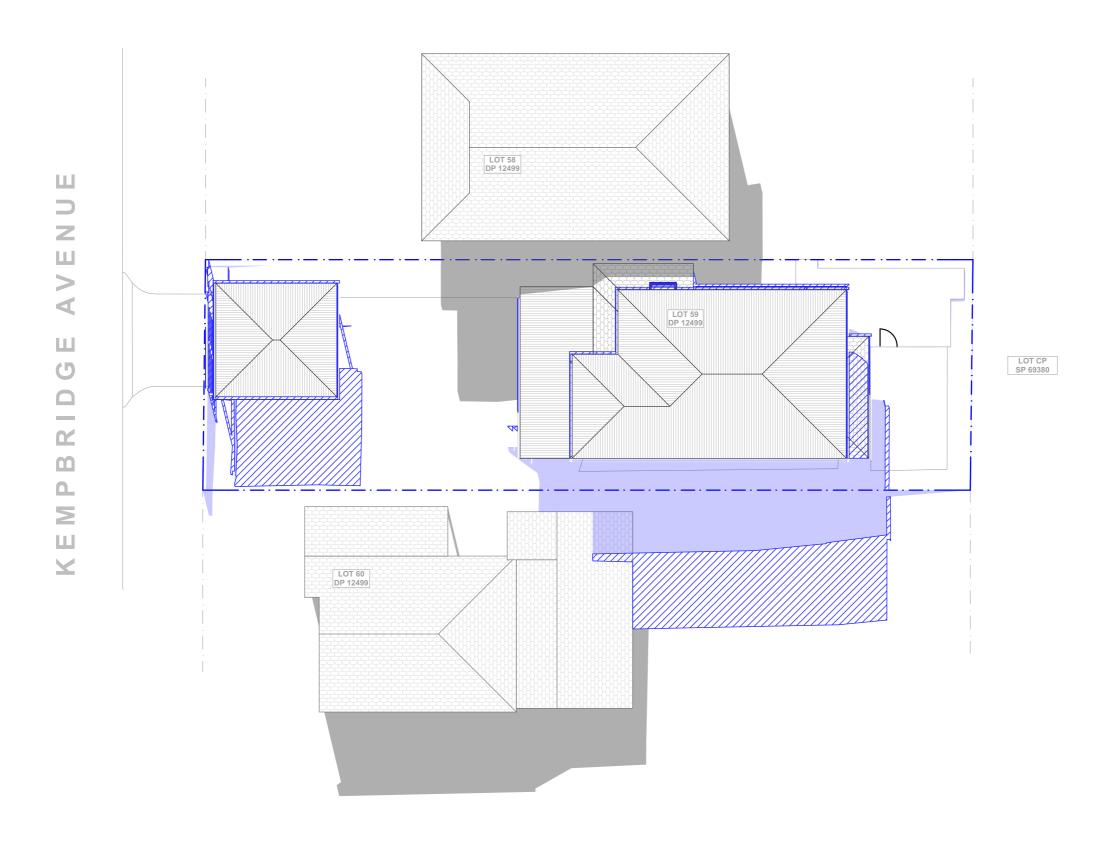

1 WINTER SOLSTICE 12PM 1:200



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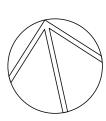



CLIENT THOMAS & VANESSA MILES

PROJECT ADDRESS 6 KEMPBRIDGE AVE, SEAFORTH 2092 DRAWING NO.

DATE Friday, 23 October 2020 **DRAWING NAME**WINTER SOLSTICE 12 PM

SCALE 1:200 @A3




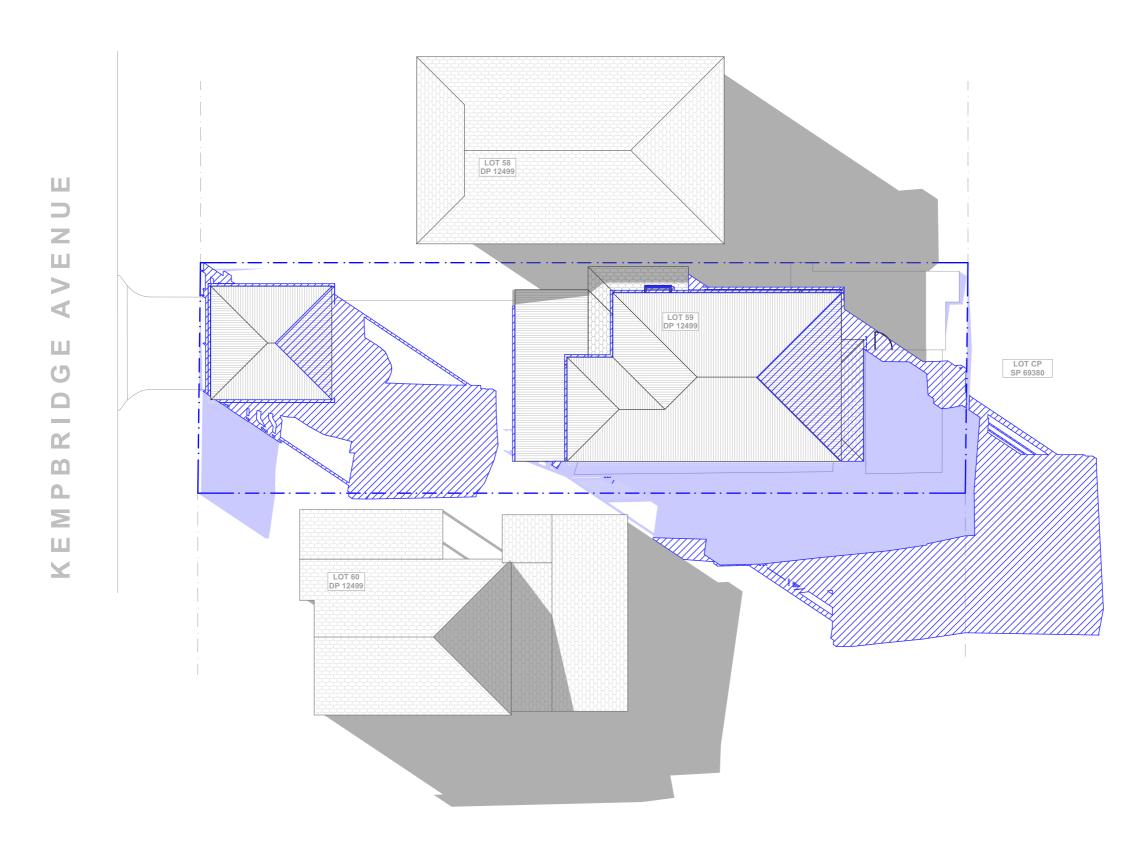

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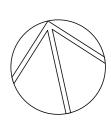
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DATE Friday, 23 October 2020 WINTER SOLSTICE 3 PM

DRAWING NAME

SCALE 1:200 @A3

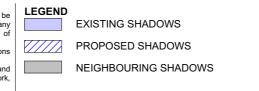



Building Sustainability Index www.basix.nsw.gov.au

Alterations and Additions

Certificate number: A380197_02

This certificate confirms that the proposed development will meet the NSW government's requirements for sustainability, if it is built in accordance with the commitments set out below. Terms used in this certificate, or in the commitments, have the meaning given by the document entitled "BASIX Alterations and Additions Definitions" dated 06/10/2017 published by the Department. This document is available at www.basix.nsw.gov.au

Secretary
Date of issue: Friday, 23, October 2020
To be valid, this certificate must be lodged within 3 months of the date of issue.



Project name	6 Kempbridge Avenue Seaforth_02
Street address	6 Kempbridge Avenue Seaforth 2092
Local Government Area	Northern Beaches Council
Plan type and number	Deposited Plan 12499
Lot number	59
Section number	
Project type	
Dwelling type	Separate dwelling house
Type of alteration and addition	My renovation work is valued at \$50,000 or more and includes a pool (and/or spa).

Certificate Prepared by (please complete before submitting to Council or PCA)
Name / Company Name: Action Plans
ABN (if applicable): 17118297587

Pool and Spa	Show on DA Plans	Show on CC/CDC Plans & specs	Certifier Check
Outdoor swimming pool			
The swimming pool must be outdoors.	✓	✓	V
The swimming pool must not have a capacity greater than 20 kilolitres.	✓	✓	~
The swimming pool must have a pool cover.		✓	~
The applicant must install a pool pump timer for the swimming pool.		✓	~
The applicant must not incorporate any heating system for the swimming pool that is part of this development.		✓	✓
Fixtures and systems	Show on DA Plans	Show on CC/CDC Plans &	Certifier Check

Fixtures and systems	Show on DA Plans	Show on CC/CDC Plans & specs	Certifier Check
Lighting			
The applicant must ensure a minimum of 40% of new or altered light fixtures are fitted with fluorescent, compact fluorescent, or light-emitting-diode (LED) lamps.		~	✓
Fixtures			
The applicant must ensure new or altered showerheads have a flow rate no greater than 9 litres per minute or a 3 star water rating.		✓	✓
The applicant must ensure new or altered toilets have a flow rate no greater than 4 litres per average flush or a minimum 3 star water rating.		✓	✓
The applicant must ensure new or altered taps have a flow rate no greater than 9 litres per minute or minimum 3 star water rating.		✓	
Construction	Show on	Show on	Certifier

Construction	Show on DA Plans	Show on CC/CDC Plans & specs	Certifier Check		
Insulation requirements					
The applicant must construct the new or altered the table below, except that a) additional insulat is not required for parts of altered construction v	ion is not required where the area of new constr		√	✓	✓
Construction	Additional insulation required (R-value)	Other specifications			
suspended floor with open subfloor: framed (R0.7).	R0.8 (down) (or R1.50 including construction)				
suspended floor with enclosed subfloor: framed (R0.7).	R0.60 (down) (or R1.30 including construction)				
floor above existing dwelling or building.	nil				
external wall: framed (weatherboard, fibro, metal clad)	R1.30 (or R1.70 including construction)				
external wall: cavity brick	nil				
flat ceiling, pitched roof	ceiling: R3.00 (up), roof: foil/sarking	medium (solar absorptance 0.475 - 0.70)			

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In these commitments, "applicant" means the person carrying out the development.

Commitments identified with a "\script" in the "Show on DA plans" column must be shown on the plans accompanying the development application for the proposed development (if a development application is to be lodged for the proposed development).

Commitments identified with a "\scrip*" in the "Show on CC/CDC plans & specs" column must be shown in the plans and specifications accompanying the application for a construction certificate / complying development certificate for the proposed development.

Commitments identified with a "v" in the "Certifier check" column must be certified by a certifying authority as having been fulfilled, before a final occupation certificate for the

Glazing re	quirements						Show on DA Plans	Show on CC/CDC Plans & specs	Certifier Check
Windows a	ınd glazed	doors							
					nading devices, in accordanc reach window and glazed do	e with the specifications listed in the table below. or.	~	~	~
The following	g requiremen	ts must also	be satisfi	ed in relation	to each window and glazed	door:		✓	✓
have a U-va	lue and a Sol	ar Heat Gai	in Coefficie	ent (SHGC) r		or toned glass may either match the description, or, the table below. Total system U-values and SHGCs ditions.		~	~
Each window or glazed door with improved frames, or pyrolytic low-e glass, or clear/air gap/clear glazing, or toned/air gap/clear glazing mu have a U-value and a Solar Heat Gain Coefficient (SHGC) no greater than that listed in the table below. Total system U-values and SHGCs must be calculated in accordance with National Fenestration Rating Council (NFRC) conditions. The description is provided for information only. Alternative systems with complying U-value and SHGC may be substituted.								~	~
For projection	ns described	in millimetr	es, the lea	iding edge of	-	ah, balcony or awning must be no more than 500 mm	✓	✓	~
Pergolas wit	h polycarbon	ate roof or s	similar trar	slucent mate	erial must have a shading coe	efficient of less than 0.35.		~	✓
					e window or glazed door abo ens must not be more than 50	ve which they are situated, unless the pergola also 0 mm.		~	~
	ving buildings the 'overshad				nt and distance from the cent	re and the base of the window and glazed door, as	✓	~	~
	and glaze					-			
Window / do no.	oor Orientatio	glass	Height	Distance	Shading device	Frame and glass type			
		inc. frame (m2)	(m)	(m)					
W1	N	0.84	0	0	eave/verandah/pergola/bal >=600 mm	cony standard aluminium, single clear, (or U-value: 7.63, SHGC: 0.75)			
W2	N	0.9	0	0	eave/verandah/pergola/bal >=600 mm	cony standard aluminium, single pyrolytic low-e, (U-value: 5.7, SHGC: 0.47)			
W3	N	2.88	0.305	3.14	eave/verandah/pergola/bal >=600 mm	cony standard aluminium, single pyrolytic low-e, (U-value: 5.7, SHGC: 0.47)			
W4	N	2.88	0	0	eave/verandah/pergola/bal	cony standard aluminium, single pyrolytic low-e, (U-value: 5.7, SHGC: 0.47)			
W5	N	3.06	0	0	eave/verandah/pergola/bal	, ,			
W6	E	3.06	0	0	eave/verandah/pergola/bal				
W7	E	2.88	0	0	eave/verandah/pergola/bal >=600 mm				
W8	S	2.88	0	0	eave/verandah/pergola/bal >=600 mm				
W9	S	1.44	0	0	eave/verandah/pergola/bal				
W10	S	2.88	0	0	eave/verandah/pergola/bal				
W11	N	1.08	0	0	eave/verandah/pergola/bal				
W12	w	1.8	0	0	eave/verandah/pergola/bal				
D1	w	2.4	0	0	eave/verandah/pergola/bal >=900 mm				
D2	N	1.64	0	0	eave/verandah/pergola/bal	cony standard aluminium, single pyrolytic low-e,			
D3	N	1.64	0	0	eave/verandah/pergola/bal				
D4	=	7.35	U	U	>=600 mm 	(U-value: 5.7, SHGC: 0.47) stanuaru atummum, single pyrolytic low-e, (U-value: 5.7, SHGC: 0.47)			
D5	W	6.22	0	0	eave/verandah/pergola/bal				
D6	W	6.22	0	0	eave/verandah/pergola/bal >=900 mm				
D7	W	6.93	0	0	eave/verandah/pergola/bal >=900 mm				
W13	N	1.02	0	0	eave/verandah/pergola/bal	cony standard aluminium, single clear, (or			
Skyliahte					>=900 mm	U-value: 7.63, SHGC: 0.75)			
Skylights The applicar	nt must install	the skyligh	its in accor	dance with the	he specifications listed in the	table below.	V	V	✓
The following	g requiremen	ts must also	be satisfi	ed in relation	to each skylight:			~	✓
Each skyligh the table bel		match the d	lescription	, or, have a L	J-value and a Solar Heat Gai	n Coefficient (SHGC) no greater than that listed in		✓	~
External aw	nings and lou	vres must fi	ully shade	the skylight a	above which they are situated	d when fully drawn or closed.		~	~
Skylights Skylight nur	glazing re		nts Shading	device	From	ne and place type			
	inc. fr	of glazing ame (m2)				ne and glass type			
S1	1.092		external	adjustable a		inium, moulded plastic single clear, (or U-value: , SHGC: 0.808)			

_	ACTION PLANS
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	drawings, or fabrication of components.	
	All errors and omissions are to be verified by the Builder/Contractor and referred to the designer prior to the commencement of works.	
	All window & door dimensions, orientation, glazing materials, opening types, frame types are to be confirmed by a suitably qualified	
	person prior to the ordering of any such materials are to take place.]
	U value takes precedence over glazing type/colour in all cases.	6
	All new glazing must meet the BASIX specified frame and glass type, <u>OR</u> meet the certified U value and SHGC value.	5

CLIENT

THOMAS & VANESSA MILES

PROJECT ADDRESS 6 KEMPBRIDGE AVE, SEAFORTH 2092

DRAWING NO.

DA18

DATE Friday, 23 October 2020

DRAWING NAME BASIX COMMITMENTS