


CONCRETE SLEEPER RETAINING WALL

**BOUNDARY LINE** 

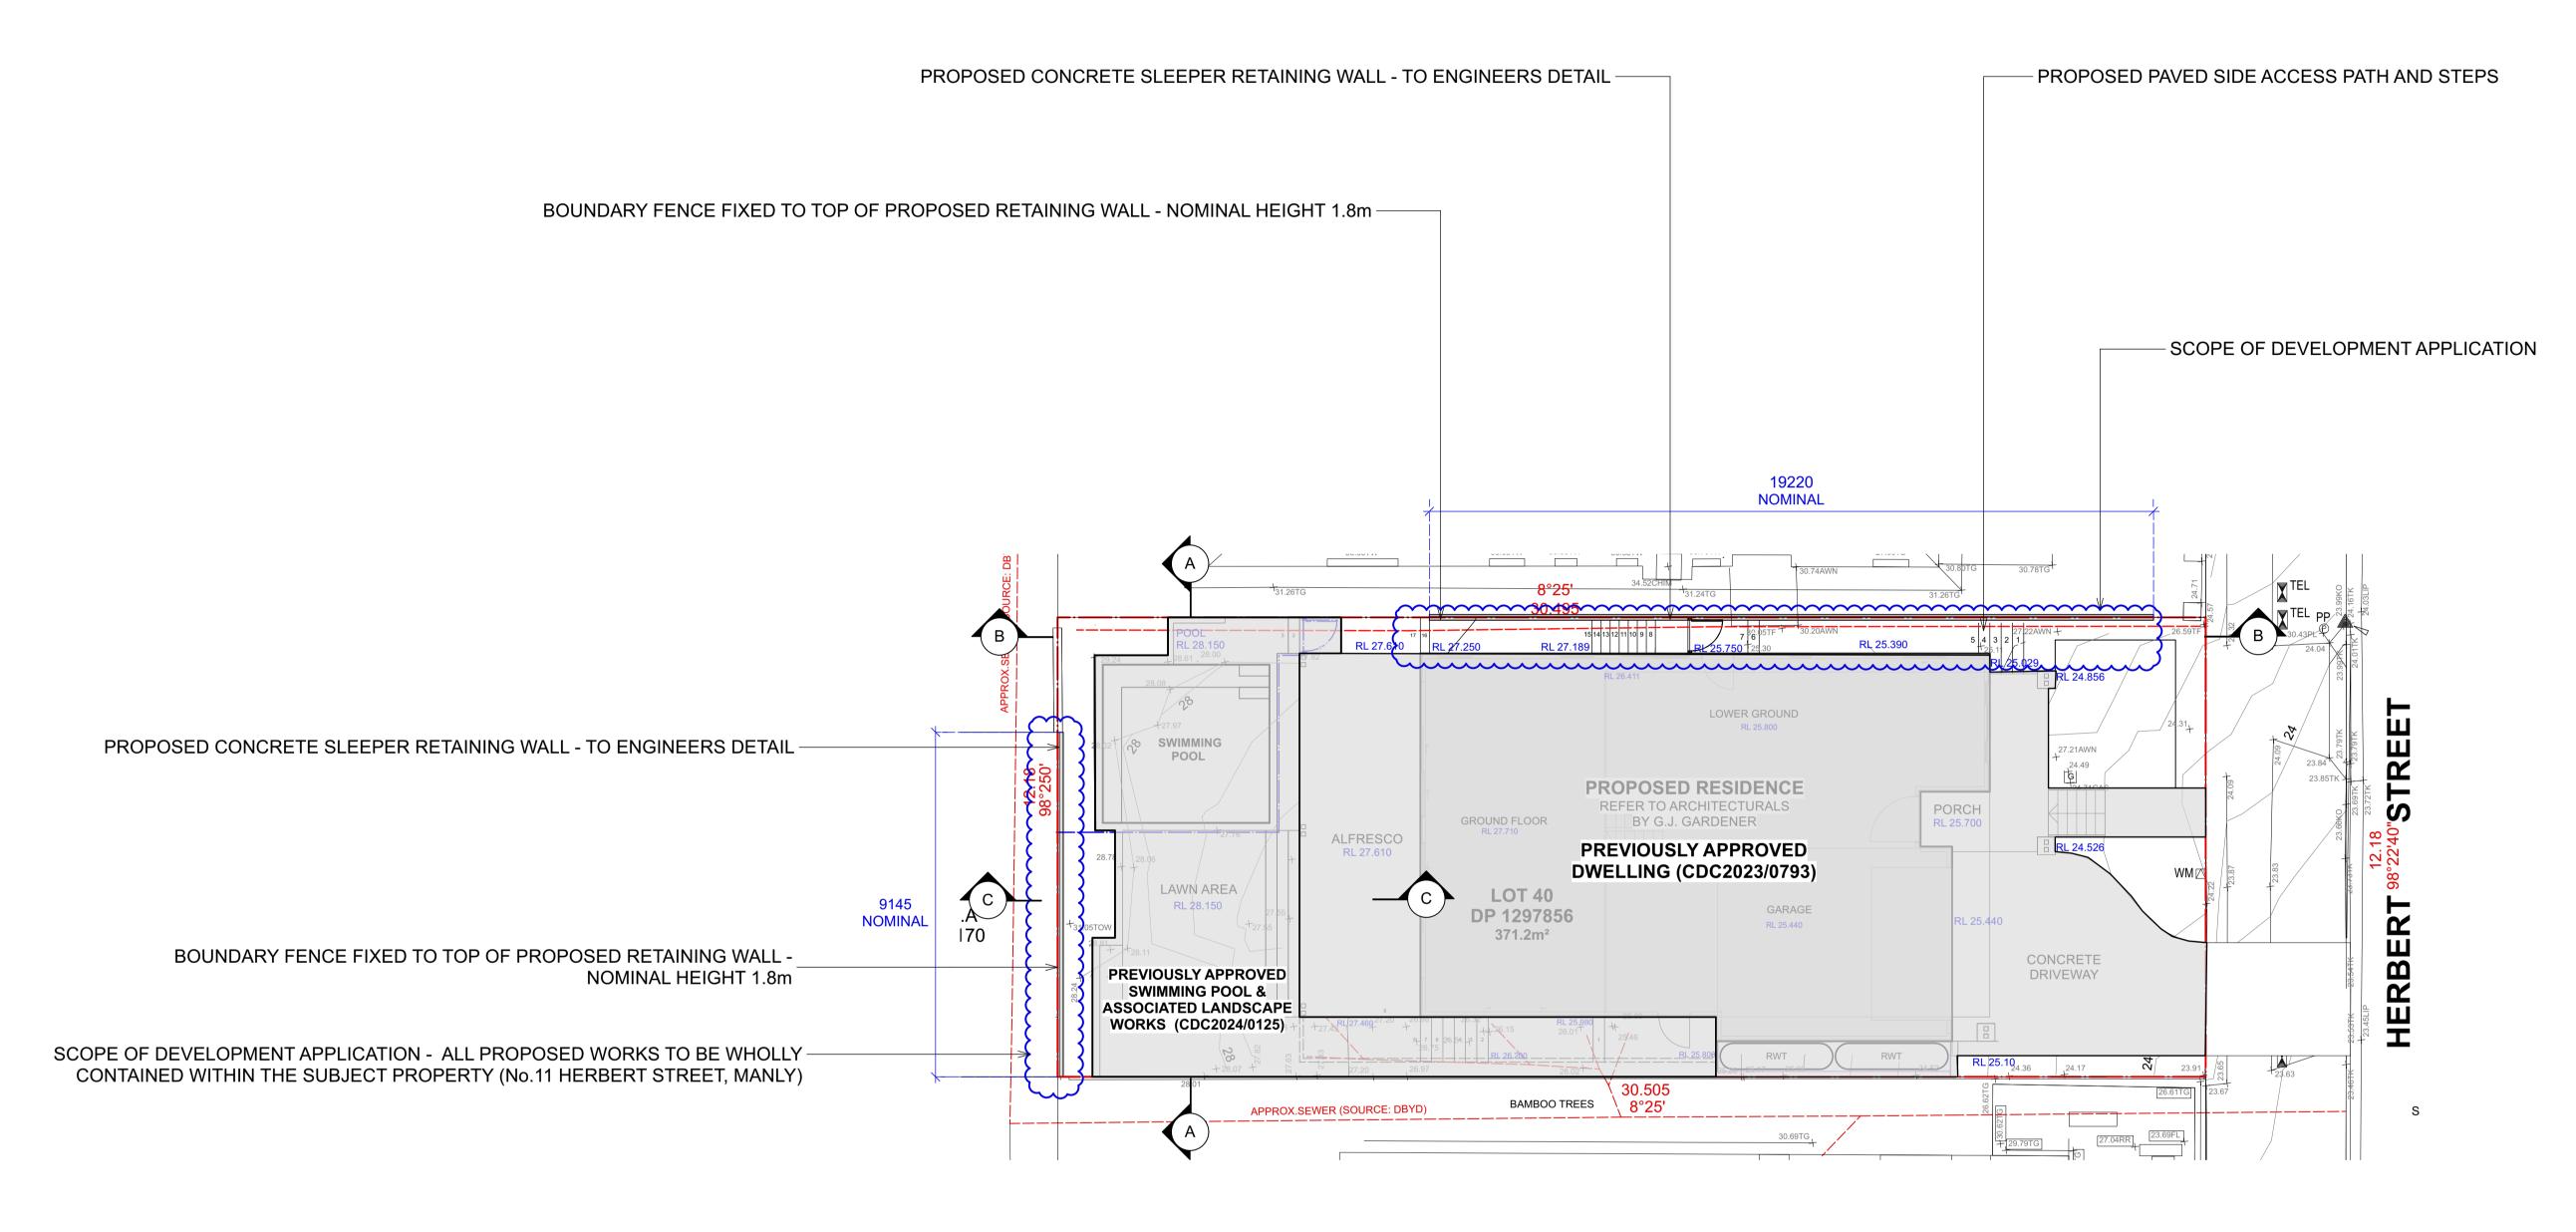



## NOTE

TOP OF WALLS SHOW FOR PROPOSED RETAINING WORKS ARE INDICATIVE ONLY AND MUST BE CONFIRMED ONSITE BY BUILDER



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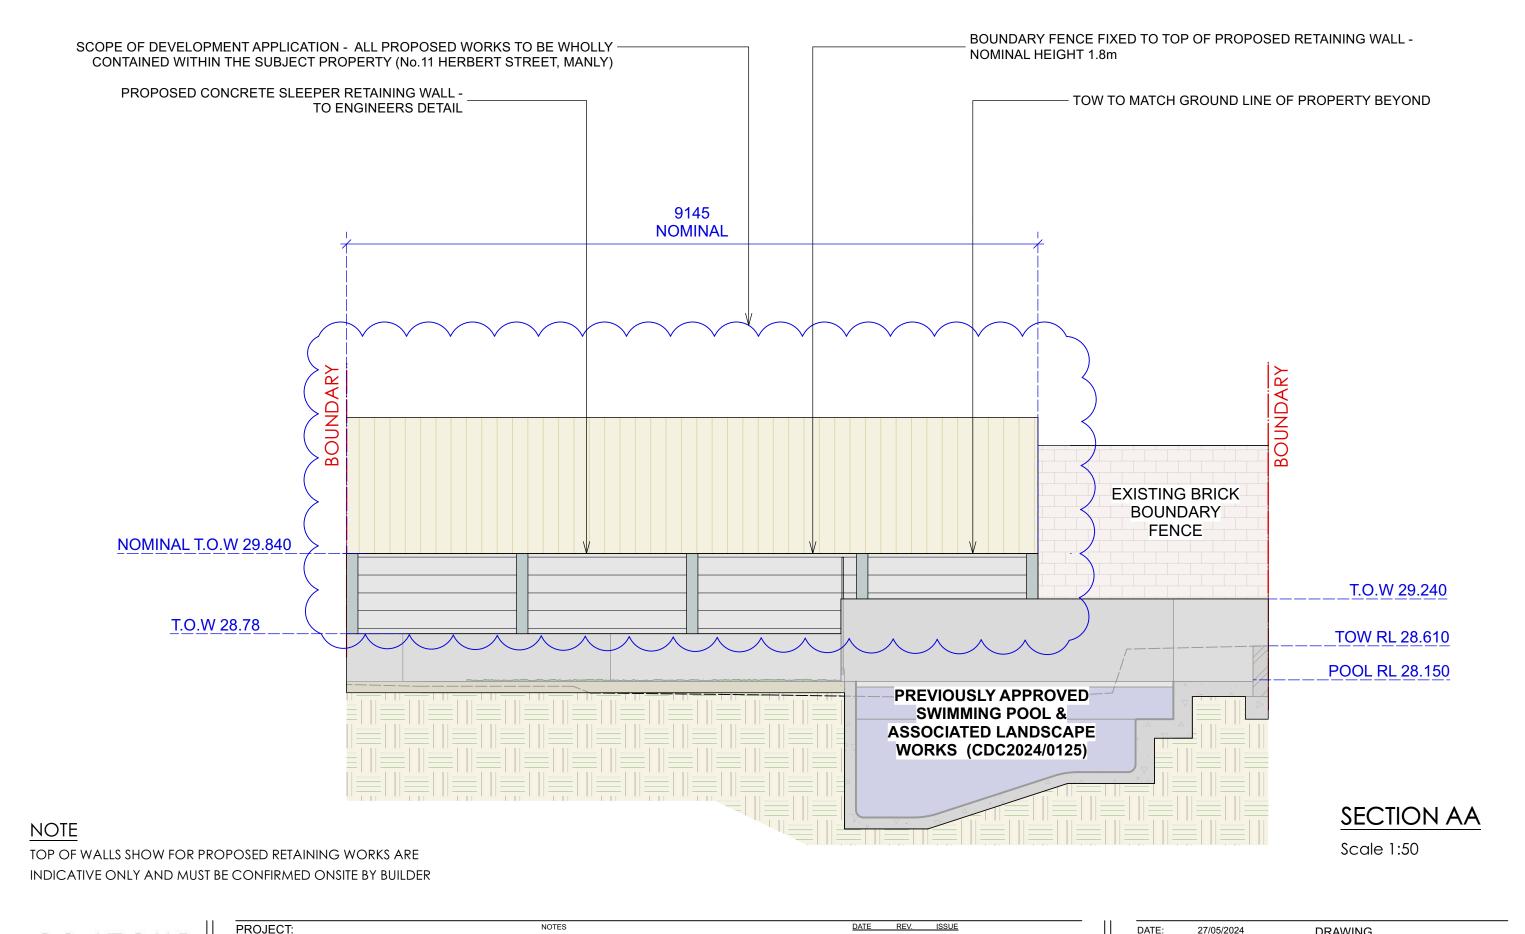
Anthony Dawson & Jane Hutchinson

11 HERBERT STREET MANLY, NSW 2095

NOTES

comply with building code of Australia and all relevant Australian standards
all works shall be in accordance with development application and construction certificate conditions of consent
all levels to ahd
refer to survey information relating to existing site data
verify all dimensions prior to works
do not scale from drawings
use figured dimensions in preference to scaling
refer all discrepancies to landscape architect for determination
this drawing is copyright and must not be retained, copied, used or reproduced in any way without prior written permission of
contour landscape architects.

DATE:	27/05/2024	DRAWING <b>SITE PLAN</b>	
SCALE:	1:100@A1 1:200@A3	DRAWING NO: C1	
DRAWN:	CC	REV: A	



CONTOUR LANDSCAPE ARCHITECTURE

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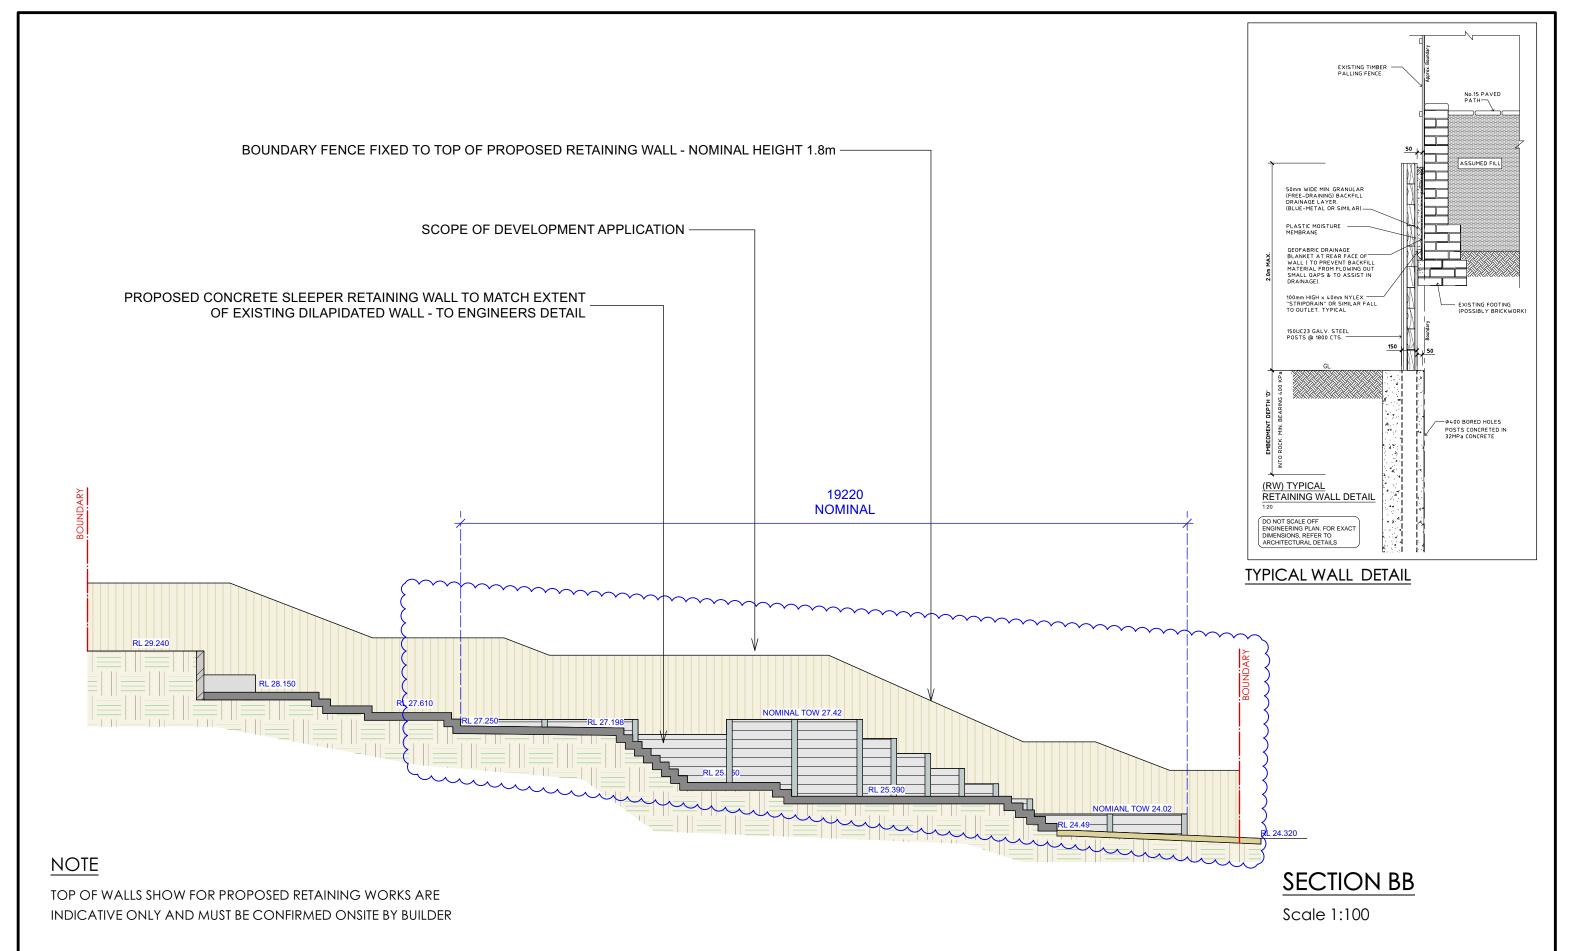
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REV. ISSUE

DATE:	27/05/2024	DRAWING SECTION AA
SCALE:	1:50@A3	DRAWING NO: C2
DRAWN:	CC	REV: A



CONTOUR

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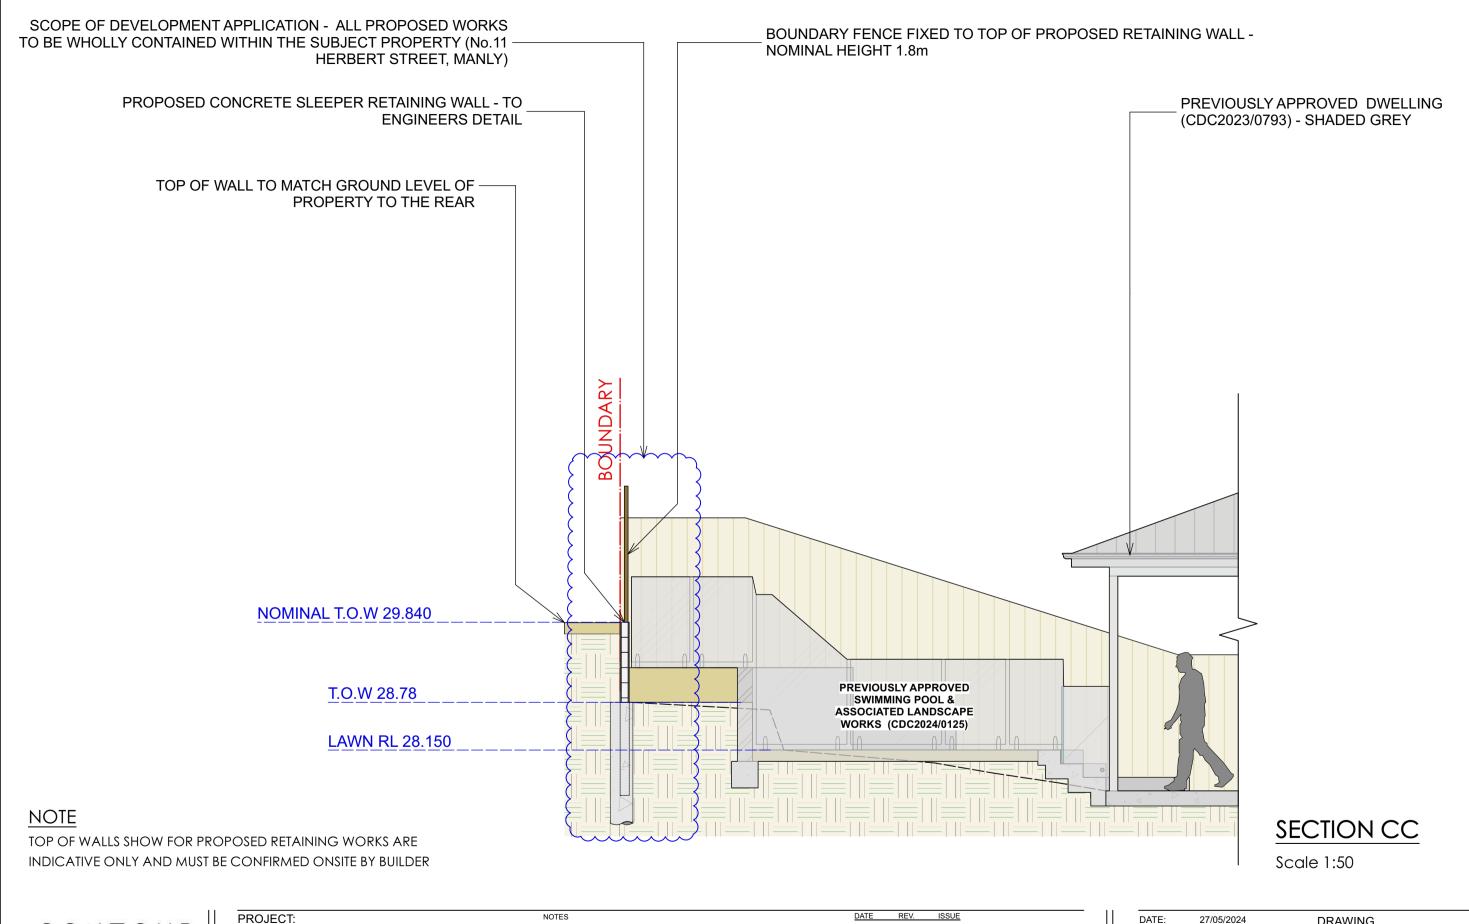
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DATE:	27/05/2024	DRAWING SECTION BB
SCALE:	1:100@A3	DRAWING NO: C3
DRAWN:	СС	REV: A



CONTOUR

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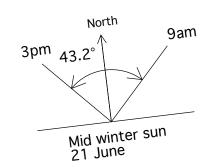
Anthony Dawson & Jane Hutchinson


11 HERBERT STREET MANLY, NSW 2095


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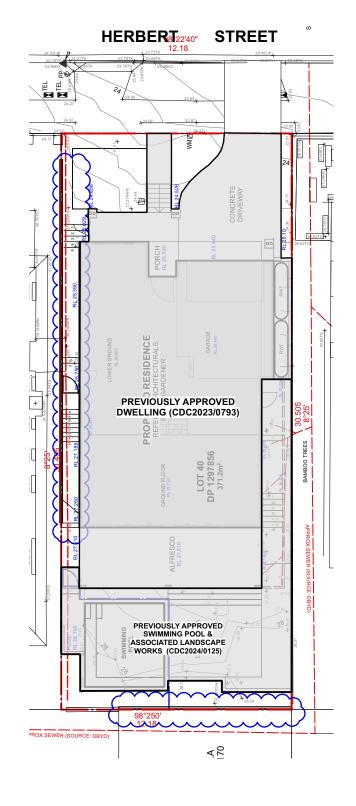
comply with building code of Australia and all relevant Australian standards all works shall be in accordance with development application and construction certificate conditions of consent all levels to ahd refer to survey information relating to existing site data verify all dimensions prior to works do not scale from drawings use figured dimensions in preference to scaling refer all discrepancies to landscape architect for determination this drawing is copyright and must not be retained, copied, used or reproduced in any way without prior written permission of conduct landscape architect.


DATE:	27/05/2024	DRAWING SECTION CC
SCALE:	1:50@A3	DRAWING NO: C4
DRAWN:	СС	REV: A







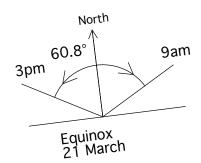


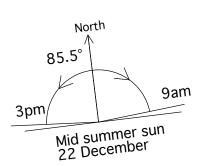

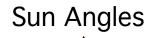

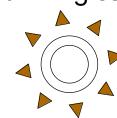

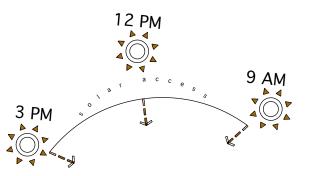

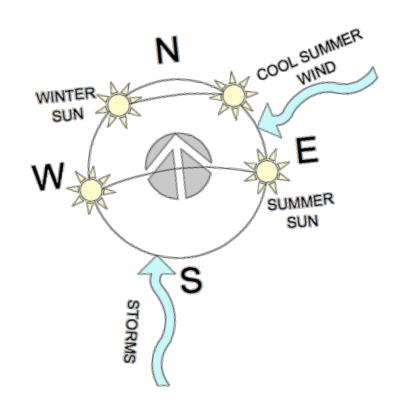

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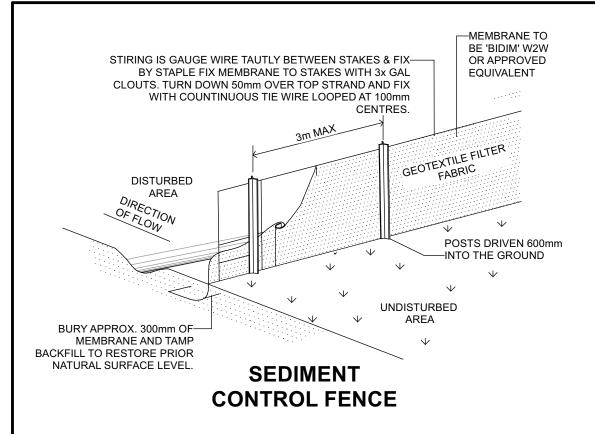
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DATE:	27/05/2024	DRAWING SITE ANALYSIS	Ŋ
SCALE:	1:100@A1 1:200@A3	DRAWING NO: C4	
DRAWN:	CC	REV: A	



## SEDIMENT CONTROL DETAILS

Scale 1:50

1. ALL WORK SHALL BE GENERALLY CARRIED OUT IN ACCORDANCE WITH: A. LOCAL AUTHORITY REQUIREMENTS

B. EPA REQUIREMENTS

C. NSW DEPERTMENT OF HOUSING MANUAL

 2. MAINTAIN THE EROSION CONTROL DEVICES TO THE
 SATISFACTION OF THE SUPERINTENDENT AND THE LOCAL AUTHORITY.
 3. WHEN STORMWATER PITS ARE CONSTRUCTED, PREVENT SITE RUNOFF ENTERING UNLESS SILT FENCES ARE ERECTED AROUND PITS.
 4. CONTRACTOR IS TO ENSURE ALL EROSION & SEDIMENTATION CONTROL DEVICES ARE MAINTAINED IN GOOD WORKING ORDER AND OPERATE EFFECTIVELY. REPAIRS AND/OR MAINTENANCE SHALL BE UNDERTAKEN


AS REQUIRED, PARTICULARLY FOLLOWING STORM EVENTS.

5. CLEAN BEHIND FENCE EACH MAJOR STORM OR OTHERWISE AS DIRECTED AND REMOVE ALL SILT FROM THE SITE.

2. SILT FENCE IS TO BE INSTSALLED & APPROVED BY COUNCIL'S SUPERVSING ENGINEERS BEFORE OVERBURDEN IS REMOVED. THIS FENCE MAY REQUIRE REPLACEMENT AT TIMES IF LOCATED WITHIN OR NEARBY CONSTUCTION ZONES.

**CONTROL FENCE** 

6. 'BIDIM' W2W IS SUPPLIED BY GEOFABRICS AUST. P/L

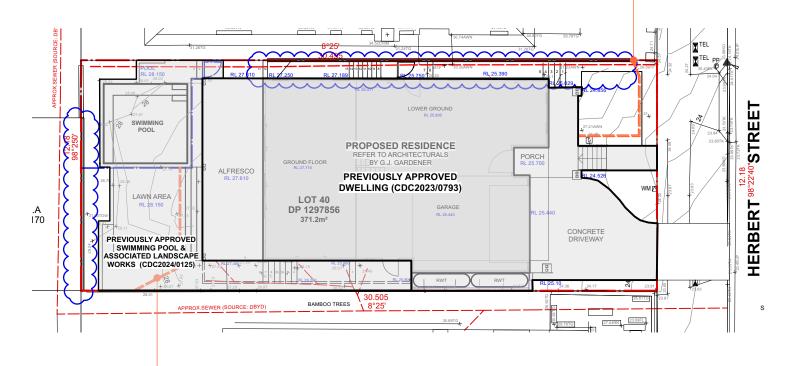

CONTOUR LANDSCAPE ARCHITECTURE

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PROJECT:

**Anthony Dawson &** Jane Hutchinson

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APPROXIMATE LOCATION OF SEDIMENT

**CONTROL FENCE** 

NOTES comby with building code of Australia and all relevant Australian standars all works shall be in accordance with development application and construence of the construction of the constr

ISSUE DATE REV.

DATE:	27/05/2024	DRAWING SEDIMENT CONTROL
SCALE:	1:100@A1 1:200@A3	PLAN DRAWING NO: C5
DRAWN:	CC	REV: A

SEDIMENT CONTROL PLAN

Scale 1:200

APPROXIMATE LOCATION OF SEDIMENT