

Anthony Protas Consulting Pty Ltd

BUILDING REGULATIONS CONSULTANTS

17 January, 2005

Our Ref: 051706

The General Manager Pittwater Council PO Box 882 Monal Vale NSW 1660

Dear Sir,

Re: 1193 Barrenjoey Road, Palm Beach

Construction Certificate

Pursuant to the requirements of the Environmental Planning and Assessment Act please find attached a copy of our Construction Certificate, plans and specifications to which the Construction Certificate has been issued and other relevant documents.

Should you have any questions, please do not hesitate to contact the undersigned.

R/160344

Yours faithfully

Anthony Protas

Anthony Protas Consulting Pty Ltd

for \$350,00



Construction Certificate - 1193 Barrengoey Road, Palm Beach

"Proposed alterations and additions to the existing cottage for café/kiosk"

1.	Det	ails of	f the ap	plicant				
	Mr [⊠ Ms	☐ Mrs	□ Dr □] Other			
	First	name			Family na	ame	-	
	Ste	fan			Leibei	natus		
	Flat/s	street no),	Street nam	ie			
	5			Queen	s Avenue)		
	Subu	irb or tov	v n				State	Postcode
	Ava	alon E	Beach				NSW	2107
	Dayti	ime telep	ohone		Fax		Mobile	
	991	18 43	40				0408 690	987
	Emai	il						
	sc	leibe	natus@	Diprimus	s.com.au		7	
						<u> </u>	_1	
2.	Det	ails of	f the de	velopme	nt conser	nt		
			application	n no.		Date the c	onsent was issued	1
	330	0/03		•		7 Dece	ember, 2004	
3.	Dec	ision	of the	certifying	authority	,		
			e is issue					
				conditions				
					the kind reference the transfer that the transfer the transfer that the transfer transfer the transfer the transfer transfer the transfer transfer the transfer transfer transfer the transfer transfer transfer the transfer		es 187 or 188 of t	he Environmental
		(Conditions	have been p	placed on the	certificate for	the following reason	ons:
	\boxtimes	the iss	ue of this e applicat	certificate ha	as been endo	rsed on the pla	ans and specificati	ons that were lodged
		Plan n	o.s appro	ved				
		A17	01, da	ited Jur	ne '04, p		by M+BA A	01 to A1302 & Architects P/L.
	Date	of this d			,			
			arv. 20	05	ן			

4.	information at	tached to th	is decisio	on			
	A fire safety	schedule					
	Schedule of	fapproved plans	& specification	ens			
5.	Certification						
	Anthony Prof	las		-		certifies the	at
	if the work is comple with the requiremen section 81A(5) of the	ts of the Environn	nental Planni	ng and Ass	essment	Regulation	approved, it will comply a 2000 as referred to it
	Construction certific	ate no.		Date of th	nis certifi	cate	
	1706/05			17 Jai	nuary	, 2005	
	Name		,				
	Anthony Prot	as					
	Flat/Street no.	Street name					
	Level 3, 84	Pitt Street	•				
	Suburb or town			-	State		Postcode
	Sydney				NS	W	2000
	Telephone			,	Fax		
	9223 7158				922	3 9492	
	If the certifier is an a	accredited certifie	r:				
	Accreditation boo	dy of the certifier		 -			of the certifier
	DIPNR				244	2	

7. Applicant's right of appeal

If the certifying authority is a council, a Minister or a public authority and the certifying authority has issued a construction certificate subject to conditions, you can appeal against these conditions to the Land and Environment Court within 12 months from the date of the decision.

ATTACHMENT

SCHEDULE OF FIRE SAFETY MEASURES REQUIRED TO BE IMPLEMENTED IN THE BUILDING PREMISES

Upon completion of erection of the building, and prior to occupation, the owner of the building shall cause the Principle Certifying Authority to be given a fire safety certificate in relation to each essential and other fire safety measure included in the following schedule. Such Certificate shall state, in relation to each essential and other fire safety measure implemented in the building or on the land which the building is situated:

- a) that the measure has been assessed by a person (chosen by the owner of the building) who is properly qualified to do so; and
- b) that, as of the date of the assessment, the measure was found to be capable of performing to a standard of not less than that nominated below.

Fire Safety Measures Required to Be implemented in the Building

Fire Safety Measure	Standard of Performance
portable fire extinguishers	BCA clause E1.6 AS 2444



Application for construction certificate

1.	Details of the application	cant	
	Mr 🗹 Ms 🗌 Mrs 🗌	Dr Other	
	First name	Family name	
	Stran	Libenatus	
	NI NI	Street name	
		Queens Avenue	
	Suburb or town	State	Postcode
	Avalon Beach	NSW	2107
	Daytime telephone	Fax Mobile	
	99184340	n/a 0408 (F8P 0P3
	Email		
	SC- Leibenatus	@ i primus opman	
2.	Identify the land		
	Flat/street no. S	Street name	
	1[93	Barren scey Road *	
	Suburb or town		Postcode
	Palm Beach	NSW	2108
	Lot no. S	ection	
	200F	Governor Phillip Park	
	DP/MPS no.	Volume/folio	
	752046		
	You can find the lot no., sec documents for the land. If yo details.	ction, DP/MPS no. and volume/folio details on a map of the lou need additional room, please attach a schedule and/or a	and or on the title map with these
3.	Estimated cost of th	ne development	•
	6 010 000		

		•
4.	Describ	pe the development
	What type	of work do you propose to carry out?
	8	uilding work
	Subd	livision work
	Describe t	
	HUTER	ations and additions to change the use of cottage
	to a	ations and additions to change the use of cottage kiosk/cafe and restaurant
	For buildin	g work, what is the class of the building under the Building Code of Australia?
	This can b	
		e found on the development consent
		opment consent been granted for the development?
	No	
	Yes	What is the development application no.?
		NO 330/03
		What date was development consent granted?
		T 1) JUMA
		1 - 10 - 00001
5.	Informa	tion to be attached to the application
	Please ind	to provide material with your application that is relevant to the type of work you propose to do. icate the material you have attached by placing a cross in the appropriate
	boxes ∐:	
	1. if yo	ou are going to carry out building work:
		a copy of any compliance certificates on which you rely
	<u> </u>	detailed plans of the building (4 copies) The plans must be drawn to a suitable scale and consist of a general plan and a block plan.
		The general plan of the building is to:
		show a plan of each floor section
		show each elevation of the building
		 show the level of the lowest floor, the level of any yard or unbuilt area on that floor and the level of the ground
		 indicate the fire safety and fire resistance measures (if any), and their height, design and construction
		Where you propose to alter, add to or rebuild a building that is already on the land, or modify plans that have already been approved, please mark the general plan (by colour or otherwise) to show the change you propose to make.
	9	detailed specifications of the building (4 copies)
		The specifications are to:
		 describe the construction (including the standards that will be met), the materials which will be used to construct the building and the methods of drainage, sewerage and water supply
		 state whether the materials proposed to be used are new or second hand and give details of any second-hand materials to be used.
	,	Where you propose to modify specifications that have already been approved, please mark the approved specifications (by colour or otherwise) to show the modification.
	•	a plan of the existing building, drawn to scale, where the application involves building work to alter, enlarge or extend that building
		This plan will assist the certifying authority to assess whether the work will reduce the fire protection capacity of the building.

A 40 MA 4 AN 201 MA 1 4 1

•

5.	cont	inue	ed :
		(d)	 where you propose to meet the performance requirements of the Building Code of Australia (BCA) by using an alternative solution to the deemed-to-satisfy provisions of the BCA: a list of the performance requirements you will meet by using the alternative solution the details of the assessment methods you will use to meet those performance requirements a copy of any compliance pertitioners on which you rely evidence of any accredited component, process or design on which you seek to rely Components, processes of designs that relate to the erection or demolition of a building are accredited under the Environmental Planning and Assessment Regulation 2000. details of the fire safety measures, unless you are building a single dwelling or a non-habitable building or structure (such as a private garage, carport, shed, fence, antenna, wall or swimming pool). These details are to include: a list of any fire safety measures you propose to include in the building or on the land if you propose to alter, add to or repuild a building that is already on the land, a list of the fire safety measures that are currently used in the building or on the land The lists must describe the extent, capability and the basis of design of each measure.
		You indu	the attached schedule, completed for the development The information in the schedule will be used by the Australian Bureau of Statistics to report each quarter on the building activity that occurs in the economy. Building statistics allow governments and businesses to accurately identify main areas of population growth and demand for products and services. may also need to pay a long service levy under section 34 of the Building and Construction estry Long Service Payments Act 1986 (or where such a levy is payable by instalments, the
	2.	first	instalment of the levy) before the certifying authority can issue a certificate to you, u are going to carry out work to do a subdivision (eg building roads or a stormwater
			nage system): the details of the existing and proposed subdivision pattern (including the number of lots and the location of roads) the details of the consultation you have carried out with the public authorities who provide or
			will increase the services you will need (like water, road, electricity, sewerage) the existing ground levels and the proposed ground levels when the subdivision is completed copies of any compliance certificates on which you rely detailed engineering plans (4 copies). The detailed plans might include the following:
		u	earthworks roadworks road pavement road furnishings stormwater drainage water supply works sewerage works landscaping works

erosion control works
 Where you propose to modify plans that have already been approved, please mark the approved plans (by colour or otherwise) to show the modification.

5.	cont	inue	ed	Spring.	100		
	3.	Build a sin	line Codo of Auctralia and	i you are do itable buildi	ina h	ng or the classification of a building under the uilding work (unless the building will now be used as structure (such as a private garage, carport, shed,	
			a list of any fire safety m	easures you	prop	ose to include in the building or on the land	
			if you propose to alter, a safety measures that are	dd to or reb currently u	uild a sed ir	building that is already on the land, a list of the fire the building or on the land	
			Building Code of Austra	ia: IIIIIII		with the Category One fire safety provisions of the	
			lists of fire safety measu n measure.	res must de	scribe	the extent, capability and the basis of design of	
6.	Sign						
	The o	wner	(s) of the land must sign	n this applic	ent an	n ir: oplication, the owner did not give consent to the	
	а	polica	ent to lodge a constructio	n certificate,	or :		
	• tì	ie ow	mer of the land has chan	ged since th	e owr	ner signed the development application.	•
	As the	own	er(s) of the above proper	ty, I/we cons	sent t	o this application: Letter of consent	a 1
	Signa	ture				Signature - Letter of management for cotto	J. Jan
						Sch	twith
	L				!	Drenard, all see "Genmay's acc"	Hwalk
	Name				1	Name brokerty of the George Asares?	-ounid
	Date		 			Date	
	L						
	The a	pplic	ant, or the applicant's a	igent, must	sign	the application.	
	Signa	ture			• :		
	4	V	Alle			in what capacity are you signing if you are not	
	Name	e. if v	ou are not the applicant		 .	the applicant?	
		II.	n Lèibenatus				
	Date	<u>'</u>					<i>e</i>
	16	1.	2.04				
7.			policy				
	auth	ontu	If the information is not D	rovided, vou	r appi	nable your application to be assessed by the certifying literation may not be accepted. Please contact the application is incorrect or changes.	٠
						:	
					•		•
				•		1	•
				明 网络	ne.		
				ا مالا - في ماسم أدر وال	السيسي		ļ
				্তু চ ক্রামির ১	77 54		; ;
				+ 1			}

Har

Schedule 1	o ap	blic	ation for a	const	ruc	tion ceri	tificate			
Please comple	te this :	sche	dule. The Inform	lation W	libe	sent to the	Australiar	Bureau of St	atistics.	!
All new build	lings									
Please comple	te the f	ollow	ing:		1					
Numbe	r of sta	revs	including unde	mmund.	l floor	re)	f	laloor		
· · · · · · · · · · · · · · · · · · ·	. 0, 5,0	,0,0		igiouna		ع)		<u> </u>	2	
 Gross f 	loor are	ea of	new building (n	nili		•	_ ~	285 r	n ²	000
• Gross s	ite are	a (m²	, !!!	11 1 13				1187 m	2	
0.000	,,,,, d,, d	 ('				<u> </u>			
D. . 	** **									
Residential b		_								
Please complet	e the f	ollow	ing details on re	sidentia	Istr	uctures:				
Number	r of dw	elling	s to be construc	ted]
Number	r of ore	_avie	ting dwellings o							
- 114111001	. O. p.O	VAG								
Number	r of dw	elling	s to be demòlis	hed		1 :				
 Will the building 	new d	wellin	g(s) be attache	d to oth	er ne	w	Yes			
• Will the	new h	uildin	g(s) be attached	d to evic	lina	huildinas?	Yes			
			i i i i i i i i i i i i i i i i i i i	1 1		onwantige s	103	_ 140 C		
 Does the (NB dual) 	e site d al occuj	conta pancy	in a dual occup y = two dwelling	ancy? s.on the	sen	ne site)	Yes	□ No ☑		
Materials – re			- P. C. L. (· · · · · · · · · · · · · · · · · · ·				÷
			is to be used in	the con	struc	tion of the r	new buildi:	ng(s):		
Walls	,	Code	Roof	C	ode	Floor	Cod	e Frame	C	ode
Brick (double)	V	11	Tiles		10	Concrete or slate	<u> </u>	0 Timber		40
Brick (veneer)		12	Concrete or slate		20	Timber	[] 4	0 Steel		60
Concrete or stone		20	Fibre cement		30	Other	8	3 Aluminium		70
Fibre cement		30	Steel	; \(\sqrt{\sqrt{2}}\'	60	Not specified	9	Other		80
Timber		40	Aluminium		70			Not specified		90
Curtain glass		50	Other		80					
Steel		60	Not specified		90					
Aluminium		70								
Other		80								
Not specified		90								
			• 1	,	1	1)			

there will be mainly construction of masonary walls.



Our ref: 04-47

6 August 2004

C + S Lebenatus 5 Queens Avenue Avalon NSW 2107

Attn: Stefan Lebenatus

Dear Stefan,

RE: PROPOSED ALTERATIONS AND ADDITIONS 'THE COTTAGE' GOVERNOR PHILLIP PARK, PLAM BEACH STORMWATER DRAINAGE CERTIFICATE

We certify that the design shown on drawing no. 04-47/C1 complies with:

- 1. Section 3.1.2 'Drainage' of the Building Code of Australia Housing Provision.
- 2. AS3500.3.2 and Australian Rainfall and Runoff, 1987.
- Accepted Engineering Practice and Principles. 3.

No standards or practices other than the relevant Australian Standards have been relied upon for this certification.

Yours faithfully,

WOOLACOTTS

Stephen Branch

BE(Hons) MEngSc FIEAust CPEng

NPER Structural and Civil - Membership No. 312987

Directors

Pittwater Council

OFFICIAL RECEIPT

27/04/2004 Receipt No 140292

TO STEFAN LEIBENATUS

5 QUEENS AVE

Appl	ic Refere	nce	Amount
,GL I	Re OLSL-E	uil 93 BARRENJOE	\$270.00 Y RD NO
	Total:		\$270.00
	Amou	nts Tendered	i '
	Car	s h	\$0.00
	Cheq	ие	\$270.00
	Ca	rd	\$0.00
	Money Ord	er	50.00
	Agency R	ec .	\$0.00
	Tot		\$270.00
	Roundi	ក់ឡ	\$0.00
	Chan		\$0,00
	Ne	tt:	\$270.00

Printed 27/04/2004 5:06:42 Cashier KRubin

DRAWING	DRAWING	
NUMBER	NAME	SCALE
A1000	COVER SHEET	NTS
A1201	DEMOLITION PLAN	1:50
A1202	SURVEY (EXISTING)	1:100
A1203	PLAN (PROPOSED)	1:50
A1204	REFLECTED CEILING PLAN	1:50
A1205	ROOF PLAN	1:50
A1301	ELEVATIONS (N,S,E&W)	1:50
A1302	SECTIONS	1:50
A1701	WALL SECTIONS	1:20

1) ALL LIGHTS TO BE DIMMABLE EXCEPT LIGHTS TO KITCHEN, WASHING, LINK, CHAIR STORE AND TOILET AREAS AND EXTERNAL LIGHT FITTINGS

2) SUPPLY AND INSTALL AN INTRUDER SECURITY SYSTEM INTERNAL MOTION DETECTORS TO BE WIRED TO SECURITY ALARM SYSTEM AND WILL ACTIVATE AUDIBLE ALARM WHEN SYSTEM IS SWITCHED ON AND

3) AS PART OF THE WORKS THE CONTRACTOR IS TO SUPPLY AND INSTALL A DUCTED AIR CONDITIONING SYSTEM. THE AIR CONDITIONING SYSTEM TO BE DUCTED AIR SYSTEM WITH EXTERNAL COMPTRESSOR. SYSTEM TO BE SIZED FOR DESIGNED OCCUPANCY OF THE INTERNAL DINING AREAS (EXCLUDES TERRACE

P9 NEW MASONRY WALL PAINT FINISH TO SELECTED COLOUR P8 NEW MASONRY WALL CEMENT RENDERED AND PAINT FINISH TO SELECTED COLOUR

NEW MASONRY WALL OR INFIL FINISH SURFACE TO MATCH SURROUNDING WALL AND PAINT FINISH TO SELECTED COLOUR

P4 PROPRIETARY PARTITION SYSTEM

PST FULL HEIGHT TILED WALL ON EXISTING MASONRY SUBSTRATE

P5 EXISTING RENDERED MASONRY WALL MAKE GOOD SURFACE AND PAINT FINISH TO SELECTED COLOUR

P6 FIBRE CEMENT EXTERNAL CLADDING TO METAL STUD WALL FINISH TO SELECTED COLOUR P3 VILLABOARD TO METAL STUD WALL TAPE AND SET PAINT FINISH TO SELECTED COLOUR

P2A 13MM PLASTERBOARD TAPE AND SET TO NEW 92mm METAL STUD WALL PAINT FINISH TO SELECTED COLOUR

13MM PLASTERBOARD TAPE AND SET TO NEW 75mm METAL STUD WALL PAINT FINISH TO SELECTED COLOUR P3T FULL HEIGHT TILED WALL ON VILLABOARD - 75mm METAL STUD WALL

L1 LIGHT TYPE 1

L2 LIGHT TYPE 2

L3 LIGHT TYPE 3

DL1 DOWNLIGHT TYPE 1

WL1 WALL LIGHT TYPE 1

WALL WASHER TYPE 1

BL1 EXTERIOR BOLLARD LIGHT TYPE 1

SD SMOKE DETECTOR

TTD THERMAL DETECTOR

VB (PF2) VILLABOARD CEILING LINING (TAPE AND SET) - PAINT FINISH TYPE 2

PB (PF1) PLASTERBOARD CEILING LINING (TAPE AND SET) - PAINT FINISH TYPE 1

VB (PF1) VILLABOARD EAVES LINING (TAPE AND SET) - PAINT FINISH TYPE 1 TO EAVES

S CEILING MOUNTED SPEAKER - WIRE ALL SPEAKERS TO OFFICE AS DIRECTED

MD-L MOTION DETECTOR (EXTERNAL - ACTIVATES EXTERNAL LIGHTS)

MOTION DETECTOR INTERNAL(- ACTIVATES AUDIBLE ALARM - LINK TO SECURITY SYSTEM AS DIRECTED)

EXHAUST FAN TO DUCTED EXHAUST SYSTEM TO TOILETS

EXHAUST AIR GRILL ETO DUCTED EXHAUST SYSTEM TO TOILETS

AIR CONDITIONING SYSTEM RETURN AIR REGISTER

AIR CONDITIONING SYSTEM SUPPLY AIR REGISTER

SKL SKYLIGHT - DOUBLE GLAZED MANUAL OPENING ROOF WINDOW - VELUX MODEL VS0075 SIZE 780mm x 980mm

2400 DENOTES 2400mm CEILING HEIGHT

2780 DENOTES 2780mm CEILING HEIGHT

DENOTES WALL COLOUR C1 (REFER TO FINISHES SCHEDULE FOR DETAILS)

C2 DENOTES WALL COLOUR C2 (REFER TO FINISHES SCHEDULE FOR DETAILS)

DENOTES WALL SPECIAL COLOUR (REFER TO FINISHES SCHEDULE FOR DETAILS)

DENOTES ALL WALLS IN THIS ROOM TO BE COLOUR CI UNO (REFER TO FINISHES SCHEDULE FOR DETAILS)

DENOTES ALL WALLS IN THIS ROOM TO BE COLOUR C2 UNO (REFER TO FINISHES SCHEDULE FOR DETAILS)

DENOTES ALL WALLS IN THIS ROOM TO BE COLOUR C3 UNO (REFER TO FINISHES SCHEDULE FOR DETAILS)

DENOTES ALL WALLS IN THIS ROOM TO BE COLOUR C4 UNO (REFER TO FINISHES SCHEDULE FOR DETAILS)

DENOTES ALL WALLS IN THIS ROOM TO BE COLOUR C5 UNO (REFER TO FINISHES SCHEDULE FOR DETAILS)


DENOTES ALL WALLS IN THIS ROOM TO BE COLOUR C6 UNO (REFER TO FINISHES SCHEDULE FOR DETAILS)




CLIENT

A1000

REVISION

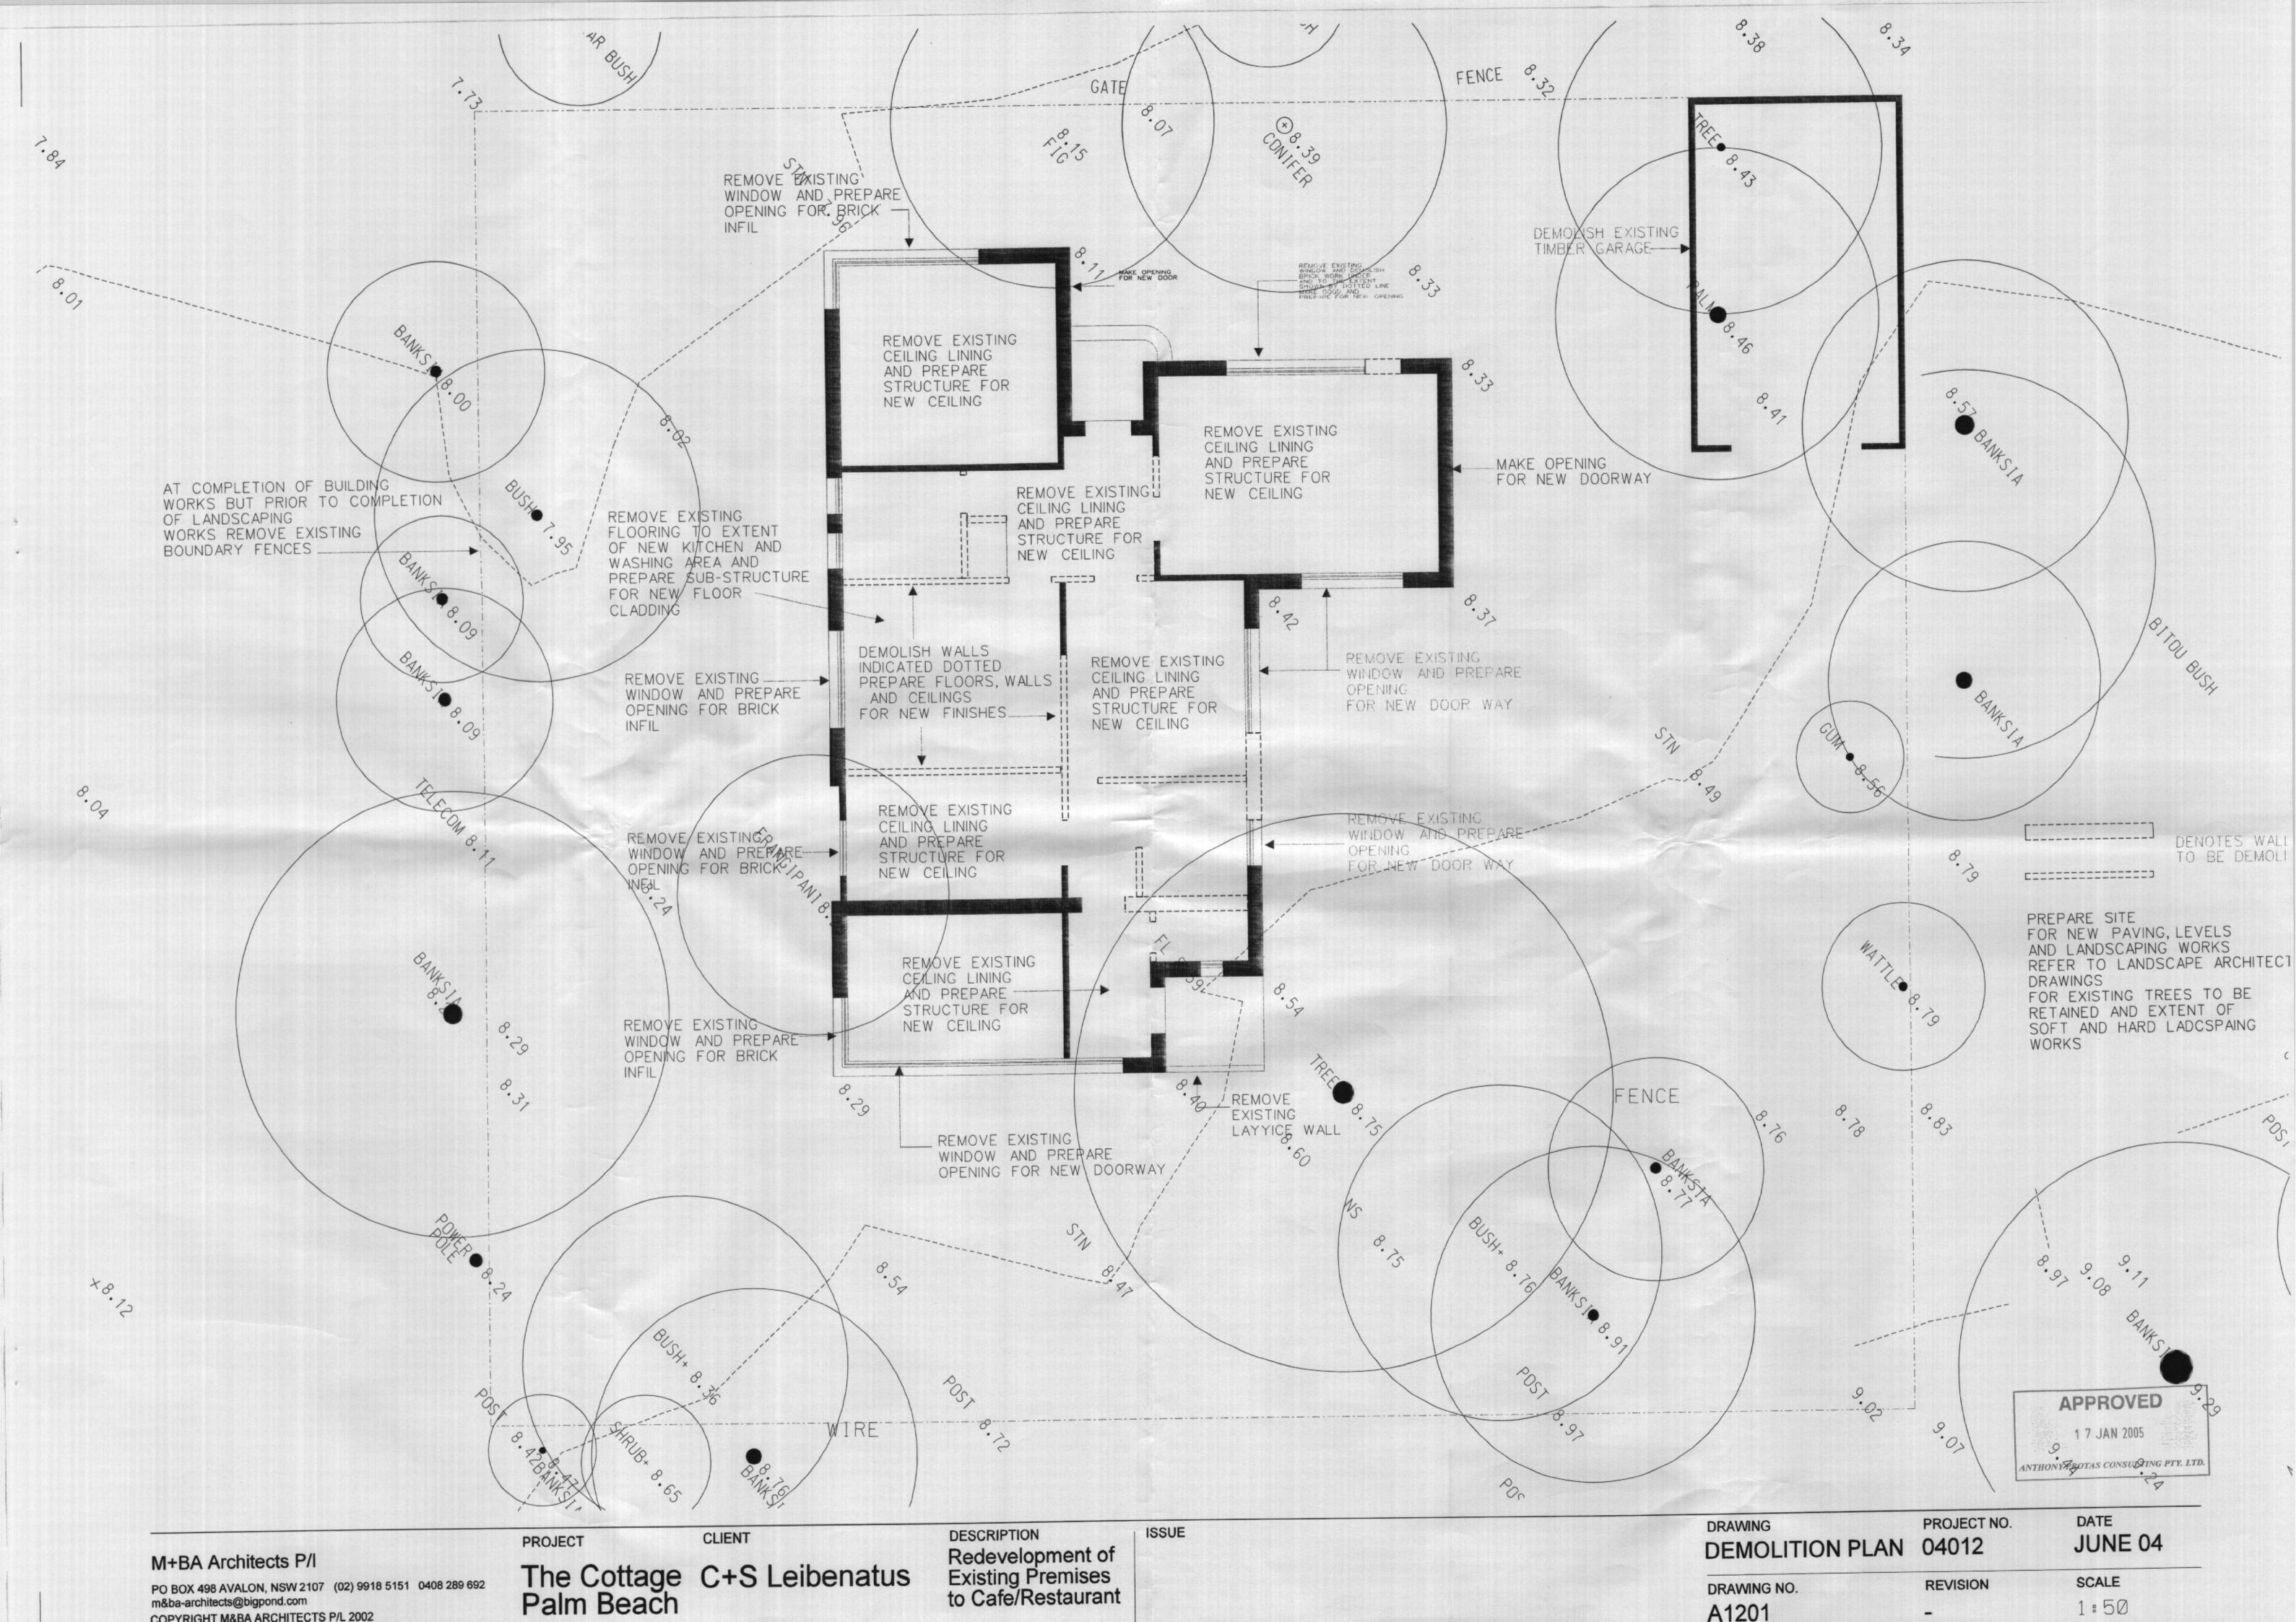


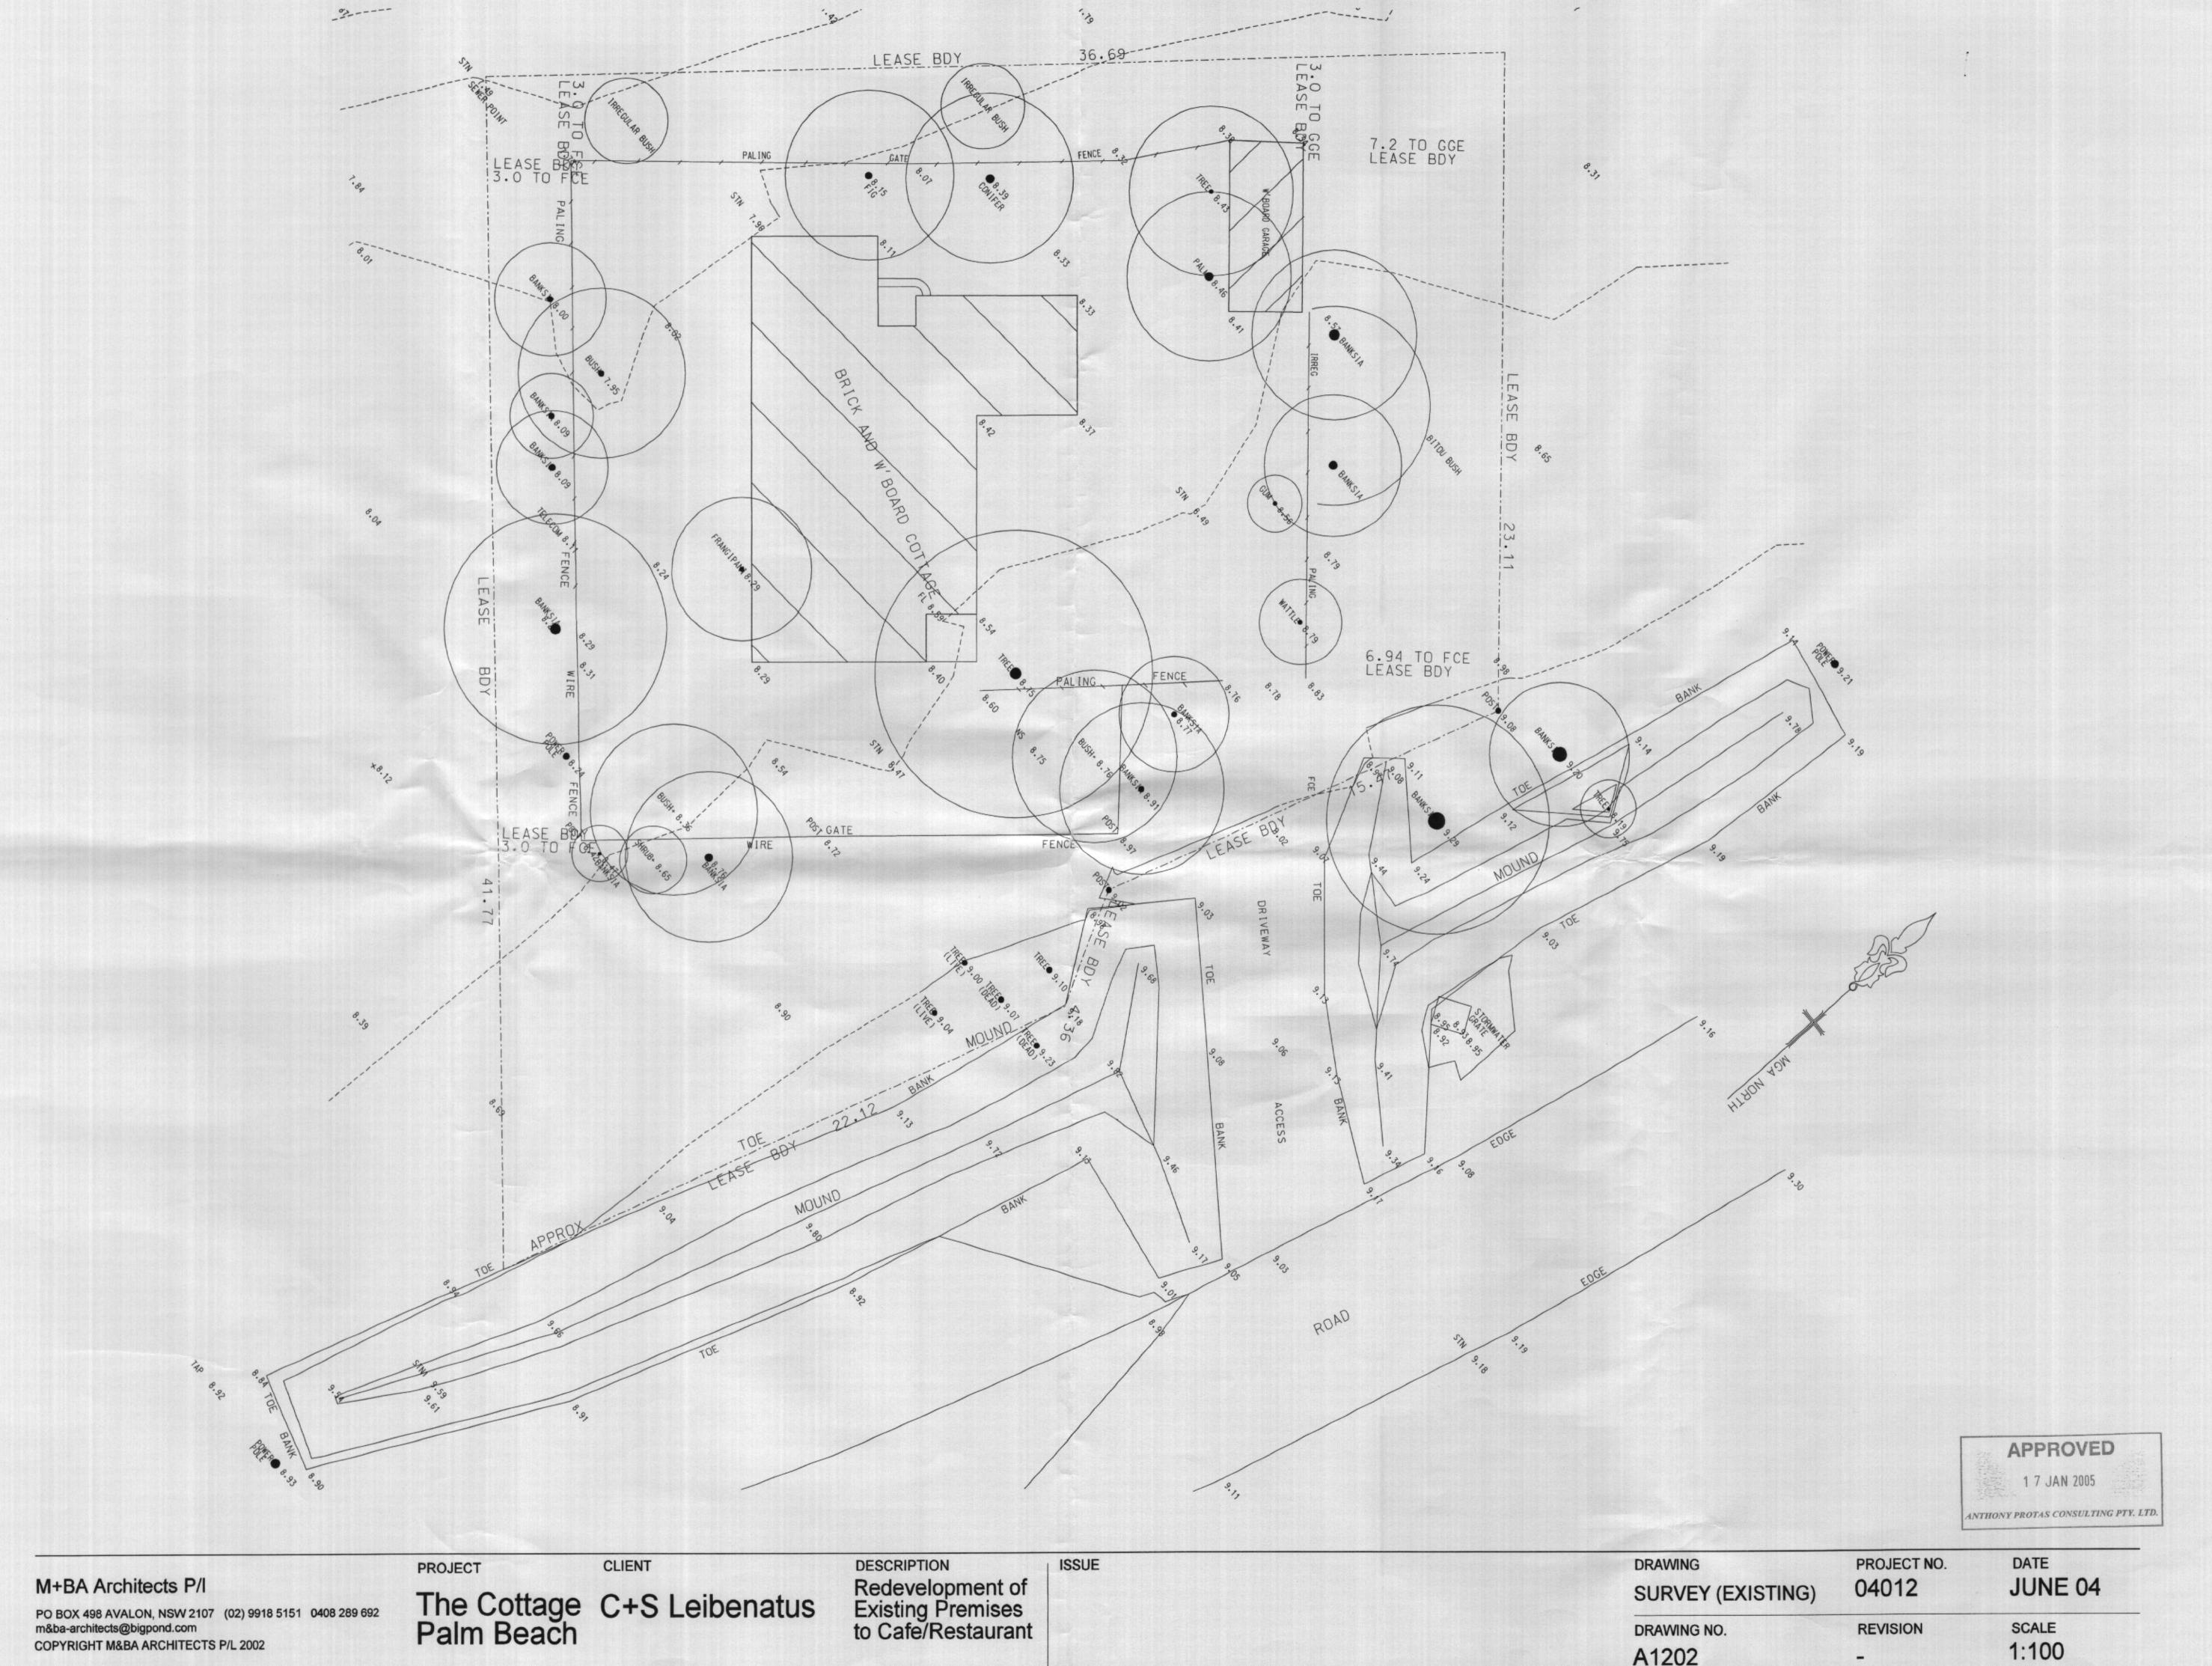


PO BOX 498 AVALON, NSW 2107 (02) 9918 5151 0408 289 692 m&ba-architects@bigpond.com
COPYRIGHT M&BA ARCHITECTS P/L 2002

DRAWING NO.

A1202

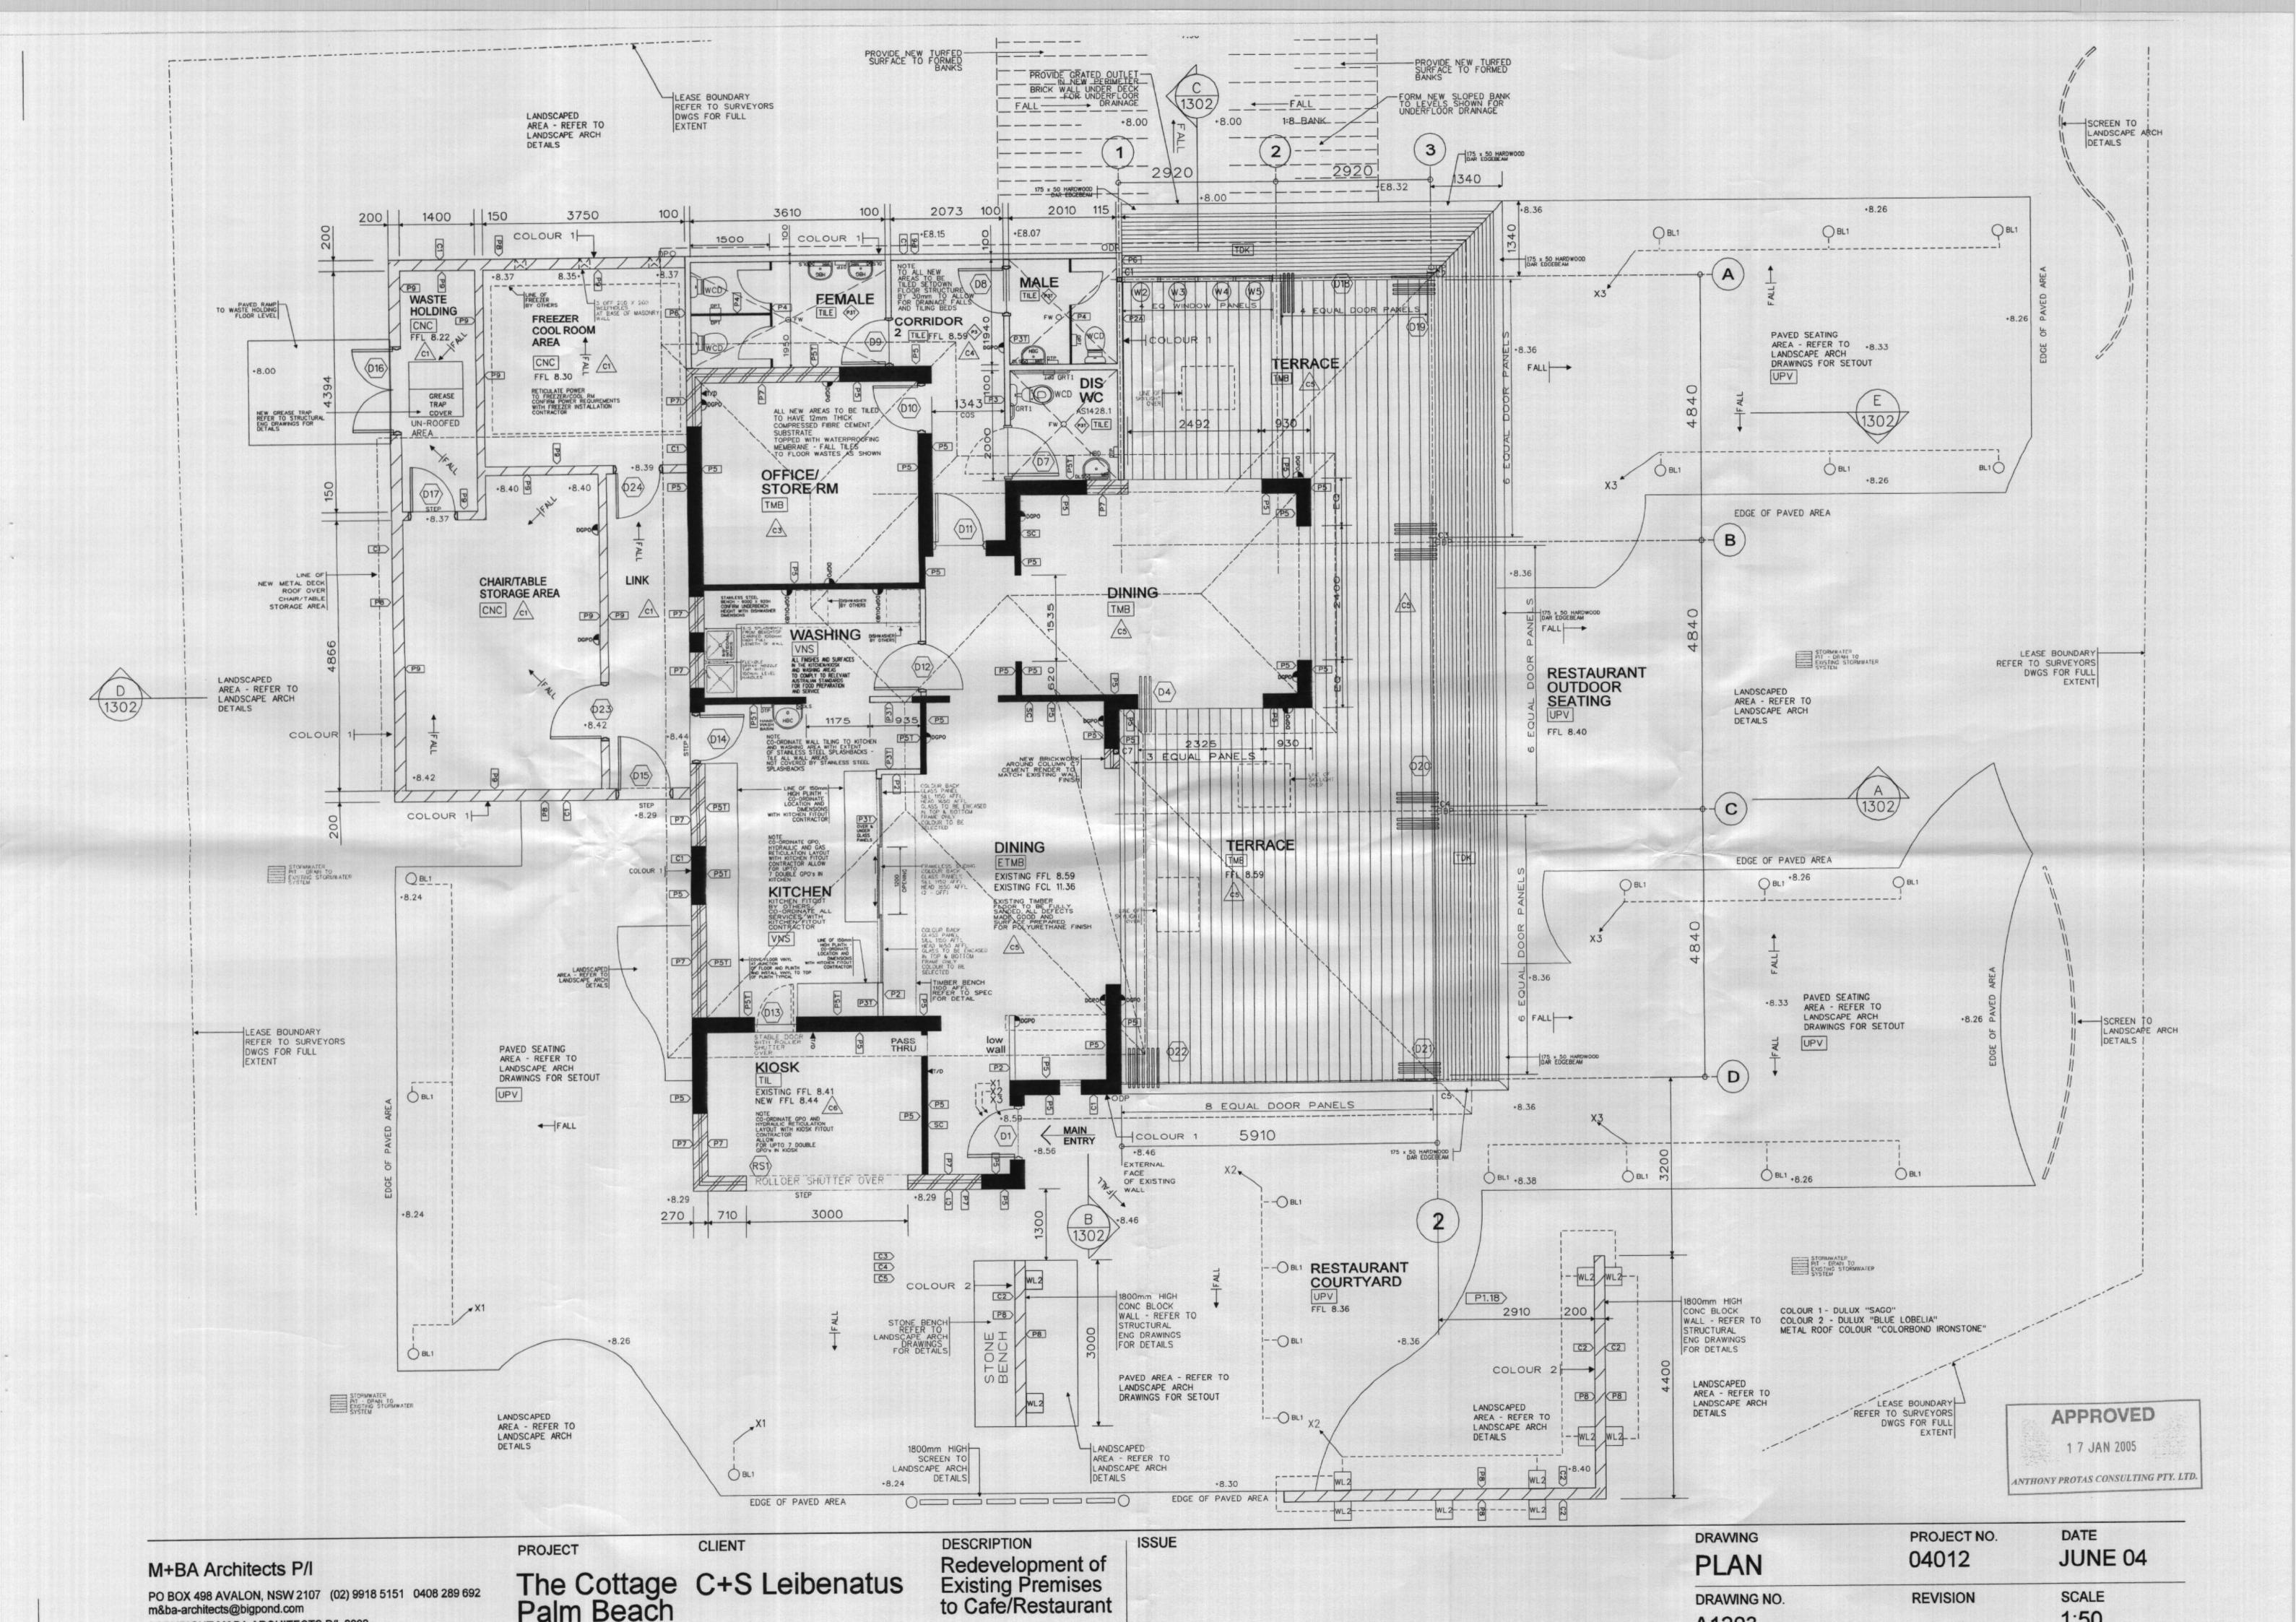

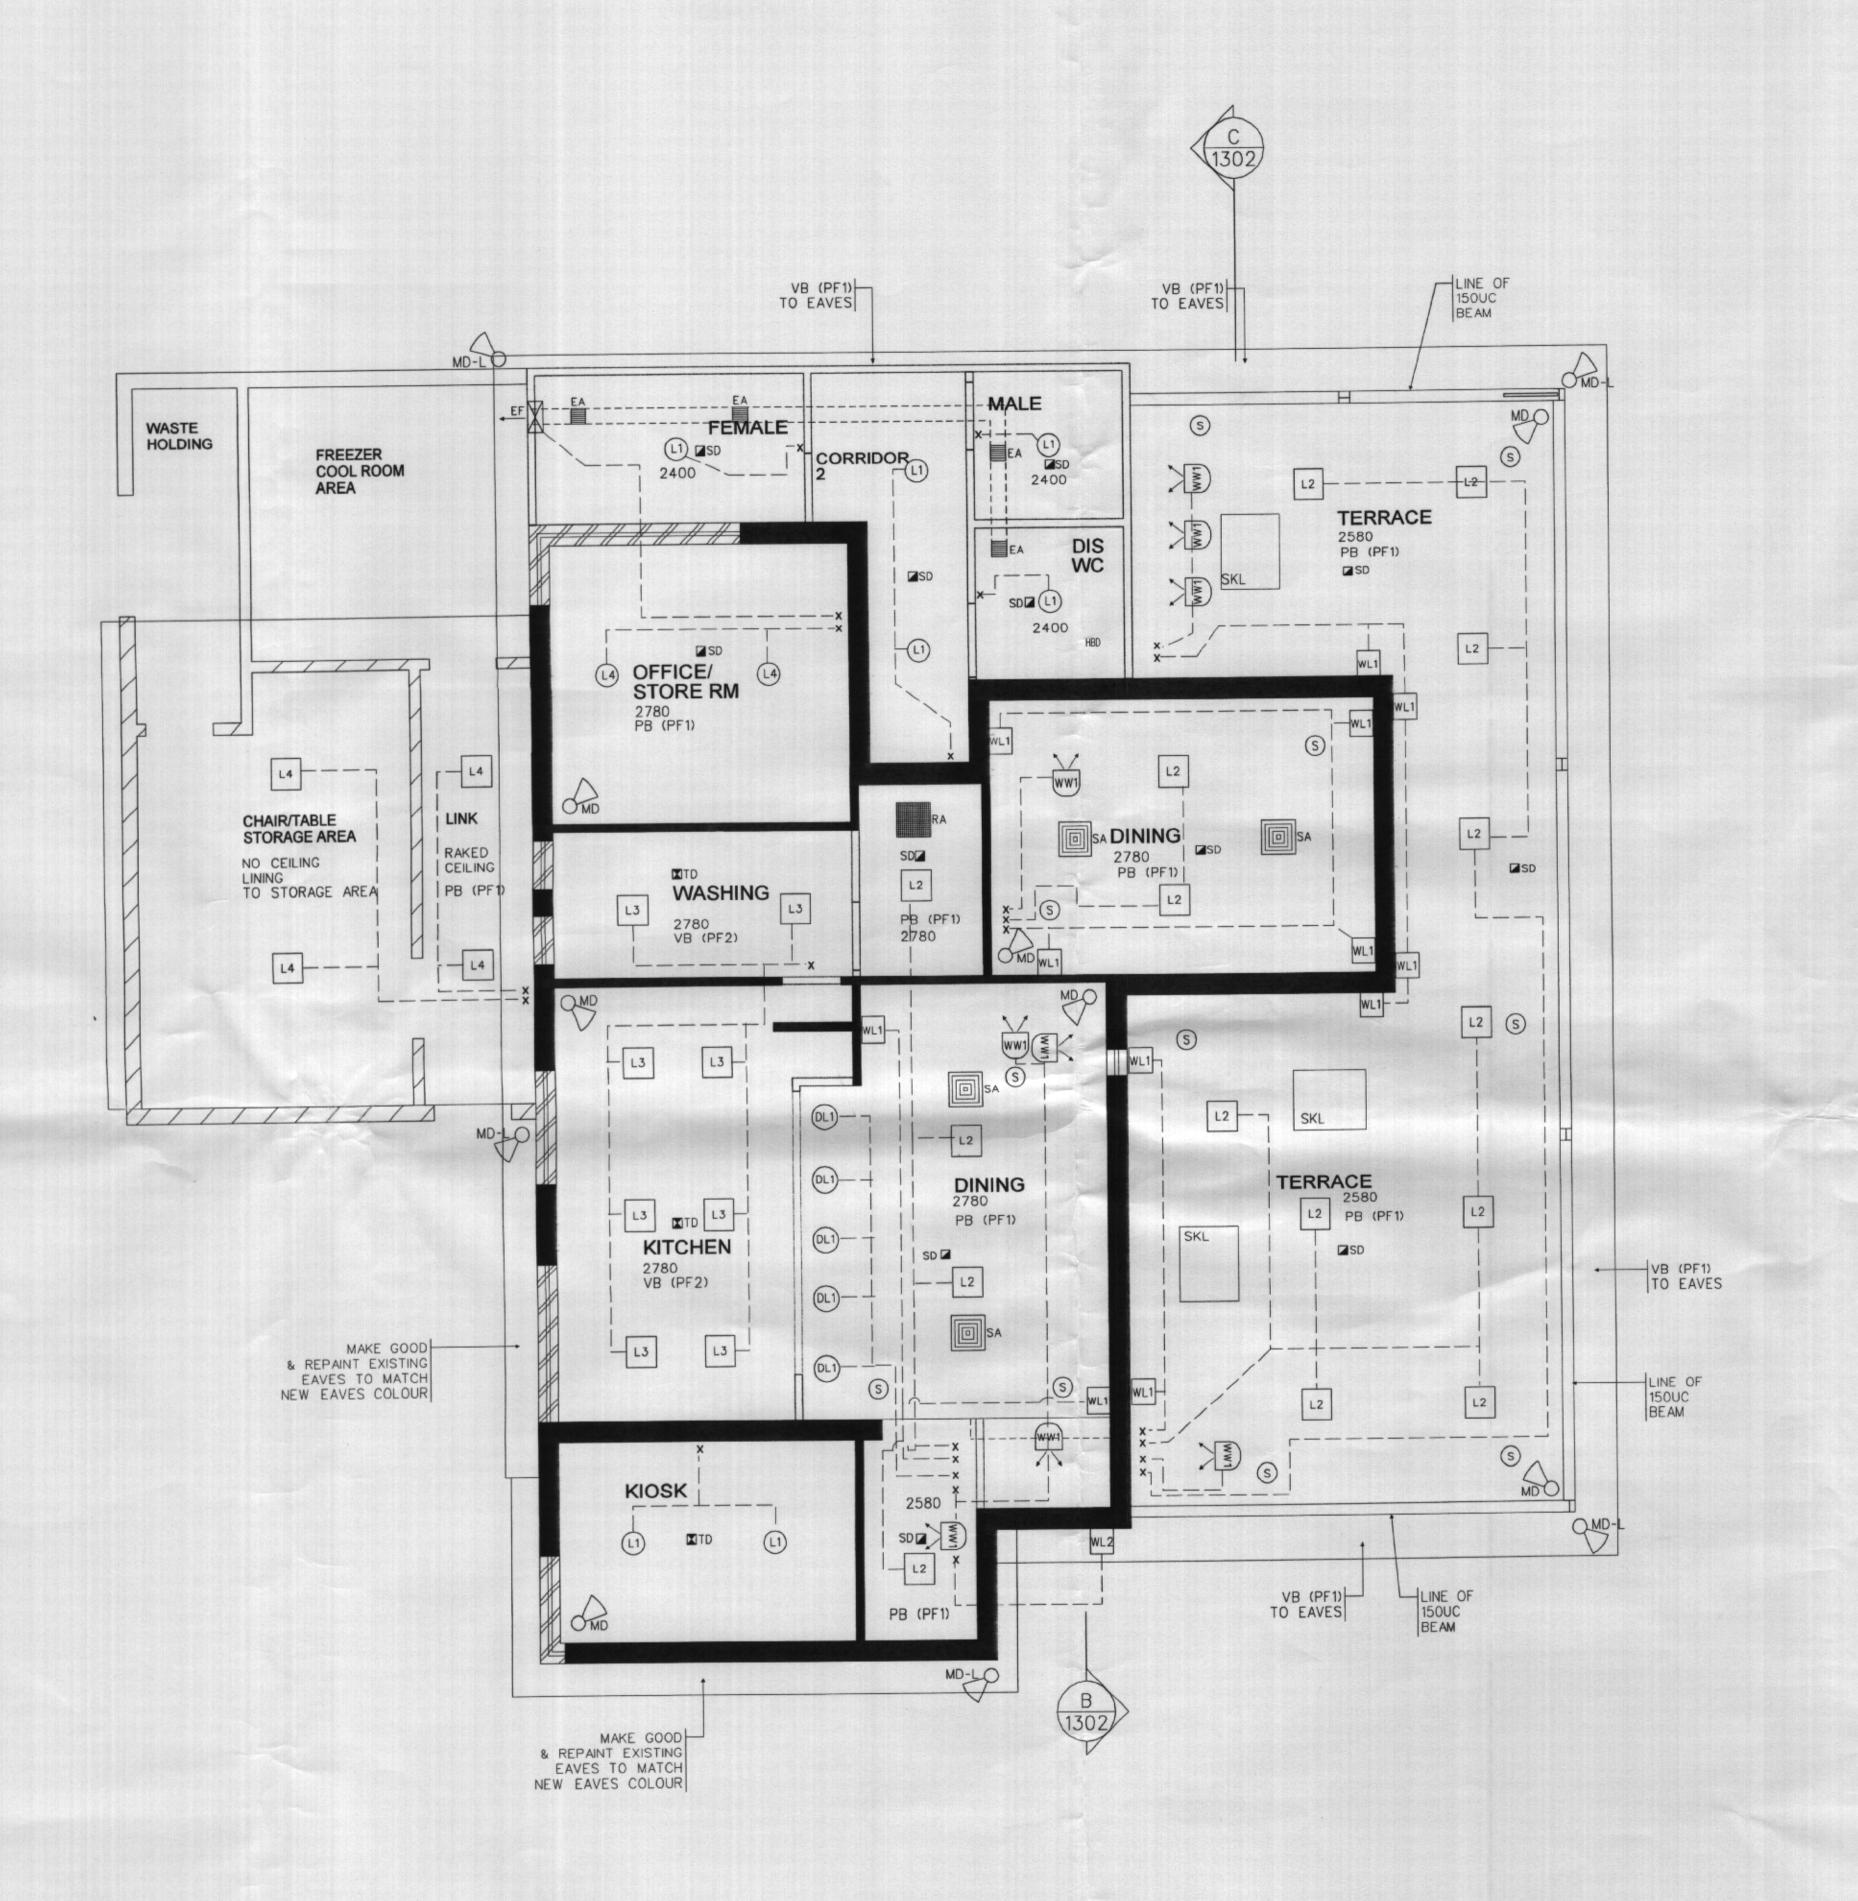

APPROVED 1 7 JAN 2005 ANTHONY PROTAS CONSULTING PTY, LTD.

M+BA Architects P/I

PO BOX 498 AVALON, NSW 2107 (02) 9918 5151 0408 289 692 m&ba-architects@bigpond.com
COPYRIGHT M&BA ARCHITECTS P/L 2002

PROJECT

CLIENT

DESCRIPTION


ISSUE

DRAWING
REFLECTED
CEILING PLAN

PROJECT NO. 04012

DATE JUNE 04

Redevelopment of Existing Premises to Cafe/Restaurant The Cottage C+S Leibenatus Palm Beach SCALE REVISION DRAWING NO. 1:50 A1204

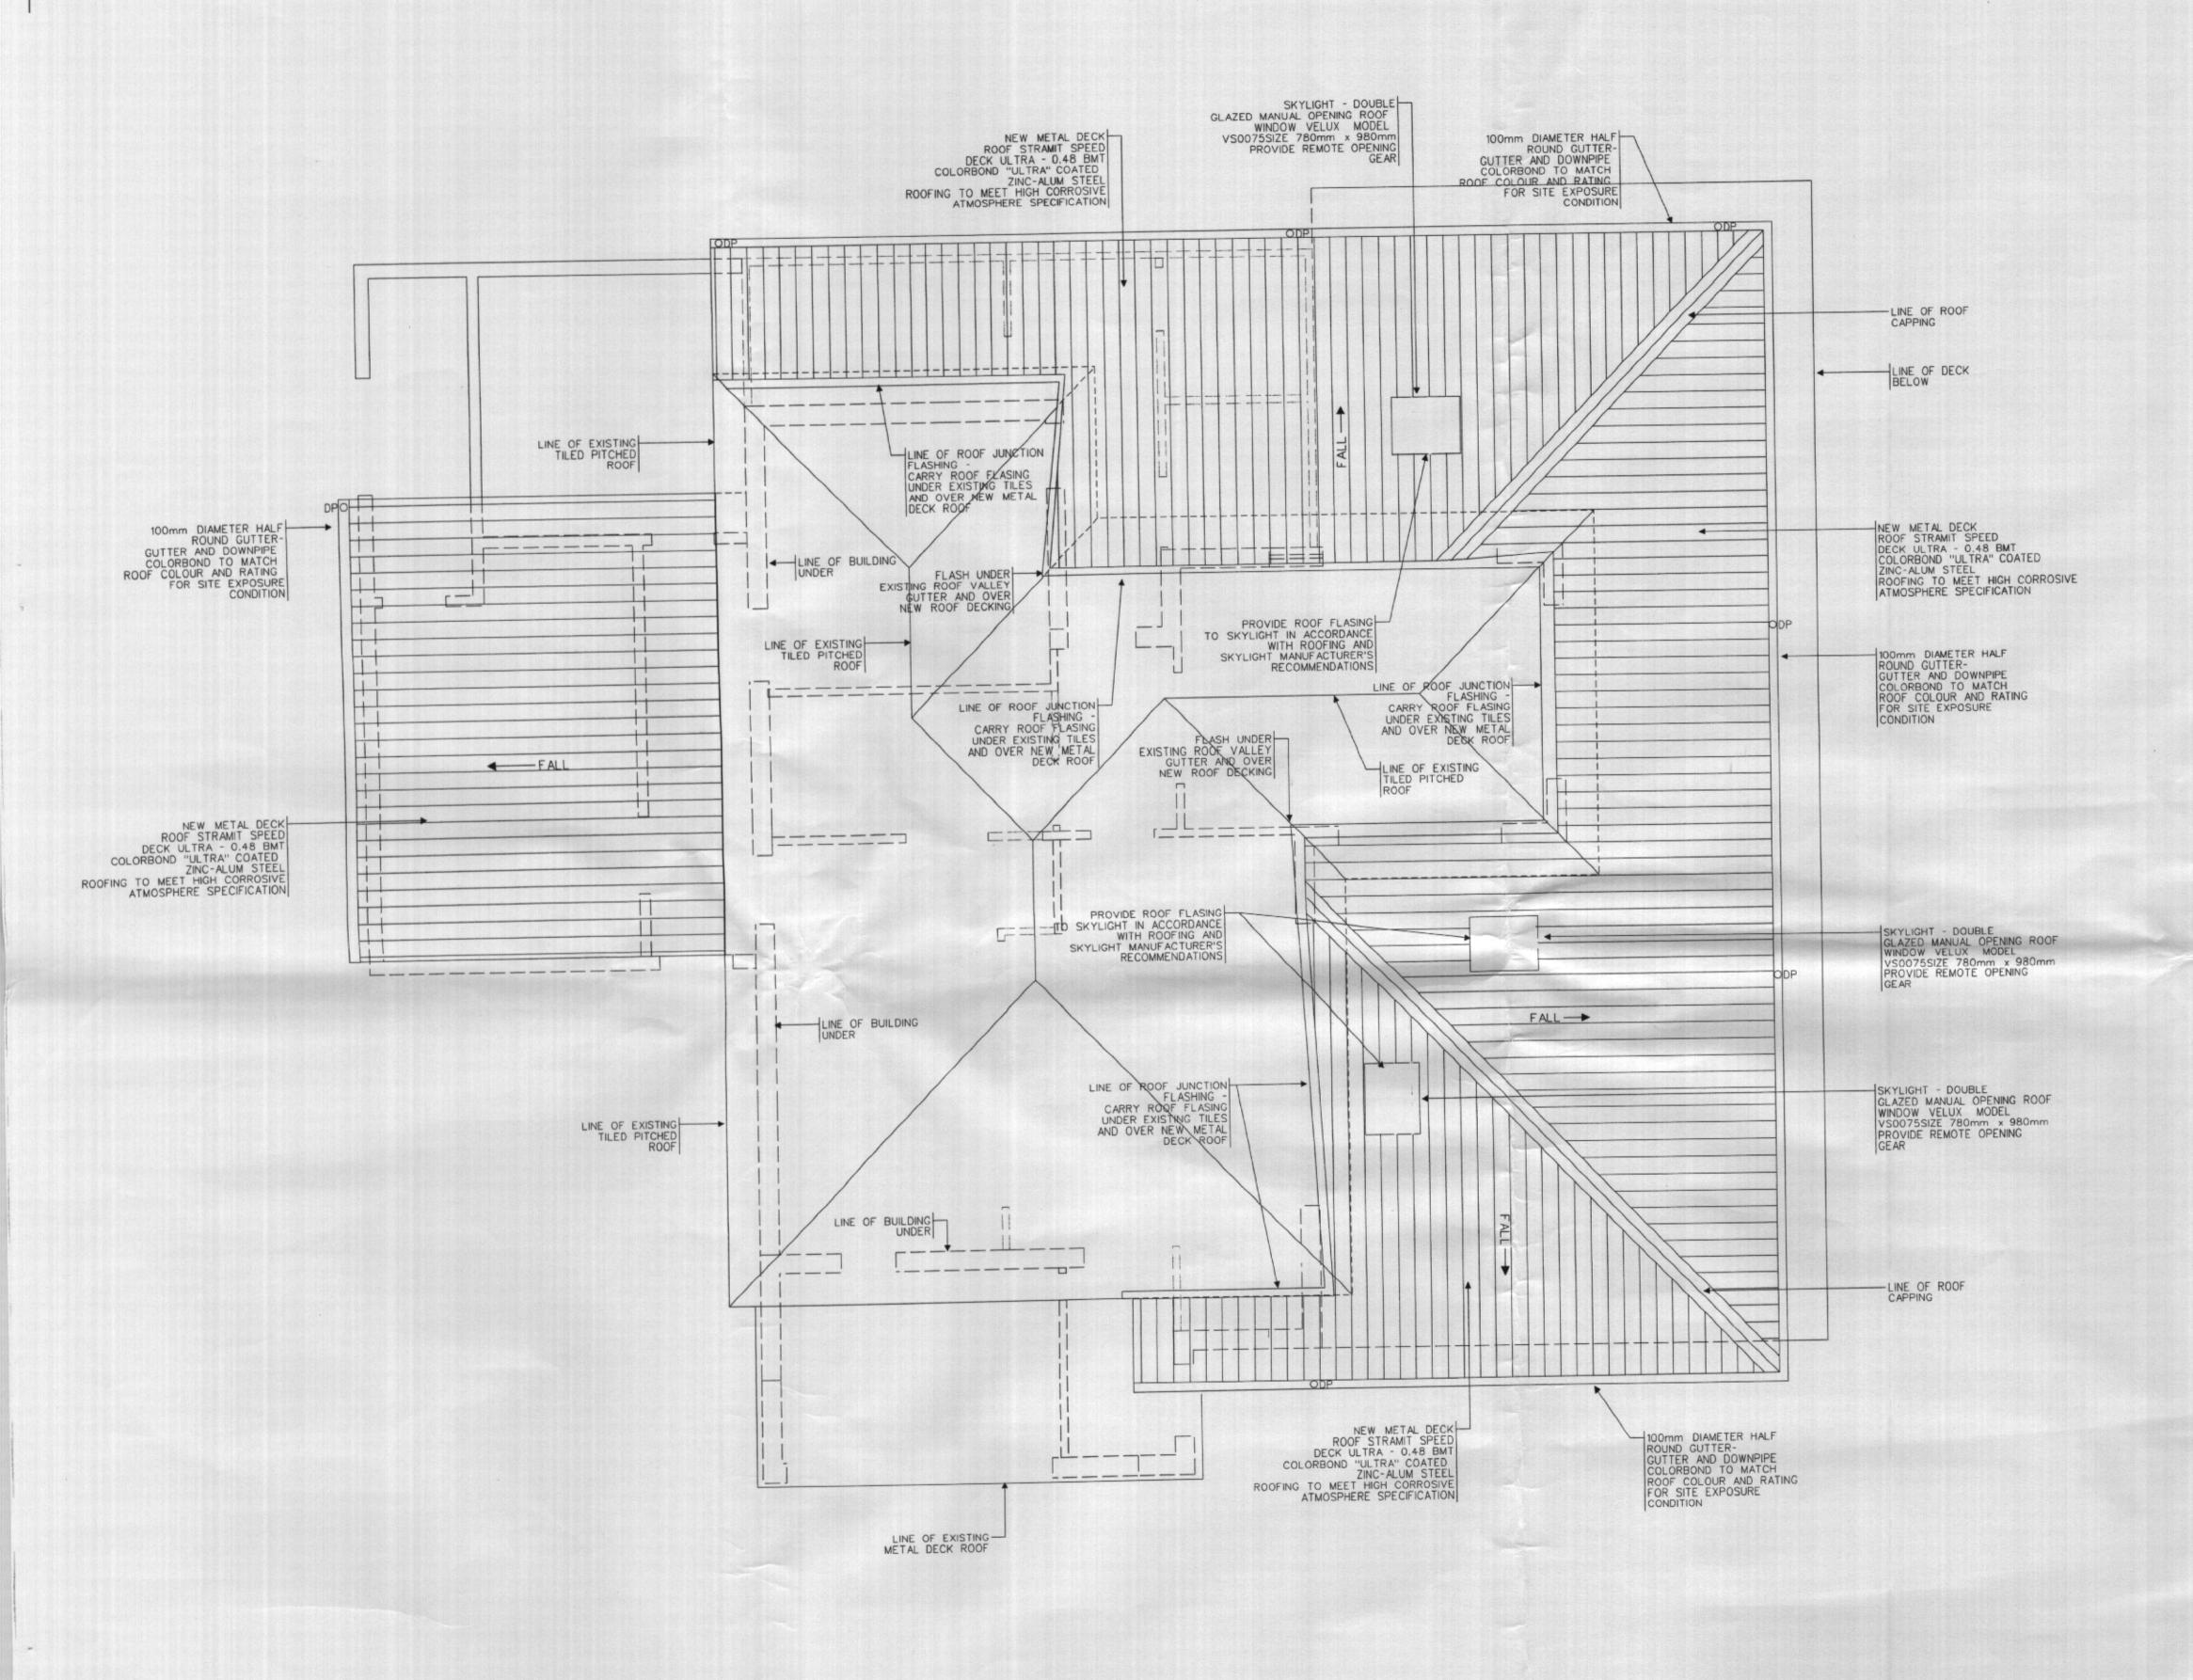

APPROVED

1 7 JAN 2005

ANTHONY PROTAS CONSULTING PTY. LTD.

PO BOX 498 AVALON, NSW 2107 (02) 9918 5151 0408 289 692 m&ba-architects@bigpond.com
COPYRIGHT M&BA ARCHITECTS P/L 2002

PROJECT

The Cottage C+S Leibenatus Palm Beach


CLIENT

Redevelopment of Existing Premises to Cafe/Restaurant

ISSUE

ROOF PLAN 04012 DATE JUNE 04

DRAWING NO. REVISION SCALE 1:50

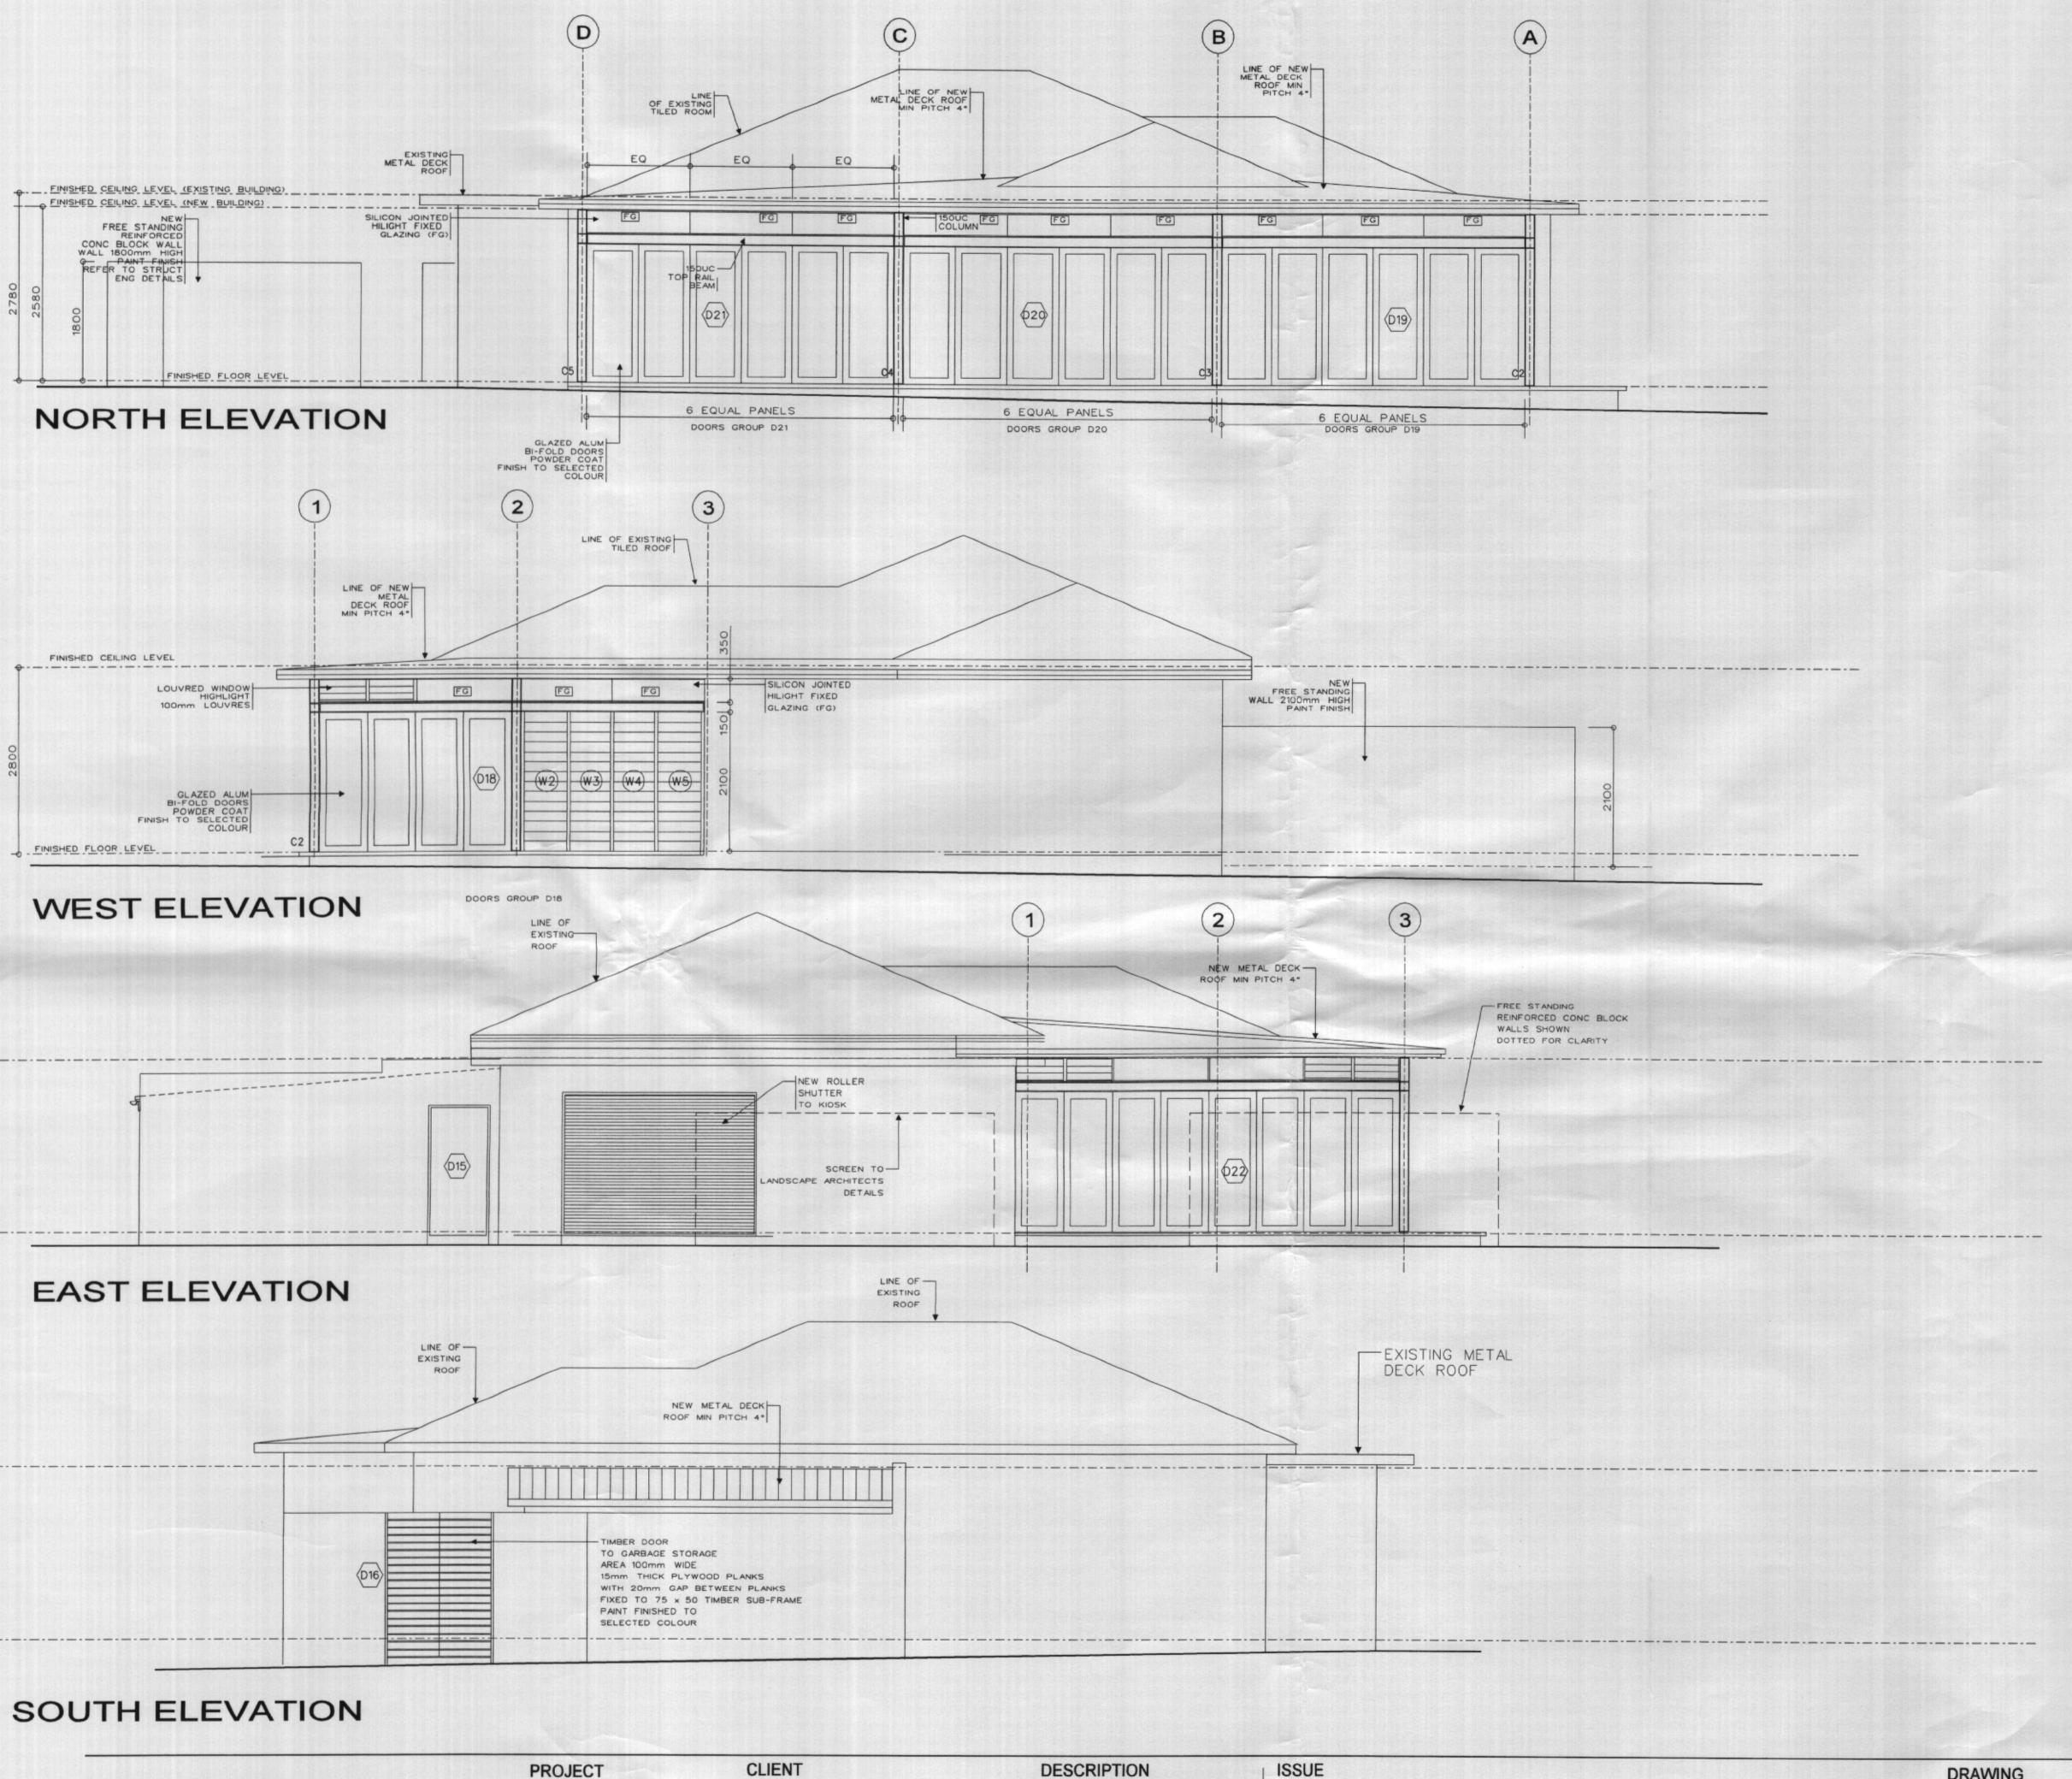

M+BA Architects P/I

PO BOX 498 AVALON, NSW 2107 (02) 9918 5151 0408 289 692 m&ba-architects@bigpond.com COPYRIGHT M&BA ARCHITECTS P/L 2002

PROJECT

The Cottage C+S Leibenatus Palm Beach

DESCRIPTION Redevelopment of Existing Premises to Cafe/Restaurant DRAWING ELEVATIONS N,S,E & W

PROJECT NO. DATE 04012 JUNE 04


SCALE 1.50


APPROVED


1 7 JAN 2005

ANTHONY PROTAS CONSULTING PTY. LTD.

DRAWING NO. REVISION A1301

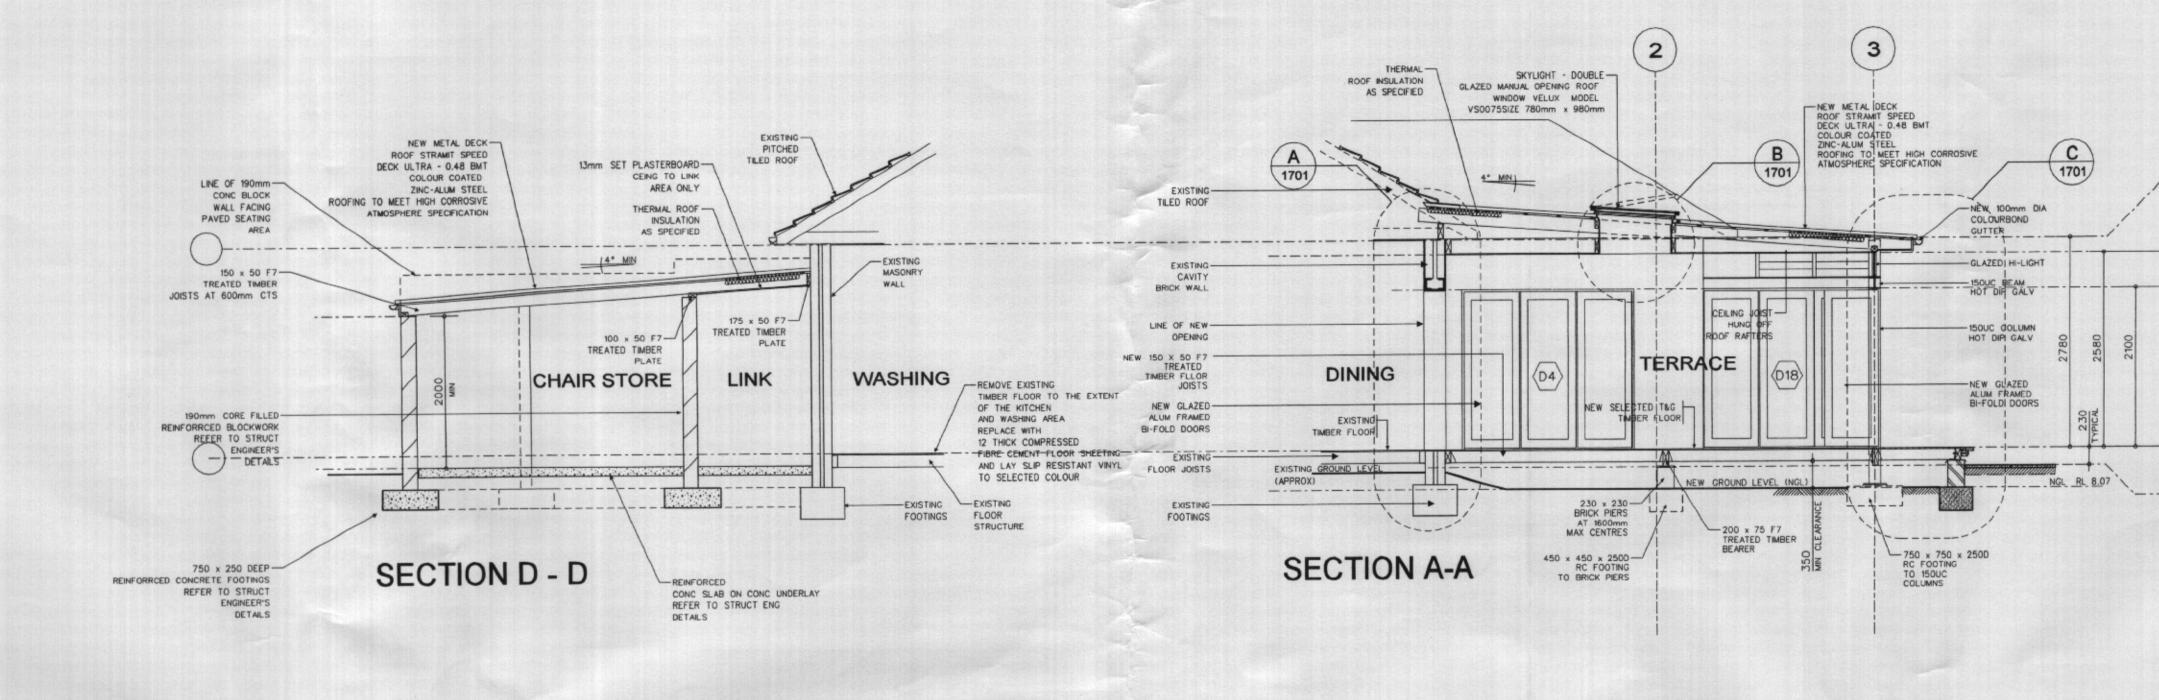

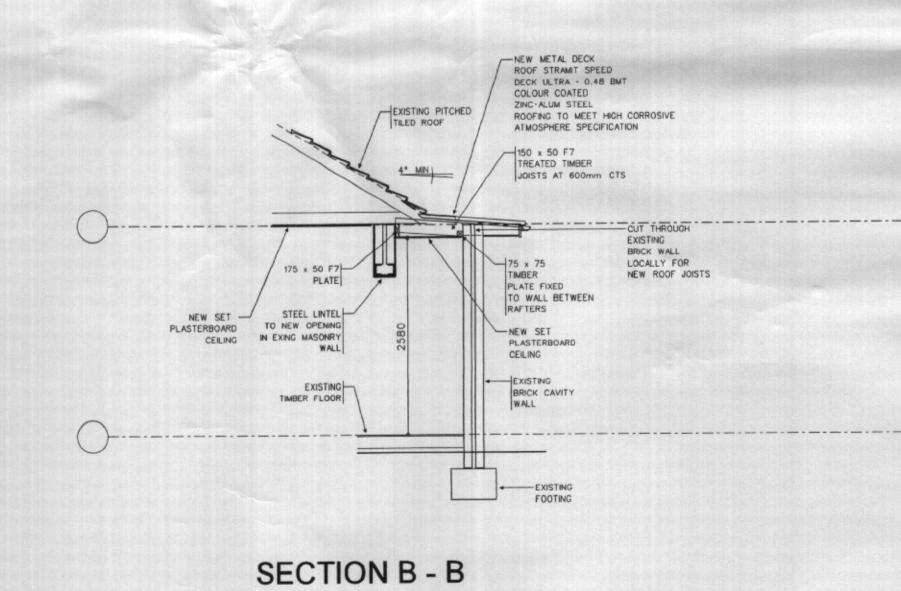

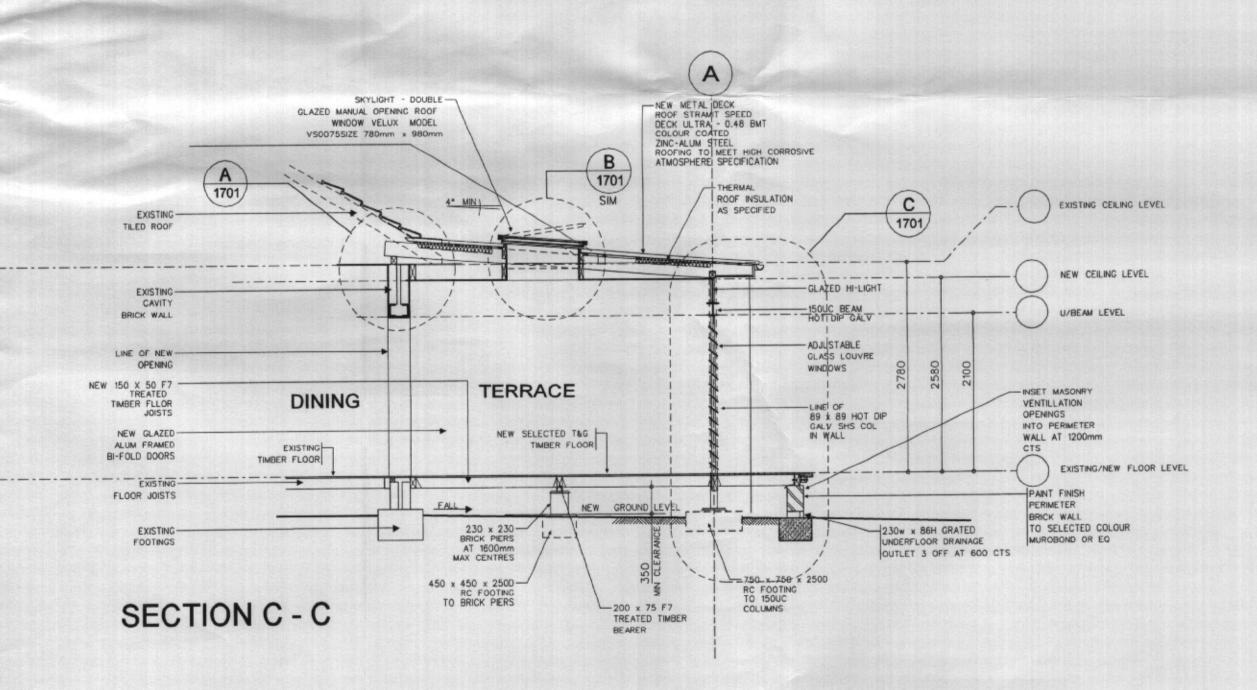

APPROVED

1 7 JAN 2005

ANTHONY PROTAS CONSULTING PTY. LTD.

PO BOX 498 AVALON, NSW 2107 (02) 9918 5151 0408 289 692 m&ba-architects@bigpond.com
COPYRIGHT M&BA ARCHITECTS P/L 2002

PROJECT

The Cottage C+S Leibenatus Palm Beach

CLIENT

Redevelopment of Existing Premises to Cafe/Restaurant

ISSUE

DRAWING PROJECT NO. DATE O4012 JUNE 04


DRAWING NO. REVISION SCALE 1:50


EXISTING CEILING LEVEL

NEW CEILING LEVEL

EXISTING/NEW FLOOR LEVEL

U/BEAM LEVEL

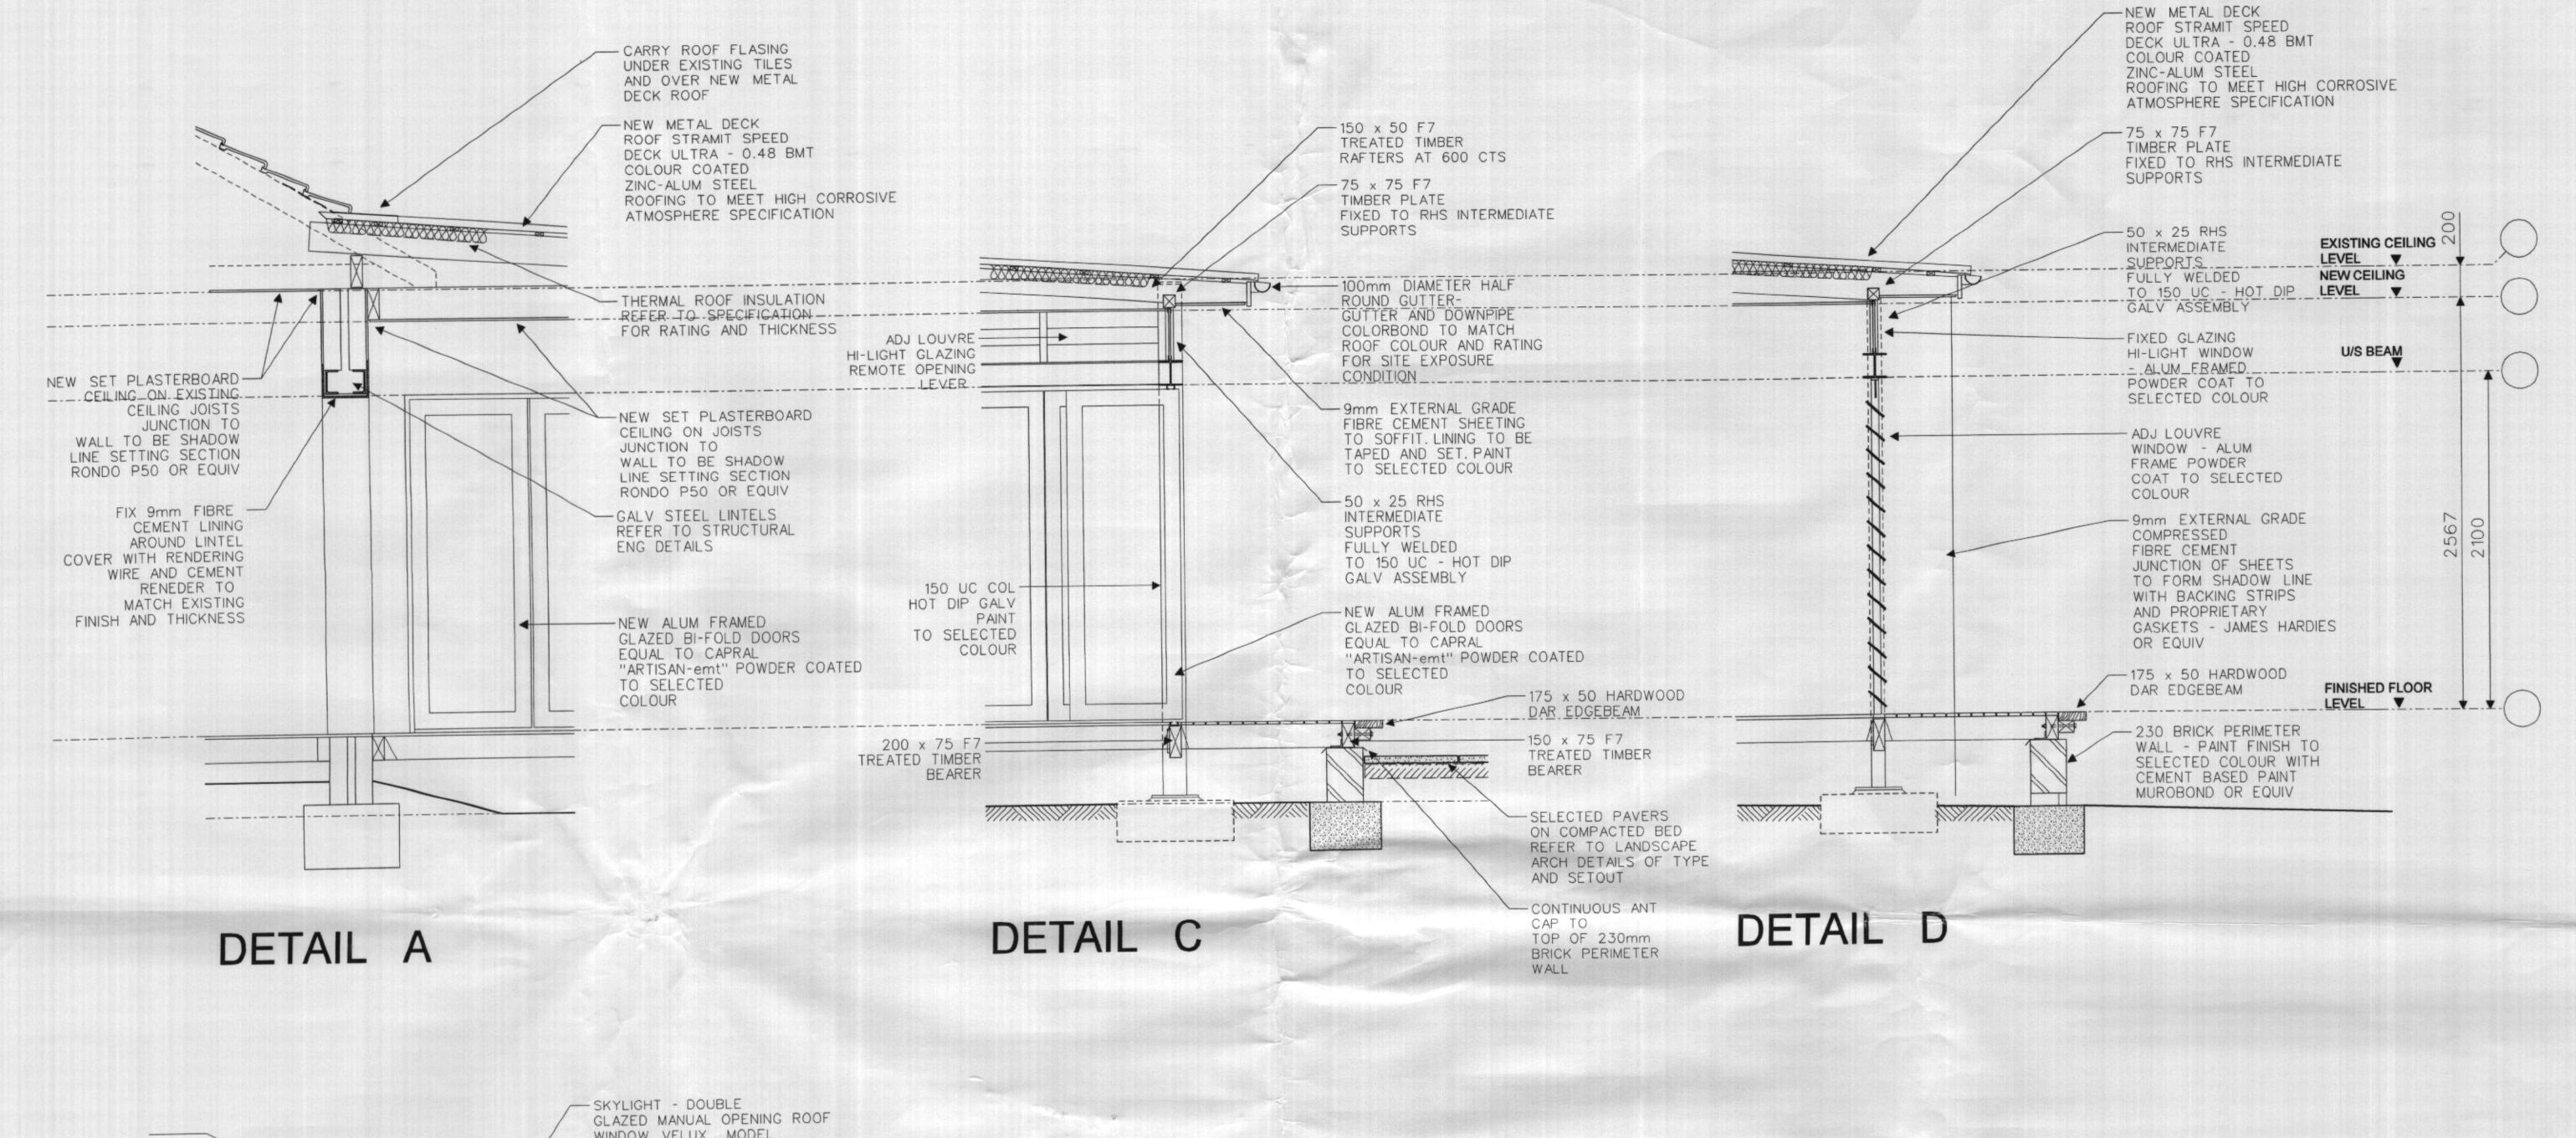

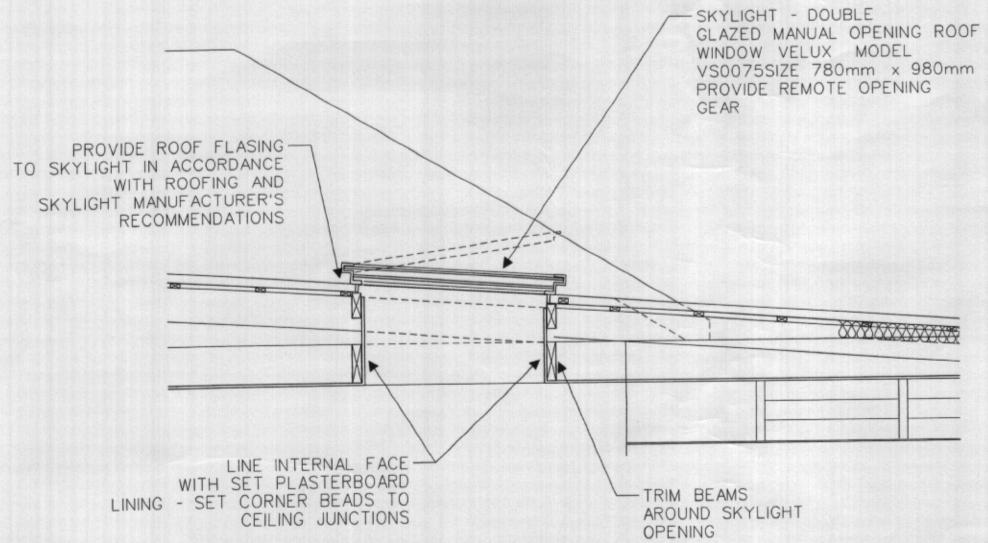

APPROVED

1 7 JAN 2005

DATE

ANTHONY PROTAS CONSULTING PTY. LTD.

M+BA Architects P/I

PO BOX 498 AVALON, NSW 2107 (02) 9918 5151 0408 289 692 m&ba-architects@bigpond.com COPYRIGHT M&BA ARCHITECTS P/L 2002

DETAIL B

PROJECT

The Cottage C+S Leibenatus Palm Beach


CLIENT

DESCRIPTION Redevelopment of Existing Premises to Cafe/Restaurant

ISSUE

PROJECT NO. DRAWING CONSTRUCTION 04012 **DETAILS** REVISION DRAWING NO. A1701

JUNE 04 SCALE 1:20

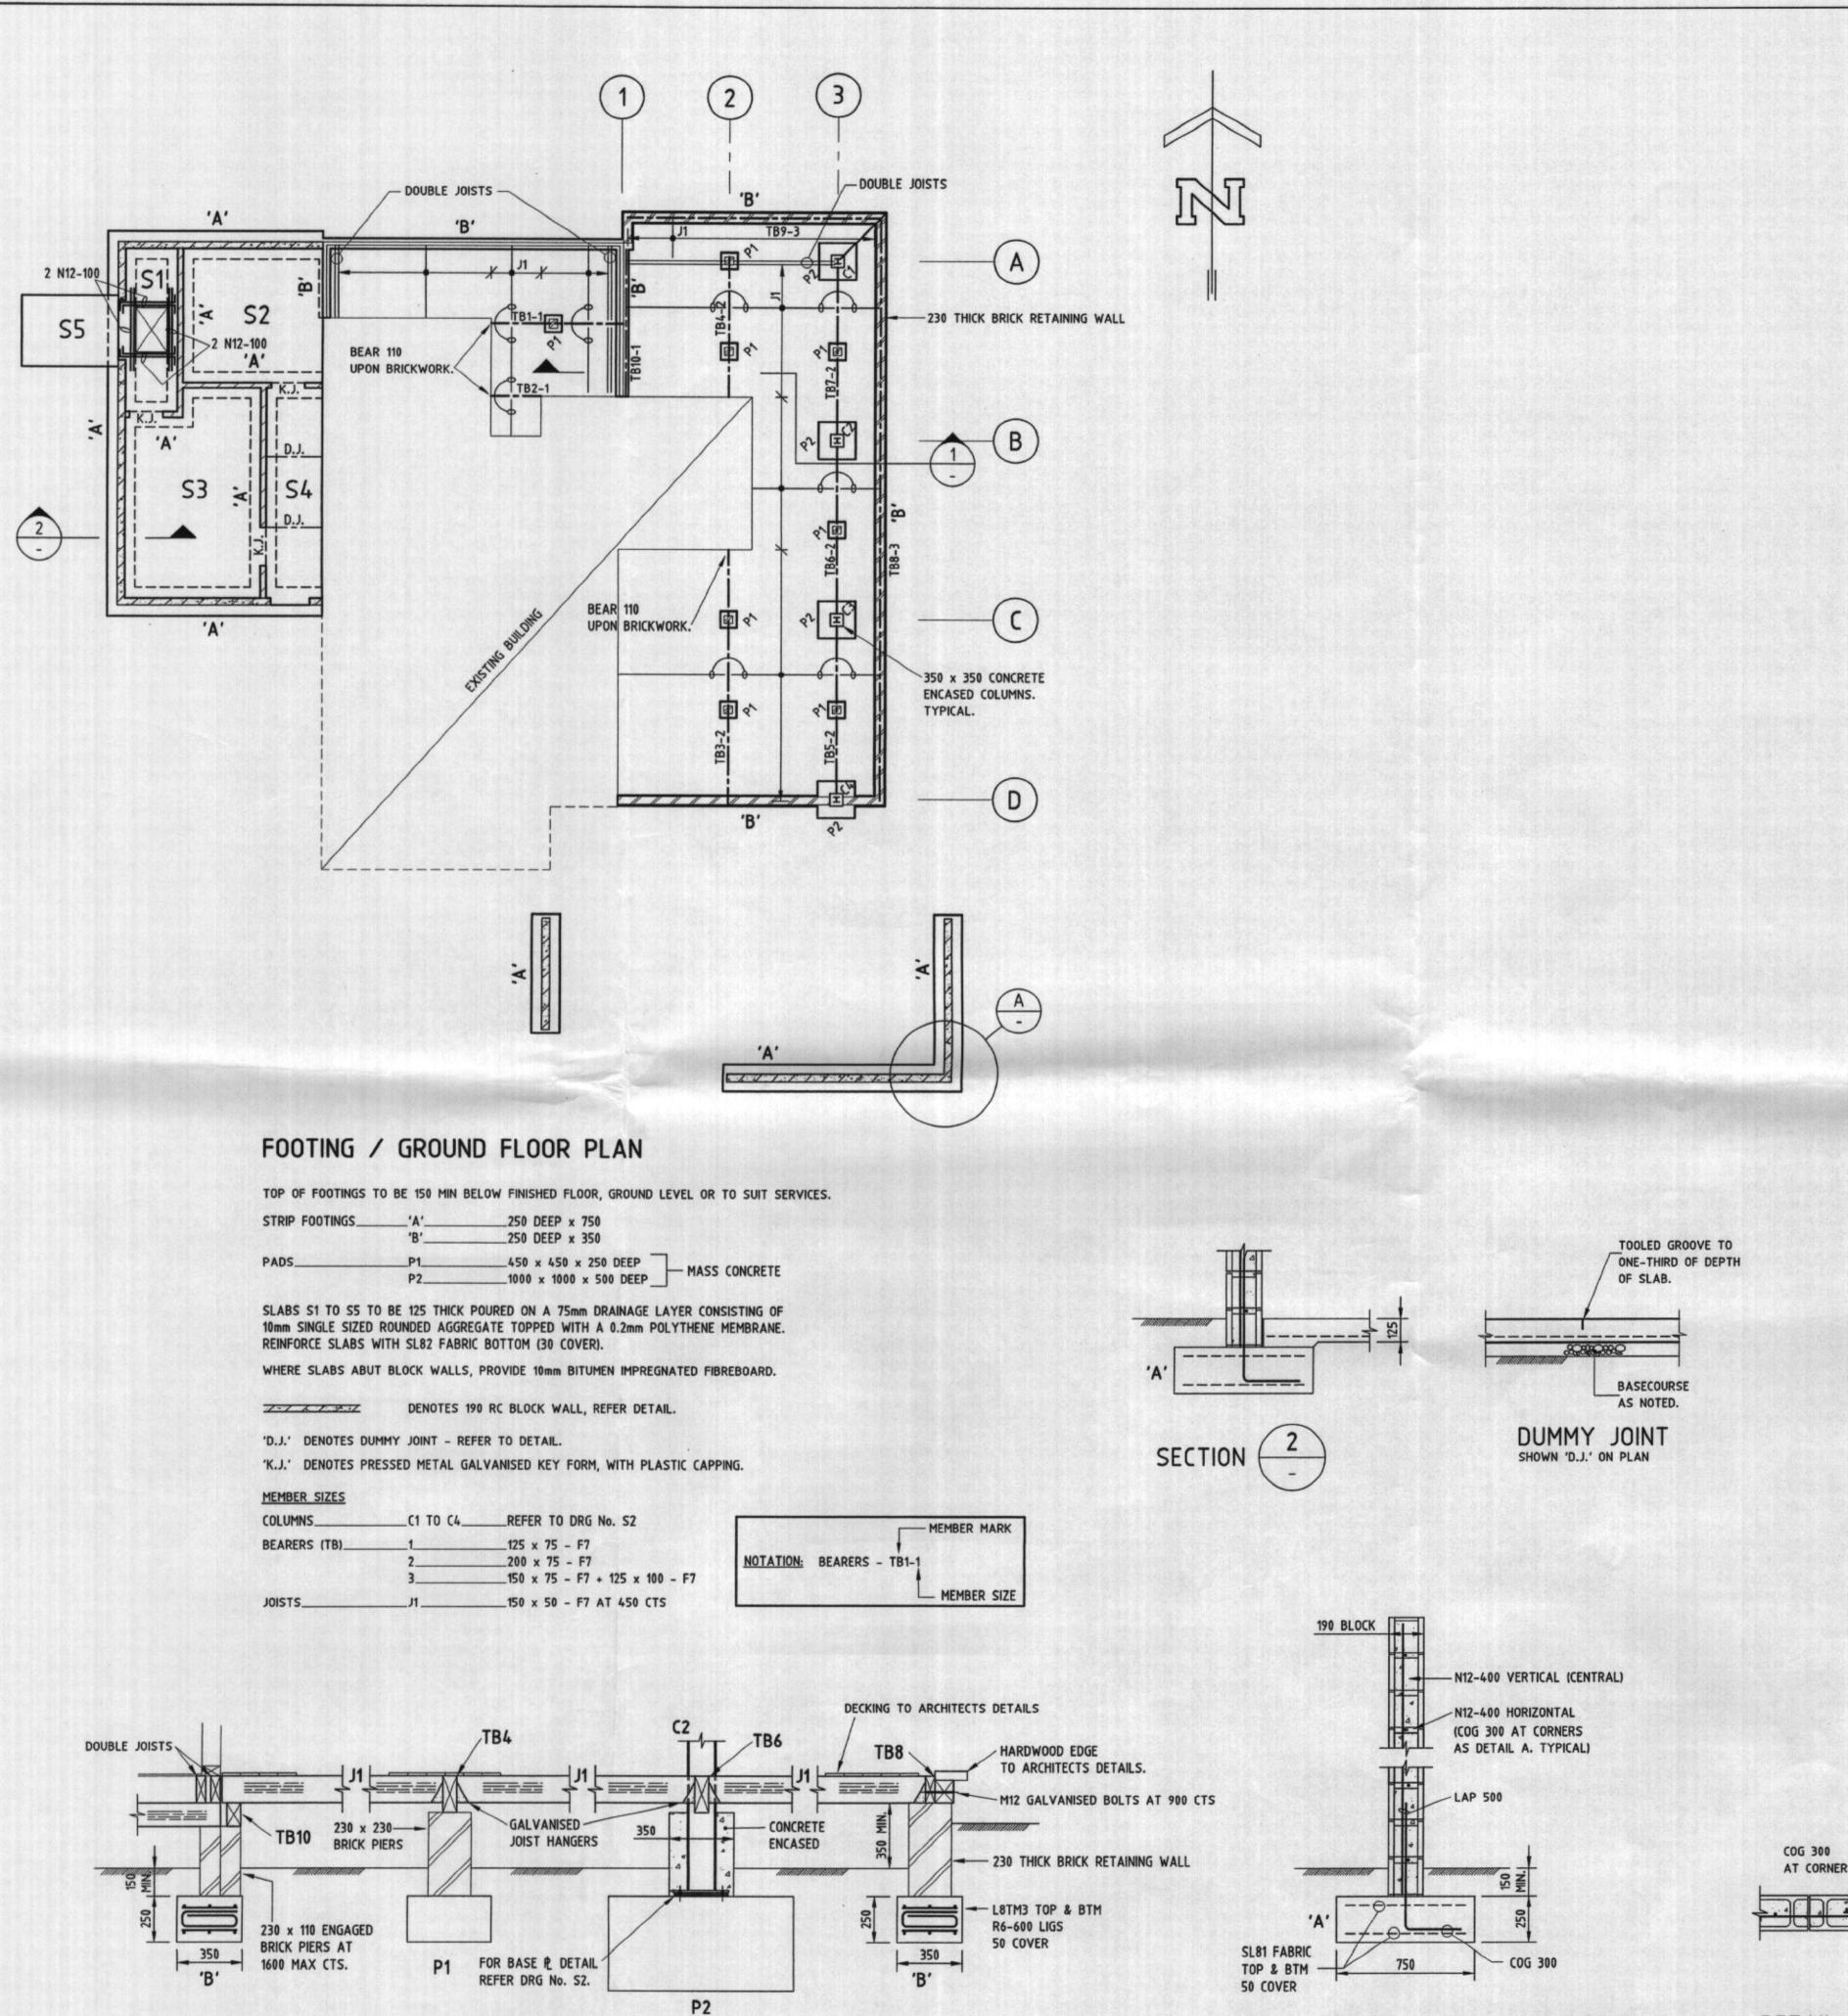


GENERAL NOTES

- G1 THESE DRAWINGS SHALL BE READ IN CONJUNCTION WITH ALL OTHER CONSULTANTS DRAWINGS, SPECIFICATIONS AND AS1100 TECHNICAL DRAWING.
- G2 ANY DISCREPANCIES SHALL BE REFERRED TO THE SUPERINTENDENT FOR DECISION BEFORE PROCEEDING WITH THE WORK.
- G3 DIMENSIONS SHALL NOT BE OBTAINED BY SCALING THE DRAWINGS.
- G4 ANY SETTING OUT DIMENSIONS SHOWN ON THE DRAWING SHALL BE VERIFIED BY
- G5 DURING CONSTRUCTION THE CONTRACTOR SHALL MAINTAIN THE STRUCTURE IN A STABLE CONDITION AND NO PART SHALL BE OVERSTRESSED.
- G6 ALL WORK SHALL COMPLY WITH THE BUILDING CODE OF AUSTRALIA, CONDITIONS OF THE DEVELOPMENT CONSENT AND RELEVANT AUSTRALIAN STANDARD CODES.


FOUNDATION NOTES

- F1 UNLESS NOTED FOOTINGS SHALL BEAR UPON NATURAL GROUND WITH A MINIMUM SAFE BEARING CAPACITY OF 100 kPa.
- F2 FOUNDATION MATERIAL SHALL BE APPROVED BY THE SUPERINTENDENT BEFORE COMMENCING FOOTING CONSTRUCTION.
- F3 FOOTINGS SHALL BE LOCATED CENTRAL UNDER WALLS AND COLUMNS UNLESS NOTED OTHERWISE.
- F4 UNLESS OTHERWISE APPROVED, EXCAVATIONS NEAR NEW OR EXISTING FOOTINGS SHALL NOT BE WITHIN THE FOOTING INFLUENCE LINE.

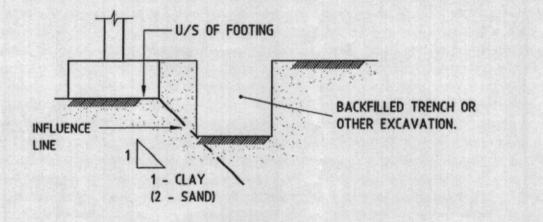

CONCRETE NOTES

- C1 ALL WORKMANSHIP AND MATERIALS SHALL BE IN ACCORDANCE WITH AS 3600 CURRENT EDITION WITH AMENDMENTS, EXCEPT WHERE VARIED BY THE CONTRACT DOCUMENTS.
- C2 CONCRETE QUALITY AS NOTED ON THE DRAWINGS. PROJECT ASSESSMENT OF STRENGTH GRADE SHALL BE USED.
- C3 CLEAR COVER OF REINFORCEMENT SHALL BE AS NOTED ON THE DRAWINGS. REINFORCEMENT SHALL BE RIGIDLY SUPPORTED TO MAINTAIN SPECIFIED COVER DURING CONSTRUCTION.
- C4 SIZES OF CONCRETE ELEMENTS DO NOT INCLUDE THICKNESS OF APPLIED FINISH.
- C5 CONSTRUCTION JOINTS WHERE NOT SHOWN SHALL BE LOCATED TO THE APPROVAL OF THE SUPERINTENDENT.
- C6 BEAM DEPTHS ARE WRITTEN FIRST AND INCLUDE SLAB THICKNESS.
- C7 NO HOLES OR CHASES OTHER THAN THOSE SHOWN ON THE STRUCTURAL DRAWINGS SHALL BE MADE IN CONCRETE MEMBERS WITHOUT THE PRIOR APPROVAL OF THE SUPERINTENDENT.
- C8 CONDUITS, PIPES ETC., SHALL ONLY BE LOCATED IN THE MIDDLE ONE THIRD OF SLAB DEPTH. (UNLESS NOTED OTHERWISE.)
- C9 REINFORCEMENT SYMBOLS:
- R GRADE 250 PLAIN BAR IN ACCORDANCE WITH AS 1302
- N GRADE 500 DEFORMED BAR DUCTILITY CLASS N (D500N) IN ACCORDANCE WITH AS/NZS 4671 WITH A CARBON EQUIVALENT (CE) LIMIT OF 0.39 MAX. SL - GRADE 500 SQUARE WELDED FABRIC, DEFORMED BARS DUCTILITY
- CLASS L (D500L) IN ACCORDANCE WITH AS/NZS 4671. RL - GRADE 500 RECTANGULAR WELDED FABRIC, DEFORMED BARS DUCTILITY
- CLASS L (D500L) IN ACCORDANCE WITH AS/NZS 4671. C10 REINFORCEMENT IS REPRESENTED DIAGRAMMATICALLY; IT IS NOT NECESSARILY
- SHOWN IN TRUE PROJECTION.
- C11 SPLICES IN REINFORCEMENT SHALL BE MADE ONLY IN THE POSITIONS SHOWN. OBTAIN APPROVAL FROM THE SUPERINTENDENT FOR ANY OTHER SPLICES.
- C12 WELDING OF REINFORCEMENT SHALL NOT BE PERMITTED UNLESS SHOWN ON THE STRUCTURAL DRAWINGS.
- C13 FABRIC SHALL BE LAPPED 1 MESH + 50 mm.
- C14 CURE CONCRETE IN ACCORDANCE WITH AS 3600. METHOD OF CURING SHALL BE SUBMITTED TO THE SUPERINTENDENT FOR APPROVAL.

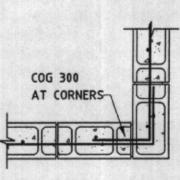

TYPICAL 190 RC BLOCK WALL DETAIL

REFERENCE DRAWINGS:

FOR STRUCTURAL STEEL NOTES REFER TO DRG. No. S2 FOR TIMBER FRAMING NOTES REFER TO DRG. No. S2

CONCRETE QUALITY Slump Strength Grade Max. Agg. Cemen ELEMENT Type mm N32 80 20 GP SLABS REMAINDER N25 80 20 GP

MASONRY NOTES

- M1 ALL WORKMANSHIP AND MATERIALS SHALL BE IN ACCORDANCE WITH AS 3700 AND CURRENT EDITION WITH AMENDMENTS, EXCEPT WHERE VARIED BY CONTRACT DOCUMENTS.
- M2 MASONRY UNITS
 - MINIMUM CHARACTERISTIC UNCONFINED COMPRESSIVE STRENGTH (f'uc) = 15 MPa
- M3 MORTAR

MINIMUM MORTAR CLASSIFICATION M3

BLOCKWORK, 300 INTO SOLID BLOCK WORK AND BRICKWORK.

- M4 UNLESS NOTED OTHERWISE MASONRY WALLS BUILT AGAINST STEEL OR CONCRETE COLUMNS, WALLS OR BEAMS SHALL BE FIXED TO THOSE ELEMENTS USING 50 mm WIDE x 1.5 mm THICK WITH 50 mm UPTURN GALVANISED STEEL WALL TIES AT 600 mm MAXIMUM CENTRES, POWER FIXED WITH 3.8 DIA. DRIVE PINS. EMBED EACH TIE A MINIMUM OF 450 mm INTO COURSING OF HOLLOW
- M5 CAVITY AND VENEER TIES TO BE TYPE A, MEDIUM DUTY, SPACED AT 600mm MAX CTS (VERTICAL AND HORIZONTAL). ADJACENT TO COLUMNS, CROSS WALLS, CONTROL JOINTS AND AROUND THE PERIMETER OF OPENINGS PROVIDE WALL TIES AT 300mm MAX CTS.
- M6 CAVITIES IN BRICKWORK SHALL BE FILLED WITH MORTAR TO FINISH GROUND LEVEL PRIOR TO BACKFILLING AGAINST WALL. BACKFILLING AND COMPACTION OF FILL MATERIAL AGAINST BRICK WALLS SHALL BE CARRIED OUT SIMULTANEOUSLY ON EACH SIDE OF THE WALL.
- M7 CHASES AND RECESSES IN LOAD-BEARING MASONRY SHALL NOT BE MADE WITHOUT THE APPROVAL OF THE SUPERINTENDENT.
- M8 NON LOAD-BEARING MASONRY WALLS SHALL STOP 15 mm BELOW THE UNDERSIDE OF SLABS AND BEAMS.
- M9 REINFORCED CONCRETE BLOCK WALLS SHALL COMPLY WITH THE FOLLOWING:
- 1. ALL BLOCKS SHALL BE DOUBLE "U" BLOCKS WITH SHALLOW TOP GROOVES FOR REINFORCEMENT.
- 2. ALL MORTAR DAGS SHALL BE REMOVED BEFORE FILLING CORES WITH GROUT. PROVIDE CLEAN OUT HOLES AT THE BASE OF ALL WALLS AND EACH POUR BREAK.
- 3. FILL ALL CORES WITH GROUT OF f'c 20 MPa SLUMP 230. 10 mm AGGREGATE SIZE. MINIMUM CEMENT CONTENT = 300kg/m
- 4. ALL PERPENDS, EXCEPT WHERE REQUIRED FOR WEEPHOLES SHALL BE FULLY FILLED WITH MORTAR.
- 5. CORE GROUT IS TO BE COMPACTED TO ENSURE COMPLETE FILLING OF ALL CORES.
- 6. PROVIDE TEMPORARY PROPPING TO WALLS WHERE REQUIRED FOR STABILITY DURING CONSTRUCTION.
- 7. STARTER BARS SHALL BE ACCURATELY POSITIONED BY TEMPLATES OR SIMILAR MEANS.
- 8. STARTER BARS SHALL BE TIED TO VERTICAL WALL BARS THROUGH INSPECTION OPENINGS AT THE BASE OF THE WALL AND ALSO ACCURATELY FIXED IN POSITION AT THE TOP BY AN APPROPRIATE METHOD.
- 9. REINFORCEMENT SHALL BE ACCURATELY PLACED AND FIRMLY HELD IN POSITION TO A TOLERANCE OF ± 10 mm

Ver. App Amendment

Woolacotts.

Consulting Engineers

Woolacott Hale Corlett & Jurnikis Consulting Engineers Pty Ltd A.C.N. 002 791 620 2A Broughton Rd.
Artarmon 2064.
Telephone (02) 9413 1399
Facsimile (02) 9413 1132
E-mail office@woolacotts.com.au

DETAILS

This drawing is Copyright and must not be used, reproduced or copied wholly or in part without written permission of Woolacott Hale Corlett & Jumikis Consulting Engineers Pty. Ltd.

'THE COTTAGE', GOVERNOR PHILLIP PARK

PALM BEACH FOR

C. & S. LEBENATUS

M + BA ARCHITECTS PTY LTD P.O. BOX 498 AVALON 2107 PH: 9918 5151


Drawing title

FOOTING / GROUND FLOOR

PLAN AND DETAILS

Scale D.G./D.Mc. JULY 2004 14.7.04 14.7.04 1:100, 20 Amendment Drawing number

04-47 **S1**

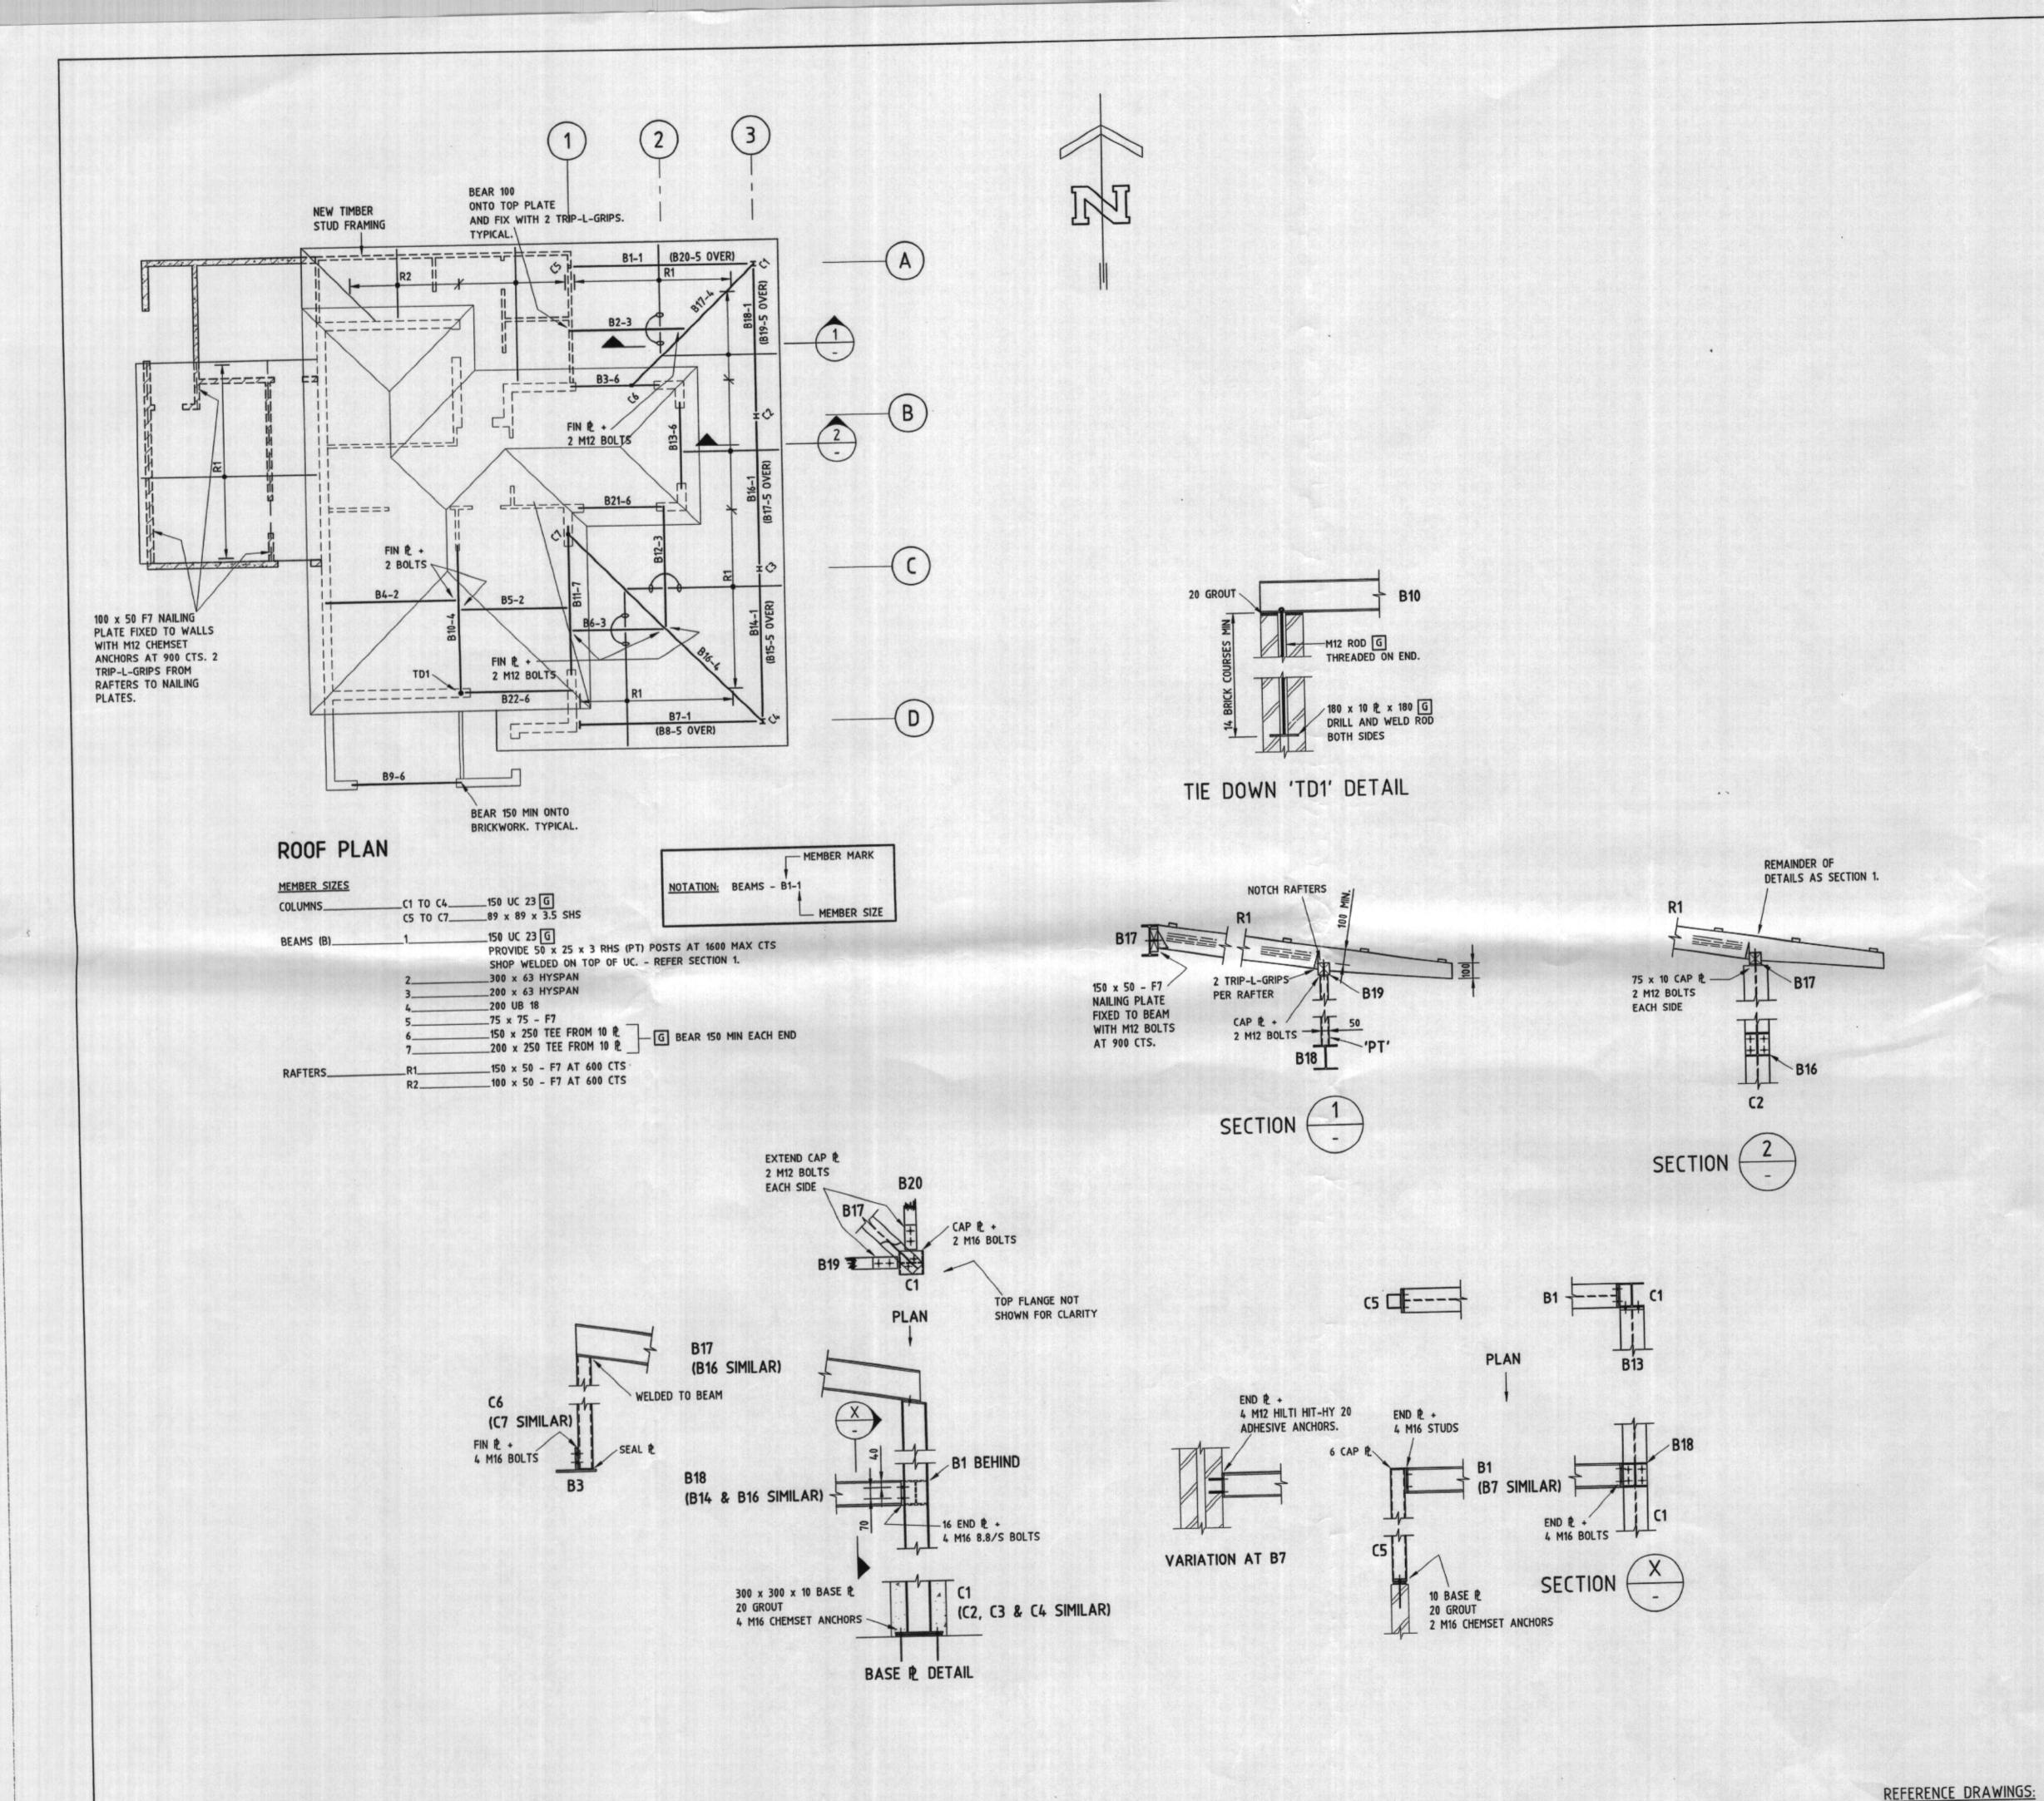

STRUCTURAL STEELWORK NOTES

- S1 ALL WORKMANSHIP AND MATERIALS SHALL BE IN ACCORDANCE WITH AS 4100 CURRENT EDITION WITH AMENDMENTS, EXCEPT WHERE VARIED BY THE CONTRACT DOCUMENTS.
- S2 STEEL QUALITY ALL STEELWORK SHALL BE GRADE 250 UNLESS NOTED. ROLLED SECTIONS (UB, UC, PFC, EA etc) SHALL BE GRADE BHP-300PLUS. RECTANGULAR HOLLOW SECTIONS SHALL BE GRADE 350 UNLESS NOTED. COLD FORMED PURLIN AND GIRT SECTIONS SHALL BE IN ACCORDANCE WITH AS1397 AND AS1538, AND BE EQUIVALENT TO BHP GALVASPAN, COATING CLASS Z350.
- ALL WELDING SHALL BE IN ACCORDANCE WITH AS 1554. UNLESS NOTED ALL CONNECTIONS BETWEEN MEMBERS SHALL BE 6 mm CONTINUOUS FILLET WELD TYPE G.P. BUTT WELDS SHALL BE COMPLETE PENETRATION TYPE SP. WELDING SYMBOLS ON DRAWINGS ARE IN ACCORDANCE WITH AS 1101 PART 3.
- BOLTS SHALL BE M20 4.6/S UNLESS NOTED. MEMBERS SHALL BE CONNECTED WITH 2 BOLTS UNLESS NOTED. BOLTING PROCEDURES SHALL BE AS FOLLOWS:

FIRMO I MOCETO			
BOLTING	BOLT NAME	AUSTRALIAN STANDARD	INSTALLATION AS 4100
PROCEDURE	COMMERCIAL	AS 1111	SNUG TIGHTENED
4.6/5	HIGH STRENGTH	AS 1252	SNUG TIGHTENED
8.8/5		AS 1252	TENSIONED FRICTION
8.8/TF	HIGH STRENGTH		TENSIONED BEARING
	HIGH STRENGTH	AS 1252	I ENDIONED DEFINITION

APPROVED LOAD-INDICATING WASHERS SHALL BE USED UNDER THE BOLT HEAD OF 8.8/TF AND 8.8/TB JOINTS.

- SS HOLES IN MEMBERS FOR FIXINGS OF OTHER TRADES SHALL NOT EXCEED 14 mm DIAMETER.

ALL PLATES SHALL BE 10 mm THICK UNLESS NOTED. BEARING PLATE DIMENSIONS PARALLEL TO WEBS ARE GIVEN FIRST.

ST SURFACE TREATMENT PRIMER UNLESS NOTED ALL STEELWORK SHALL BE POWERTOOL CLEANED TO A CLASS 2 PREPARATION IN ACCORDANCE WITH AS 1627.2 AND COATED WITH A MINIMUM OF 75 MICRONS OF AN APPROVED ZINC

PHOSPHATE PRIMER IN ACCORDANCE WITH AS K108. NO PRIMING COAT SHALL BE APPLIED TO CONTACTING SURFACES UTILISING 8.8/TF BOLTS NOR TO MEMBERS TO BE SUBSEQUENTLY CONCRETE ENCASED OR FIRE RATED.

- MEMBERS NOTED Z SHALL BE GIVEN A CLASS 2.5 PREPARATION IN ACCORDANCE WITH AS 1627.4 AND COATED WITH A MINIMUM OF 75 MICRONS OF AN APPROVED INORGANIC ZINC SILICATE.
- MEMBERS NOTED G SHALL BE HOT DIP GALVANISED.

ALL BOLTS, NUTS AND WASHERS USED IN CONNECTION OF MEMBERS NOTED


Z OR G SHALL BE HOT DIP GALVANISED.

MAKE GOOD PROTECTIVE COATINGS AT SITE WELDS AND UNCOATED STEELWORK AT T.F. BOLTED JOINTS.

S8 STRUCTURAL STEELWORK BELOW GROUND SHALL BE CONCRETE ENCASED AND HAVE 75mm CONCRETE COVER, REINFORCED WITH GALVANISED F41 MESH WITH 40mm COVER, LAPPED 150mm AT SPLICES.

TIMBER FRAMING NOTES

- TF1 ALL DESIGN, WORKMANSHIP AND MATERIALS SHALL BE IN ACCORDANCE WITH AS 1684 AND AS 1720 CURRENT EDITION WITH AMENDMENTS, EXCEPT WHERE VARIED BY THE CONTRACT DOCUMENTS.
- TF2 TIMBER SIZES, WALL BRACING AND CONNECTION DETAILS WHERE NOT SHOWN ON
- TF3 ROOF BRACING AND ANCHOR DETAILS WHERE NOT SHOWN ON DRAWINGS SHALL BE IN ACCORDANCE WITH AS 1684.
- TF4 ALL TIMBER MEMBERS SUBJECT TO WEATHER EXPOSURE SHALL BE DURABILITY CLASS 1 IN ACCORDANCE WITH THE NSW TIMBER MARKETING ACT (1977) OR HAZARD LEVEL H3 FOR TREATED TIMBERS IN ACCORDANCE WITH AS1604.

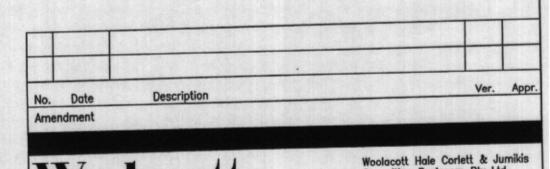

Woolacotts. Consulting Engineers

Woolacott Hale Corlett & Jumikis
Consulting Engineers Pty Ltd
A.C.N. 002 791 620
2A Broughton Rd.
Artarmon 2064.
Telephone (02) 9413 1399
Facsimile (02) 9413 1132
E-mail office@woolacotts.com.au

DETAILS NOTED

This drawing is Copyright and must not be used, reproduced or copied wholly or in part without written permission of Woolacott Hale Corlett & Jumikis Consulting Engineers Pty. Ltd. 'THE COTTAGE', GOVERNOR PHILLIP PARK

PALM BEACH FOR


C. & S. LEBENATUS M + BA ARCHITECTS PTY LTD

P.O. BOX 498 AVALON 2107 PH: 9918 5151

ROOF PLAN AND DETAILS

Approved	Verified	Prepared	Date	Scale
1/2/2/24	B.P. 14.7.04	D.G./D.Mc 14.7.04	JULY 2004	1:100, 20
Job rrumber			Drawing number	Amendment
04	+-47		S2	

FOR GENERAL AND MASONRY NOTES REFER TO DRG. No. S1.

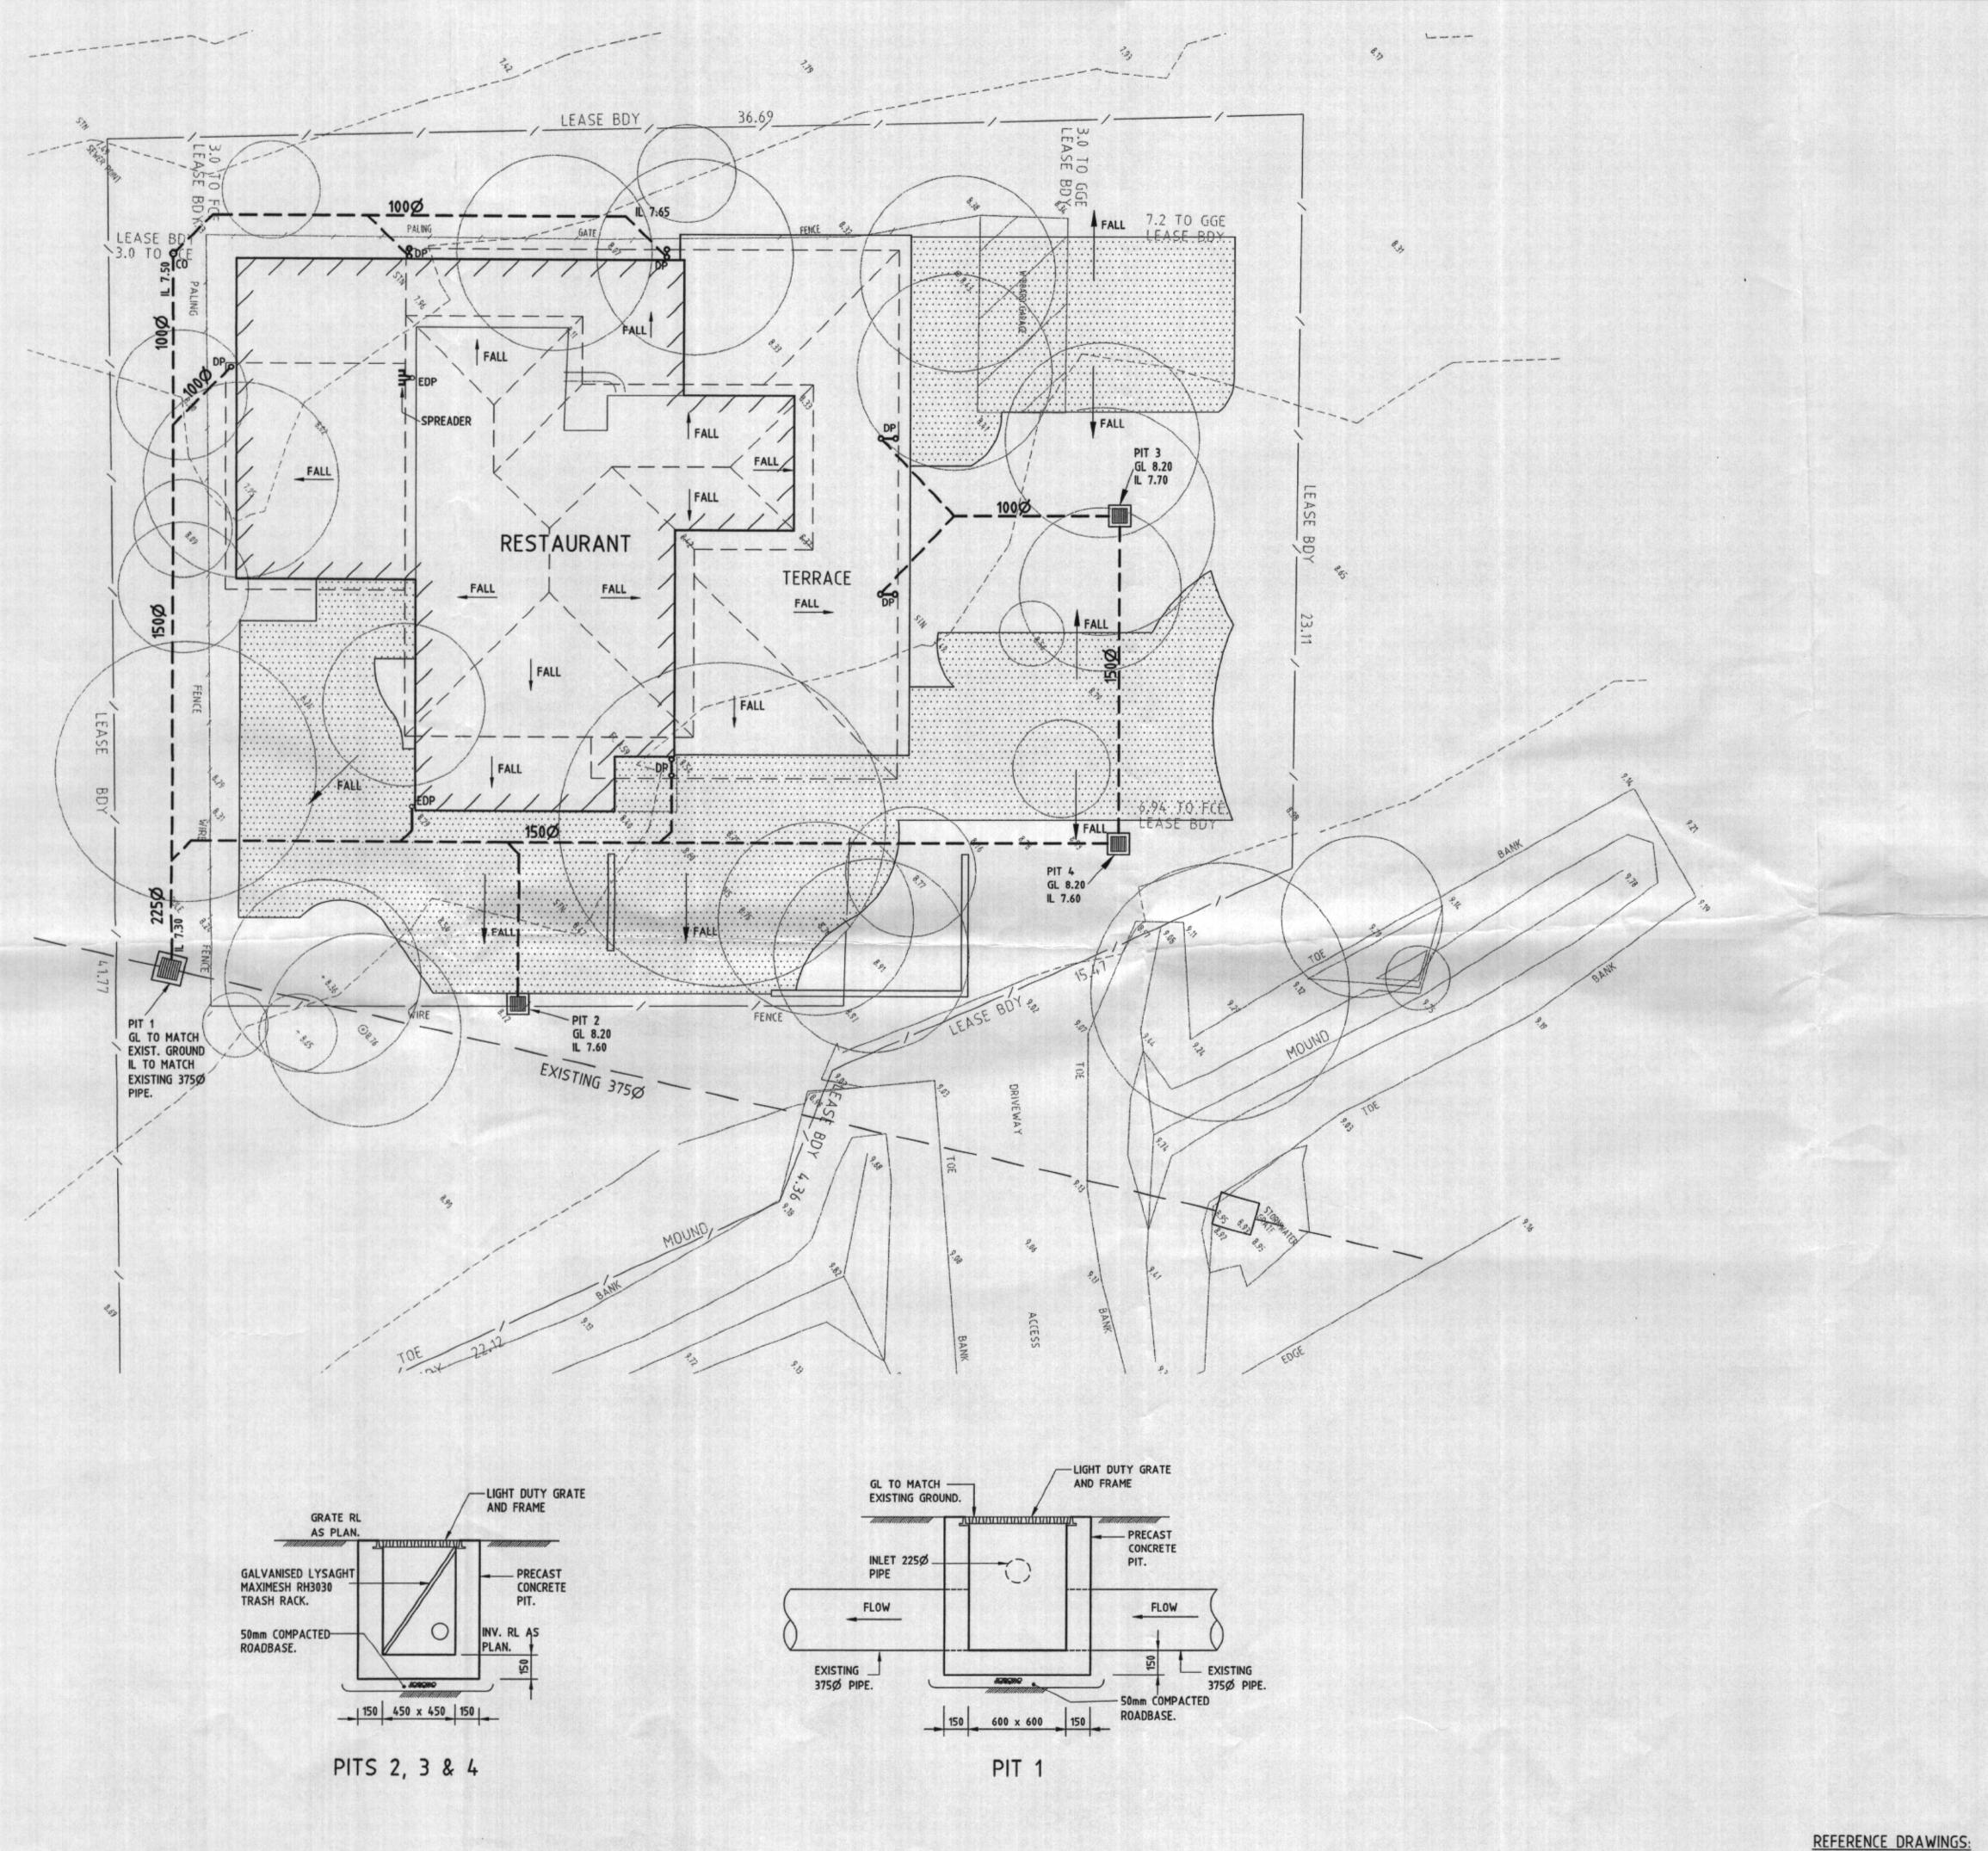

DRAINAGE NOTES

D1 ALL WORKS GENERALLY SHALL BE IN ACCORDANCE WITH AS 3500.3.2


- D2 FOR PIPE DIAMETERS NOT EXCEEDING 150mm, USE:
- VITRIFIED CLAY PIPE TO AS 1742 - SEWER GRADE UPVC TO AS 1260 OR - CLASS 2 FIBRE REINFORCED CONCRETE TO AS 4139
- D3 PVC PIPES SHALL BE SOLVENT WELDED. ALL OTHER PIPES SHALL BE RUBBER RING JOINTED UNLESS NOTED OTHERWISE.
- D4 UNLESS SPECIFIED OTHERWISE, BED & BACKFILL SHALL BE COMPACTED SAND TO 100mm PLUS ONE THIRD PIPE DIAMETER ABOVE THE PIPE. REMAINDER OF BACKFILL SHALL BE COMPACTED EXCAVATED MATERIAL. WHEN UNDER VEHICULAR PAVEMENT, REMAINDER OF BACKFILL SHALL BE COMPACTED BASECOURSE.
- D5 LOADS ON PIPES DURING CONSTRUCTION SHALL NOT EXCEED THE REQUIREMENT OF AS 3725, OR THE RECOMMENDATIONS OF THE PIPE MANUFACTURER.
- D6 TRENCH WIDTHS SHALL BE IN ACCORDANCE WITH AS 3500, BUT NOMINALLY THE GREATER OF 1.5 PIPE DIAMETER OR PIPE DIAMETER PLUS 300.


EROSION CONTROL NOTES

- E1 INSTALL SILT FENCES ON LOW SIDE OF SITE AND AS REQUIRED BY LOCAL COUNCIL PRIOR TO COMMENCEMENT OF TOPSOIL STRIPPING.
- E2 INSTALL DRAINAGE SYSTEM AND SILT FENCES AROUND PITS AS SOON AS PRACTICABLE.
- E3 REINSTATE GRASS COVER AS SOON AS PRACTICABLE.

LEGEND:

	PAVING TO LANDSCA ARCHITECTS DETAILS
	STORMWATER PIPE
•DP	DOWNPIPE
o EDP	EXISTING DOWNPIPE
000	CLEAR OUT
L	INVERT LEVEL
GL	GRATE LEVEL

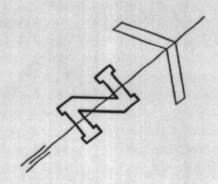

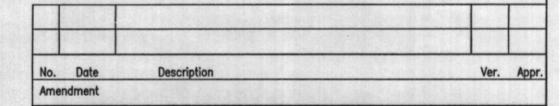

Woolacotts.

Consulting Engineers

Woolacott Hale Corlett & Jumiki Consulting Engineers Pty Ltd A.C.N. 002 791 620 2A Broughton Rd. Artarmon 2064. Telephone (02) 9413 1399 Facsimile (02) 9413 1132 E-mail office@woolacotts.com

This drawing is Copyright and must not be used, reproduced or copied wholly or in part without written permission of Woolacott Hale Corlett & Jumikis Consulting Engineers Pty. Ltd.

Project

'THE COTTAGE', GOVERNOR PHILLIP PARK PALM BEACH FOR

C. & S. LEBENATUS

Architect
M + BA ARCHITECTS PTY LTD
P.O. BOX 498 AVALON 2107
PH: 9918 5151



STORMWATER MANAGEMENT PLAN AND DETAILS

Approved Verified Prepared Date Scale

23/7/04 23.7.04 23/5/64: JULY 2004 1:100, 20

Job number Drawing number Amendment

04-47

REFERENCE DRAWINGS:
FOR GENERAL NOTES REFER TO DRG. No. S1