



PROPOSED STREET VIEW; SECOND STOREY ADDITION BEHIND EXISTING ESTABLISHED GUM TREE



EXISTING STREET VIEW; EXISTING RESIDENCE BEHIND ESTABLISHED GUM TREE



This drawing is the copyright of Donna Barnes Designs and not be altered, reproduced or transmitted in any form or by any means in part or in whole with the written permission of Donna Barnes Designs.

All levels and dimensions are to be checked and verified on site prior to commencement of any

work, making of shop drawings or fabrication of components.

Do no scale on drawings. Use figured dimensions.

All workmanship & materials shall be in accordance with the requirements of current editions

including amendmnets of the SAA Codes of Practice, the Building Code of Australia, any AS standards and the current 2019 NCC and local council requirements.

Concrete footings, slab, structural beams or any other structural members are to be designed by a practicing engineer.

LEGEND

NEW FLOOR AREA NEW WET FLOOR AREA METAL ROOFING TILED ROOFING TIMBER

CONCRETE METAL **EXISTING**

BRICKWORK

DEMOLISHED

Mr and Mrs Ford

CLIENT

PROJECT ADDRESS 203 Balgowlah Road Balgowlah NSW 2093 DRAWING NO.

DA01


December 2019


DATE

DRAWING NAME SITE ANALYSIS PLAN

SCALE 1:200, 1:2.73 @A3



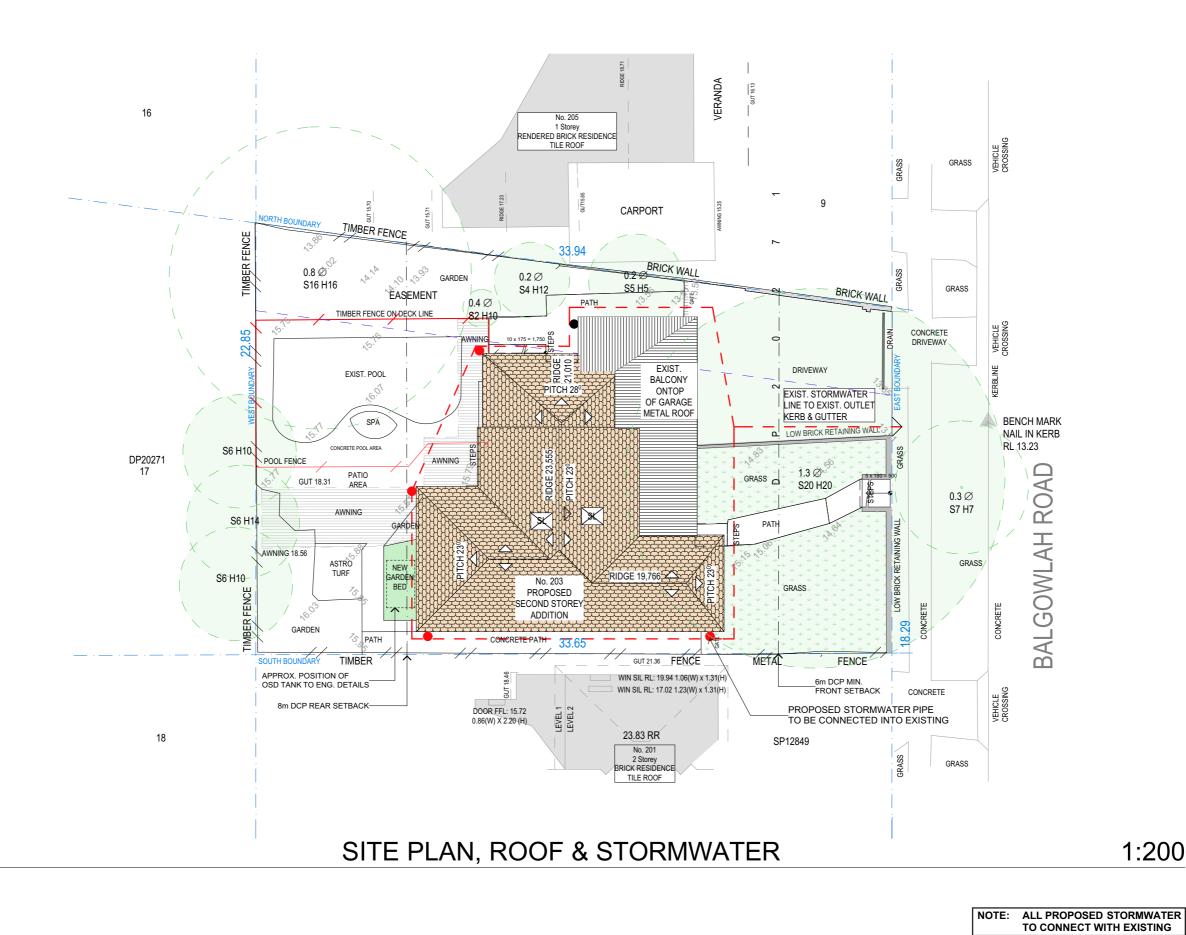

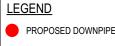

PROPOSED DOWNPIPE EXISTING DOWNPIPE

NOTES

This drawing is the copyright of Donna Barnes Designs and not be altered, reproduced o transmitted in any form or by any means in part or in whole with the written permission of

Donna Barnes Designs.
All levels and dimensions are to be checked and verified on site prior to com work, making of shop drawings or fabrication of components. Do no scale on drawings. Use figured dimensions.

All workmanship & materials shall be in accordance with the requirements of current editions including amendmnets of the SAA Codes of Practice, the Building Code of Australia, any AS standards and the current 2019 NCC and local council requirements.

Concrete footings, slab, structural beams or any other structural members are to be designed by a practicing engineer.



CONCRETE **BRICKWORK** METAL **EXISTING**

DEMOLISHED

CLIENT

Mr and Mrs Ford

PROJECT ADDRESS 203 Balgowlah Road Balgowlah NSW 2093 DRAWING NO.

DA02

December 2019

DATE

SITE, ROOF & STORMWATER PLAN

1:200


DRAWING NAME

SCALE 1:200 @A3

m: 0434 551 654 e: DonnaBDesigns@outlook.com ABN: 24 628 502 321

donna barnes

DESIGNS

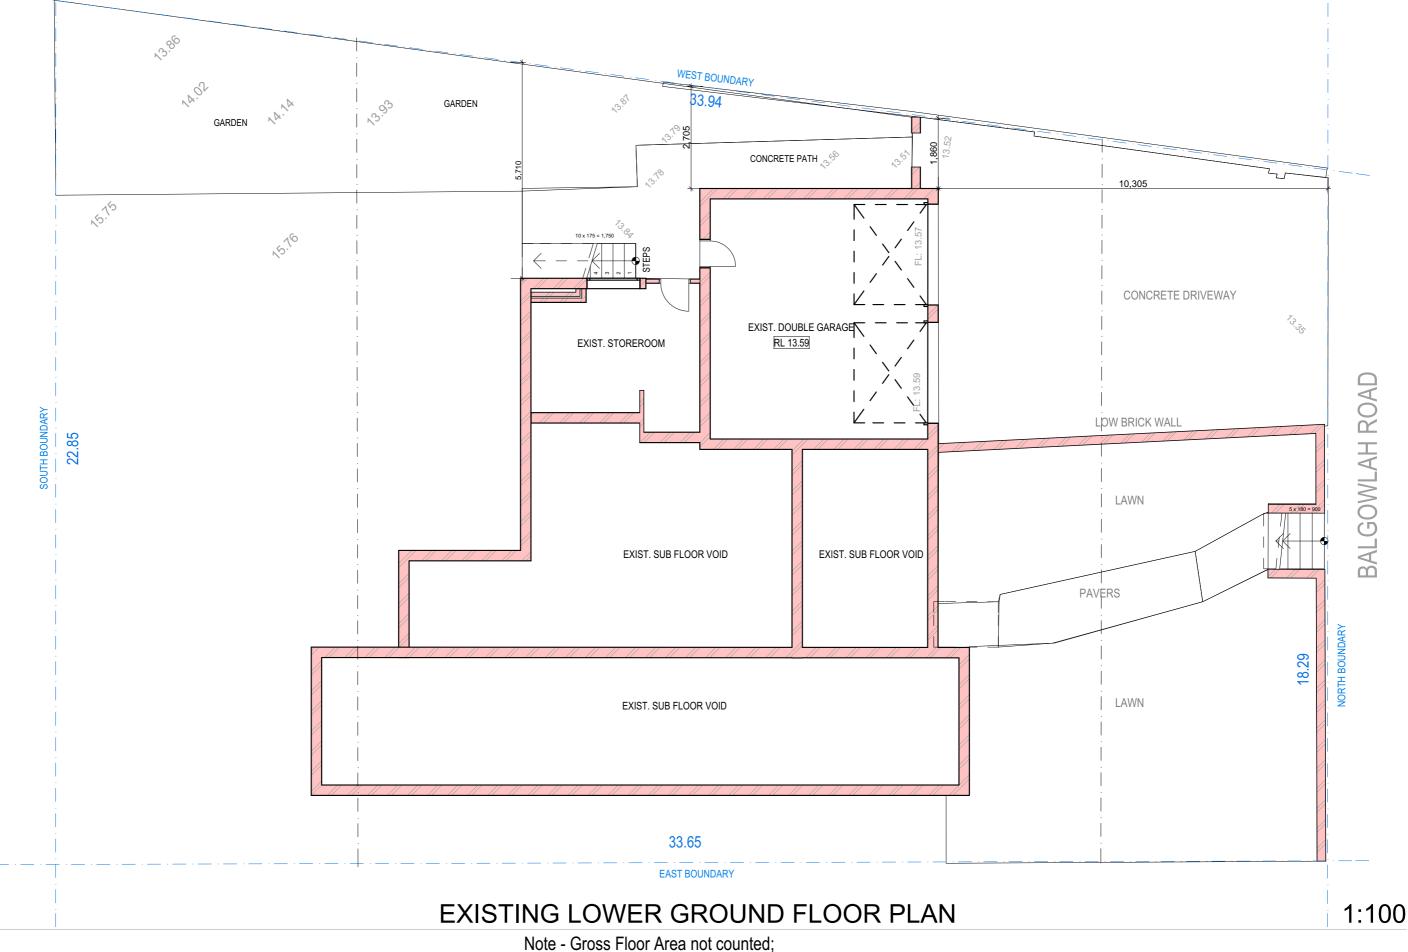

garage and storage areas excluded from calculation



NOTES

This drawing is the copyright of Donna Barnes Designs and not be altered, reproduced or transmitted in any form or by any means in part or in whole with the written permission of Donna Barnes Designs.

All levels and dimensions are to be checked and verified on site prior to commencement of any

work, making of shop drawings or fabrication of components.

Do no scale on drawings. Use figured dimensions.

All workmanship & materials shall be in accordance with the requirements of current editions including amendmnets of the SAA Codes of Practice, the Building Code of Australia, any AS standards and the current 2019 NCC and local council requirements.

Concrete footings, slab, structural beams or any other structural members are to be designed by a practicing engineer.



CLIENT Mr and Mrs Ford

PROJECT ADDRESS

203 Balgowlah Road

Balgowlah NSW 2093


DRAWING NO. **DA03**

DATE

December 2019

DRAWING NAME **EXISTING LOWER GROUND** FLOOR PLAN

SCALE 1:100 @A3

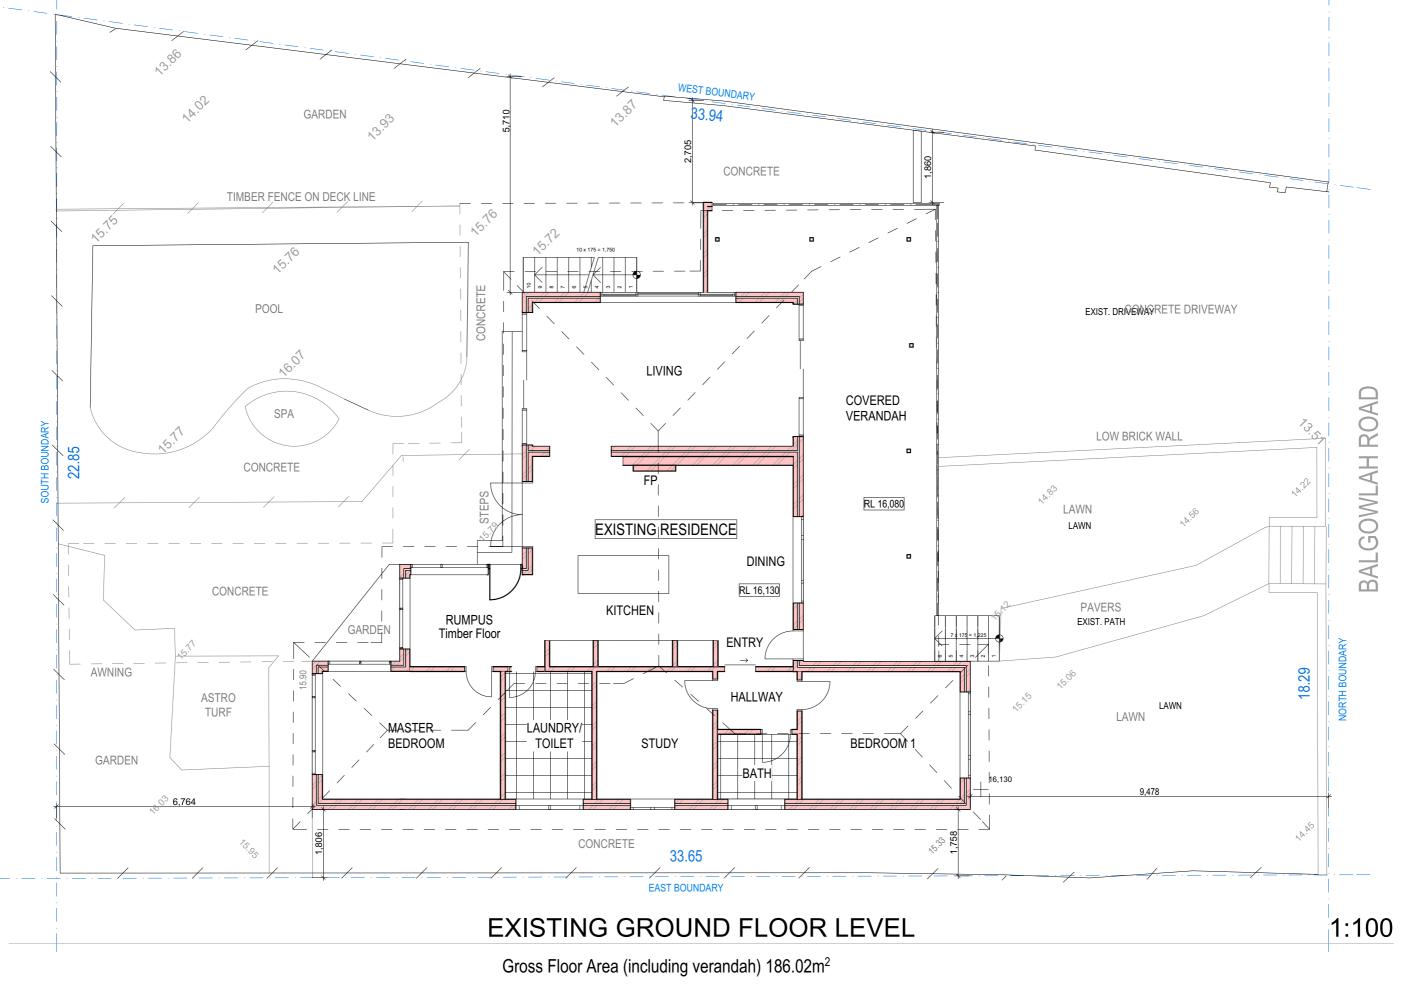



This drawing is the copyright of Donna Barnes Designs and not be altered, reproduced or transmitted in any form or by any means in part or in whole with the written permission of Donna Barnes Designs.

All levels and dimensions are to be checked and verified on site prior to commencement of any

All levels and dimensions are to be checked and verified on site prior to commencement of an work, making of shop drawings or fabrication of components.

Do no scale on drawings. Use figured dimensions.

All workmanship & materials shall be in accordance with the requirements of current editions including amendmnets of the SAA Codes of Practice, the Building Code of Australia, any AS standards and the current 2019 NCC and local council requirements.

Concrete footings, slab, structural beams or any other structural members are to be designed by a practicing engineer.



CLIENTMr and Mrs Ford

PROJECT ADDRESS 203 Balgowlah Road

Balgowlah NSW 2093

DA04

December 2019

DATE

EXISTING GROUND FLOOR PLAN

DRAWING NAME

SCALE 1:100 @A3



This drawing is the copyright of Donna Barnes Designs and not be altered, reproduced or transmitted in any form or by any means in part or in whole with the written permission of Donna Barnes Designs.

All levels and dimensions are to be checked and verified on site prior to co

work, making of shop drawings or fabrication of components.

Do no scale on drawings. Use figured dimensions.

All workmanship & materials shall be in accordance with the requirements of current editions

including amendmnets of the SAA Codes of Practice, the Building Code of Australia, any AS standards and the current 2019 NCC and local council requirements.

Concrete footings, slab, structural beams or any other structural members are to be designed by a practicing engineer.



DEMOLITION GROUND FLOOR PLAN

CLIENT Mr and Mrs Ford

PROJECT ADDRESS 203 Balgowlah Road Balgowlah NSW 2093 DRAWING NO.

DA05


DATE December 2019 **DEMOLITION PLAN**

SCALE

1:100 @A3

DRAWING NAME

1:100

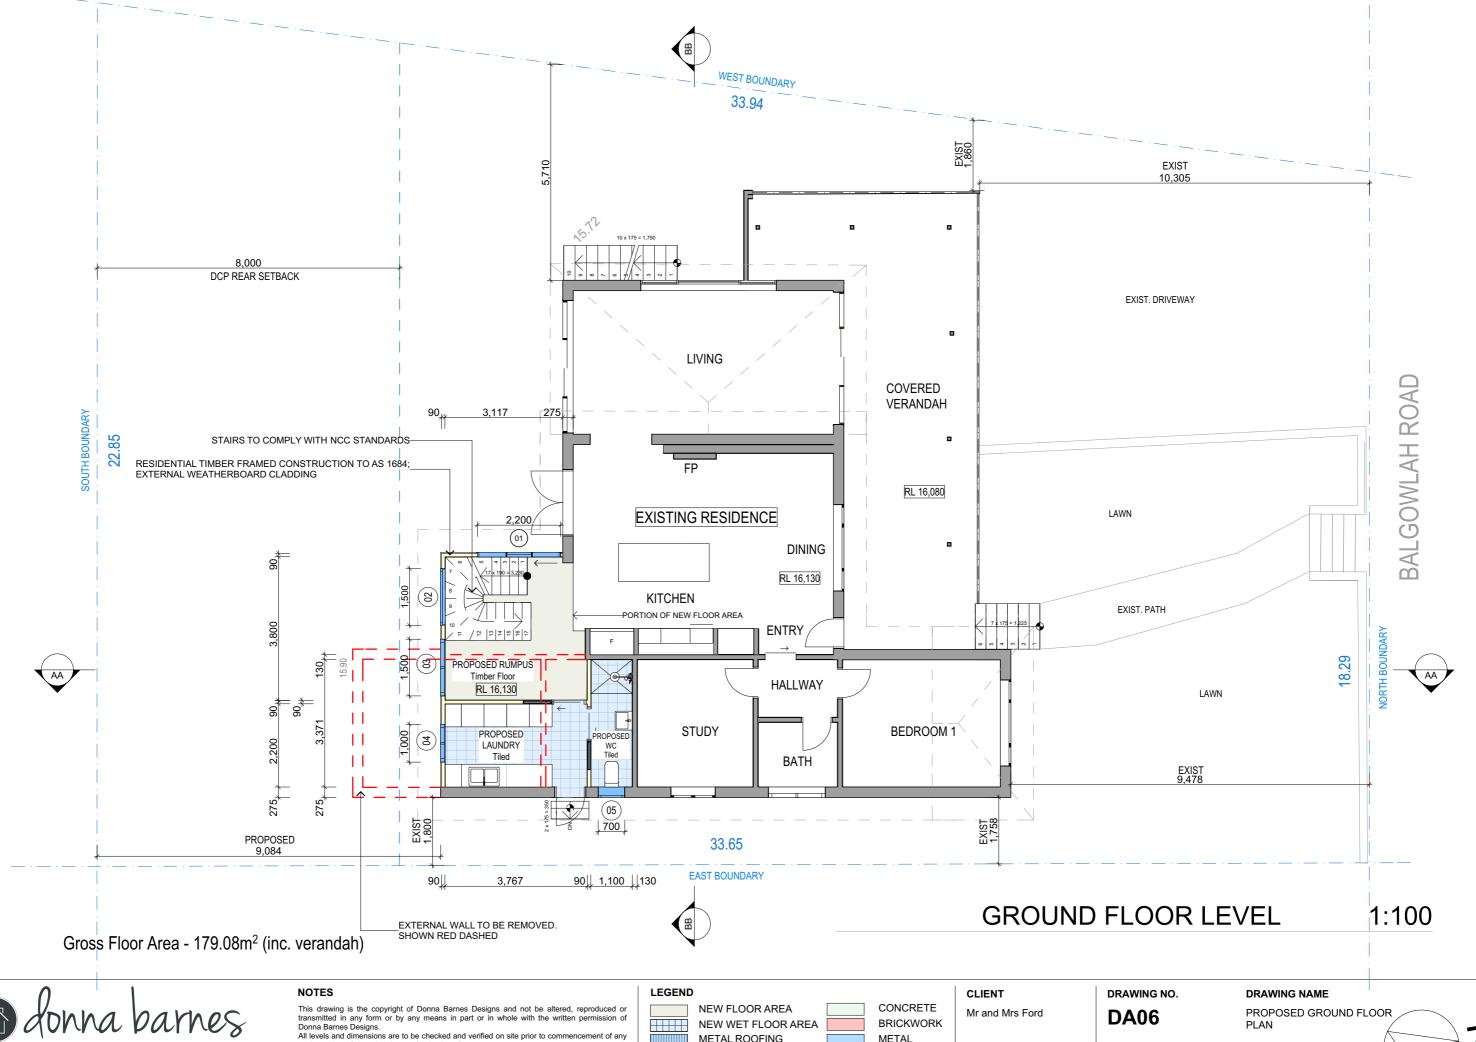



work, making of shop drawings or fabrication of components. Do no scale on drawings. Use figured dimensions.

All workmanship & materials shall be in accordance with the requirements of current editions including amendmnets of the SAA Codes of Practice, the Building Code of Australia, any AS standards and the current 2019 NCC and local council requirements.

Concrete footings, slab, structural beams or any other structural members are to be designed by a practicing engineer.

METAL ROOFING TILED ROOFING

TIMBER

METAL **EXISTING**


DEMOLISHED

PROJECT ADDRESS 203 Balgowlah Road Balgowlah NSW 2093 DATE

December 2019

SCALE

1:100 @A3

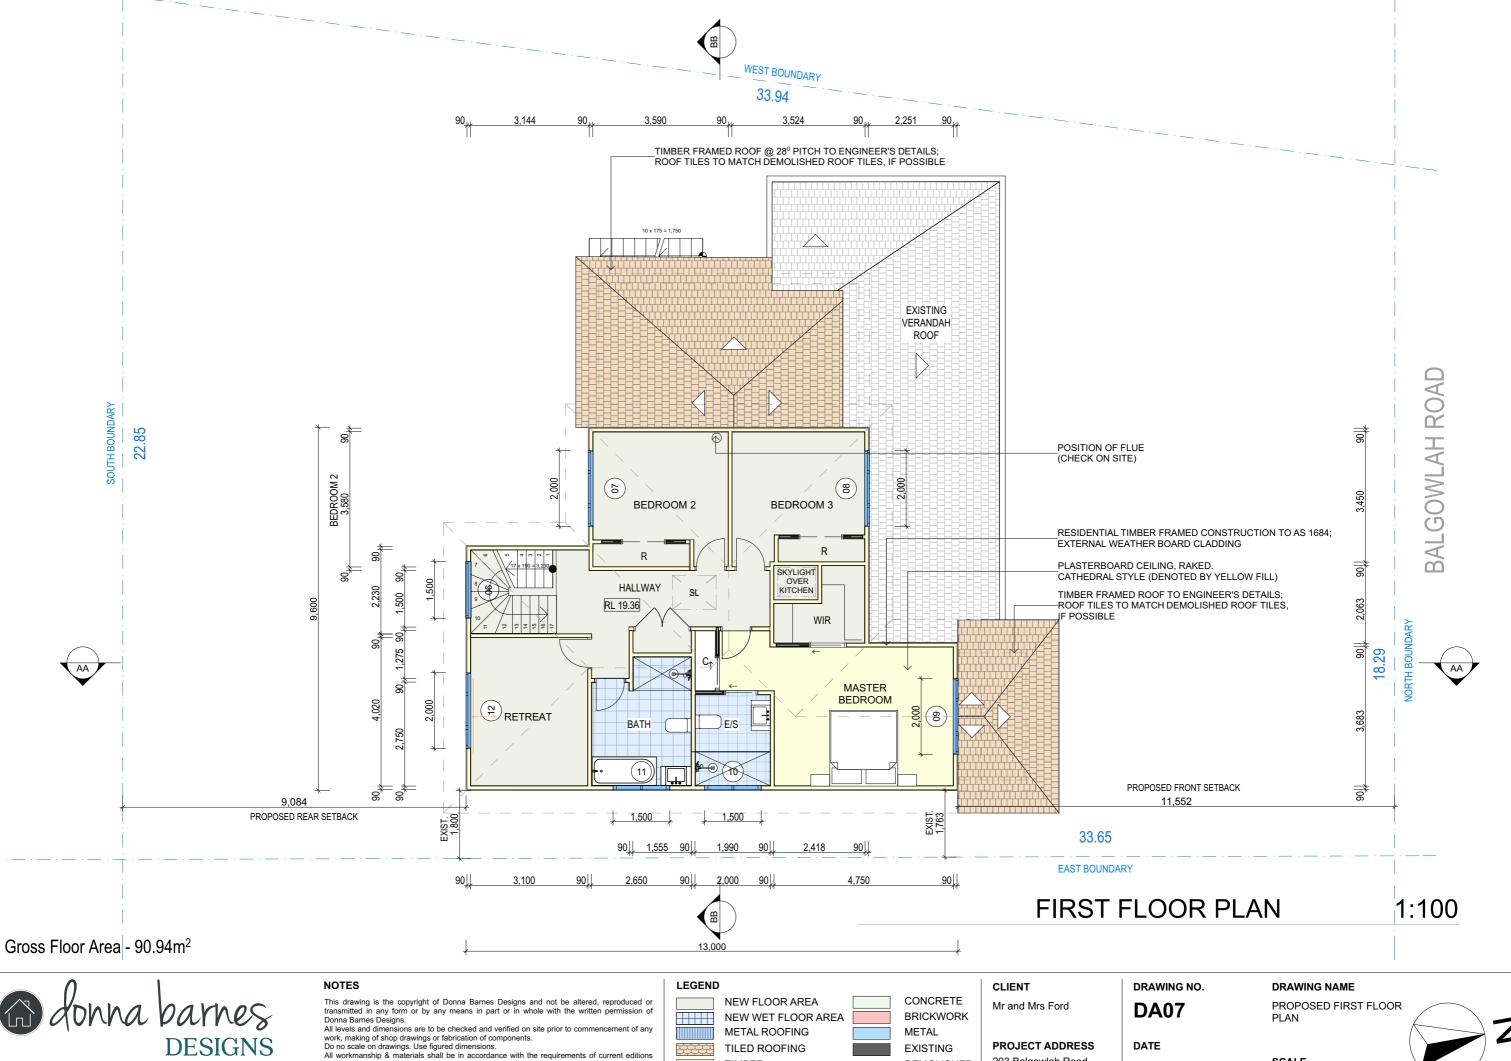



including amendmnets of the SAA Codes of Practice, the Building Code of Australia, any AS standards and the current 2019 NCC and local council requirements.

Concrete footings, slab, structural beams or any other structural members are to be designed by a practicing engineer.

TILED ROOFING

TIMBER


EXISTING DEMOLISHED

203 Balgowlah Road

Balgowlah NSW 2093

December 2019

SCALE 1:100 @A3

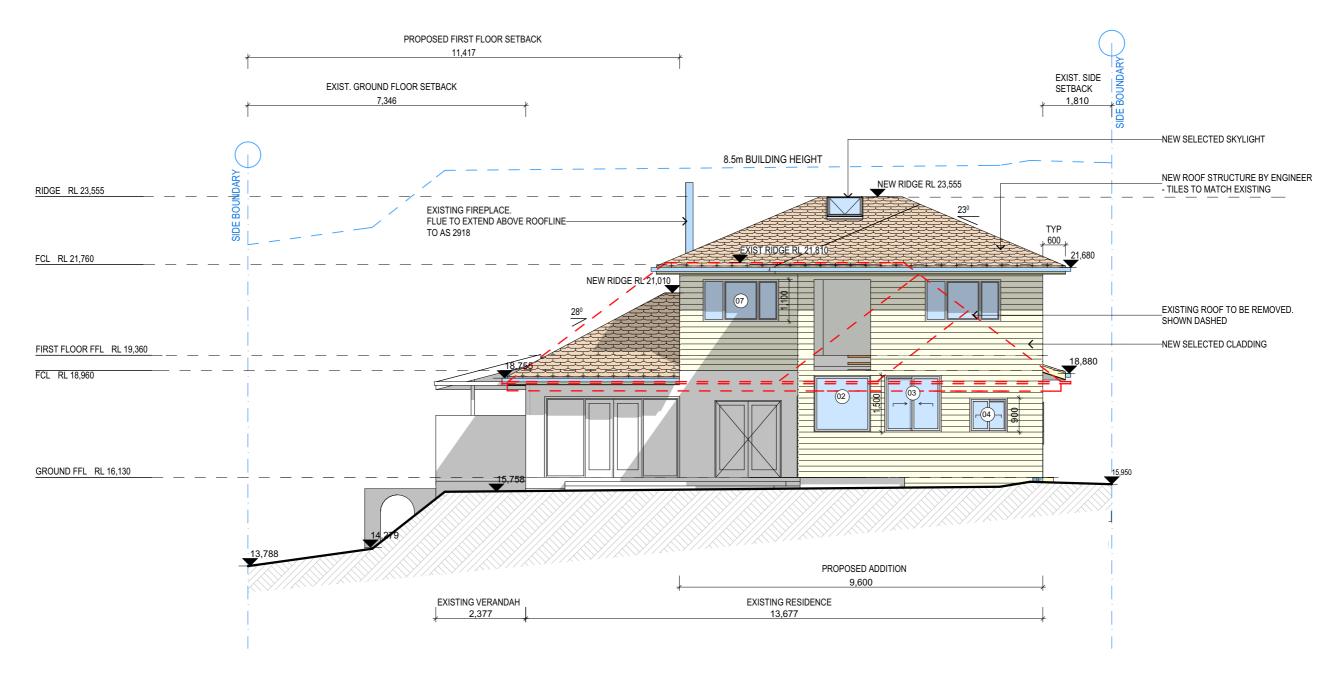

SOUTH ELEVATION

1:100



NOTES

This drawing is the copyright of Donna Barnes Designs and not be altered, reproduced or transmitted in any form or by any means in part or in whole with the written permission of Donna Barnes Designs.

All levels and dimensions are to be checked and verified on site prior to commencement of any

All levels and dimensions are to be checked and verified on site prior to commencement of any work, making of shop drawings or fabrication of components.

Do no scale on drawings. Use figured dimensions.

All workmanship & materials shall be in accordance with the requirements of current editions

All workmanship & materials shall be in accordance with the requirements of current editions including amendmnets of the SAA Codes of Practice, the Building Code of Australia, any AS standards and the current 2019 NCC and local council requirements.

Concrete footings, slab, structural beams or any other structural members are to be designed by a practicing engineer.

TIMBER
WEATHERBOARD
FACE BRICKWORK
METAL
CONCRETE

METAL ROOFING
TILED ROOFING
RENDER
EXISTING

Mr and Mrs Ford

PROJECT ADDRESS

203 Balgowlah Road

Balgowlah NSW 2093

DA08


DRAWING NO.

DRAWING NAME ELEVATIONS

1:100 @A3

DATE

December 2019 SCALE

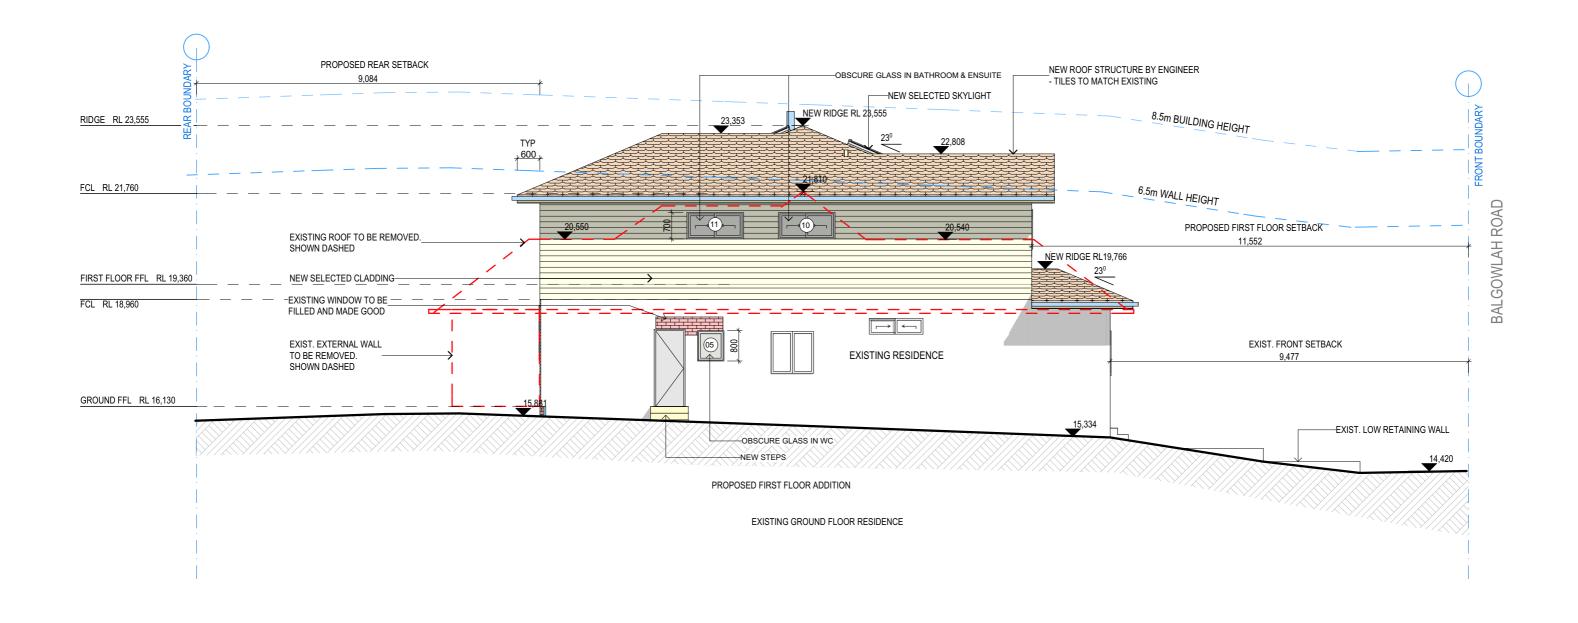

EAST ELEVATION

1:100



NOTES

This drawing is the copyright of Donna Barnes Designs and not be altered, reproduced or transmitted in any form or by any means in part or in whole with the written permission of Donna Barnes Designs.

All levels and dimensions are to be checked and verified on site prior to con

work, making of shop drawings or fabrication of components.

Do no scale on drawings. Use figured dimensions.

All workmanship & materials shall be in accordance with the requirements of current editions

including amendmnets of the SAA Codes of Practice, the Building Code of Australia, any AS standards and the current 2019 NCC and local council requirements.

Concrete footings, slab, structural beams or any other structural members are to be designed by a practicing engineer.

DRAWING NO. **CLIENT** Mr and Mrs Ford

PROJECT ADDRESS

203 Balgowlah Road


Balgowlah NSW 2093

DA09

DRAWING NAME **ELEVATIONS**

DATE

SCALE December 2019 1:100 @A3

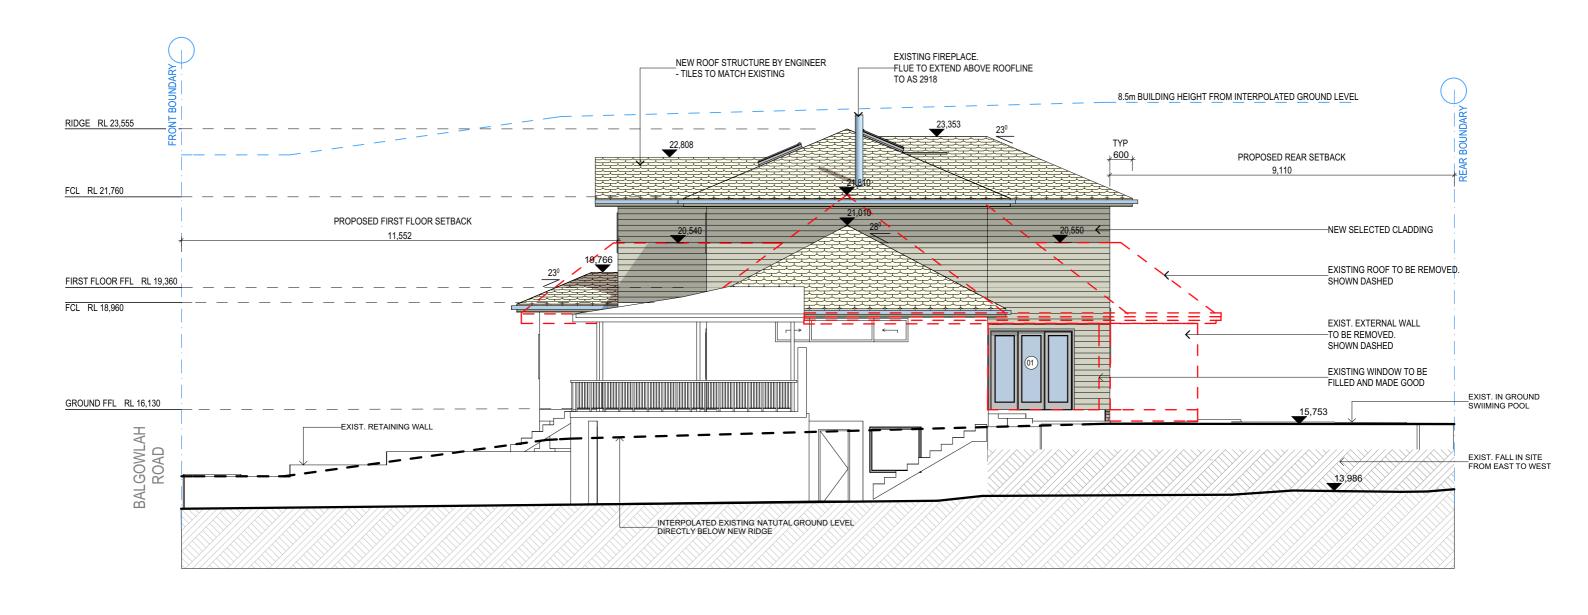

WEST ELEVATION

1:100



NOTES

This drawing is the copyright of Donna Barnes Designs and not be altered, reproduced or transmitted in any form or by any means in part or in whole with the written permission of Donna Barnes Designs.

All levels and dimensions are to be checked and verified on site prior to commencement of any

All levels and dimensions are to be checked and verified on site prior to commencement of any work, making of shop drawings or fabrication of components.

Do no scale on drawings. Use figured dimensions.

All workmanship & materials shall be in accordance with the requirements of current editions

All workmanship & materials shall be in accordance with the requirements of current editions including amendments of the SAA Codes of Practice, the Building Code of Australia, any AS standards and the current 2019 NCC and local council requirements.

Concrete footings, slab, structural beams or any other structural members are to be designed by a practicing engineer.

TIMBER
WEATHERBOARD
FACE BRICKWORK
METAL
CONCRETE

CLIENT
Mr and Mrs Ford
PROJECT ADDRESS

203 Balgowlah Road

Balgowlah NSW 2093

METAL ROOFING

TILED ROOFING

RENDER

EXISTING

DA10


DRAWING NAME ELEVATIONS

SCALE

1:100 @A3

DATE

December 2019

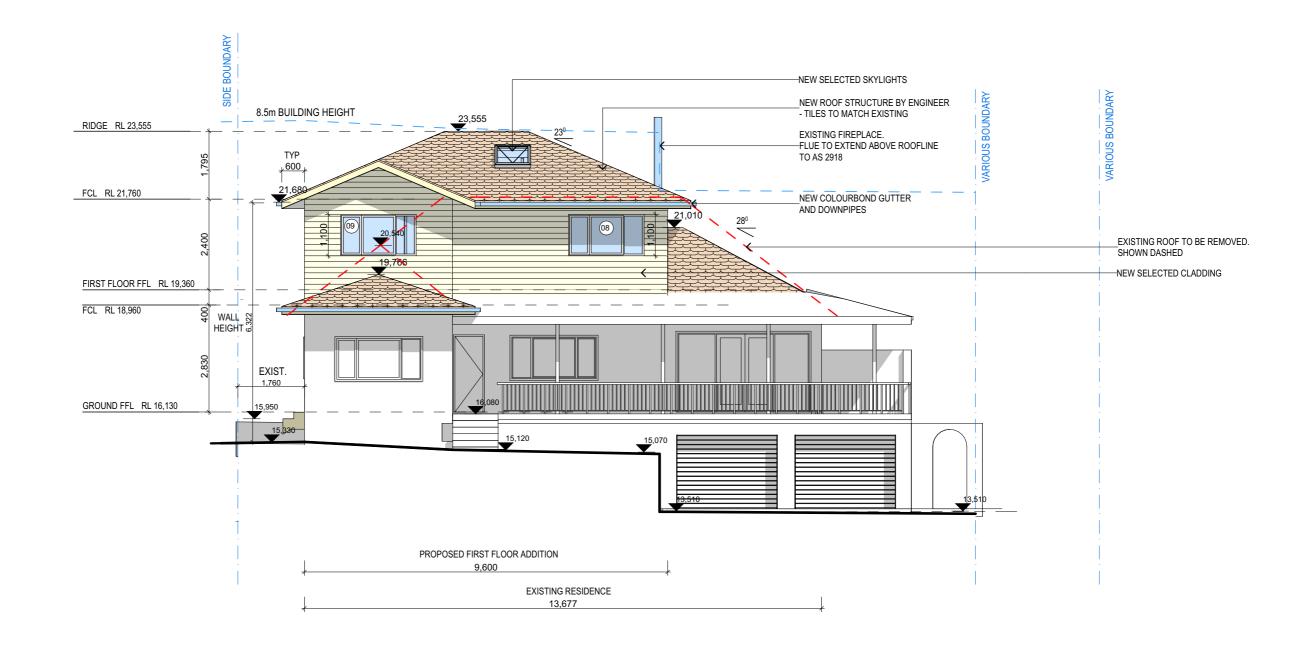

NORTH ELEVATION

1:100



NOTES

This drawing is the copyright of Donna Barnes Designs and not be altered, reproduced or transmitted in any form or by any means in part or in whole with the written permission of Donna Barnes Designs.

All levels and dimensions are to be checked and verified on site prior to commencement of any

work, making of shop drawings or fabrication of components.

Do no scale on drawings. Use figured dimensions.

All workmanship & materials shall be in accordance with the requirements of current editions

including amendmnets of the SAA Codes of Practice, the Building Code of Australia, any AS standards and the current 2019 NCC and local council requirements. Concrete footings, slab, structural beams or any other structural members are to be designed by a practicing engineer.

METAL CONCRETE

LEGEND METAL ROOFING TIMBER TILED ROOFING WEATHERBOARD FACE BRICKWORK RENDER **EXISTING**

CLIENT Mr and Mrs Ford

203 Balgowlah Road

Balgowlah NSW 2093


DA11 PROJECT ADDRESS DATE

DRAWING NAME **ELEVATIONS**

1:100 @A3

SCALE

DRAWING NO.

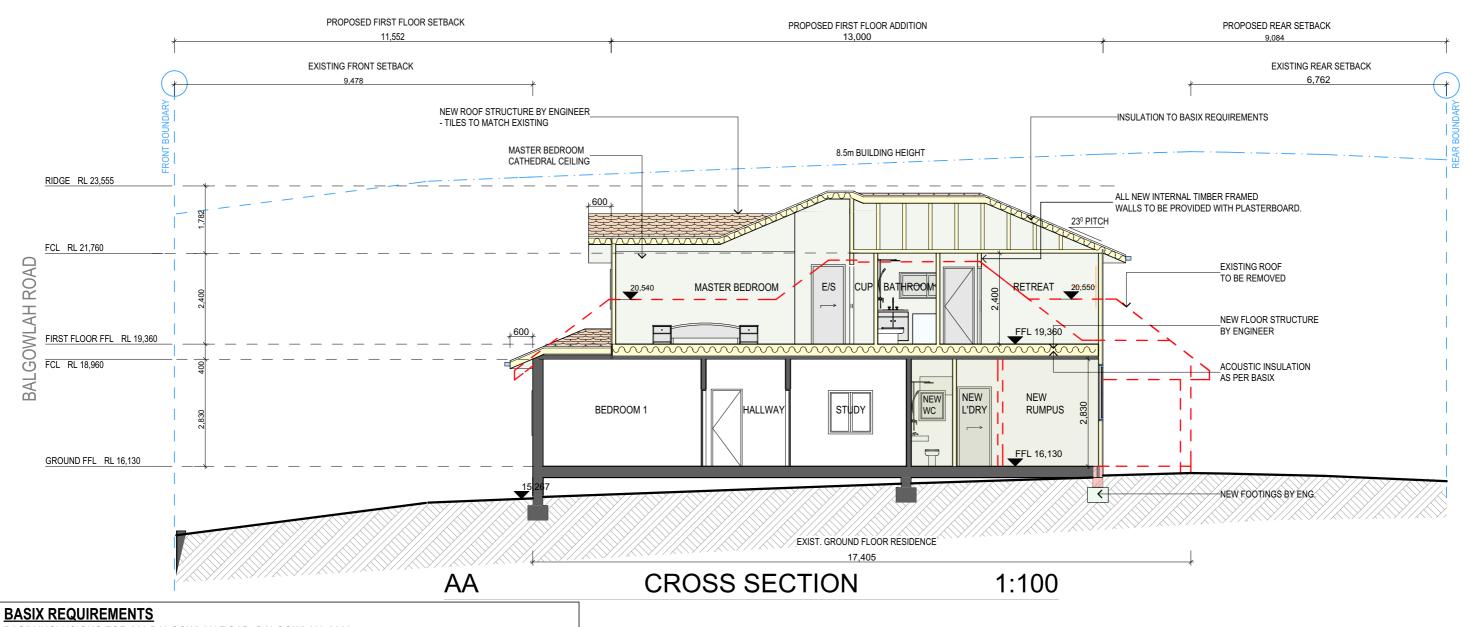

BASIX INCLUSIONS FOR 203 BALGOWLAH ROAD, BALGOWLAH, 2093

40% OF NEW OR ALTERED LIGHT FIXTURES TO BE FITTED WITH FLUORESCENT, COMPACT FLUORESCENT, OR LIGHT-EMITTING-DIODE (LED) LAMPS

D1

SHOWER: MINIMUM 3 STARS

TOLIET: MINIMUM 3 STARS

TAPS: MINIMUM 3 STARS

CONSTRUCTION

INSULATION REQUIREMENTS

FLOOR ABOVE EXISTING DWELLING OR BUILDING

EXTERNAL WALL; FRAMED (WEATHERBOARD, FIBRO, METAL CLAD)

FLAT CEILING, PITCHED ROOF

RAKED CEILING, PITCHED/SKILLION ROOF; FRAMED

GLAZING DOORS/ WINDOWS

TIMBER or uPVC, SINGLE CLEAR, (OR U-VALUE 5.71, SHGC: 0.66) W2, W3, W4, W5, W6, W7, W8, W9, W10, W11, W12

IMPROVED ALUMINIUM, SINGLE PYROLYTIC LOW e, (U-VALUE: 4.48, SHGC: 0.46)

EXTERNAL WALLS

- LIGHTWEIGHT FRAME WALLS FINISHED OFF WITH SELECTED CLADDING

SPECIFICATION NOTES

- ALUMINIUM & TIMBER FRAMED WINDOWS AND DOORS

- WEATHER STRIPPING IS TO BE PROVIDED TO ALL EXTERNAL WINDOWS AND DOORS

-REINFORCED CONCRETE SLAB ON GROUND TO GROUND FLOOR

-TIMBER FLOOR FRAMING TO BE FINISHED WITH T&G HARDWOOD FLOORING TO GROUND & FIRST FLOOR

- TILES ON COMPRESSED F.C & WATERPROOF MEMBRANE TO ALL WET AREAS.

- SELECTED TILES

BATHROOM/LAUNDRY/ENSUITE

-ALL WATERPROOFING TO AS 3740

LEGEND

-PROVIDE A GUARANTEED FLEXIBLE WATERPROOF MEMBRANE TO ALL WET AREA FLOORS & SHOWER WALLS TO MANUFACTURES INSTRUCTIONS

STORMWATER

-NEW DOWNPIPES TO BE CONNECTED INTO EXISTING STORMWATER

TERMITE CONTOL TO AS 3660.1

GUTTERS & DOWNPIPES

- COLOURBOND GUTTER & DOWNPIPES

MINIMUM SLOPE OF EAVES AND GUTTERS 1:200

FLASHING & CAPPING
- SELECTION AND INSTALLATION OF METAL RAINWATER GOODS
REFER TO AS 2180

-FLASH PROJECTIONS ABOVE THE ROOF WITH TWO PART FLASHINGS CONSITING OF AN APRON FLASHING & OVER FLASHING, WITH AT LEAST 100mm OVFRLAP

-PROVIDE FOR INDEPENDANT MOVEMENT BETWEEN ROOF AND PROJECTION.

- USE TREATED TIMBER WHERE REQUIRED FOR DURABILITY

- DO NOT USE TIMBER UNSUITABLE FOR EXPOSURE TO MOISTURE IN EXPOSED LOCATION.

-ALL WORKMANSHIP AND MATERIALS SHALL BE IN ACCORDANCE WITH AS 1684 AND 1720 AS APPLICABLE

- PROVIDE STRUCTURE BRACING AS PER AS 1684
- PROVIDE STRUCTURE TIEDOWN AS PER AS 1684
- USE GALVANISED FIXING WHERE EXPOSED TO WEATHER

CONCRETE

- FOOTINGS AS PER AS 1480.

- ALL REINFORCEMENTS SHALL CONFORM TO AS 1302, AS 1303, AS 1304

INTERNAL LINING

-PROVIDE PLASTERBOARD LINING

- DRESSED & SEASONED PINE TREADS

- BALUSTRADE 1m HIGH TO NCC

SMOKE DETECTORS/ALARMS

- NCC VOL 2 PART 3.7.2, FIRE/SMOKE DETECORS COMPLYING WITH THE REQUIREMENTS OF THE LOCAL GOVERNMENT ACT AND/OR STATE OR TERRITORY REGULATIONS MUST BE FITTED IN THE LOCATIONS REQUIRED AND APPROVED BY THE AUTHORITY AND SHALL BE INSTALLED IN ACCORDANCE WITH AS3786-2014.

WASTE MANAGEMENT

- ALL WASTE SHALL BE TAKEN AWAY BY TRUCKS TO A SUITABLE LANDFILL OR RECYCLE DEPOT.

-ALL WASTE SHALL BE COVERED DURING TRANSPORATION - WASTE GENERATED DURING CONSTRUCTION SHALL BE PLACED IN STEEL BINS AND TAKEN AWAY BY AN APPROVED LANDFILL SITE

SEDIMENT CONTOL

- A FILTER CLOTH SYSTEM SHALL BE INSTALLED TO STOP ANY SEDIMENT ENTERING COUNCIL'S STORMWATER SYSTEM

ADDITIONS AND ALTERATIONS ARE TO BE READ IN CONJUCTION

AND COMPLY WITH THE BASIX CERTIFICATE



S1, S2

This drawing is the copyright of Donna Barnes Designs and not be altered, reproduced of transmitted in any form or by any means in part or in whole with the written permission of

ADDITIONAL INSULATION REQUIREMENTS (R-VALUE)

R1.30 (OR R1.70 INCLUDING CONSTRUCTION)

(OR U-VALUE: 2.5, SHGC: 0.456)

CEILING; R1.45 (UP), ROOF; FOIL BLANKET (55mm)

CEILING; R1.74 (UP), ROOF, FOIL BACKED BLANKET (55mm)

TIMBER, LOW-e INTERNAL/ARGON FILL/ CLEAR EXTERNAL

All levels and dimensions are to be checked and verified on site prior to commencement of any work, making of shop drawings or fabrication of components. Do no scale on drawings. Use figured dimensions.

All workmanship & materials shall be in accordance with the requirements of current editions including amendmnets of the SAA Codes of Practice, the Building Code of Australia, any AS standards and the current 2019 NCC and local council requirements. Concrete footings, slab, structural beams or any other structural members are to be designed by a practicing engineer.

TIMBER WEATHERBOARD FACE BRICKWORK METAL CONCRETE

METAL ROOFING TILED ROOFING RENDER **EXISTING**

CLIENT

PROJECT ADDRESS 203 Balgowlah Road Balgowlah NSW 2093

Mr and Mrs Ford

DATE

December 2019

DRAWING NO.

DA12


DRAWING NAME

CROSS SECTION

SCALE

1:100 @A3

m: 0434 551 654 e: DonnaBDesigns@outlook.com ABN: 24 628 502 321

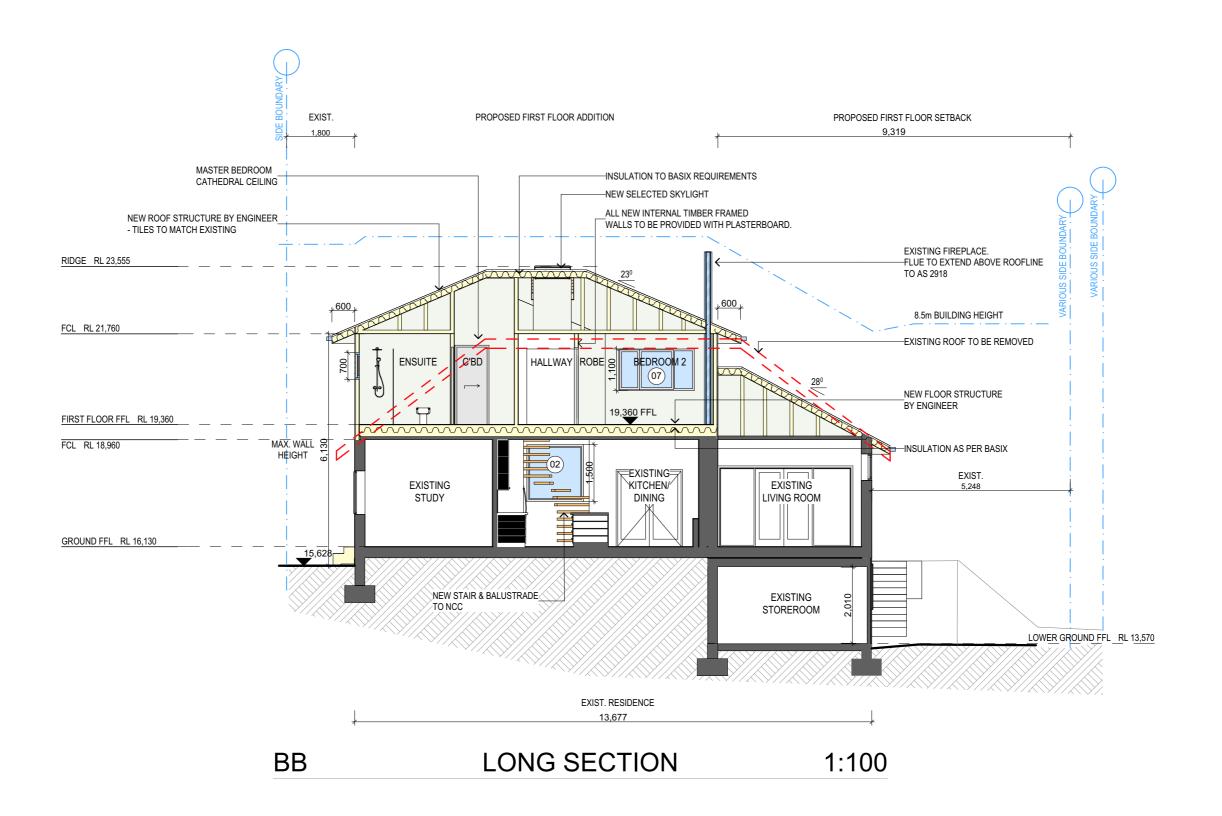



This drawing is the copyright of Donna Barnes Designs and not be altered, reproduced or transmitted in any form or by any means in part or in whole with the written permission of Donna Barnes Designs.

All levels and dimensions are to be checked and verified on site prior to commencement of any

All levels and dimensions are to be checked and verified on site prior to commencement of any work, making of shop drawings or fabrication of components.

Do no scale on drawings. Use figured dimensions.

All workmanship & materials shall be in accordance with the requirements of current editions

All workmanship & materials shall be in accordance with the requirements of current editions including amendmnets of the SAA Codes of Practice, the Building Code of Australia, any AS standards and the current 2019 NCC and local council requirements.

Concrete footings, slab, structural beams or any other structural members are to be designed by a practicing engineer.

LEGEND)
	TIMBER
	WEATHERBOARD
	FACE BRICKWORK
	METAL
84776¥49	CONCRETE

METAL ROOFING TILED ROOFING RENDER EXISTING CLIENT
Mr and Mrs Ford
PROJECT ADDRESS

203 Balgowlah Road

Balgowlah NSW 2093

DA13

DRAWING NO.

DRAWING NAME LONG SECTION

DATE

December 2019 **SCALE** 1:100 @A3

DESIGNATED SITE MANAGER/BUILDER:

PRIOR TO COMMENCEMENT OF WORK A SITE MANAGER OR BUILDER MUST BE NOMINATED. THE SITE MANAGER OR BUILDER WILL BE RESPONSIBLE AND LIABLE FOR ALL WORKS CARRIED OUT ON THE SITE. THIS ASSUMES THE RESPONSIBILITY FOR THE ACTIONS OF ALL SUBCONTRACTED PARTIES AS WELL AS ADVISING THEMOF COUNCIL'S REQUIREMENTS WHEN CARRYING OUT WORKS.

BUILDING MATERIAL STOCKPILING:

SUFFICIENT AREA MUST BE LOCATED ALONG THE DOWNSLOPE BOUNDARY(S) OF THE SITE, ON THE CONSTRUCTION SIDE OF THE TURF FILTER STRIP OR NATIVE VEGETATION AND AROUND ALL STOCKPILES OF

MATERIAL ON THE SITE.

GUTTER PROTECTION:

PROVIDE PROTECTION TO DOWNHILL GRATE IN GUTTER BY MEANS OF SAND BAGS OR BLUE METAL WRAPPED IN GEOTEXTILE FABRIC. WHEN SOIL OR SAND BUILDS UP AROUND THIS SEDIMENT BARRIER, THE MATERIAL SHOULD BE RELOCATED BACK TO THE SITE FOR DISPOSAL.

STOCKPILES:

ALL STOCKPILES ARE TO BE KEPT ON-SITE WHERE POSSIBLE. ANY MATERIALS PLACED ON THE FOOTPATHS OR NATURE STRIPS REQUIRE COUNCIL'S PERMISSION.

ALL STOCKPILES ARE TO BE PLACED AWAY FROM THE DRAINAGE LINES AND STREET GUTTERS. IT IS BEST TO LOCATE THESE ON THE HIGHEST PART OF THE SITE IF POSSIBLE. PLACE WATERPROOF COVERING OVER STOCKPILES.


IF REQUIRED PROVIDE DIVERSION DRAIN & BANK AROUND STOCKPILES.

SEDIMENT NOTE:


- 1. ALL EROSION AND SEDIMENT CONTROL MEASURES TO BE INSPECTED AND MAINTAINED DAILY BY THE SITE MANAGER.
- 2. MINIMISE DISTURBED AREAS, REMOVE EXCESS SOIL FROM EXCAVATED AREA AS SOON AS POSSIBLE.
- 3. ALL MATERIAL STOCKPILE TO BE CLEAR FROM DRAINS, GUTTERS AND FOOTPATHS, OR WITHIN SEDIMENT FENCE AREA 4. DRAINAGE TO BE CONNECTED TO STORMWATER AS SOON AS POSSIBLE. IF STORED ON SITE, IT MUST BE FILTERED BEFORE RELEASING INTO STORMWATER SYSTEM OR WATERWAYS. 5. ROADS AND FOOTPATHS TO BE SWEPT DAILY.

DUST CONTROL:

TO REDUCE DUST GENERATED BY WIND ACTION, THE REMOVAL OF THE TOP SOIL IS TO BE MINIMISED. TO PREVENT DUST GENERATION. WATERING DOWN OF THE SITE. ESPECIALLY DURING THE MOVEMENT OF MACHINERY IS REQUIRED. WHERE EXCAVATING INTO ROCK, KEEP THE SURFACE MOIST TO MINIMISE DUST. CONSTRUCT A GRAVEL ENTRY/EXIT POINT USING BLUE METAL AND RESTRICT ALL VEHICLE MOVEMENTS WITHIN THE SITE TO A MINIMUM. ENSURE WIND BREAKS, SUCH AS EXISTING FENCES ARE MAINTAINED DURING THE CONSTRUCTION PHASE UNTIL NEW LANDSCAPING IS PROVIDED OR REINSTATED. PREVENT DUST BY COVERING STOCKPILES

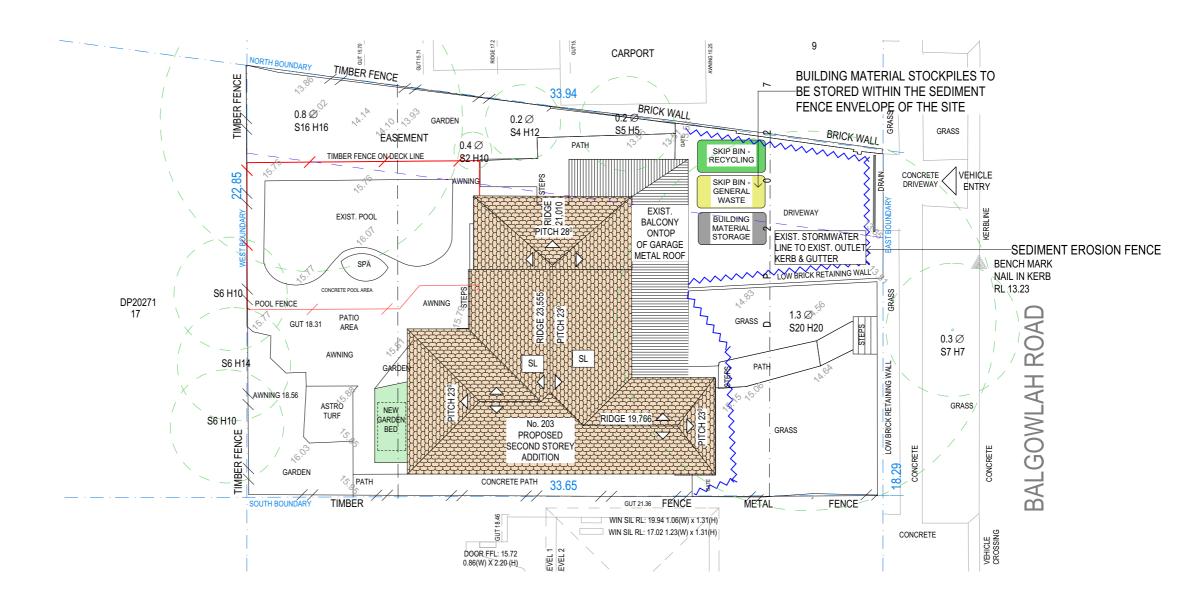

EROSION AND SEDIMENT CONTROL & WASTE MANAGEMENT PLAN

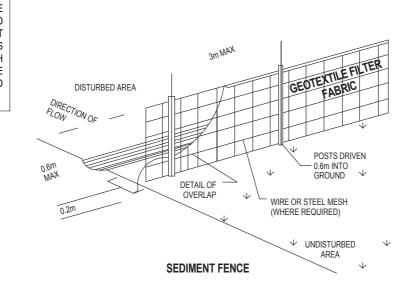

adonna barnes **DESIGNS**

NOTES

This drawing is the copyright of Donna Barnes Designs and not be altered, reproduced o transmitted in any form or by any means in part or in whole with the written permission of

All levels and dimensions are to be checked and verified on site prior to comi work, making of shop drawings or fabrication of components. Do no scale on drawings. Use figured dimensions.

All workmanship & materials shall be in accordance with the requirements of current editions including amendmnets of the SAA Codes of Practice, the Building Code of Australia, any AS standards and the current 2019 NCC and local council requirements.

Concrete footings, slab, structural beams or any other structural members are to be designed



CONCRETE **BRICKWORK** METAL **EXISTING**

DEMOLISHED

CLIENT Mr and Mrs Ford

PROJECT ADDRESS 203 Balgowlah Road Balgowlah NSW 2093

DRAWING NO. **DA14**

DATE

December 2019


DRAWING NAME


EROSION AND SEDIMENT CONTROL & WASTE MANAGEMENT PLAN

1:200

SCALE

1:200, 1:100 @A3

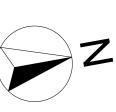

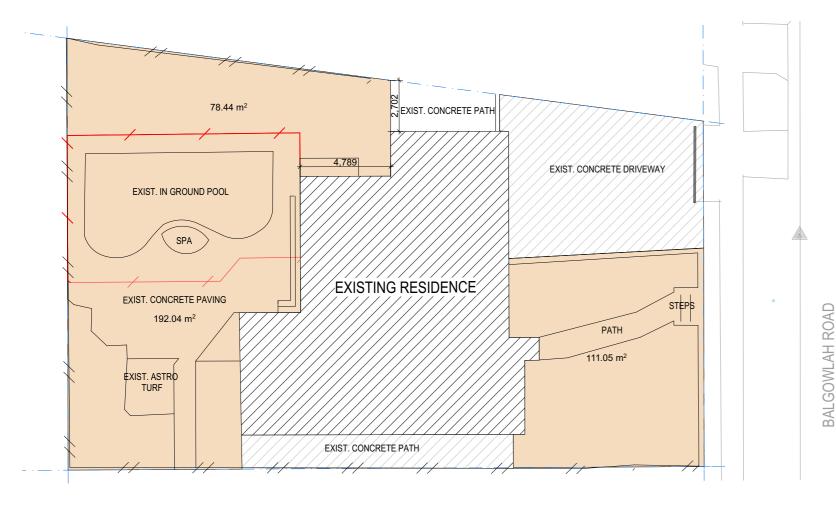


MINIMUM RESIDENTIAL TOTAL OPEN SPACE REQUIREMENTS:

AREA 0S3 - TOTAL OPEN SPACE - AT LEAST 55% OF SITE AREA

MIN. TOTAL OPEN SPACE = 692m² x 55% = 380.6m²

EXIST. TOTAL OPEN SPACE = 372.46m² (53.82%)

PROPOSED TOTAL OPEN SPACE = 381.53m² (55.13%), COMPLIES

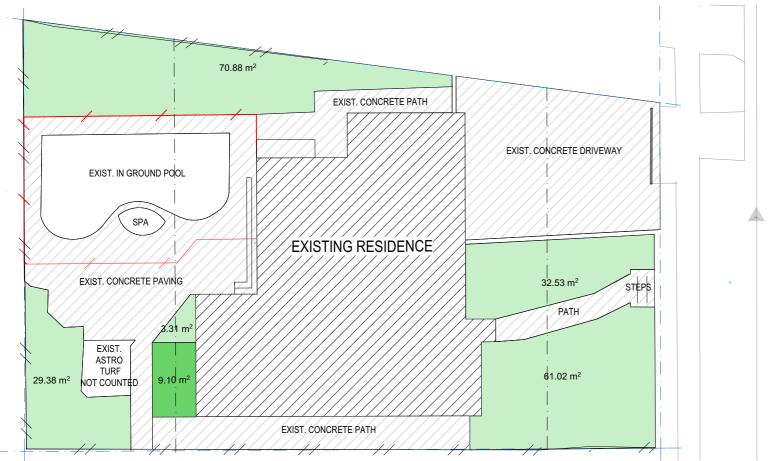

AREA 0S3 - LANDSCAPE AREA - AT LEAST 35% OF OPEN SPACE

MIN. LANDSCAPE AREA OF TOTAL OPEN SPACE = 380.6m² x 35% = 133.21m²

EXIST, LANDSCAPE AREA OF TOTAL OPEN SPACE = 197.12m²

PROPOSED. LANDSCAPE AREA OF TOTAL OPEN SPACE = 206.22m², COMPLIES



NOTES

This drawing is the copyright of Donna Barnes Designs and not be altered, reproduced or transmitted in any form or by any means in part or in whole with the written permission of Donna Barnes Designs.

All levels and dimensions are to be checked and verified on site prior to commencement of any

All levels and dimensions are to be checked and verified on site prior to commencement of any work, making of shop drawings or fabrication of components. Do no scale on drawings. Use figured dimensions.

All workmanship & materials shall be in accordance with the requirements of current editions including amendmnets of the SAA Codes of Practice, the Building Code of Australia, any AS standards and the current 2019 NCC and local council requirements. Concrete footings, slab, structural beams or any other structural members are to be designed by a practicing engineer.

EXIST. LANDSCAPING
NEW LANDSCAPING
TOTAL OPEN SPACE

LEGEND

CLIENT

Mr and Mrs Ford


PROJECT ADDRESS 203 Balgowlah Road Balgowlah NSW 2093 DA15

DRAWING NAMEAREA CALCULATIONS

DATE

December 2019

SCALE 1:200 @A3

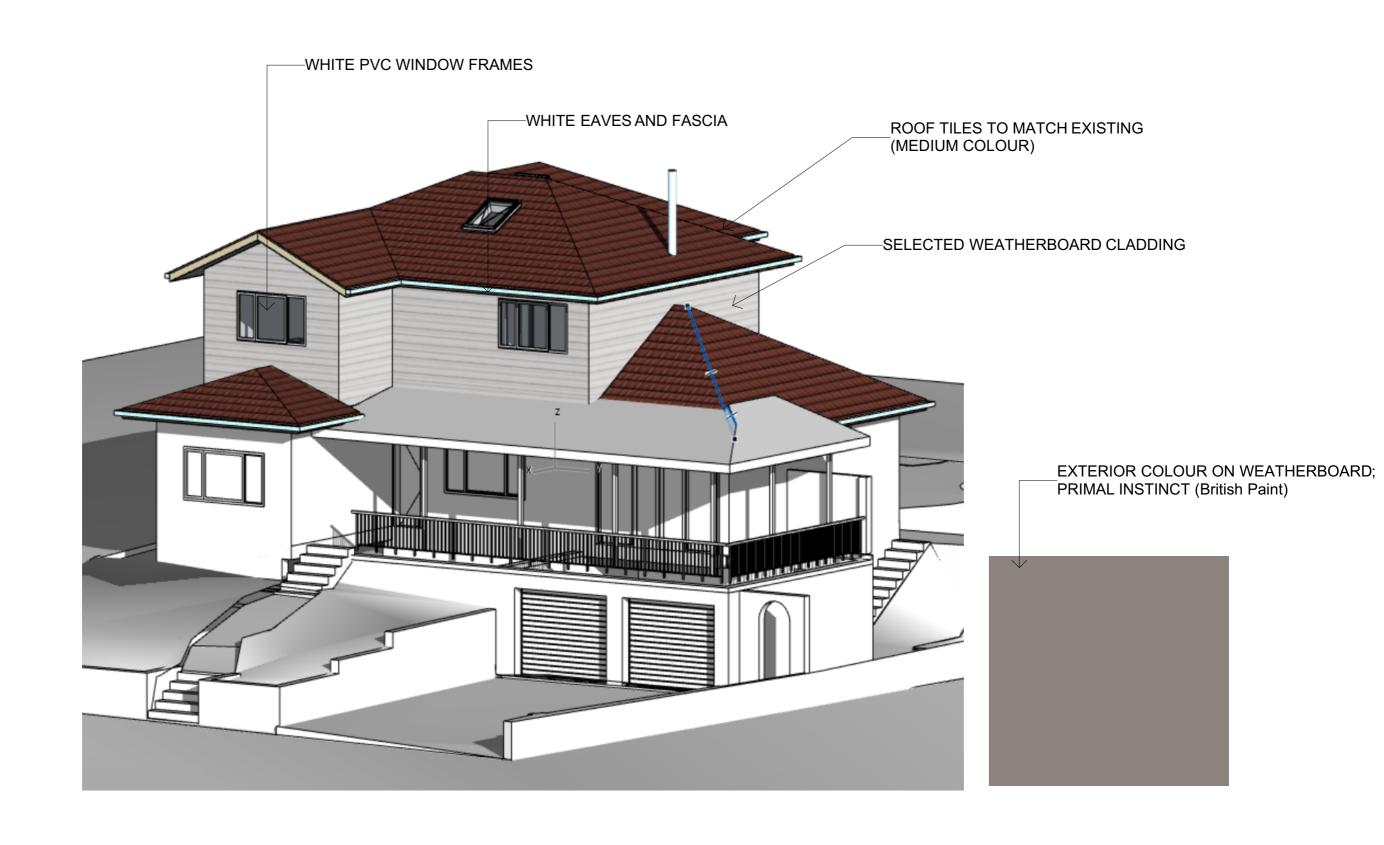



This drawing is the copyright of Donna Barnes Designs and not be altered, reproduced or transmitted in any form or by any means in part or in whole with the written permission of Donna Barnes Designs.

All levels and dimensions are to be checked and verified on site prior to commencement of any work, making of shop drawings or fabrication of components.

Do no scale on drawings. Use figured dimensions.

All workmanship & materials shall be in accordance with the requirements of current editions including amendments of the SAA Codes of Practice, the Building Code of Australia, any AS standards and the current 2019 NCC and local council requirements.

Concrete footings, slab, structural beams or any other structural members are to be designed by a practicing engineer.

LEGEND

CLIENT

Mr and Mrs Ford

PROJECT ADDRESS

203 Balgowlah Road Balgowlah NSW 2093 DRAWING NO. **DA16**

DRAWING NAME


SCHEDULE OF FINISHES

DATE

Thursday, 19 December 2019

SCALE

@A3

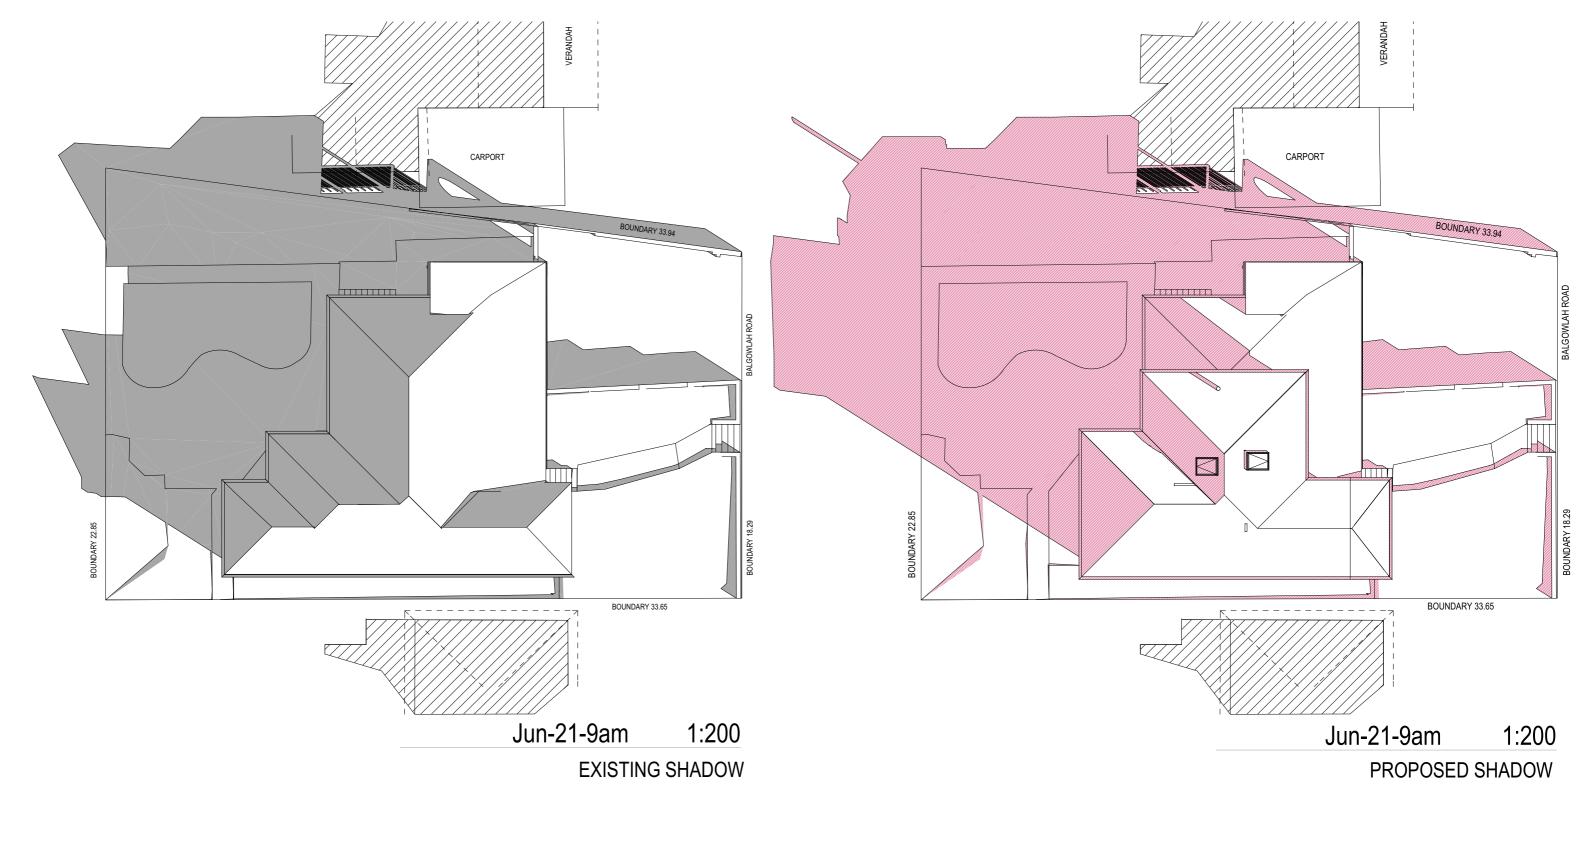



This drawing is the copyright of Donna Barnes Designs and not be altered, reproduced or transmitted in any form or by any means in part or in whole with the written permission of Donna Barnes Designs.

All levels and dimensions are to be checked and verified on site prior to commencement of any

work, making of shop drawings or fabrication of components.

Do no scale on drawings. Use figured dimensions.

All workmanship & materials shall be in accordance with the requirements of current editions All worktriantsrip α materials shall be in accordance with the requirements of current editions including amendments of the SAA Codes of Practice, the Building Code of Australia, any AS standards and the current 2019 NCC and local council requirements.

Concrete footings, slab, structural beams or any other structural members are to be designed by a practicing engineer.





EXISTING SHADOW PROPOSED SHADOW CLIENT

Mr and Mrs Ford

PROJECT ADDRESS 203 Balgowlah Road Balgowlah NSW 2093

DRAWING NO.

DA17


WINTER SOLSTICE 9 AM


DRAWING NAME

DATE December 2019

SCALE

1:200 @A3

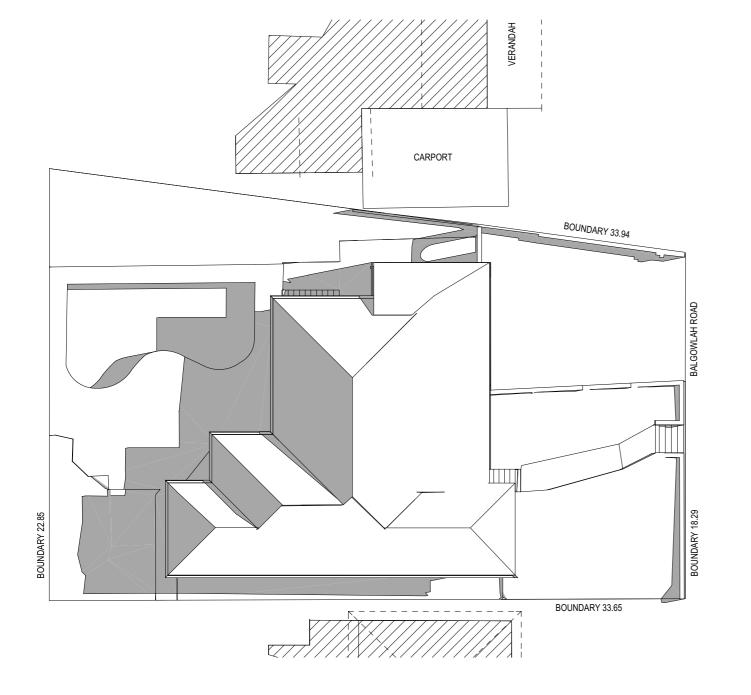

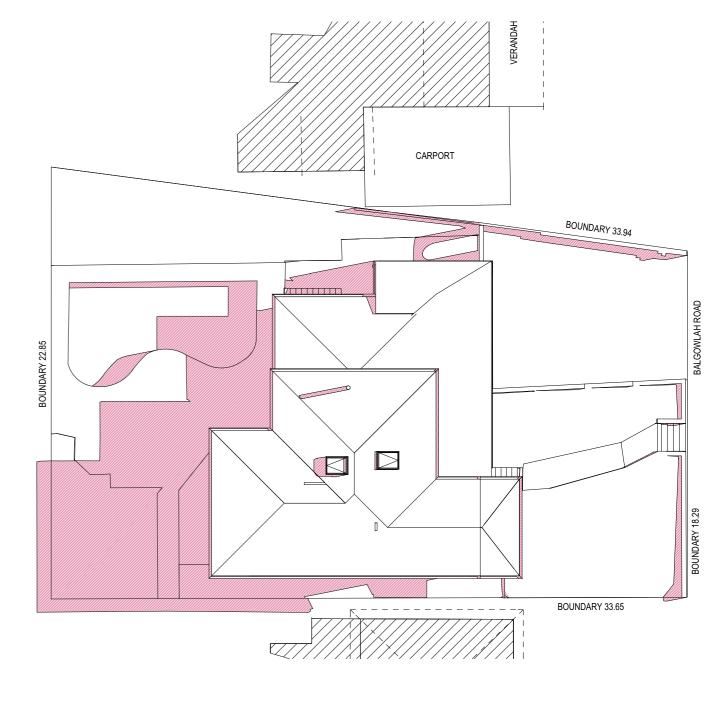

Jun-21-12 NOON 1:200 **EXISTING SHADOW**

Jun-21-NOON 1:200 PROPOSED SHADOW



This drawing is the copyright of Donna Barnes Designs and not be altered, reproduced or transmitted in any form or by any means in part or in whole with the written permission of Donna Barnes Designs.

All levels and dimensions are to be checked and verified on site prior to commencement of any

work, making of shop drawings or fabrication of components.

Do no scale on drawings. Use figured dimensions.

All workmanship & materials shall be in accordance with the requirements of current editions All worktriantsrip α materials shall be in accordance with the requirements of current editions including amendments of the SAA Codes of Practice, the Building Code of Australia, any AS standards and the current 2019 NCC and local council requirements.

Concrete footings, slab, structural beams or any other structural members are to be designed by a practicing engineer.



EXISTING SHADOW PROPOSED SHADOW CLIENT

Mr and Mrs Ford

PROJECT ADDRESS

DA18

DATE

DRAWING NO.

DRAWING NAME


SCALE


1:200 @A3

WINTER SOLSTICE 12 PM

December 2019

203 Balgowlah Road Balgowlah NSW 2093

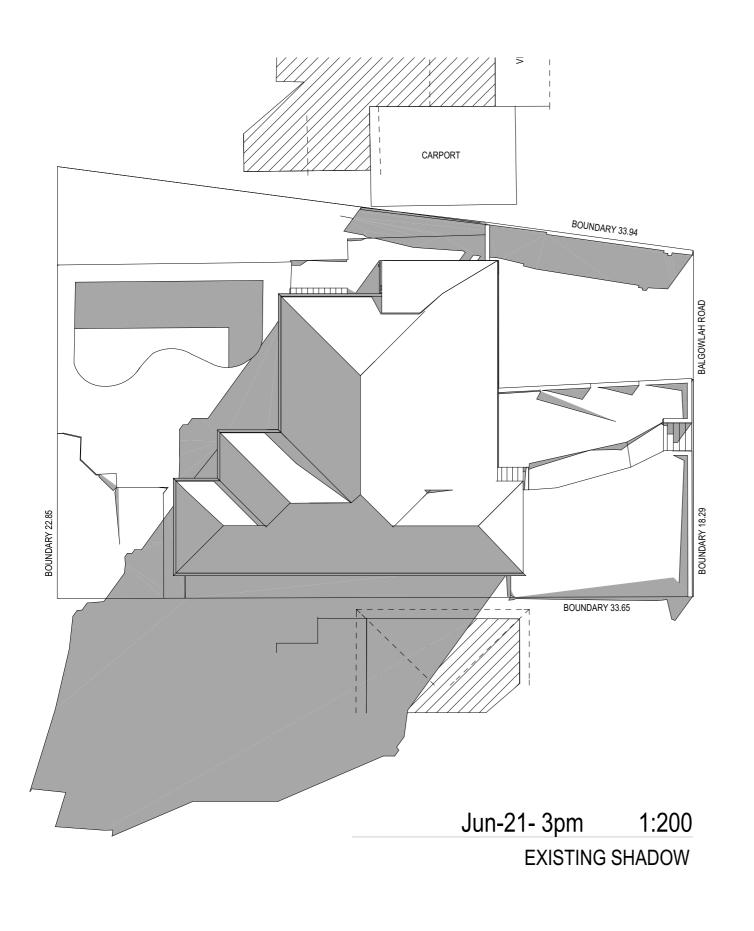

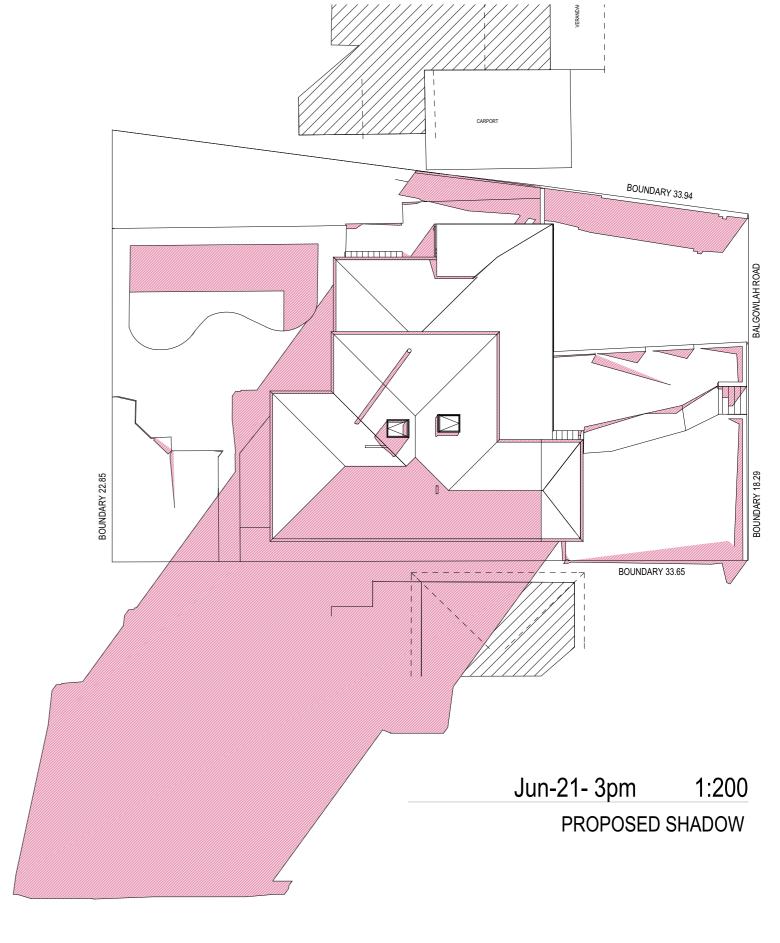



This drawing is the copyright of Donna Barnes Designs and not be altered, reproduced or transmitted in any form or by any means in part or in whole with the written permission of Donna Barnes Designs.

All levels and dimensions are to be checked and verified on site prior to commencement of any

All levels and dimensions are to be checked and verified on site prior to commencement of any work, making of shop drawings or fabrication of components.

Do no scale on drawings. Use figured dimensions.

All workmanship & materials shall be in accordance with the requirements of current editions including amendments of the SAA Codes of Practice, the Building Code of Australia, any AS standards and the current 2019 NCC and local council requirements.

Concrete footings, slab, structural beams or any other structural members are to be designed by a practicing engineer.

LEGEND



EXISTING SHADOW PROPOSED SHADOW CLIENT

Mr and Mrs Ford

PROJECT ADDRESS 203 Balgowlah Road Balgowlah NSW 2093

DRAWING NO.

DA19

WINTER SOLSTICE 3 PM

DRAWING NAME

DATE

December 2019

SCALE

1:200 @A3