
Proposed New Dwelling for Patrick and Penny Joyce 16 Addison Rd, Sydney

# **Development Application Issue**December 2020


1.0 1.1 1.2 1.3 1.4 1.5 1.6 1.7	Cover Sheet Site Survey Locality and Site Analysis Site Plan Lower Floor Plan Ground Floor Plan First Floor Plan Roof Plan Boatshed Plan	1:200 1:200 1:200 1:100 1:100 1:100 1:100
2.1 2.2	Elevations Elevations	1:200 1:200
3.1 3.2 3.3	Sections Sections Setback Building height	1:200 1:200
4 . 1 4 . 2 4 . 3	Shadow Diagram Shadow Diagram Shadow Diagram	
5.1	Material Palette	

### Town Planning: Site Area: 543.8m<sup>2</sup> Floor space Ratio: 0.6 543.8x0.6= 326.3m<sup>2</sup> Zone: E4 Environmental Living Max. Wall Height: 7.2m or calculated for gradient Max. Building Height: 8.5m Max. Roof Slope: 35° Lot size C: Min. 250m<sup>2</sup> Setback: 1/3 Wall Height Foreshore Scenic Protection Area Bandicoot and Penguin Significant Area Biodiversity Overlay

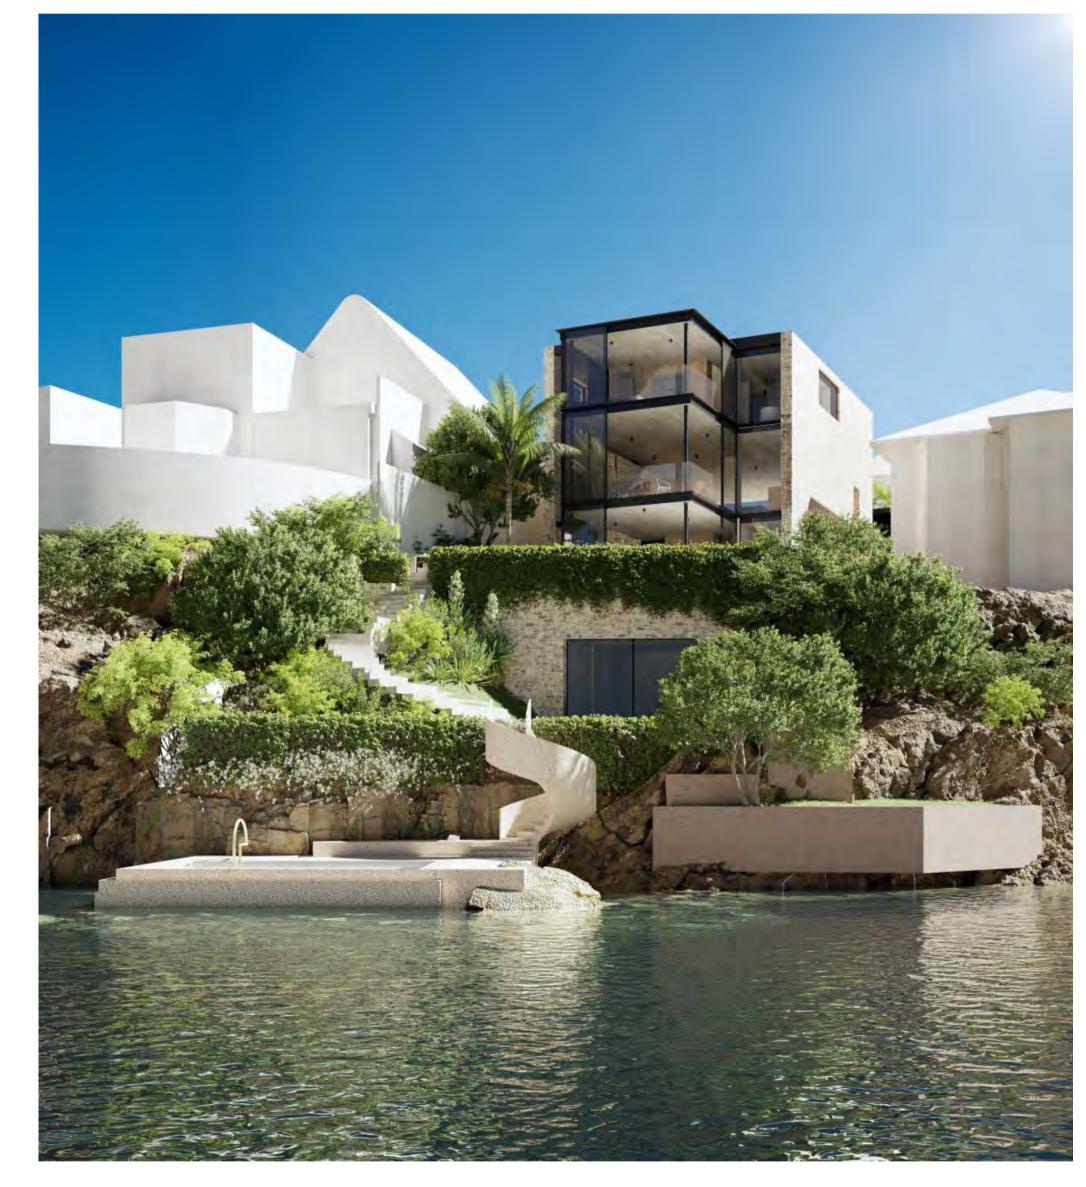

Artists Impression



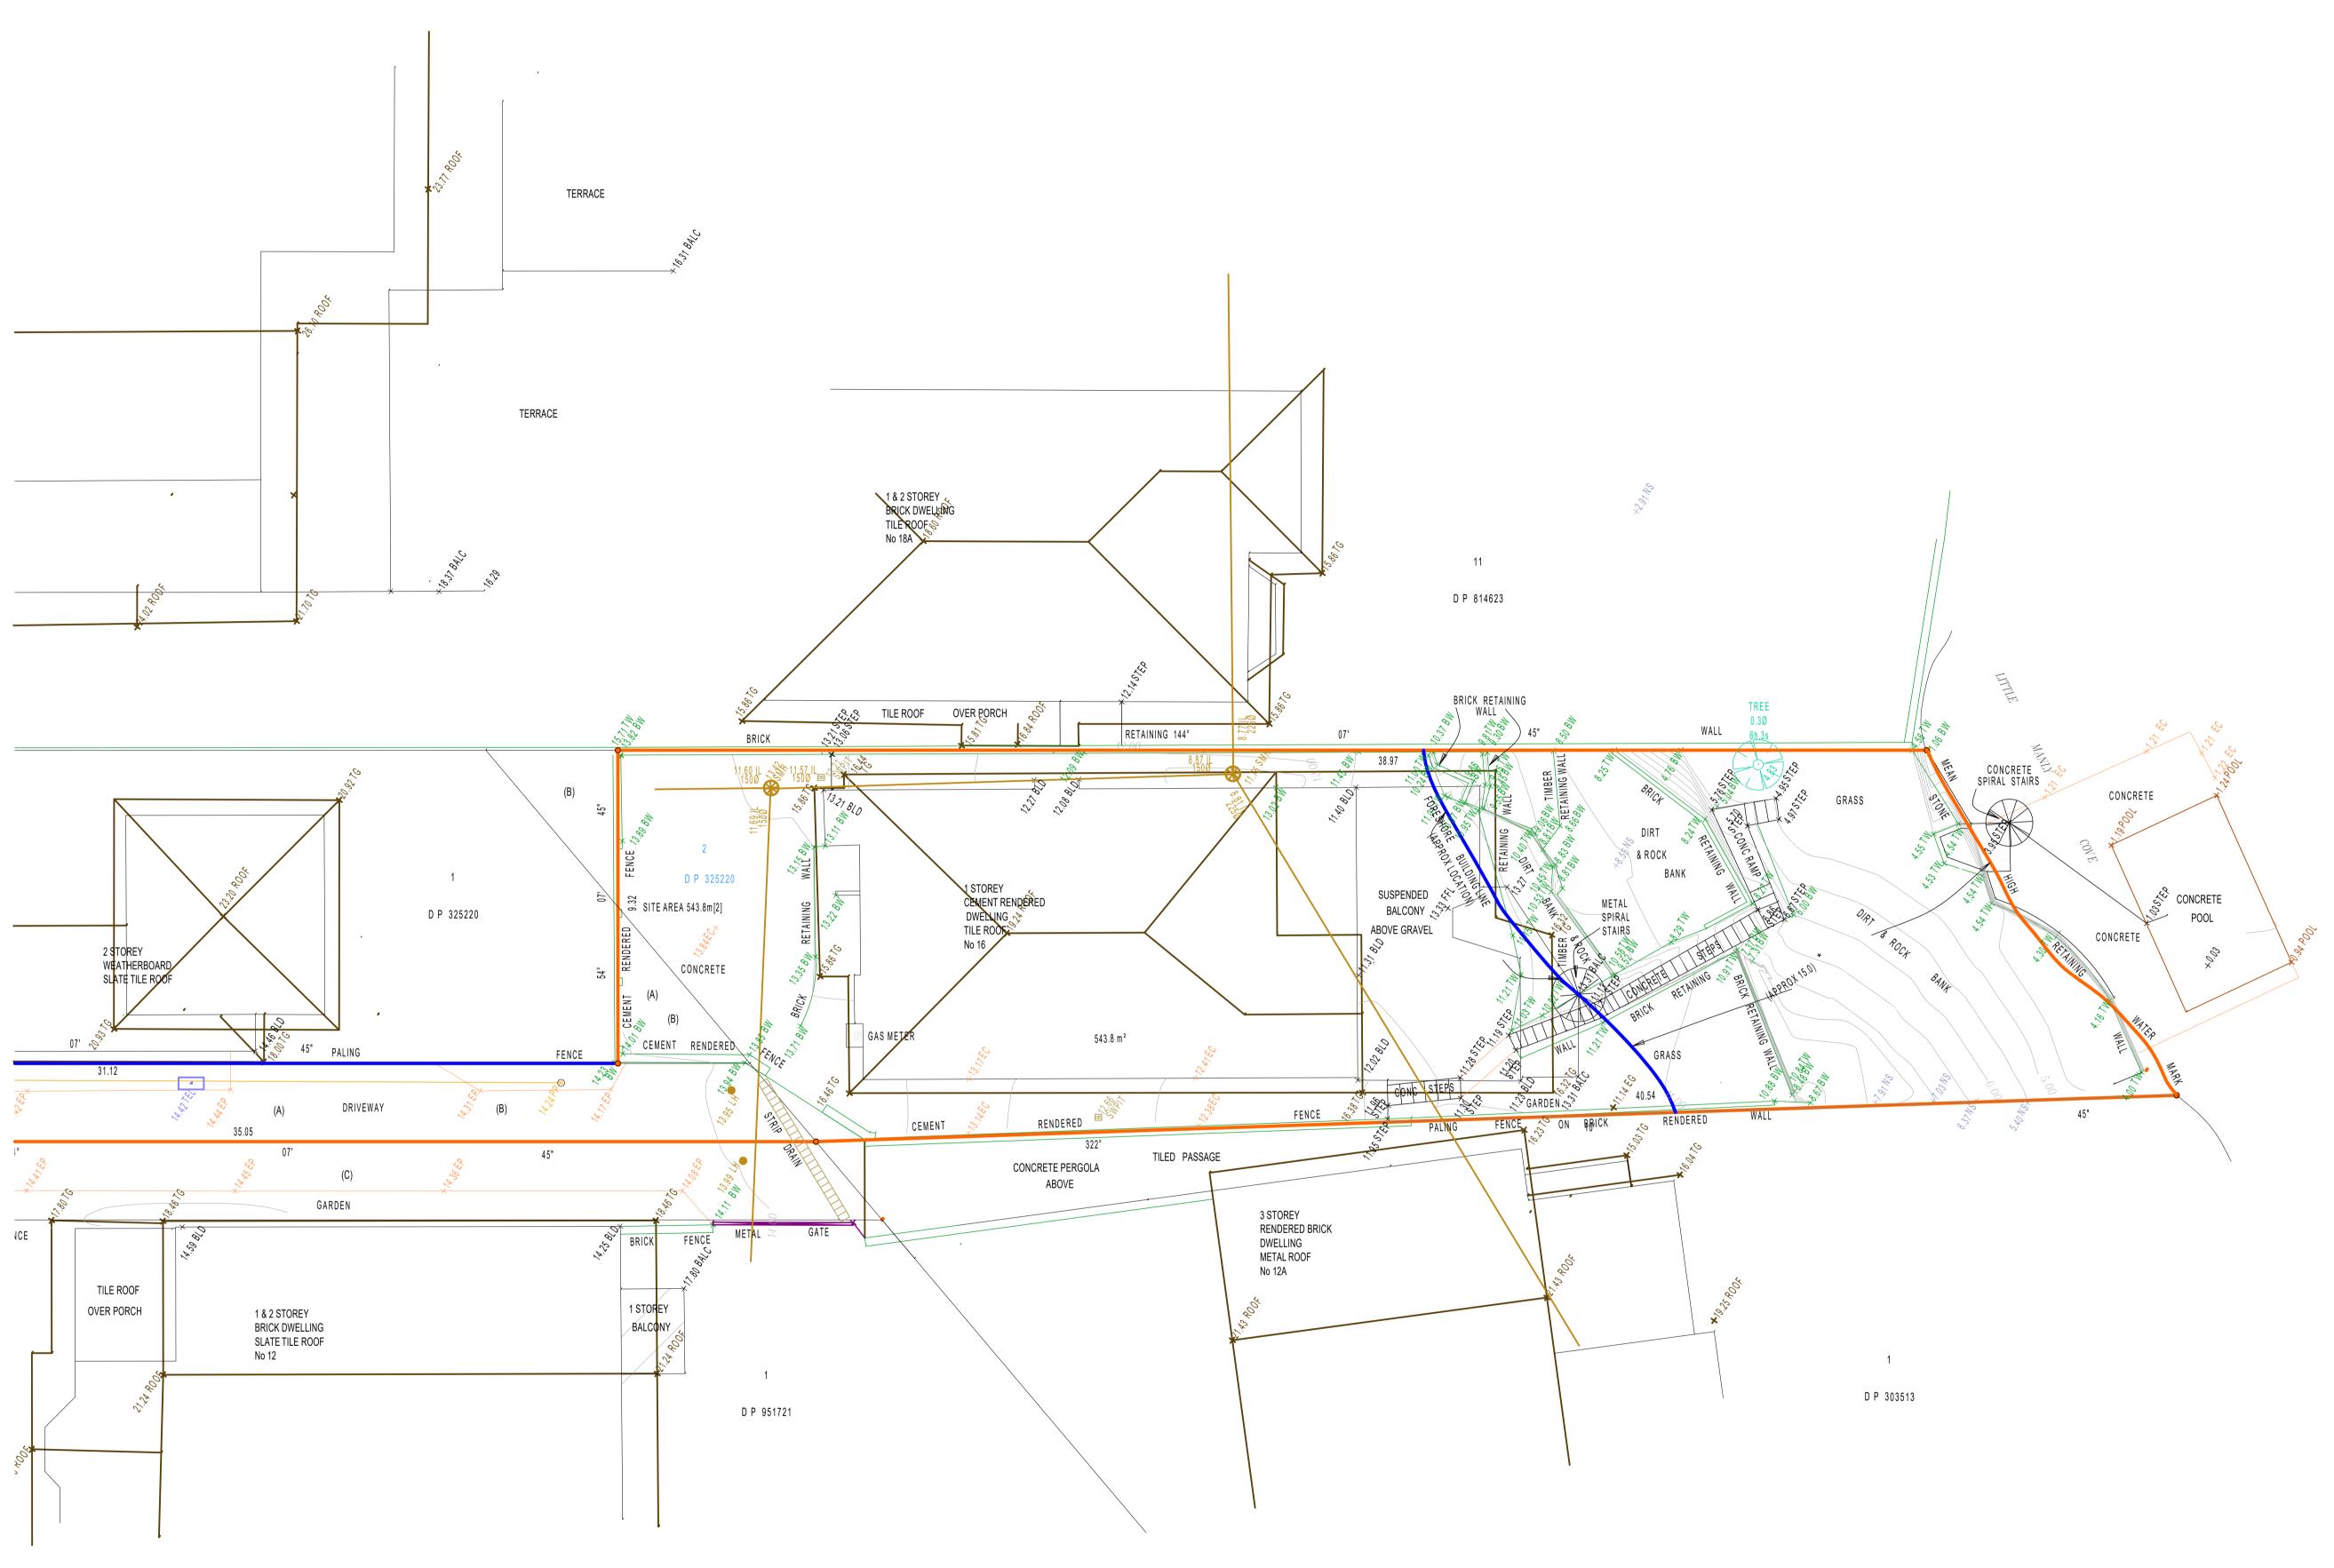

\_\_\_\_\_ DENOTES SEWER LINE

NOTE: FORESHORE BUILDLING LINE FROM L.E.P. MAP \* APPROXIMATE LOCATION (15 METRES FROM M.H.W.M. 2013)

(A) RIGHTS OF WAY (RE A735434, A750076) (B) BENEFITED BY RIGHTS OF WAY (RE A750076, B795218) (C) RIGHT OF WAY (RE 750076)

#### TYPICAL NOTES: ORIGIN OF LEVELS PM 877, R.L.18.704 (A.H.D.) BEARINGS ARE ON MGA NORTH NO BOUNDARY SURVEY HAS BEEN UNDERTAKEN. BEARINGS & DISTANCES HAVE BEEN COMPILED FROM TITLE AND/OR DEED INFORMATION SUPPLIED BY DEPARTMENT OF LANDS NSW. RELATIONSHIP OF IMPROVEMENTS AND DETAIL TO BOUNDARIES IS DIAGRAMMATIC ONLY AND SPECIFIC DETAILS, IF CRITICAL, WILL REQUIRE FURTHER SURVEY. SERVICES SHOWN ARE BASED ON VISIBLE SURFACE INDICATORS EVIDENT AT THE DATE OF SURVEY AND THE RELEVANT SERVICE DIAGRAMS OF THE VARIOUS AUTHORITIES. ALL SERVICE MUST BE VERIFIED ON SITE PRIOR TO ANY WORK BEING UNDERTAKEN. LINKER SURVEYING PTY LTD BEAR NO RESPONSIBILITY FOR THE ACCURACY OR COMPLETENESS OF THE SERVICES SHOWN RIDGE, EAVE & GUTTER HEIGHTS HAVE BEEN OBTAINED BY AN INDIRECT METHOD AND ARE ACCURATE FOR PLANNING PURPOSES ONLY. ADJOINING BUILDINGS AND DWELLINGS HAVE BEEN PLOTTED FOR DIAGRAMMATIC PURPOSES ONLY AND SPECIFIC DETAILS, IF CRITICAL, WILL REQUIRE FURTHER SURVEY. THE DIAMETER (Ø), SPREAD (S) & HEIGHT (H) OF EACH TREE IS INDICATIVE ONLY AND SPECIFIC DETAILS, IF CRITICAL, WILL REQUIRE FURTHER SURVEY. CONTOURS ARE AN INDICATION OF THE TOPOGRAPHY ONLY. SPOT LEVELS SHOULD BE USED IF detailed design is to be undertaken. CONTOUR INTERVAL 0.5 METRE. LEGEND OF TYPICAL CODES AE - ARCHITECTURAL EMBELLISHMENT AP - ALIGNMENT PIN BAWN - BOTTOM OF AWNING BB - BOTTOM OF BANK BCH - BOTTOM OF CHIMNEY BD - BOTTOM OF DOOR BDY - BOUNDARY BF - BOTTOM OF FENCE BHR - BOTTOM OF HANDRAIL BIT — BITUMEN BK - BOTTOM OF KERB BM - BENCH MARK BOL - BOLLARD BR - BOTTOM OF ROCK BRK – BRICK BRW - BOTTOM OF RETAINING WALL BS - BOTTOM OF STEPS BW - BOTTOM OF WALL BWIN - BOTTOM OF WINDOW CL - CENTRELINE CLID - CONCRETE LID COM - COMMUNICATIONS PIT CONC - CONCRETE CPT - CARPORT D - DOOR DD - DISH DRAIN DH - DRILL HOLE DHW - DRILL HOLE & WINGS EB — EDGE OF BITUMEN EBOX - ELECTRICITY BOX EC — EDGE OF CONCRETE ED - EDGE OF DOOR EG – EDGE OF GARDEN ELEC – ELECTRICITY PIT EP — EDGE OF PATH ER — EDGE OF ROAD FL - FLOOR LEVEL - FINISHED FLOOR LEVEL FP - FENCE POST GD - GLASS DOOR GL - GROUND LEVEL GM - GAS METER HPG - HIGH POWERED GAS HR - HANDRAIL HYD - HYDRANT IL - INVERT LEVEL MH - MANHOLE LEGEND OF TYPICAL SERVICES ---- C ---- COMMUNICATIONS CABLE CSWP—— CERAMIC STORMWATER PIPE ---- E ---- UNDERGROUND ELECTRICITY CABLES —AE——AO— UNDERGROUND ELECTRICITY & OPTUS CABLES ----- FS ------ FIRE SERVICE ---- G ---- GAS LINE ----- GE ----- GAS LINE & ELECTRICITY CABLES ----- T ----- TELSTRA CABLES ---- NG ---- NATURAL GAS LINE ---- OH ---- OVERHEAD CABLES ----- OPT ----- OPTUS CABLE ----- PE ------ PRIVATE ELECTRICITY ----- PS ------ PRIVATE SEWER ----- PW ------ PRIVATE WATER ALL UNDERGROUND SERVICE INFORMATION INCLUSIVE OF GENERAL POSITION AND SURFACE COVER DEPTHS NOTED ON THE PLAN ARE APPROXIMATELY ONLY. 2. ALL UNDERGROUND SERVICE INFORMATION HAS BEEN COMPILED FROM SERVICE AUTHORITY PLANS PROVIDED BY THE AUTHORITIES. THE LOCATION OF SERVICES BETWEEN SURVEYED POINTS (AS INDICATED) HAVE BEEN SHOWN DIAGRAMMATICALLY ONLY USING THE SERVICE DIAGRAMS AS PROVIDED. THE EXACT LOCATION OF THESE SERVICES BETWEEN THE SURVEYED POINTS MUST BE VERIFIED PRIOR TO ANY EXCAVATION OR PILING. NO WARRANTY IS GIVEN AGAINST THE POSSIBILITY OF THE EXISTENCE OF FURTHER UNCHARTED SERVICES. ALL CONTRACTORS, TRADESMEN, BUILDING & PROJECT CONSULTANTS MUST CONTACT THE VARIOUS AUTHORITIES, IN ACCORDANCE WITH STANDARD "DIAL BEFORE YOU DIG" PROCEDURES PRIOR TO UNDERTAKING ANY WORKS WITHIN THE VICINITY OF THE SERVICE LINES TO VERIFY THE POSITION OF THE SERVICE LINES. Liability limited by a scheme approved under Professional Standards Legislation REDUCTION RATIO 1:100 1 2 3 4 5 6 7 8 9 10 LENGTHS ARE IN METRES CLIENT: CHRISTOPHER HO TITLE No: 2/325220 DATUM: A.H.D. DATE OF SURVEY: 15.04.16 SURVEYOR: KB DRAFTER: PH PLAN OF DETAIL & LEVELS AT No 16 ADDISON ROAD

MLID — METAL LID

PERG - PERGOLA

RCK - ROCK

RLWY - RAILWAY

SEW - SEWER

SHR - SHRUB

RR - ROOF RIDGE

RSN - CONCRETE NAIL

SIP - SEWER INSPECTION PIT SLH - SEWER LAMP HOLE

SMH - SEWER MANHOLE

SSM - STATE SURVEY MARK

SP - SIGN POST

SV - STOP VALVE SW - STORM WATER

TARCH- TOP OF ARCH

TAWN - TOP OF AWNING TB - TOP OF BANK

TBX - TELSTRA BOX

TEL - TELSTRA PIT

TELP - TELSTRA PILLAR TF - TOP OF FENCE

THR - TOP OF HANDRAIL

TK - TOP OF KERB

TR – TREE TRF – TOP OF ROOF

TRK - TOP OF ROCK TRW - TOP OF RETAINING WALL

TS - TOP OF STEPS

TWIN - TOP OF WINDOW

UAWN - UNDERSIDE OF AWNING

USC - UNDERSIDE OF CEILING

USG - UNDERSIDE OF GUTTER

VENT VER - VERANDAH VC - VEHICLE CROSSING

WM - WATER METER

----- SO ----- SEWER OUTFALL ---- ST ---- SHARED TRENCH

----- SW ----- STORM WATER

—SW——CK— STORMWATER CREEK

---- U ---- UNKNOWN SERVICE

---- VO ---- VOCUS CABLES

---- W ---- WATER SUPPLY

----- WM ----- WATER MAIN

----- VR ------ VERIZON CABLES

DIAL BEFORE YOU DIG

REF:160320

**ISSUE DATE:65** SHEET SIZE: AO

Suite 301, Level 3, 55 Holt Street

email: reception@linkersurveying.com.au web site: www.linkersurveying.com.au

Surry Hills NSW 2012

Strawberry Hills NSW 2012

SHEET 1 OF 1 SHEETS

ISSUE:1

MANLY

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t: (02) 9212 4655

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---- S ---- SEWER

W - WINDOW

UNDERSIDE OF EAVE

UKS - UNKNOWN SERVICE

USB - UNDERSIDE OF BEAM

TW - TOP OF WALL

us – underside

TOP OF GUTTER

TRAFFIC ISLAND

TRAFFIC LIGHT

TOP OF PARAPET

TCH - TOP OF CHIMNEY TD - TOP OF DOOR

NATURAL SURFACE


- PRAM CROSSING

PED - PEDESTRIAN CROSSING

- OPTUS PIT

PM - PERMANENT MARK PP – POWER POLE

RM - REFERENCE MARK

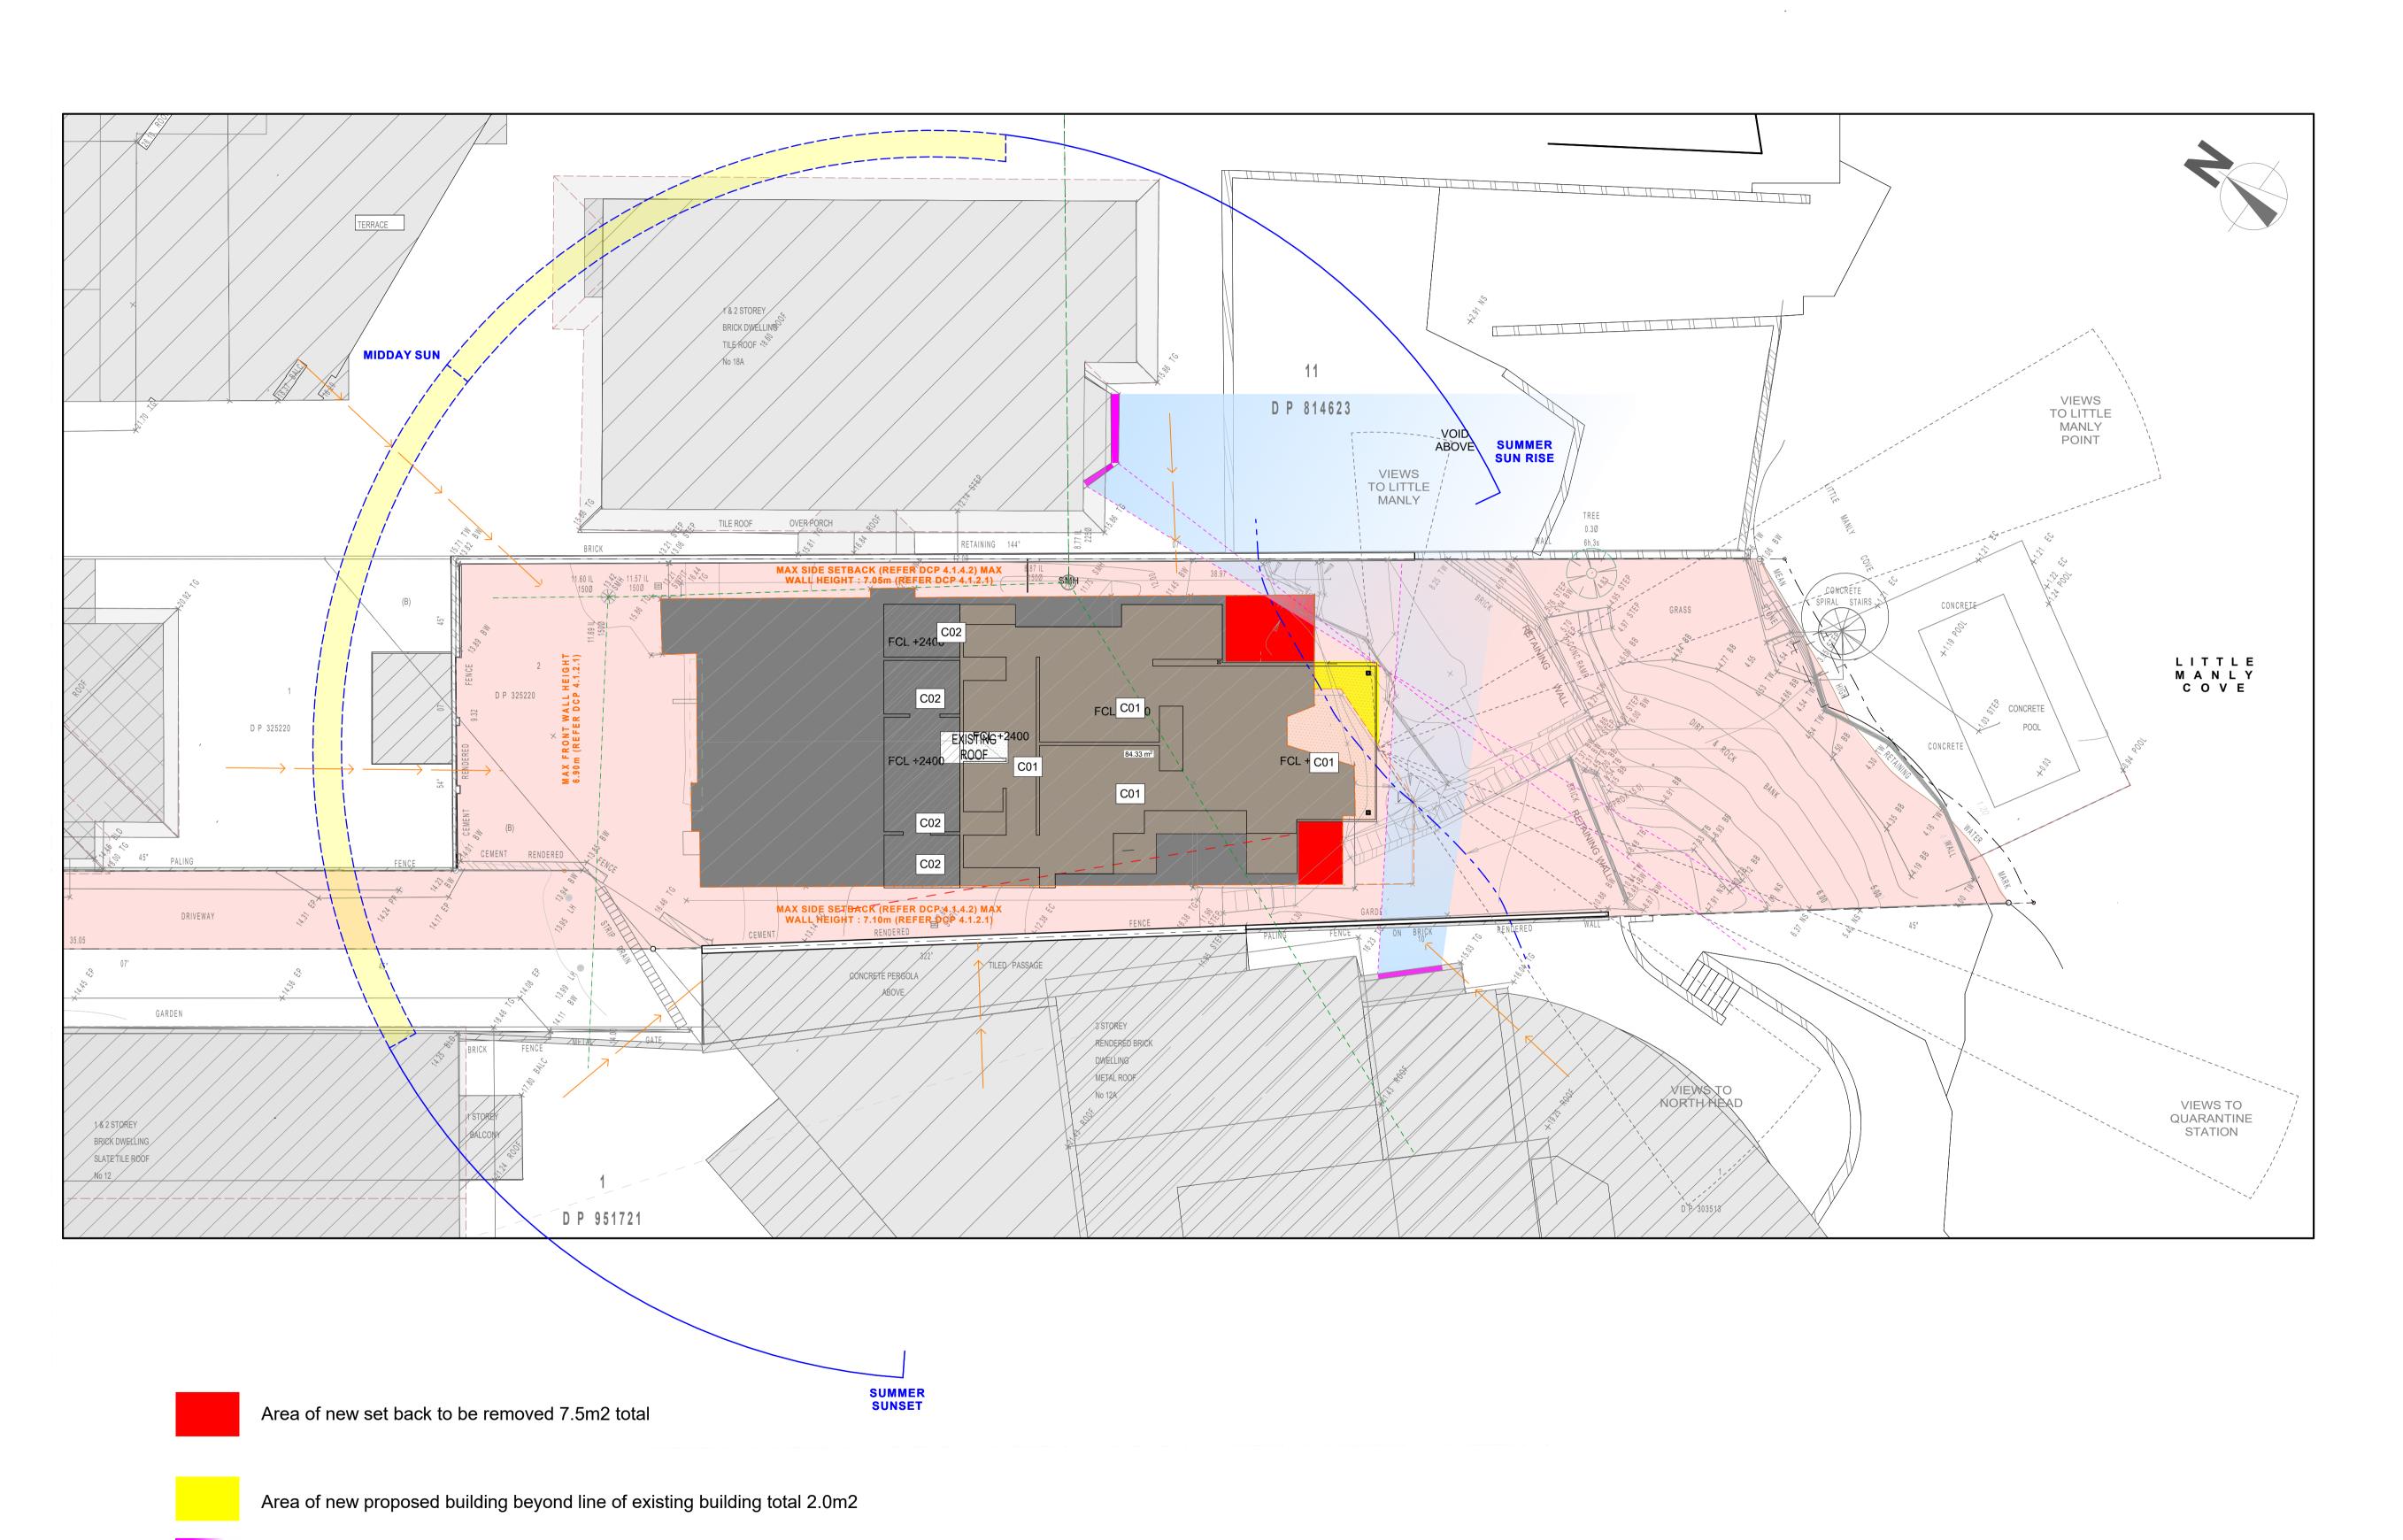

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# 16 Addison Rd, Sydney Consultants

Quantity Surveyors	Dean, Murray & Partners Ltd
Structural Engineers	Law Sue Davison Ltd.
Truss Designer	Buildable Layouts Ltd.
Geotechnical Engineer	Chambers Consultants Ltd.

designed	**	peer review	**
drawn	**	checked	**
scale <b>1:100</b>	@ A1	date 21/12/	2020

title

### Locality And Site Analysis 1:200 @ A3

drawing set

# Development Application Not For Construction

ref no. 18010 sheet no.

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Α

revision


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K Drive/Projects18/18010/Dwgs/

Overlooking

Proposed increased line of site to harbour for neighbouring properties



**Town Planning:** 

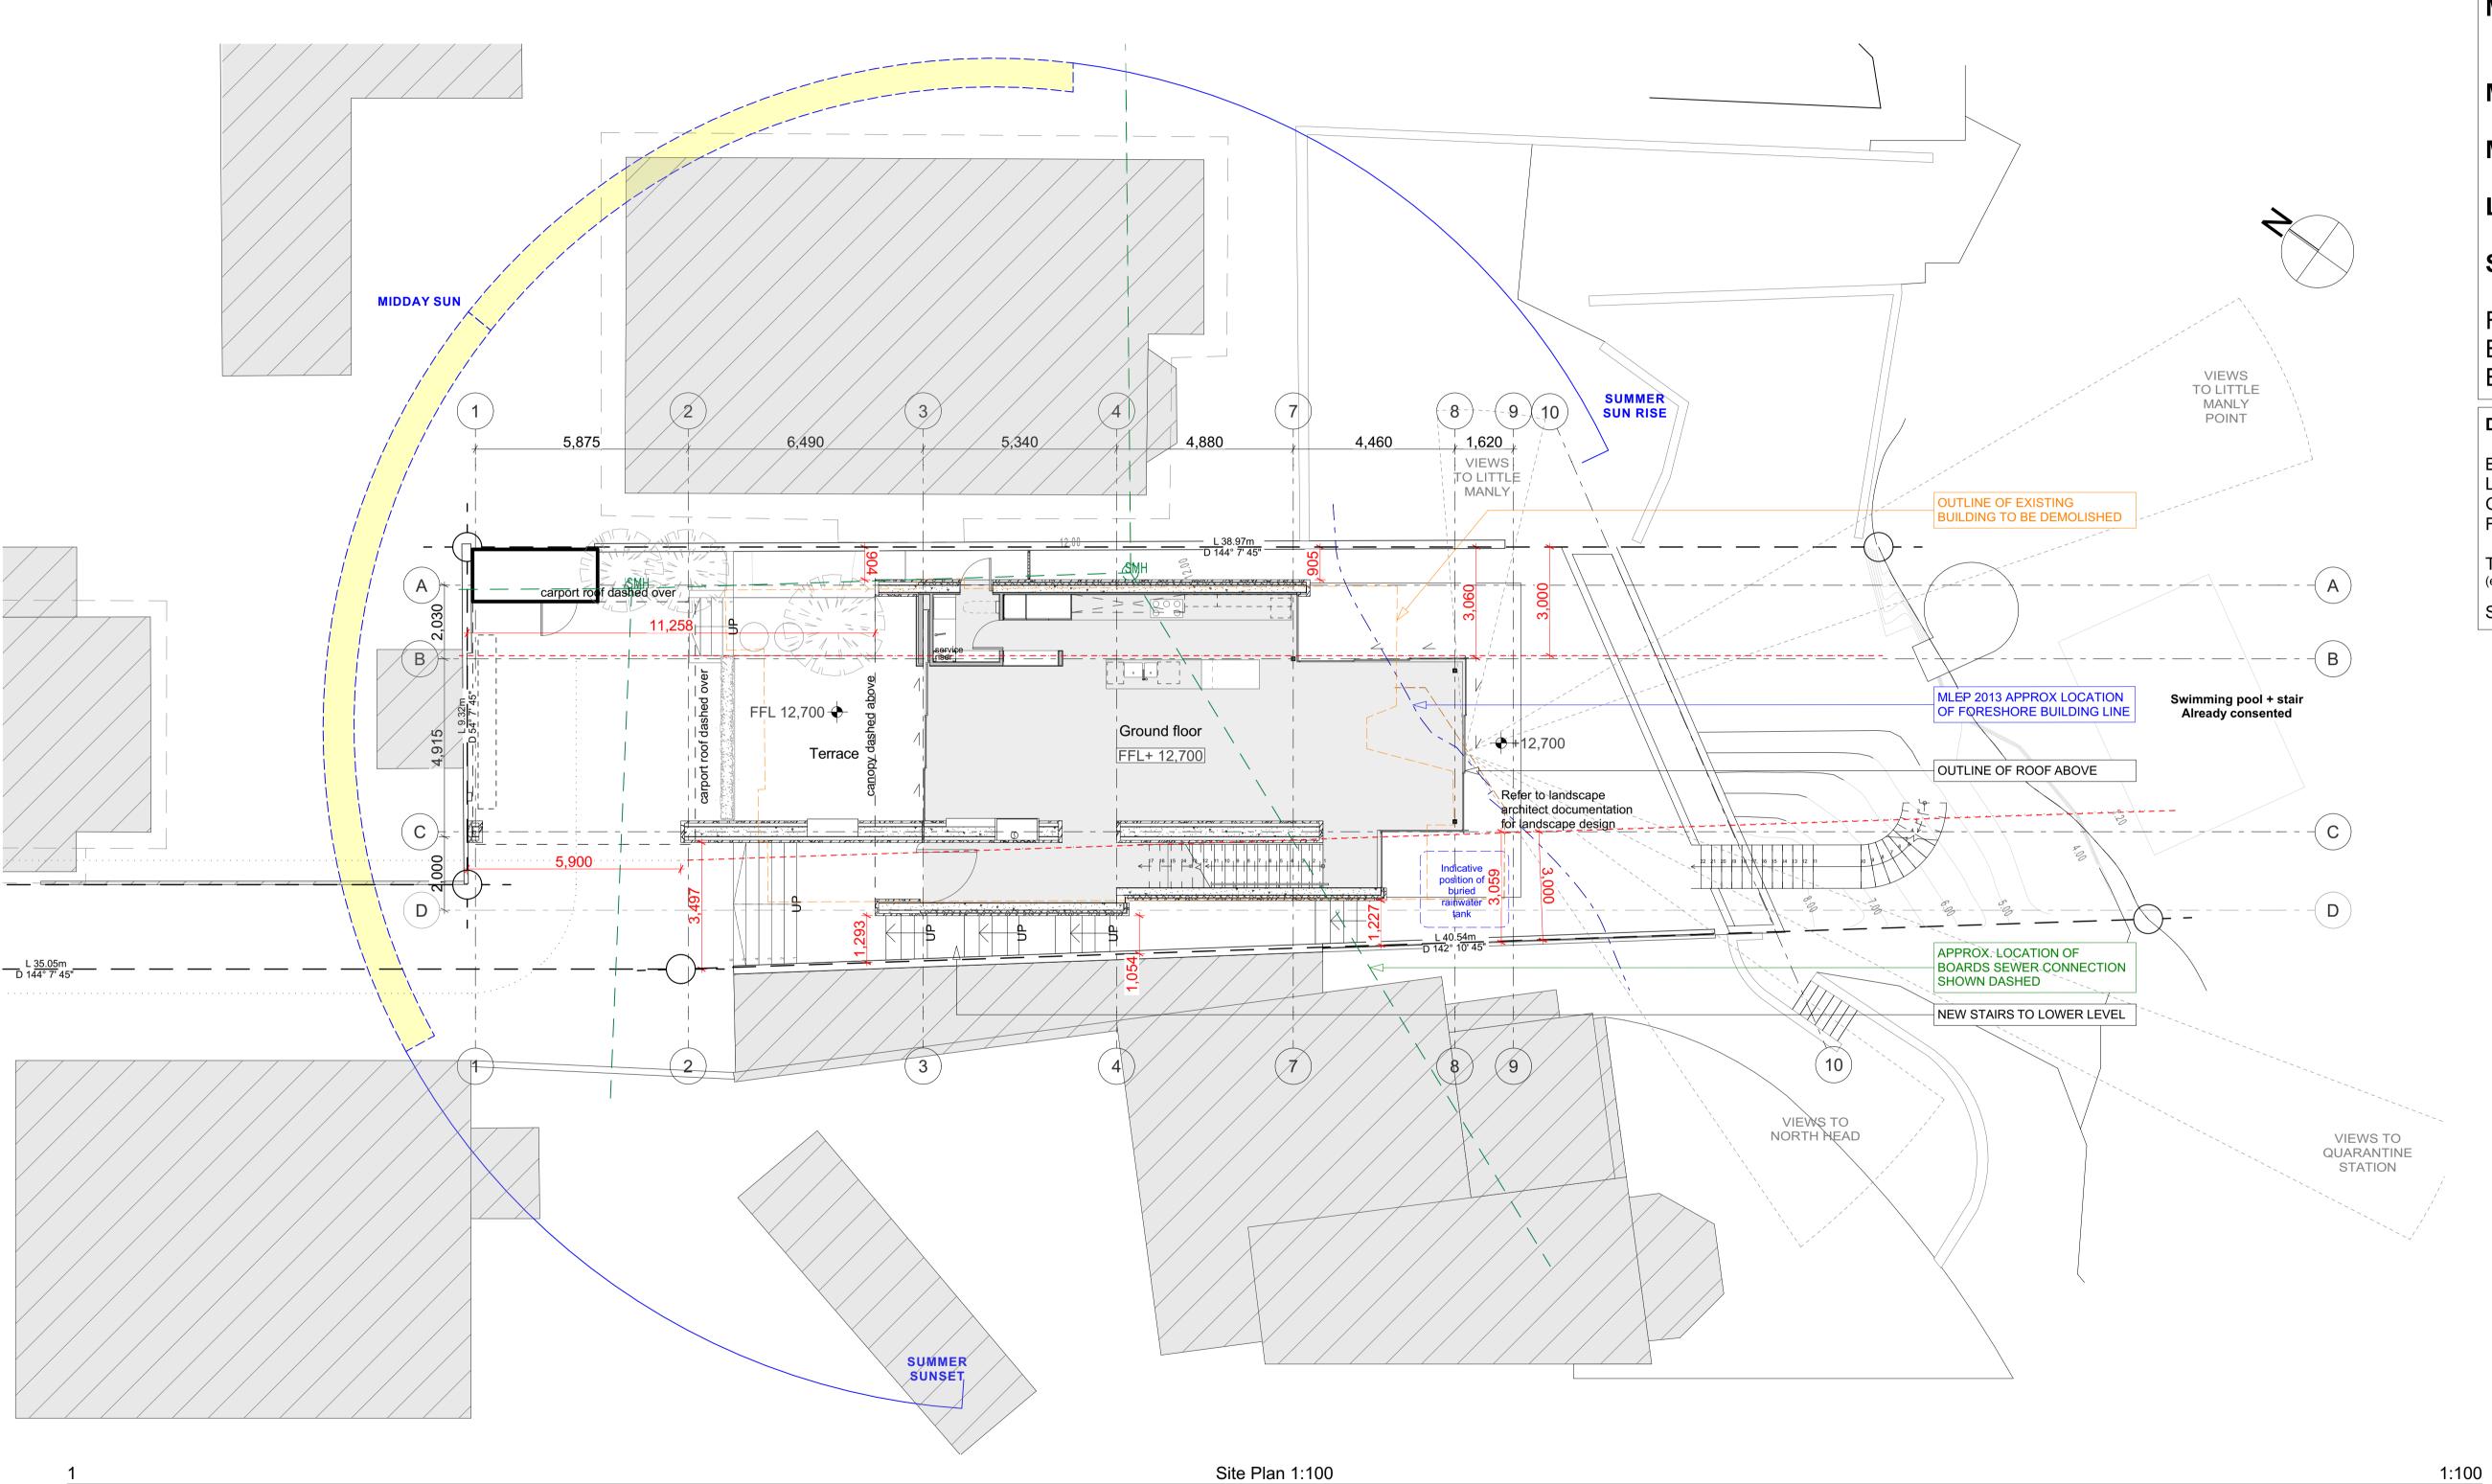Site Area: 543.8m<sup>2</sup>

Floor space Ratio: 0.6 543.8x0.6= 326.3m<sup>2</sup>

**Zone:** E4 Environmental Living

Max. Wall Height: 7.2m

or calculated for gradient

Max. Building Height: 8.5m

Max. Roof Slope: 35°

Lot size C: Min. 250m<sup>2</sup>

Setback: 1/3 Wall Height

Foreshore Scenic Protection Area
Bandicoot and Penguin Significant Area

Biodiversity Overlay

#### **Dwelling Gross Floor Area**

Boat shed 22m2
Lower Floor 84.5m2
Ground Floor 104m2
First Floor 92m2

TOTAL: 302.5m2 (excludes plant, vertical circulation & basement storage)

Storage Shed 4.3m2

NOTE: Drawings subject to Architects Developed and Detail Design revisions. Not for Construction. To be read in conjunction with Specification and Consultant Drawings

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Geotechnical Engineer	Chambers Consultants Ltd.
Truss Designer	Buildable Layouts Ltd.
Structural Engineers	Law Sue Davison Ltd.
Quantity Surveyors	Dean, Murray & Partners Ltd

drawn \*\* checked \*\*

scale **1:100 @ A1** date 23/07/2021

title

Site Plan 1:200 @ A3

drawin

# Development Application Not For Construction

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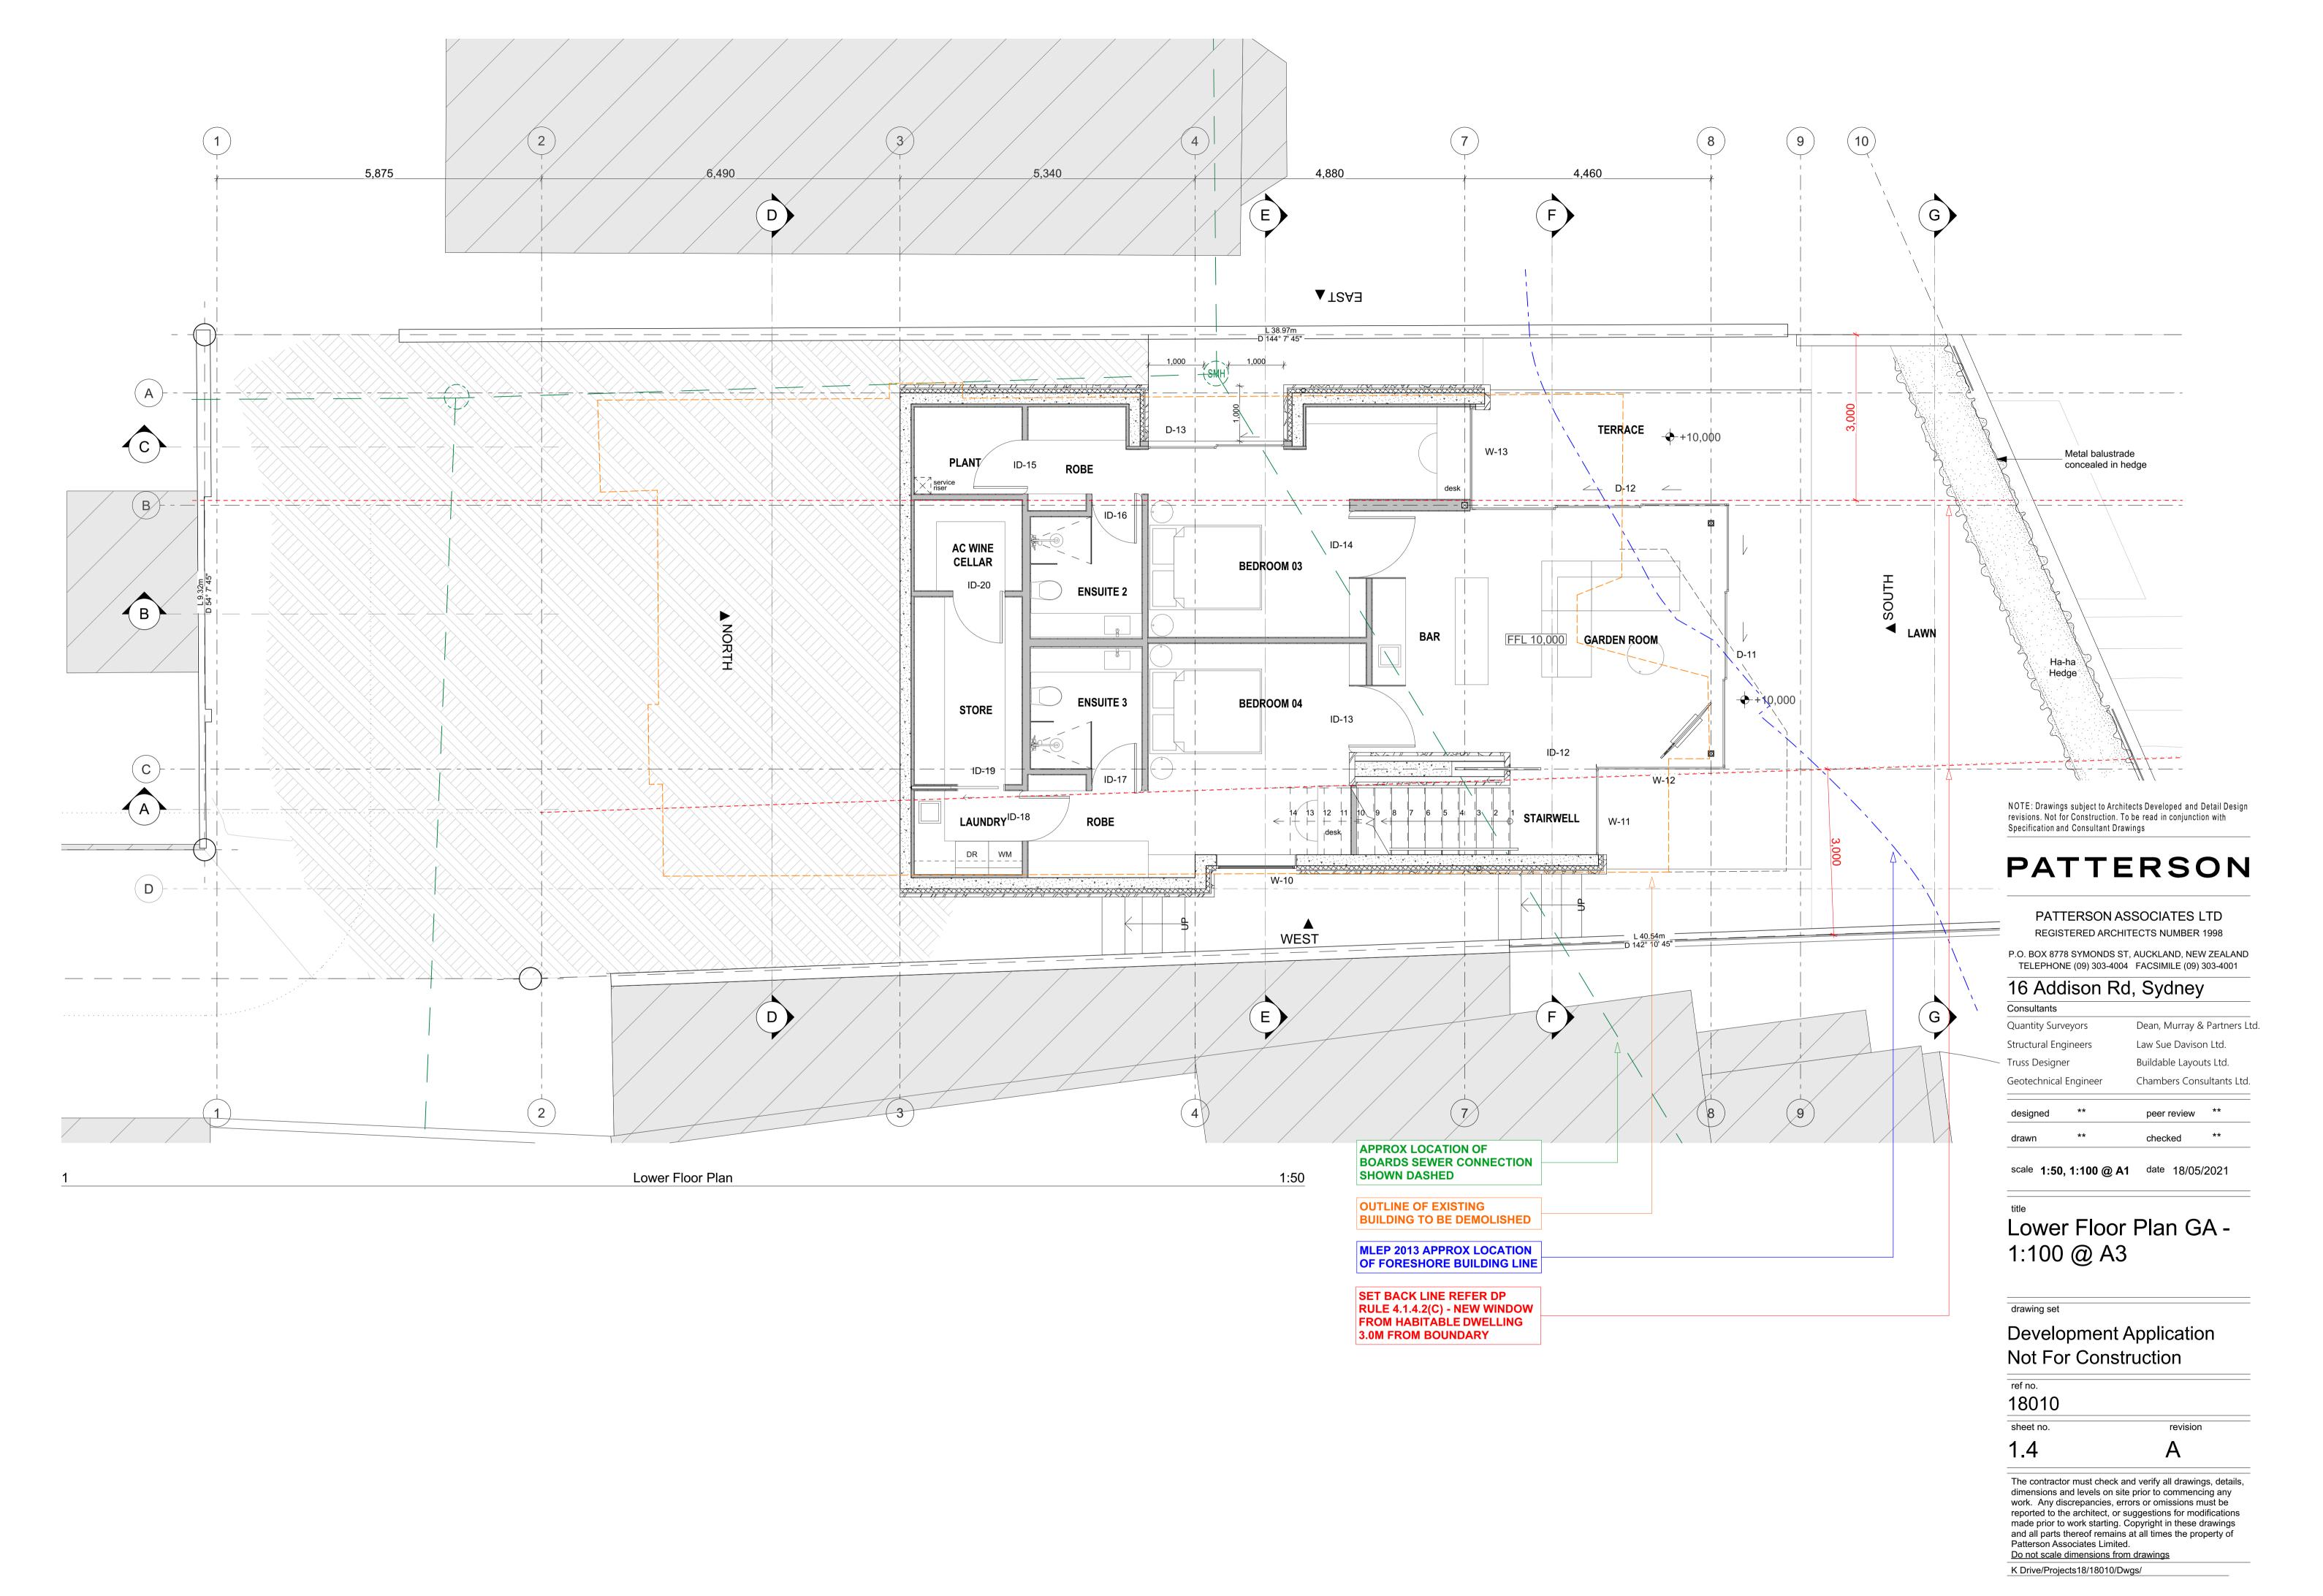
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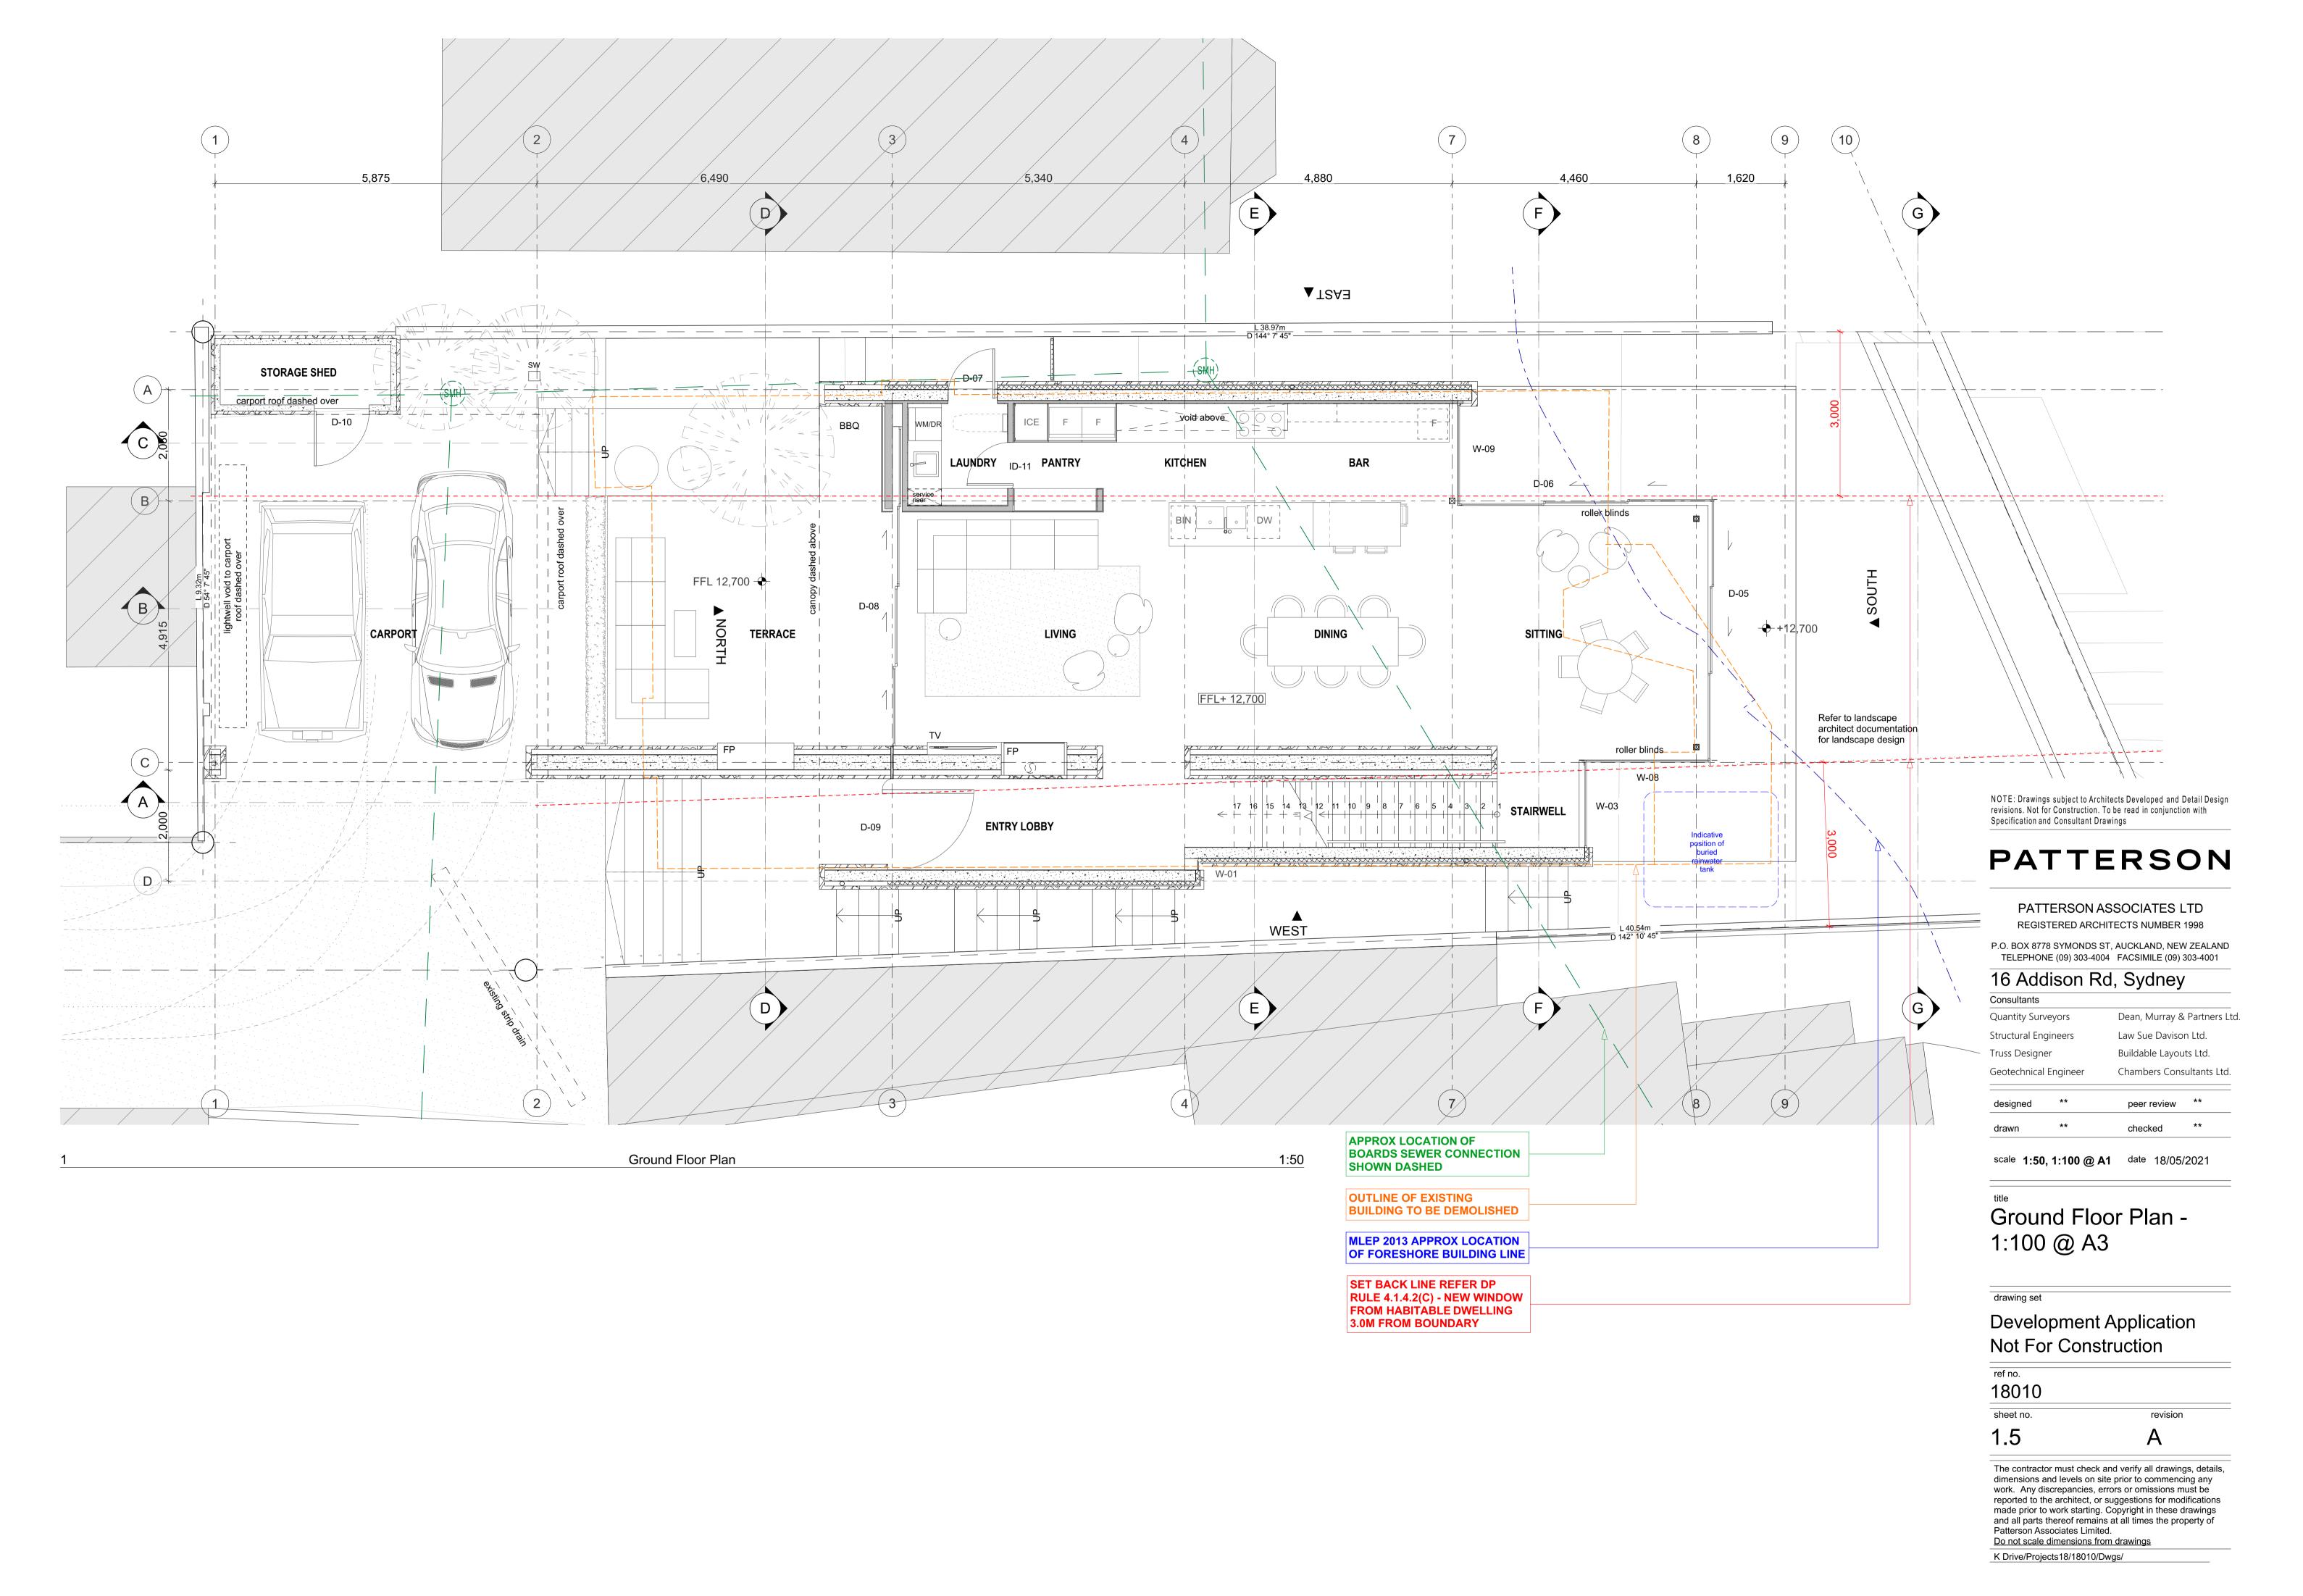
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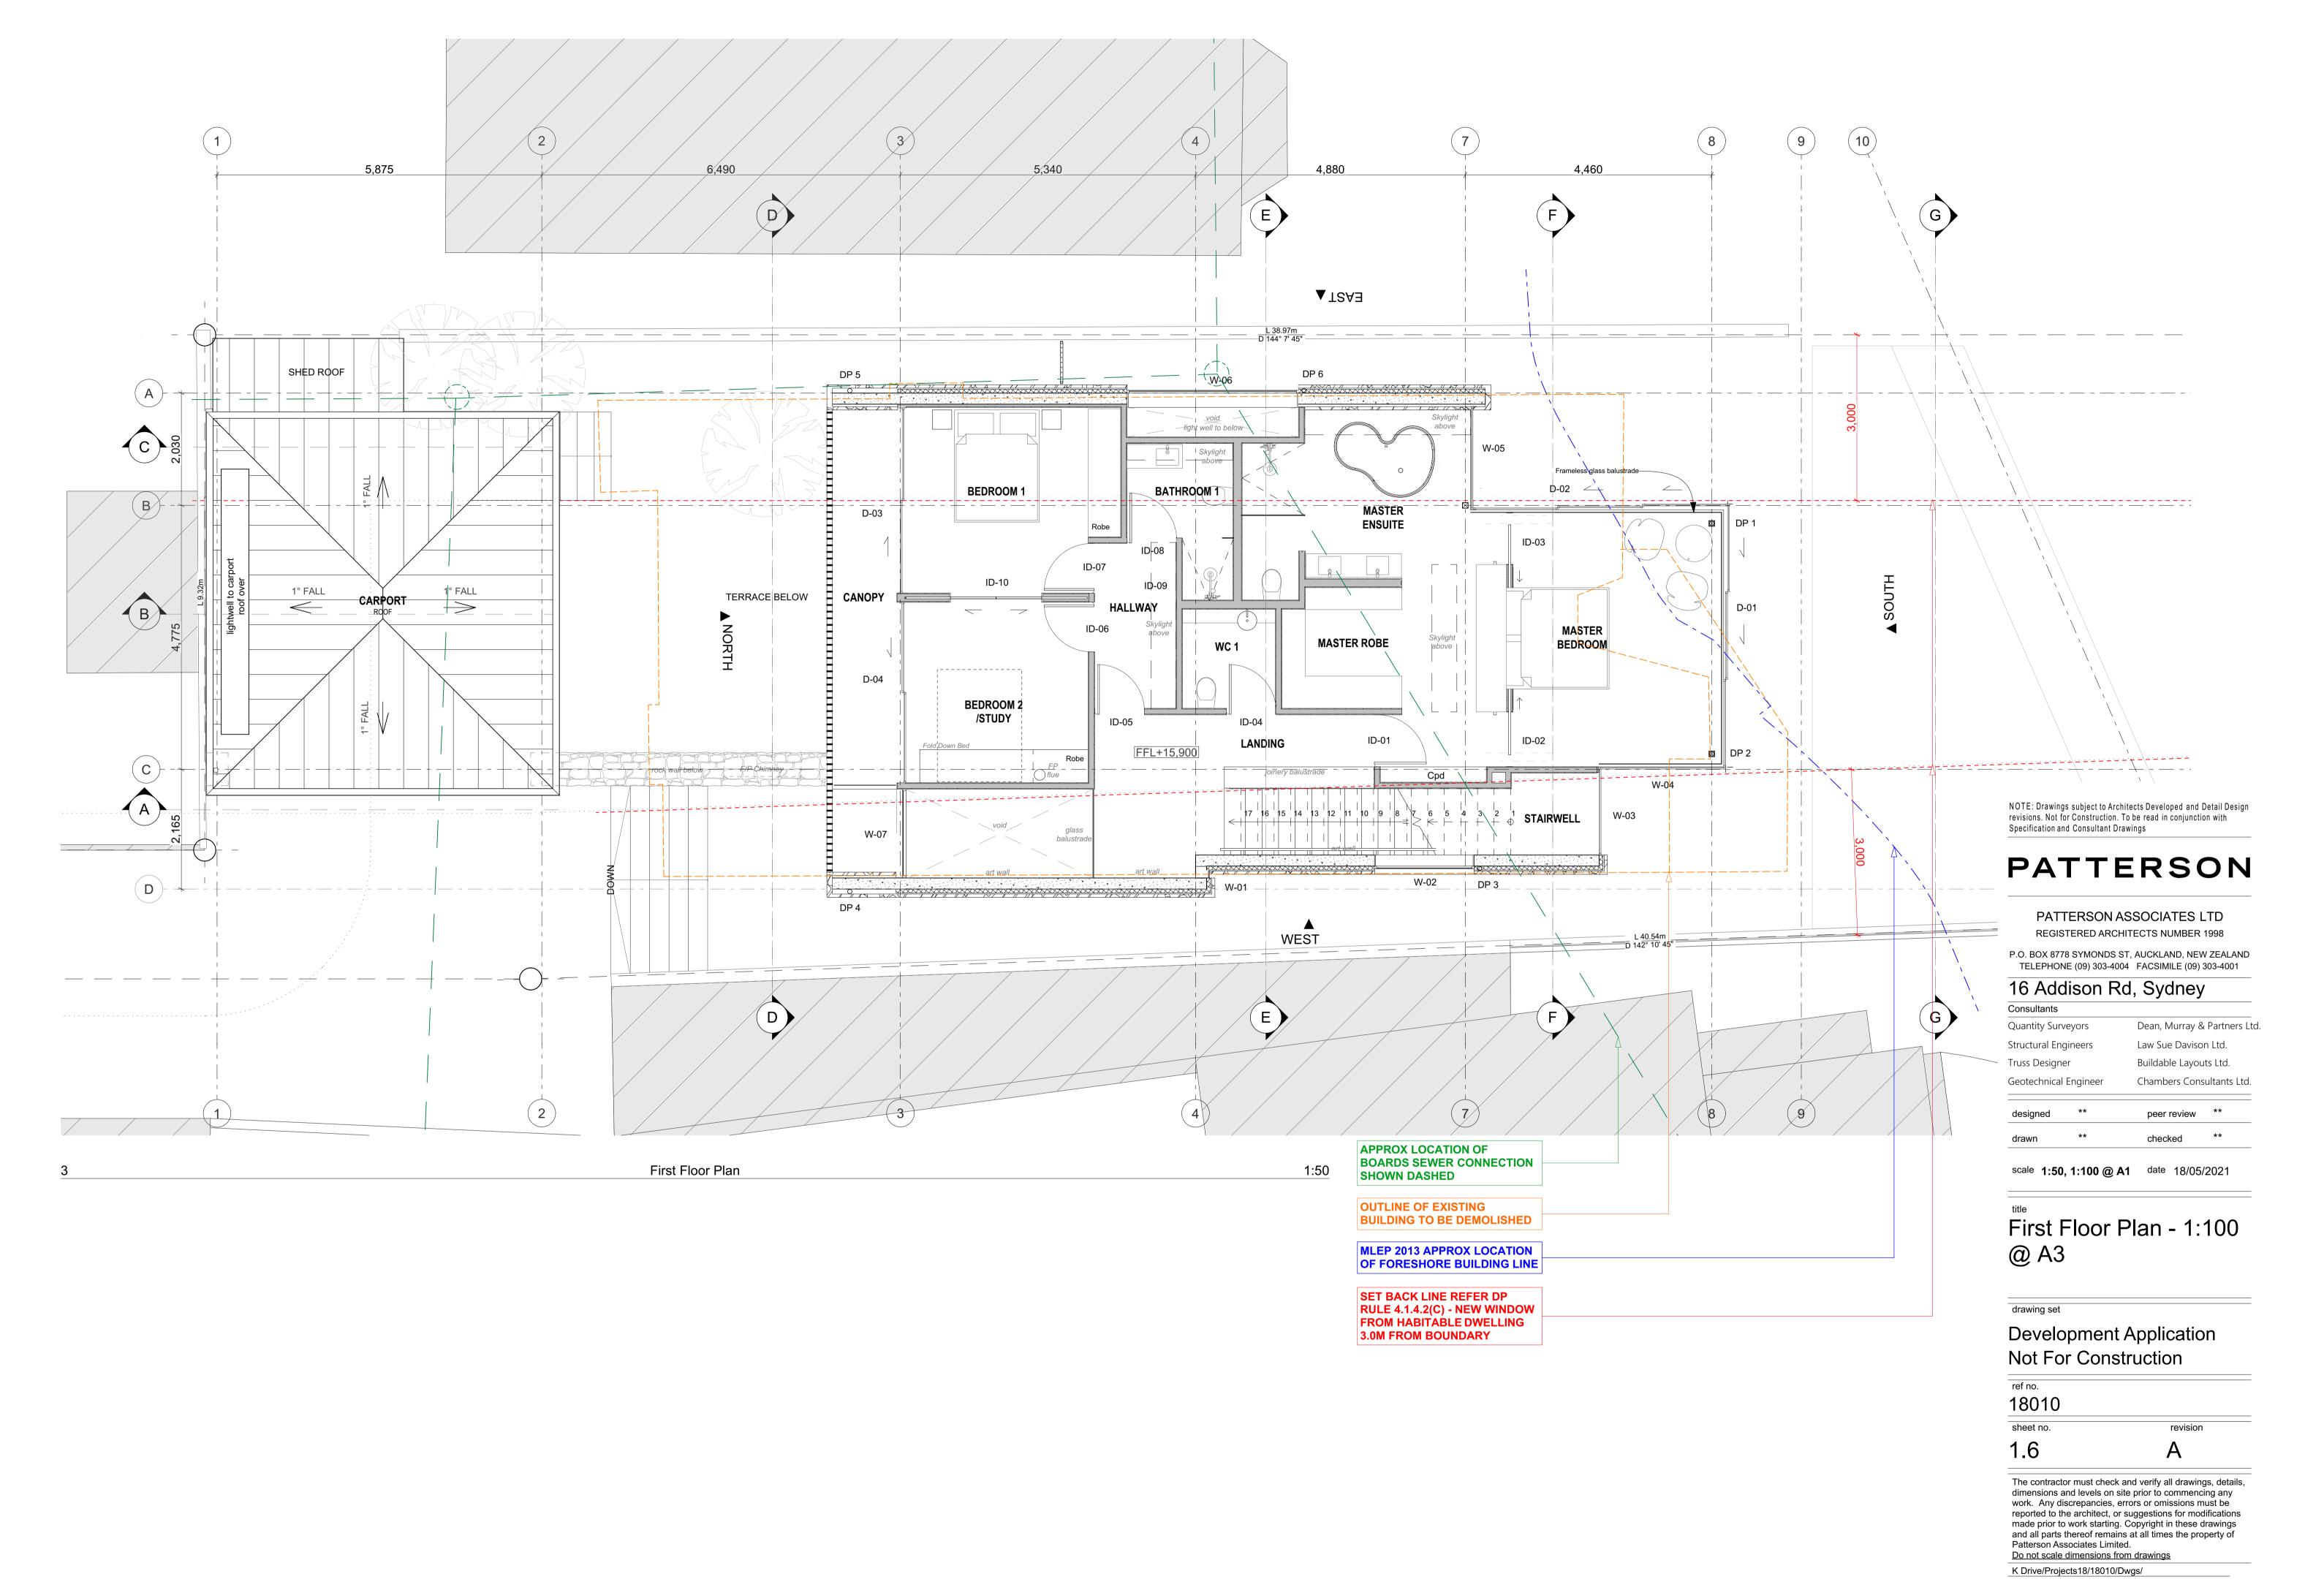
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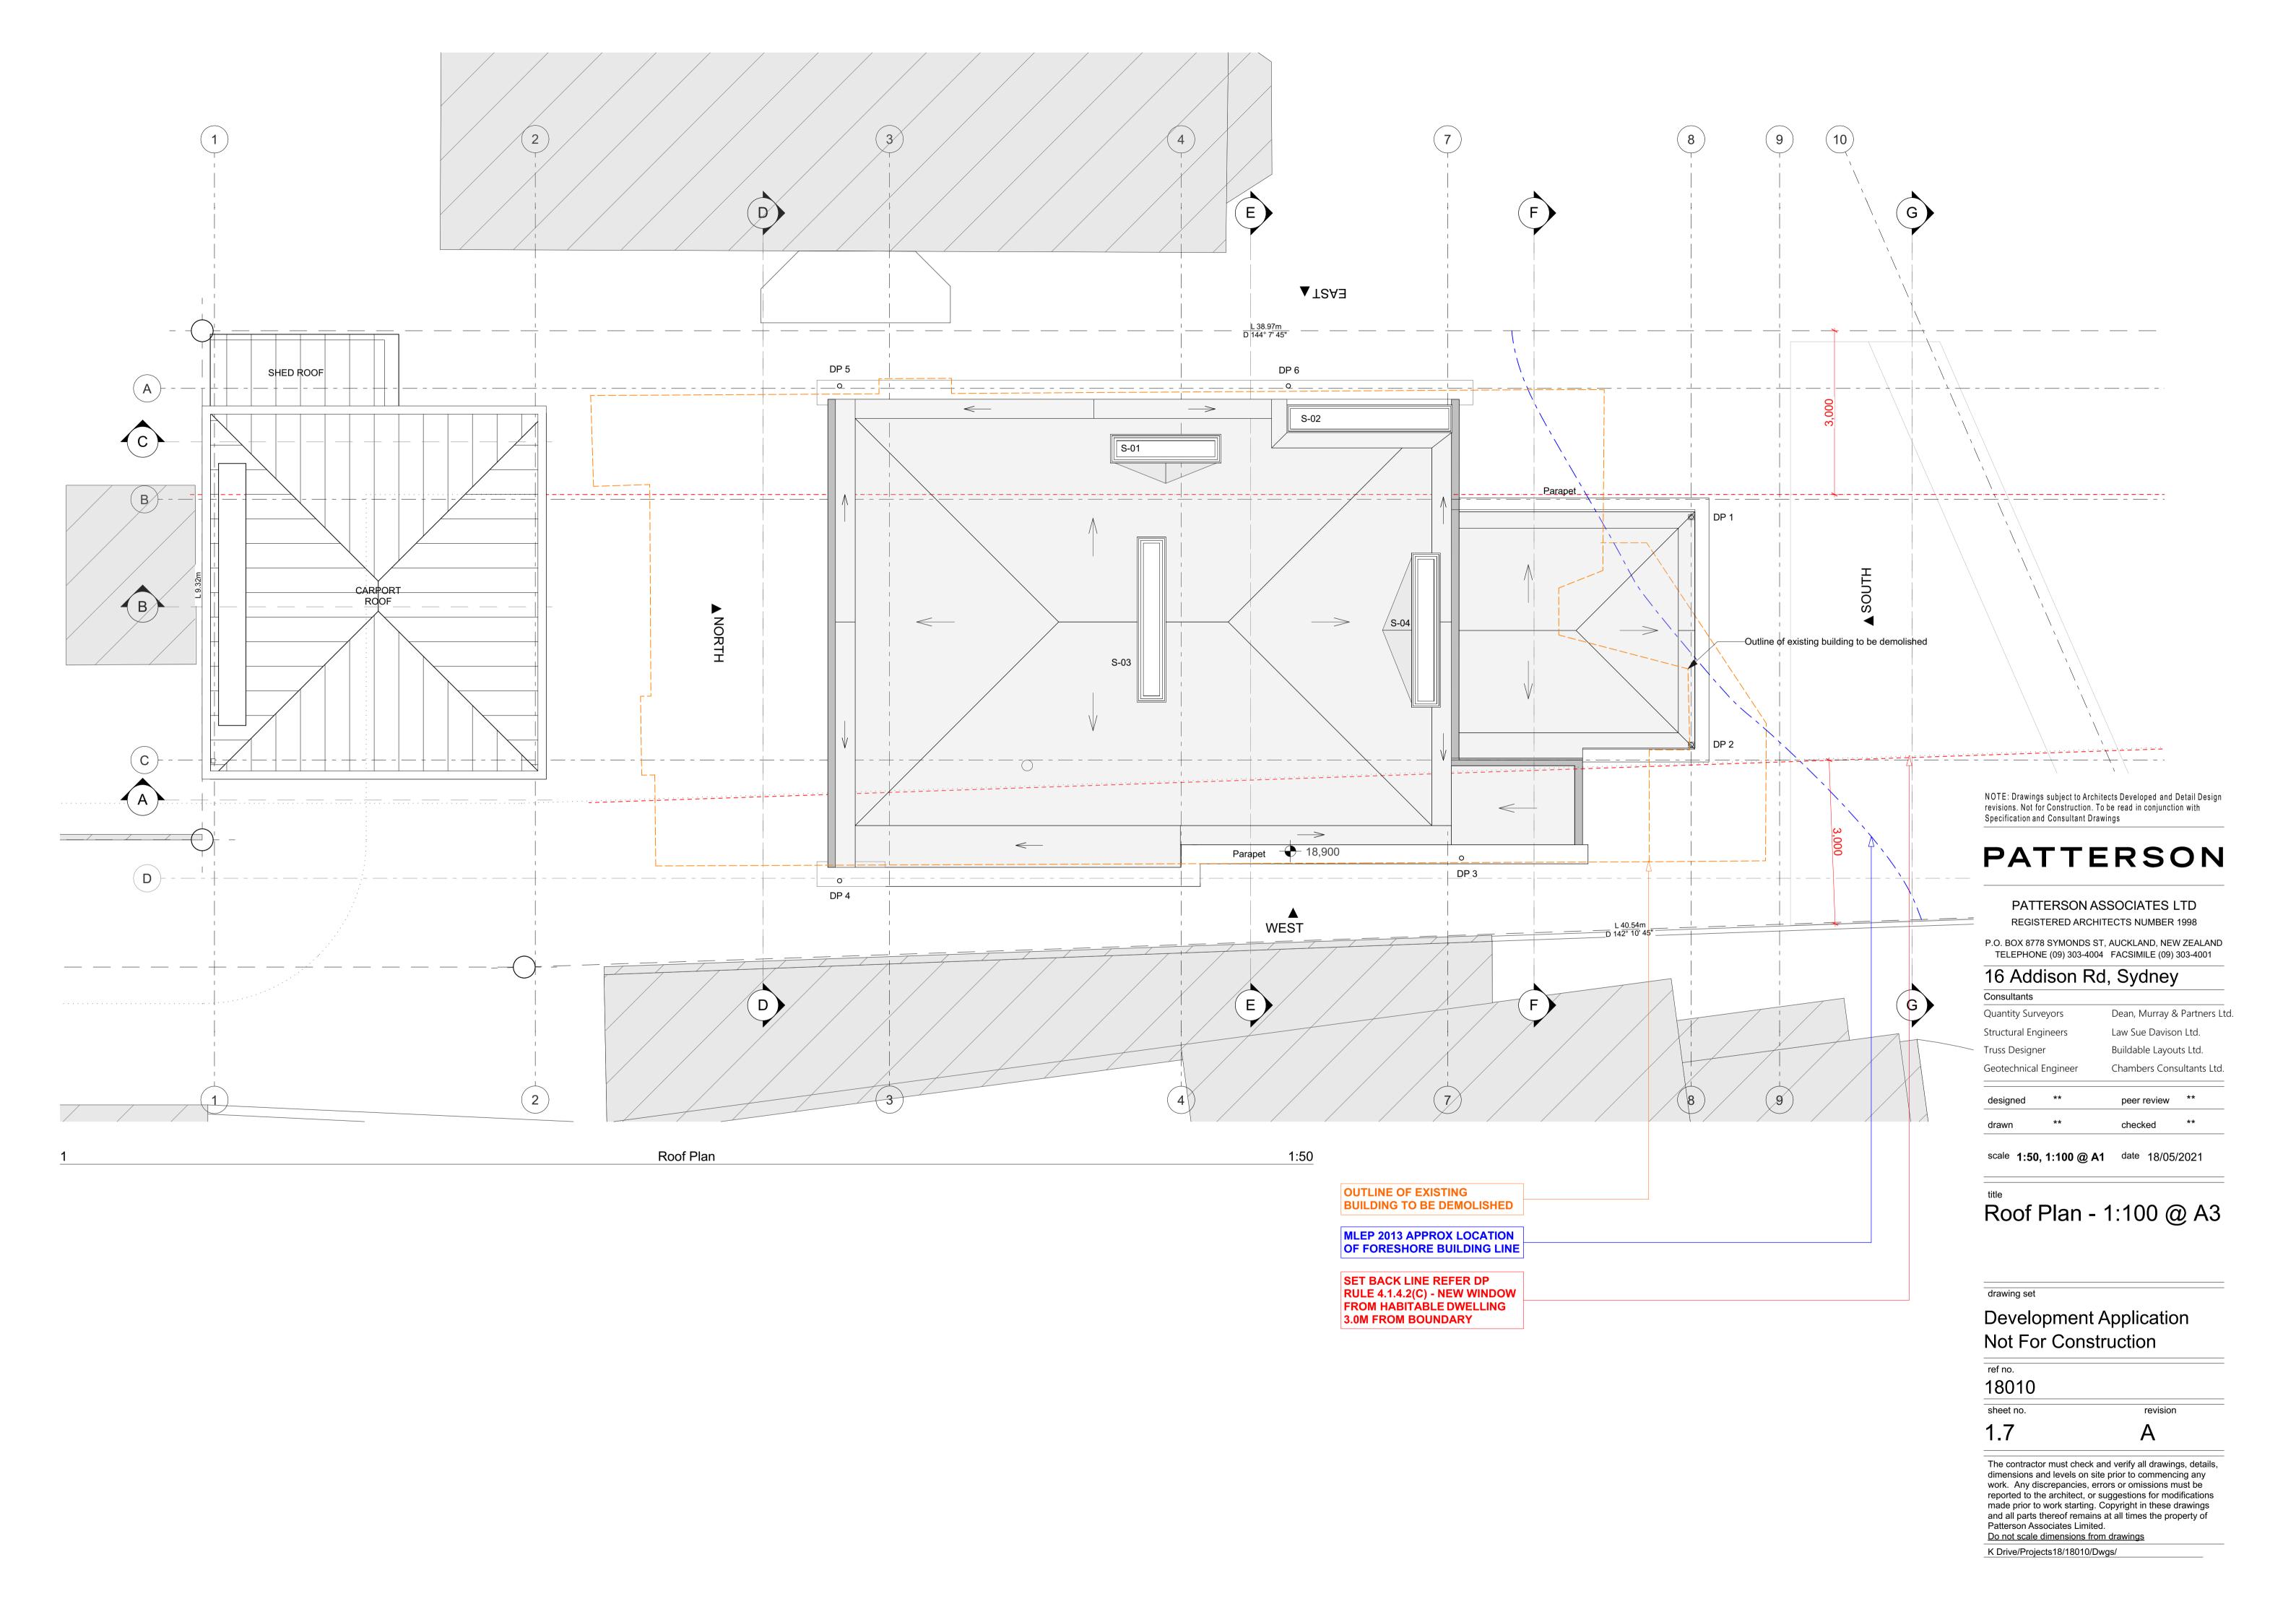
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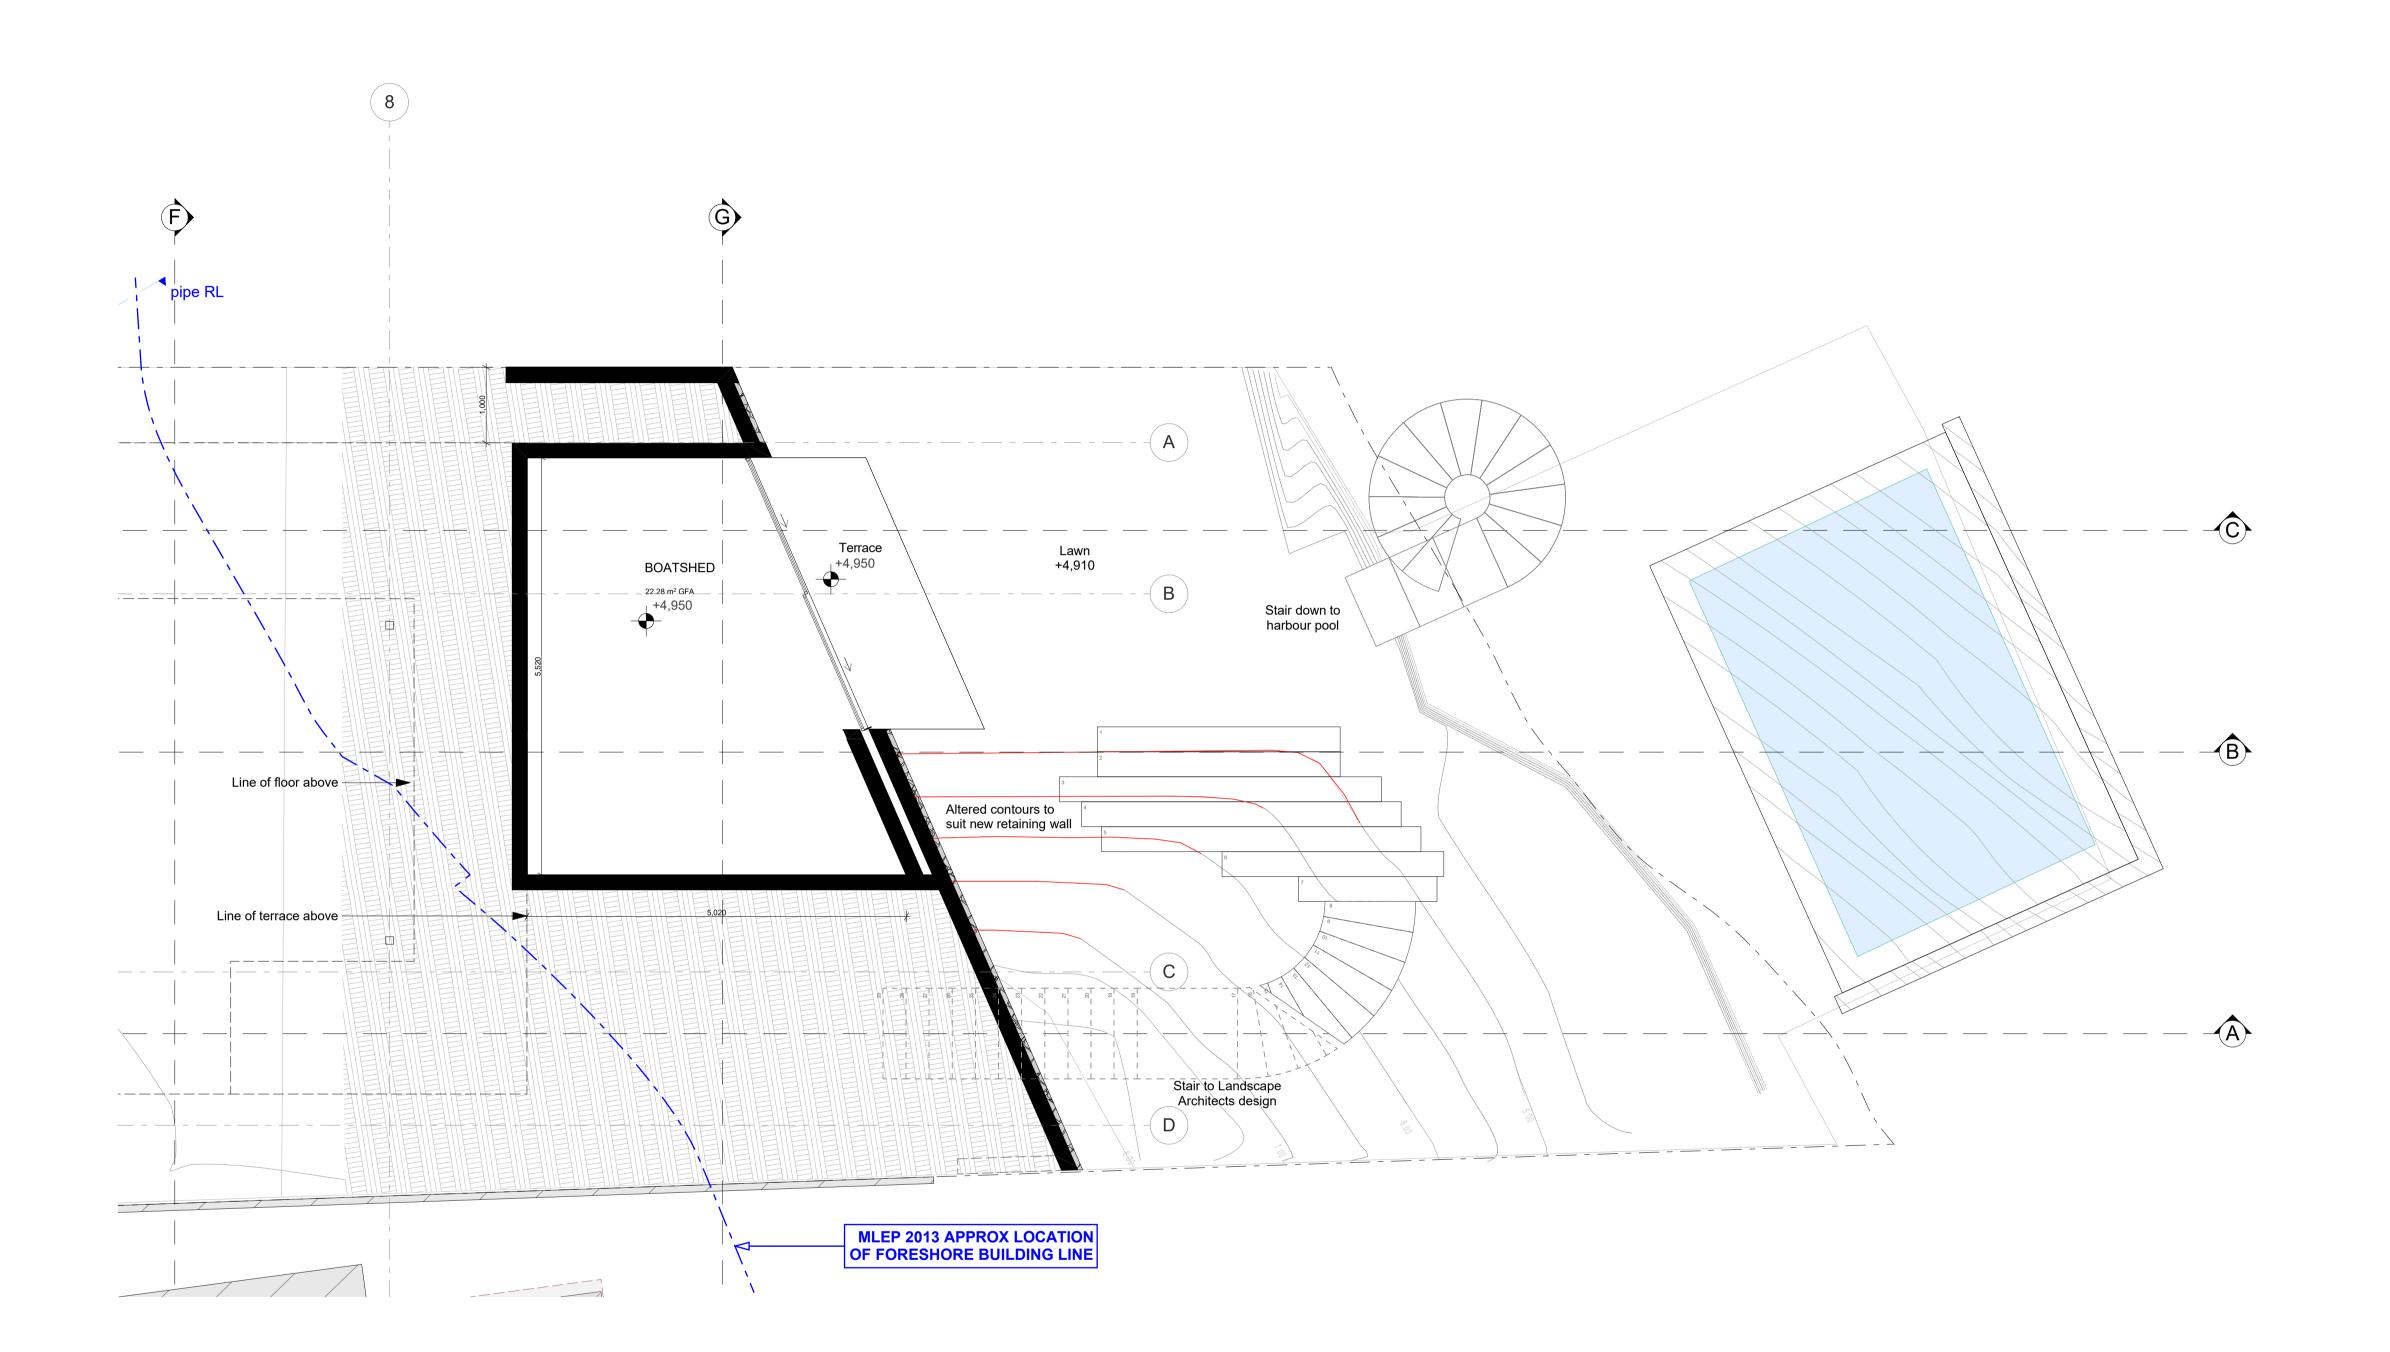
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Law Sue Davison Ltd.
Buildable Layouts Ltd.
Chambers Consultants Ltd.

designed	**	peer review	**
drawn	**	checked	**
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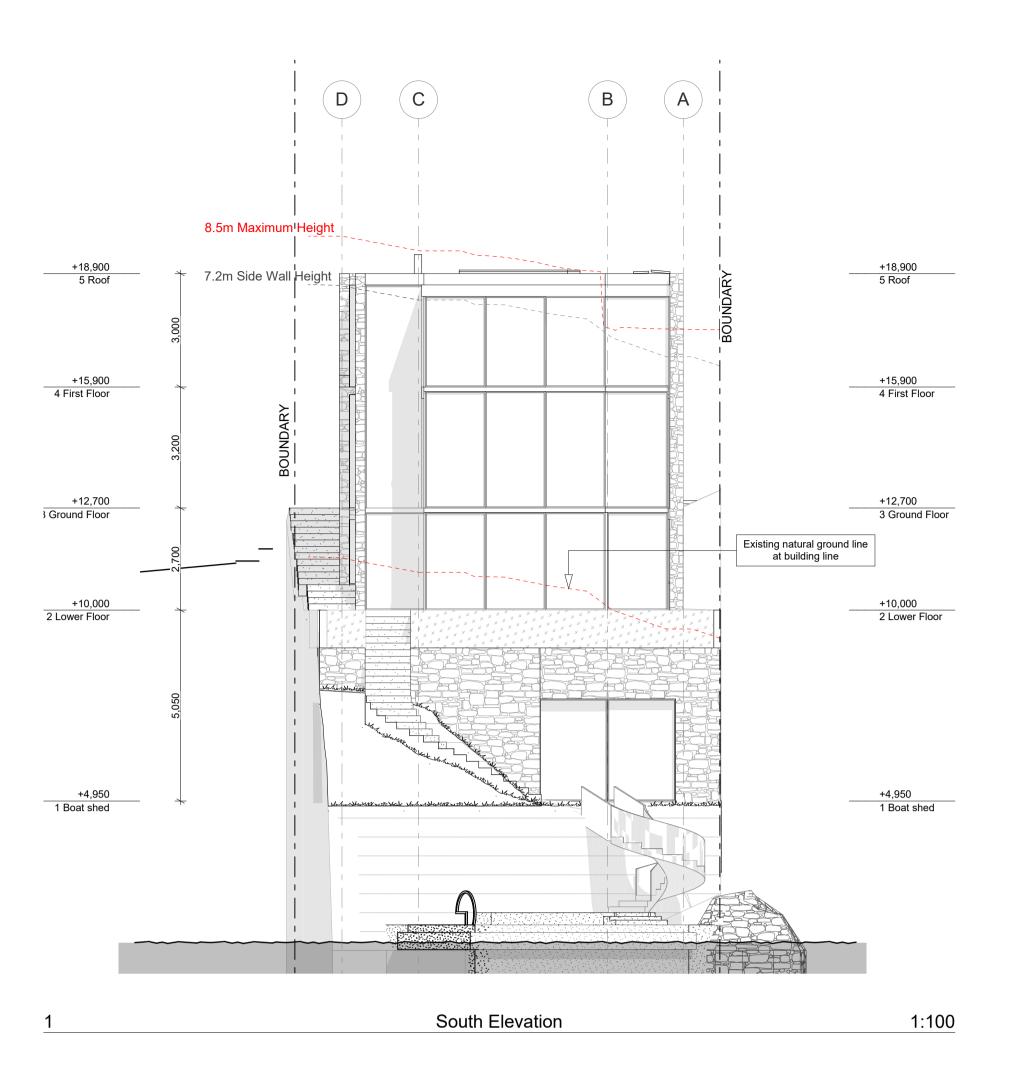
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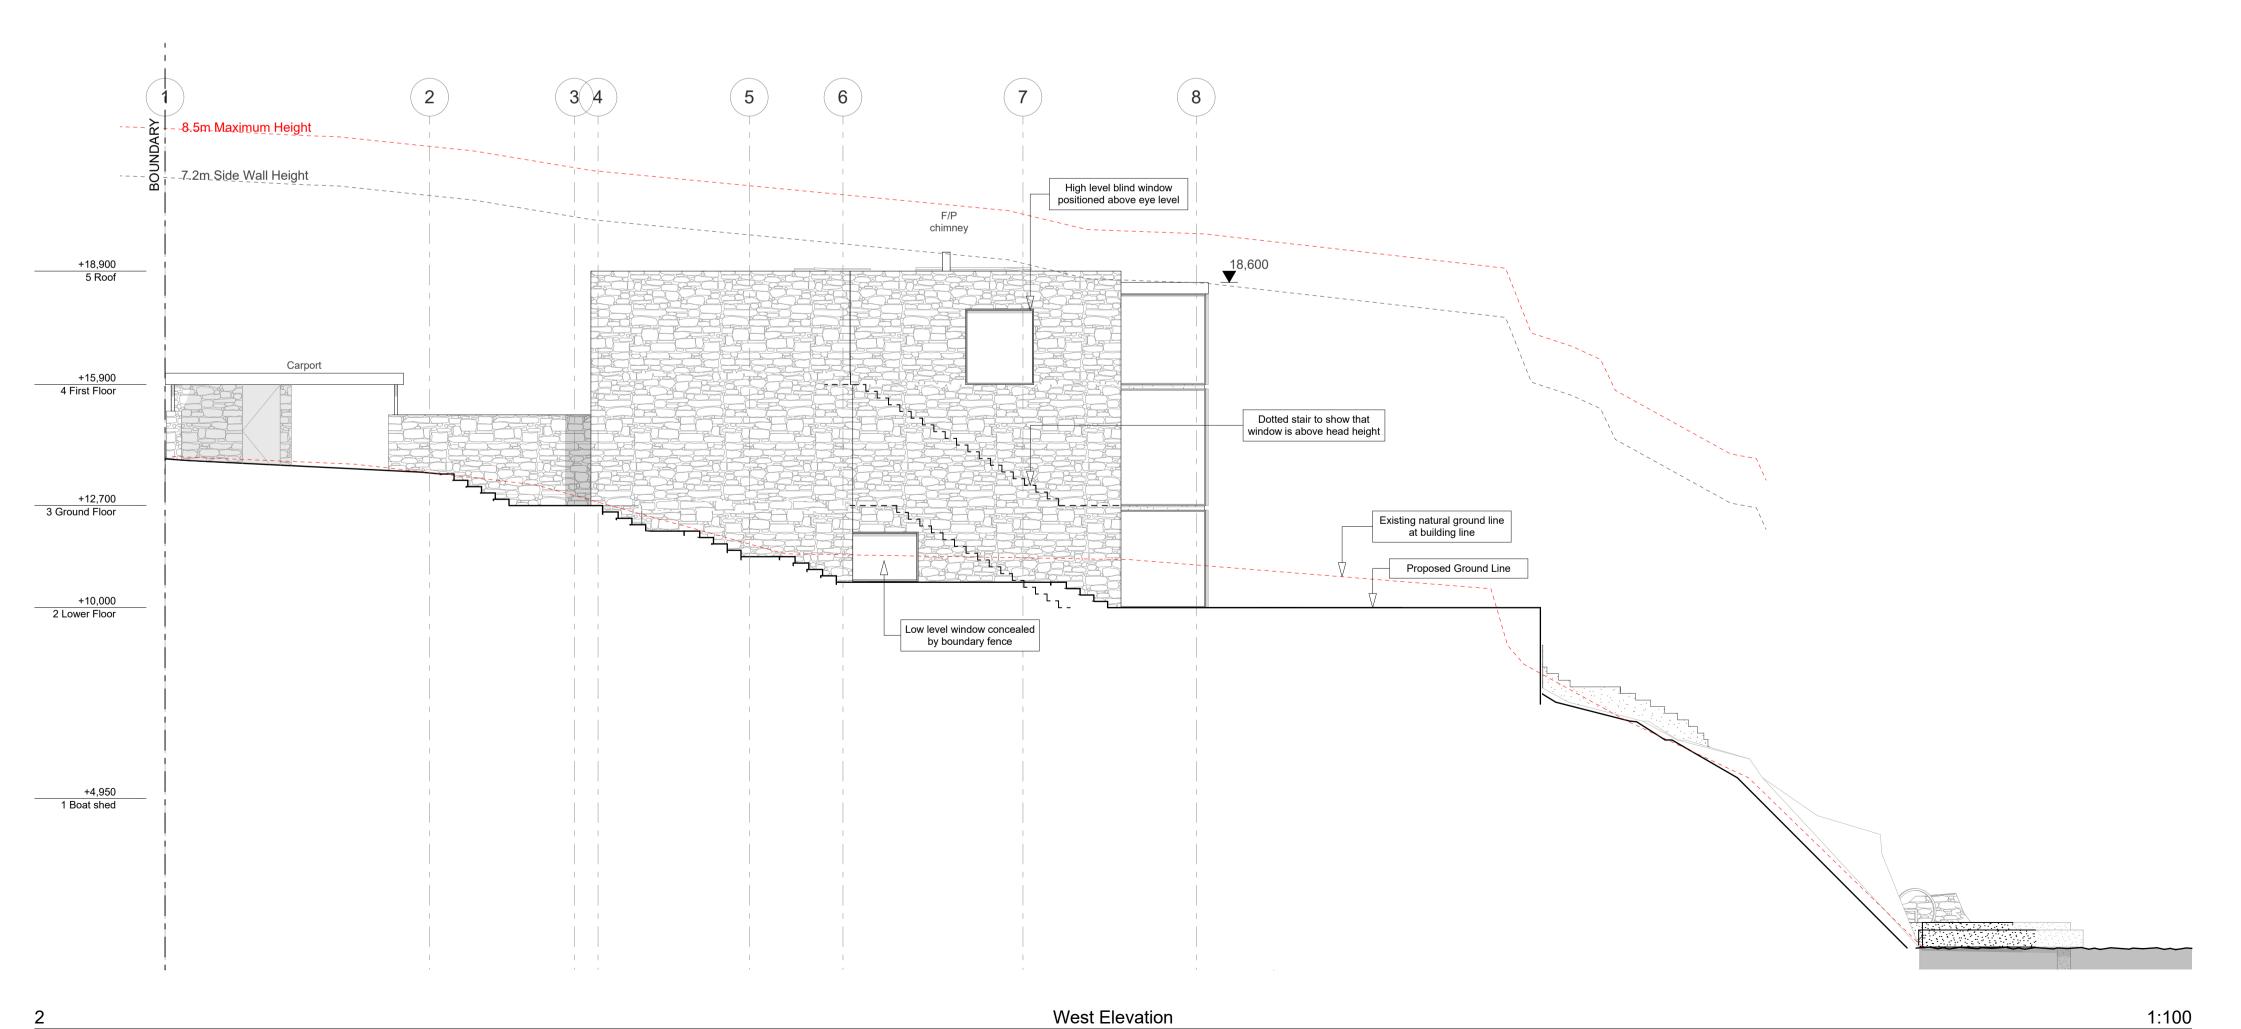
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drawn	**	checked	**
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Elevations - 1:200 @

drawing set


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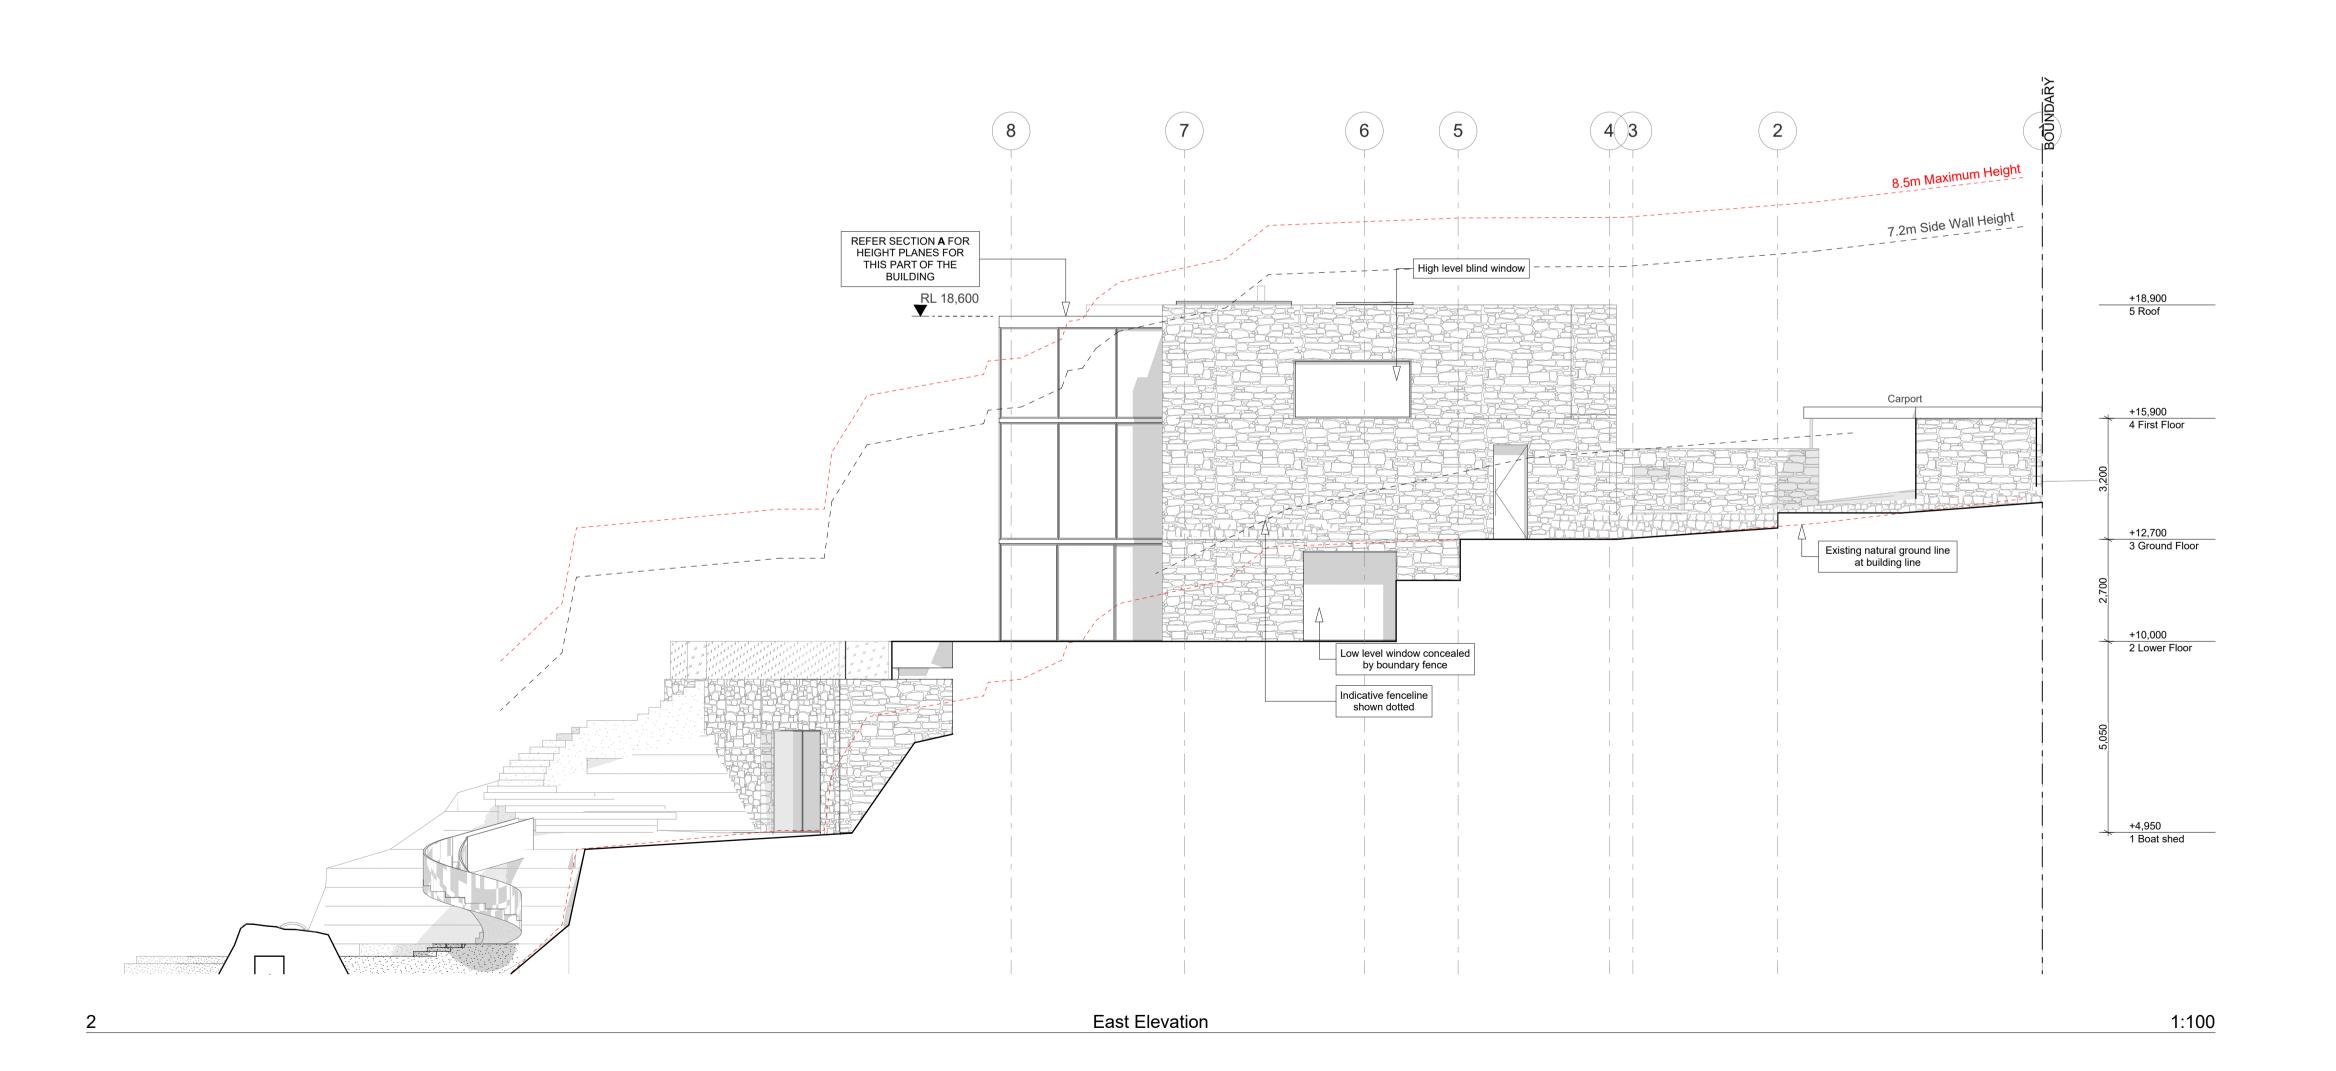
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designed	**	peer review	**
drawn	**	checked	**
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Elevations - 1:200 @ A3

drawing set

# Development Application Not For Construction

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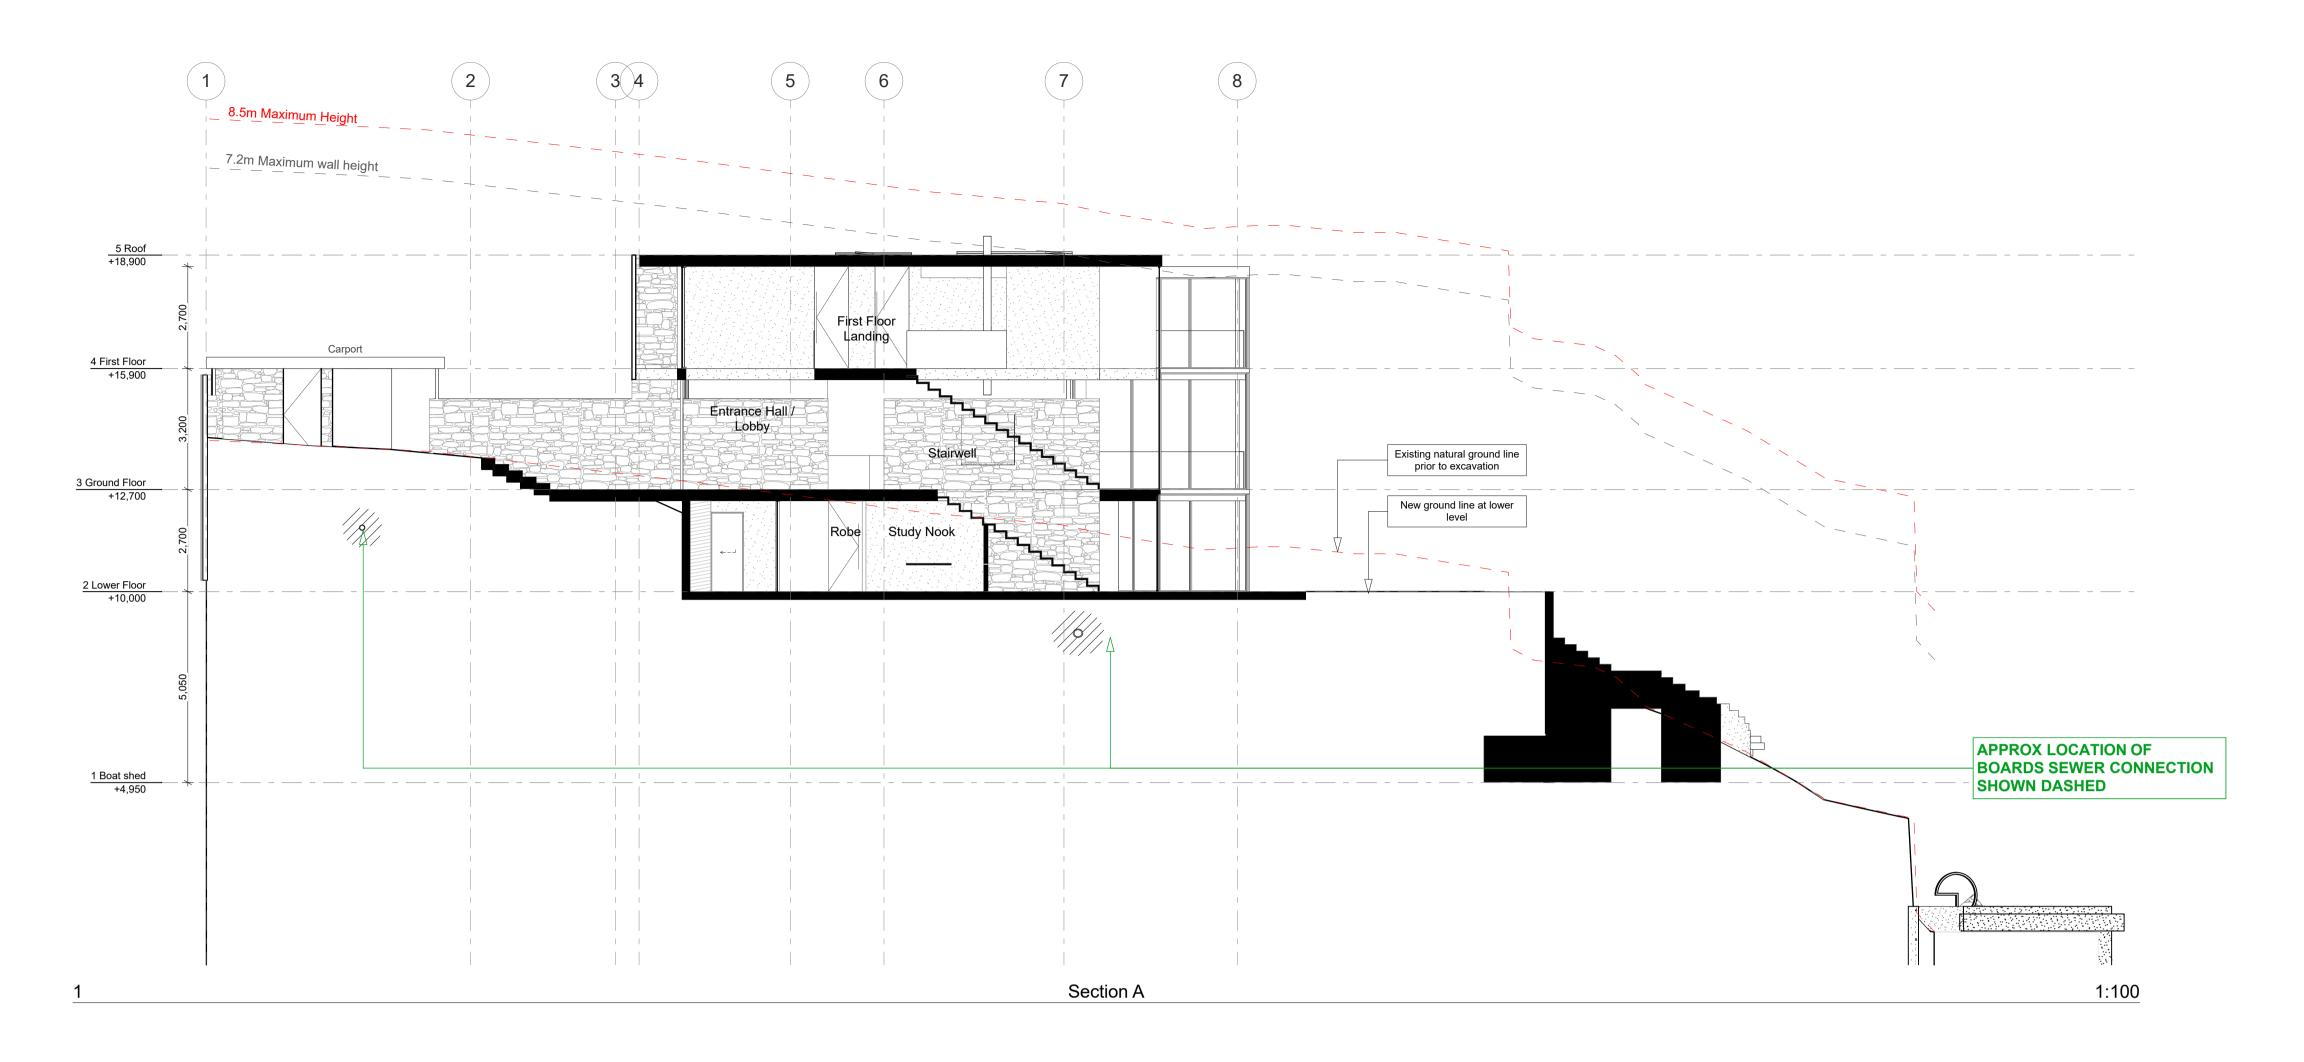
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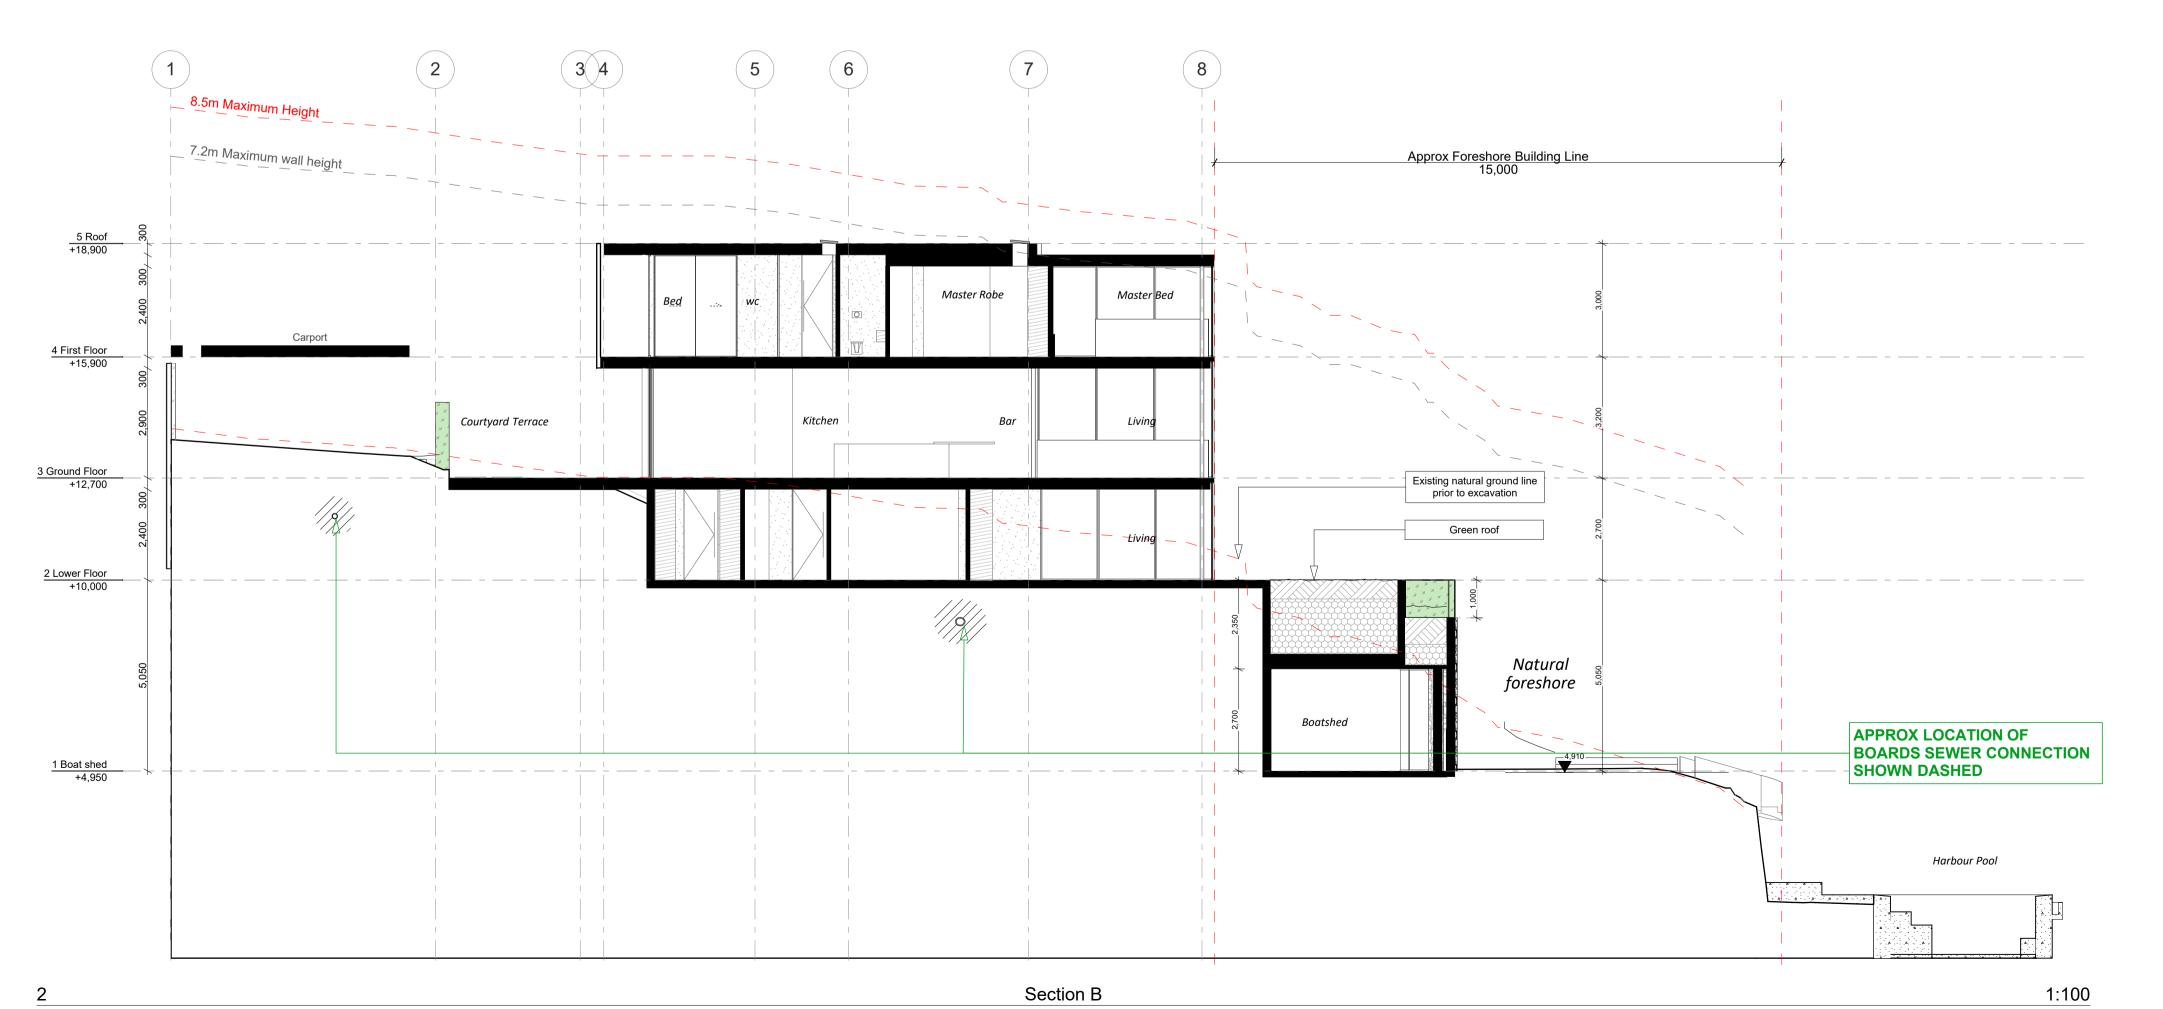
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Structural Engineers	Law Sue Davison Ltd.	
Truss Designer	Buildable Layouts Ltd.	
Geotechnical Engineer	Chambers Consultants Ltd.	

designed	**	peer review	^^
drawn	**	checked	**
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Sections - 1:200 @ A3
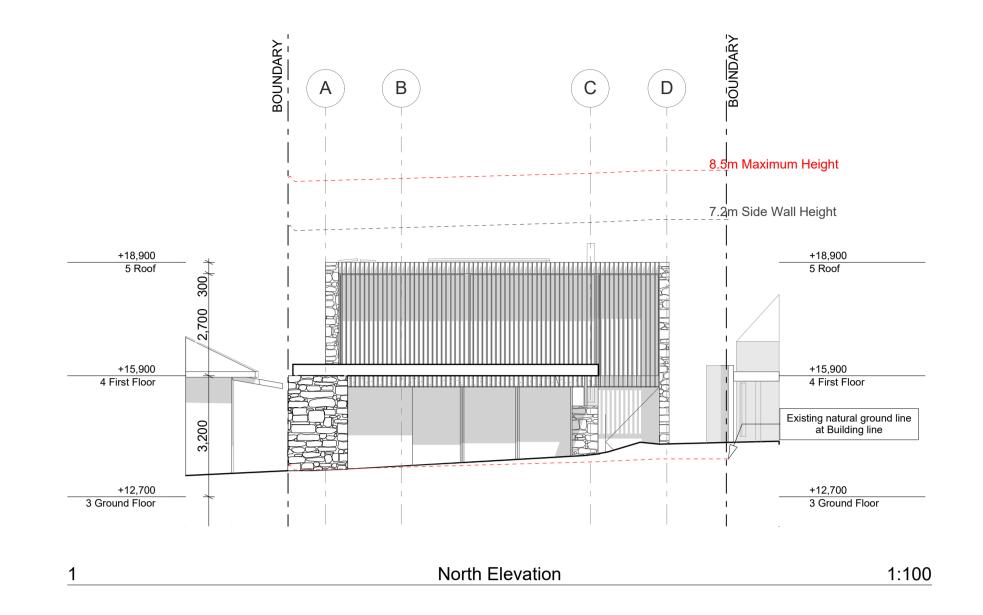
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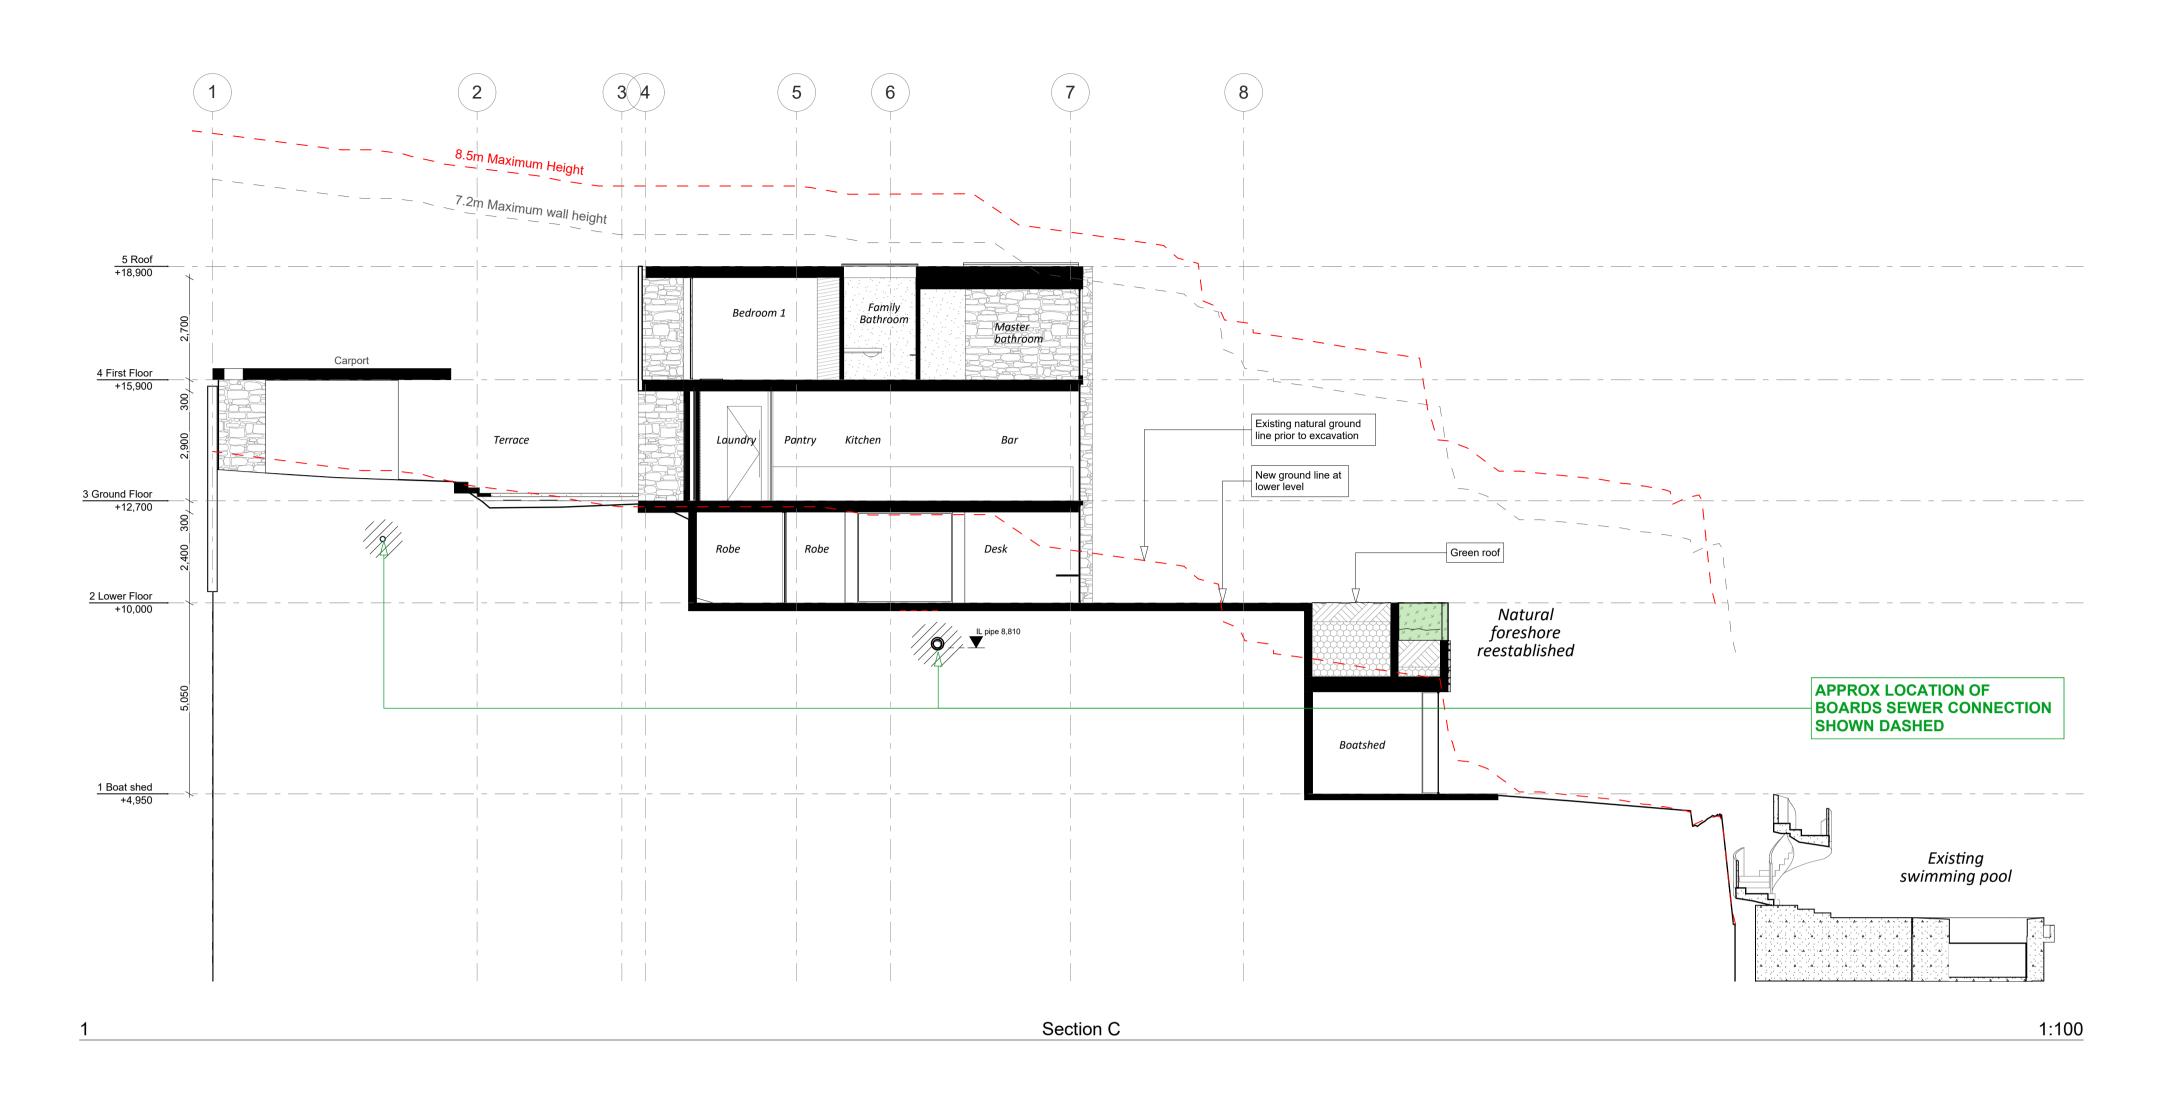
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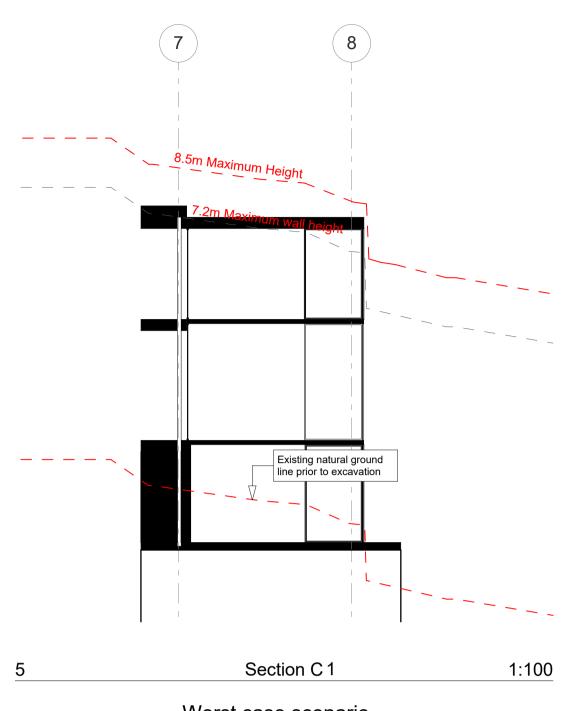
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Worst case scenario 8.5m max Height

revisions. Not for Construction. To be read in conjunction with Specification and Consultant Drawings

NOTE: Drawings subject to Architects Developed and Detail Design

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o o no antanto		
Quantity Surveyors	Dean, Murray & Partners L	
Structural Engineers	Law Sue Davison Ltd.	
Truss Designer	Buildable Layouts Ltd.	
Geotechnical Engineer	Chambers Consultants Ltd	
designed **	peer review **	
drawn **	checked **	
scale 1:100 @ A1	date 21/12/2020	

Sections - 1:200 @ A3


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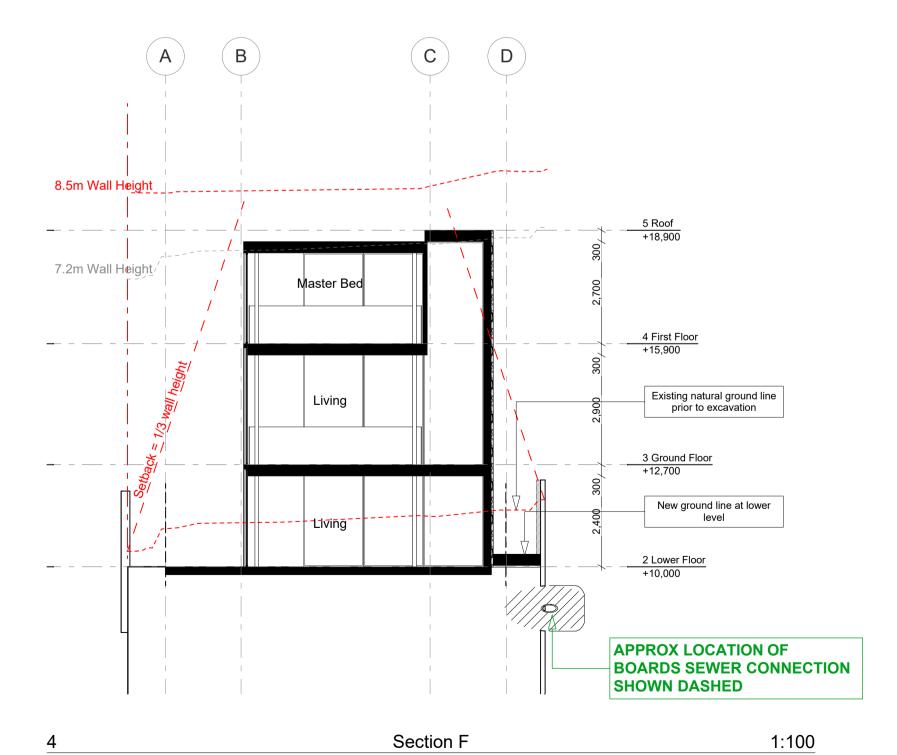
# Development Application Not For Construction

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8.5m Rolling Height Plane - SW View





7.2m Wall Height Plane - SW View

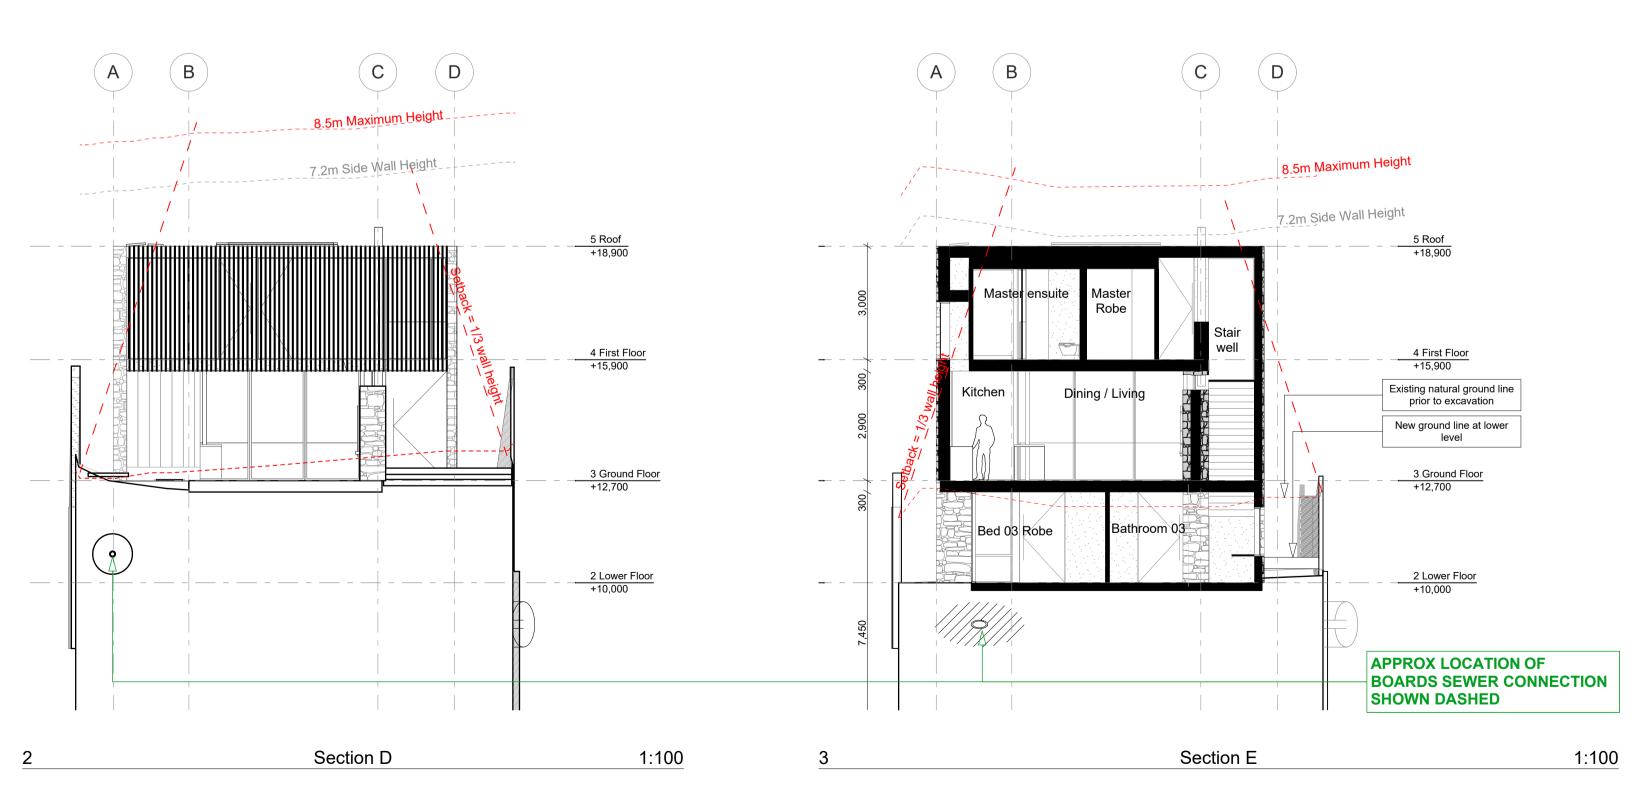1/3 Boundary Setback - SW View

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Ι.	designed **	peer review **
	Geotechnical Engineer	Chambers Consultants Ltd
T	Truss Designer	Buildable Layouts Ltd.
S	Structural Engineers	Law Sue Davison Ltd.
	Quantity Surveyors	Dean, Murray & Partners I

checked scale @ A1 date 21/12/2020

### Setback & building height diagram

drawing set


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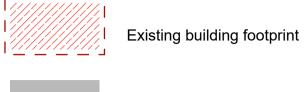
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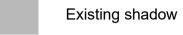
18010 sheet no.

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Additional shadow



Primary private open space

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Geotechnical Engineer	Chambers Consultants Ltd.

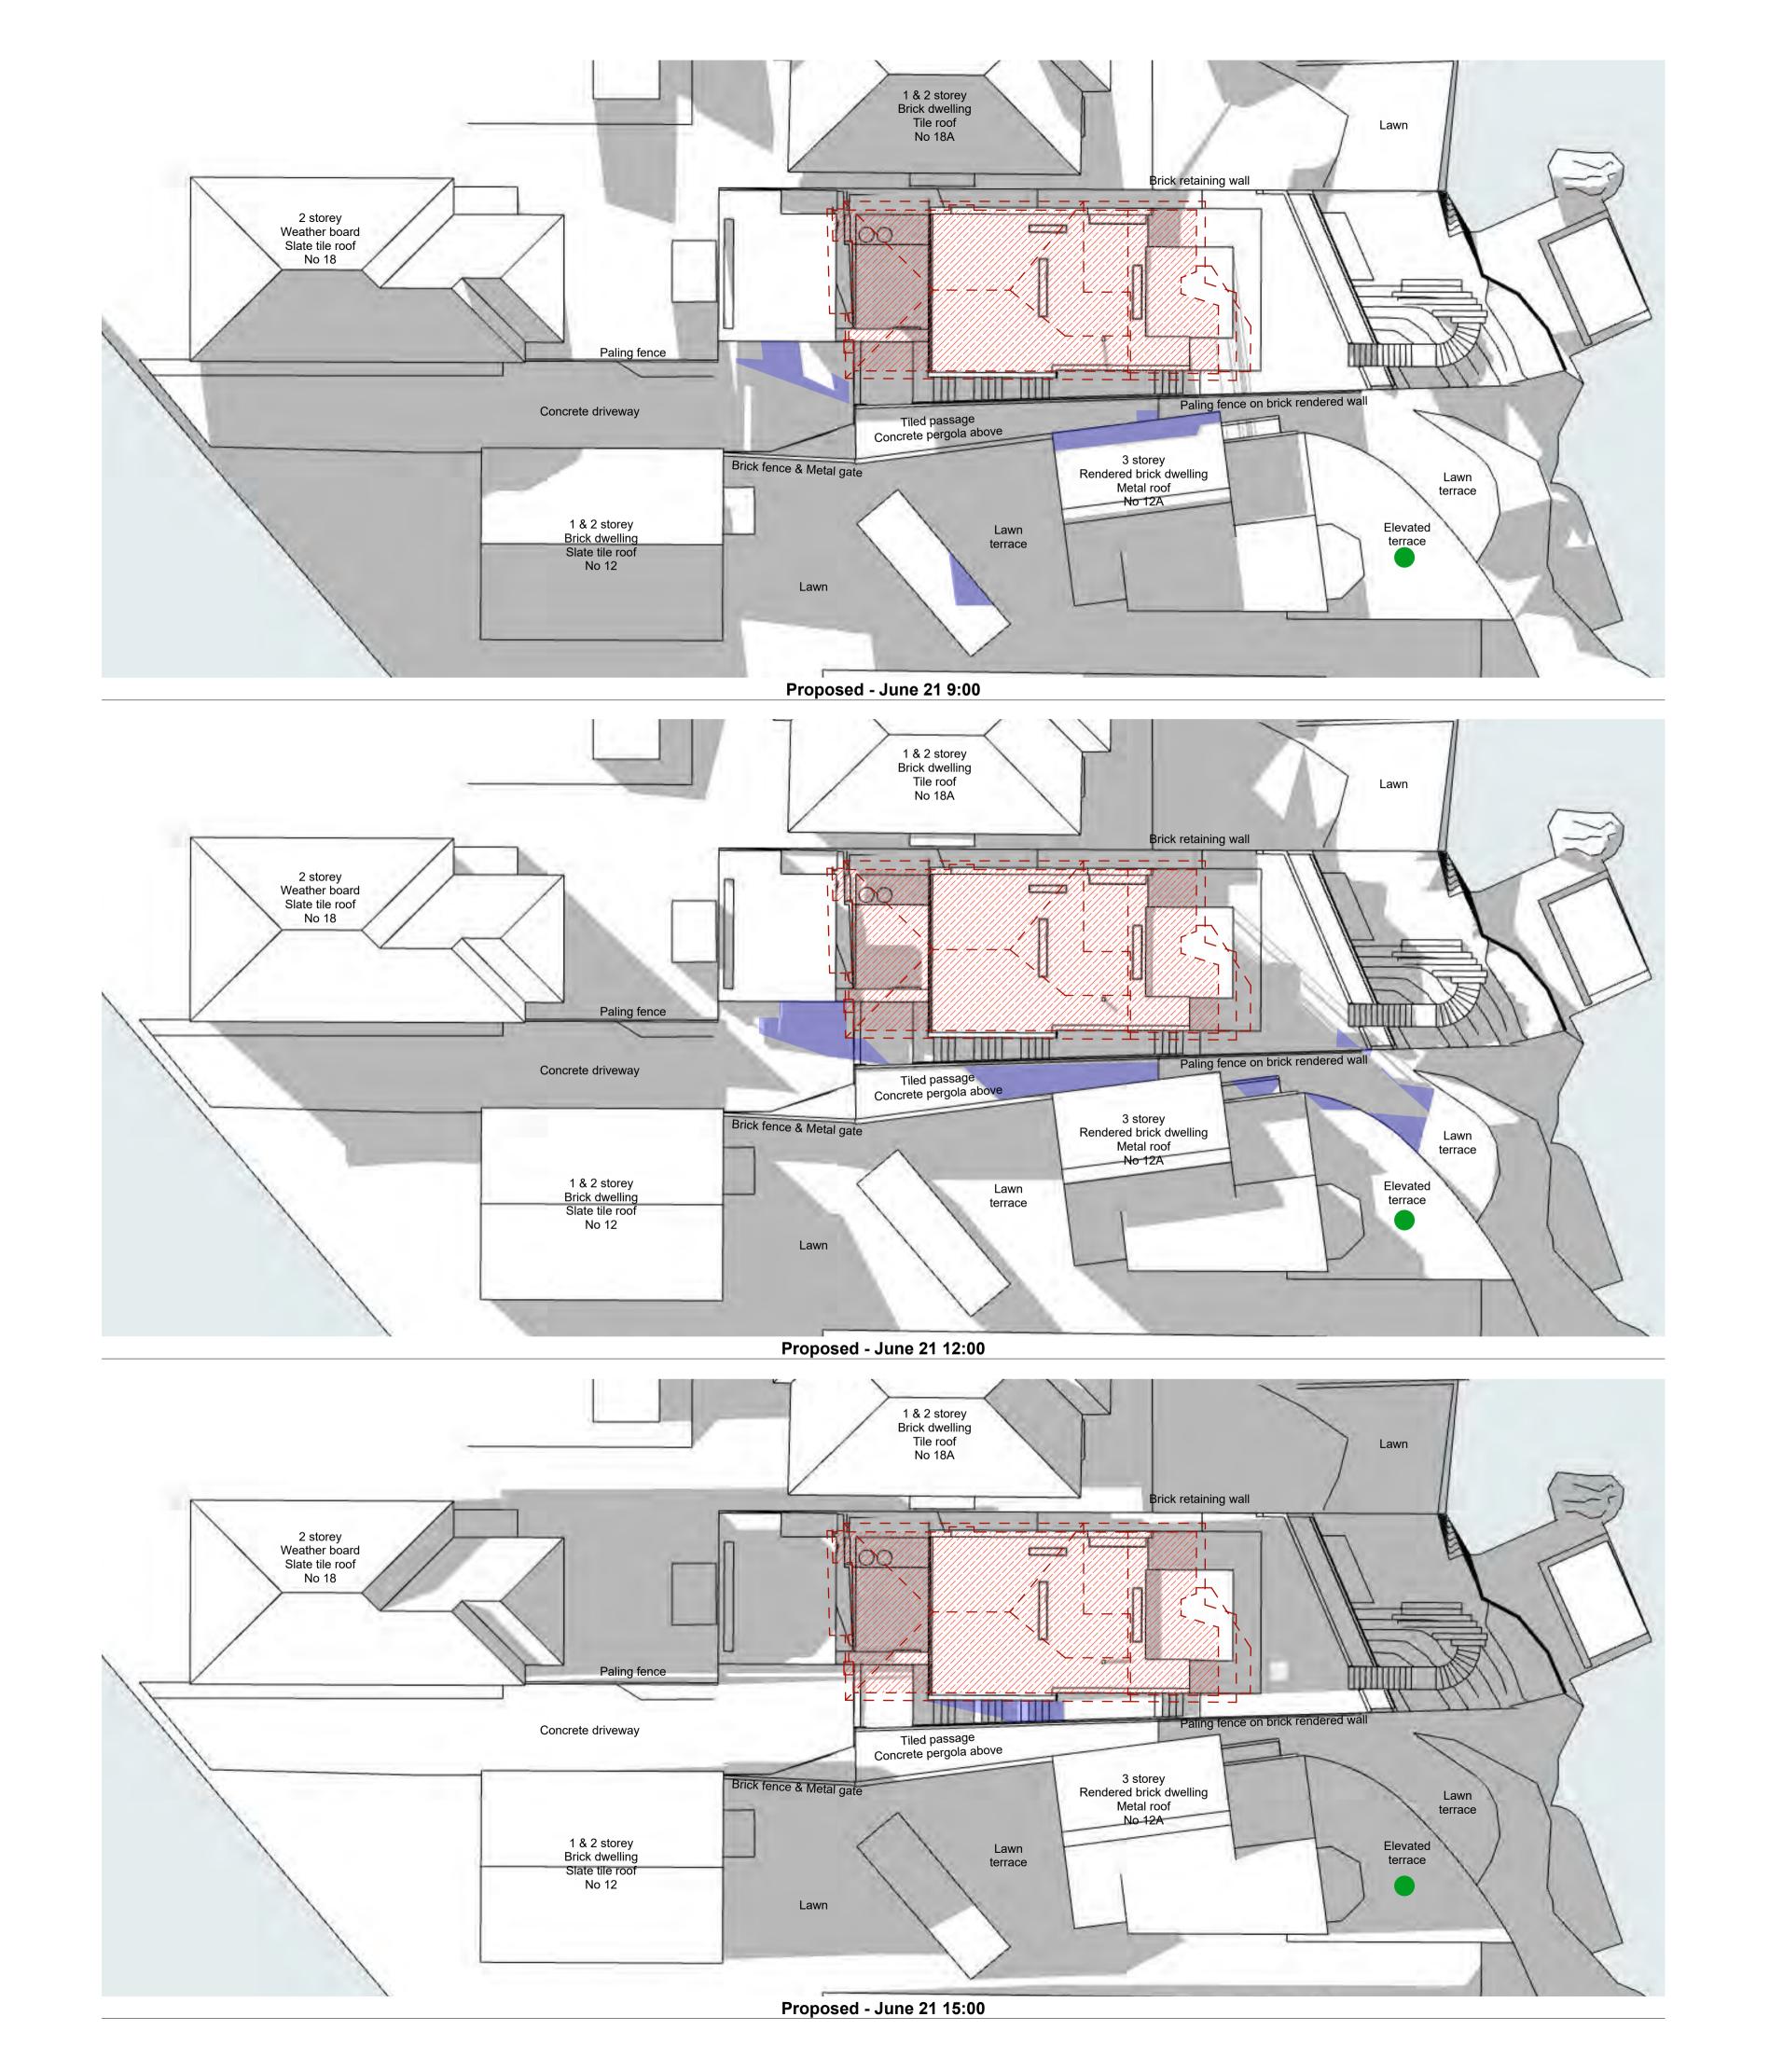designed	**	peer review	**
drawn	**	checked	**
scale 1:1	00 @ A1	date 21/12/	2020

### Shadow Diagram Plans June 21

drawing set

# Development Application Not For Construction

ref no. 18010

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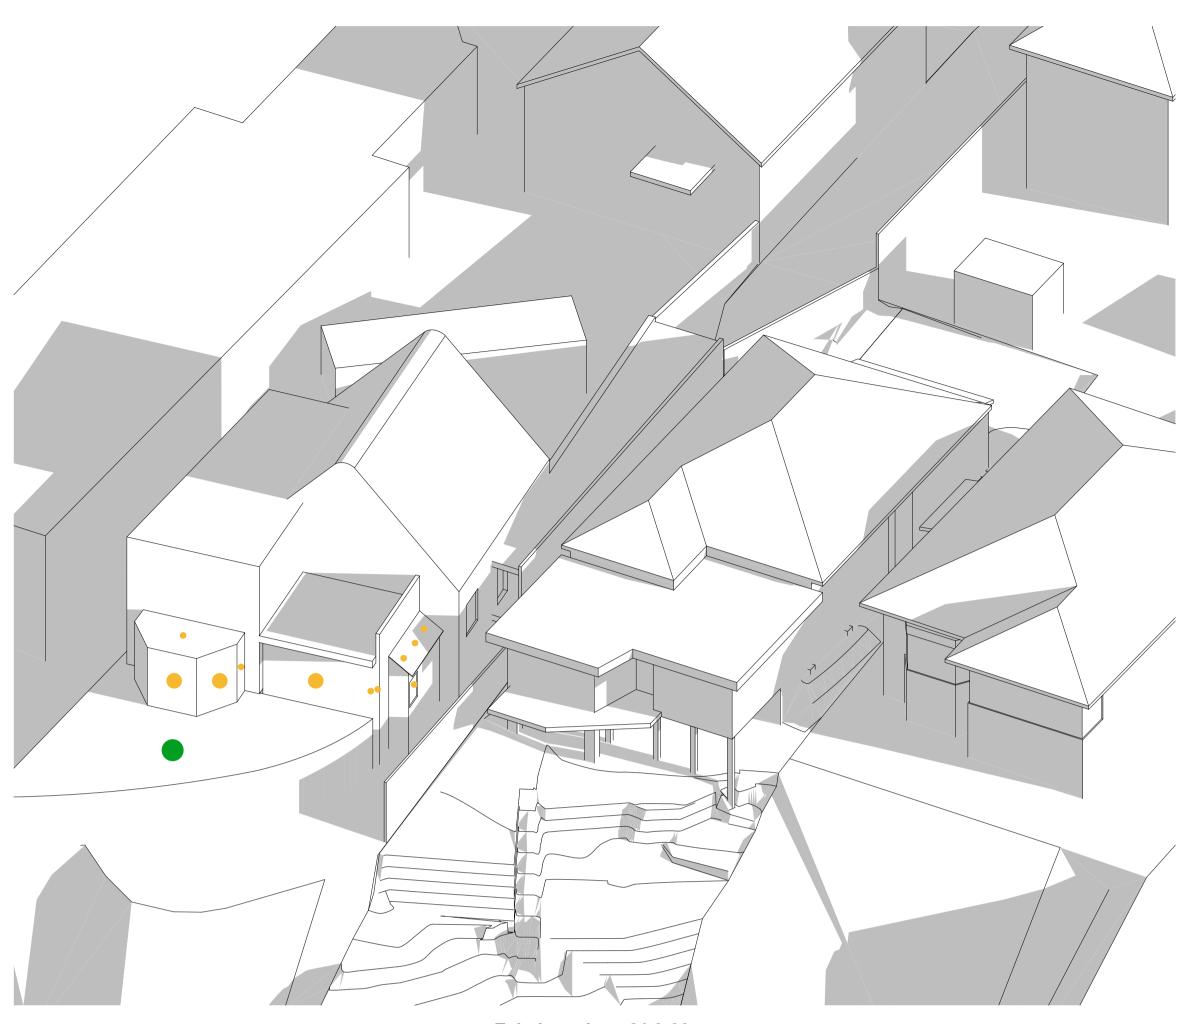
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revision

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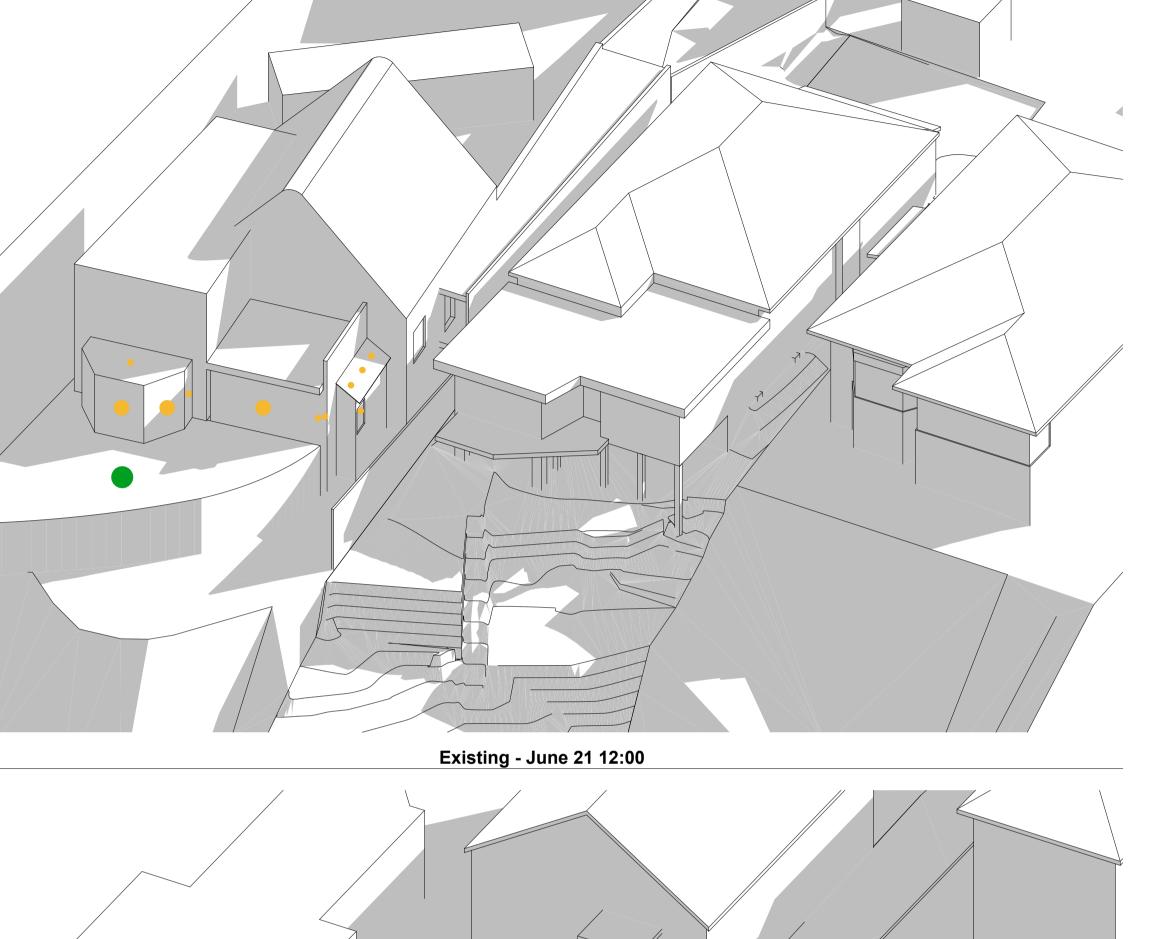






Proposed - June 21 9:00

Existing - June 21 12:00



**Proposed - June 21 12:00** 

Primary living room windows

Primary private open space

NOTE: Drawings subject to Architects Developed and Detail Design revisions. Not for Construction. To be read in conjunction with Specification and Consultant Drawings

### **PATTERSON**

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#### 16 Addison Rd, Sydney

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Geotechnical Engineer	Chambers Consultants Lt

designed	**	peer review	**
drawn	**	checked	**
scale <b>1:100</b>	@ A1	date 21/12/	2020


# Shadow Diagram 3D June 21 9:00 & 12:00

#### **Development Application** Not For Construction

18010

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Do not scale dimensions from drawings

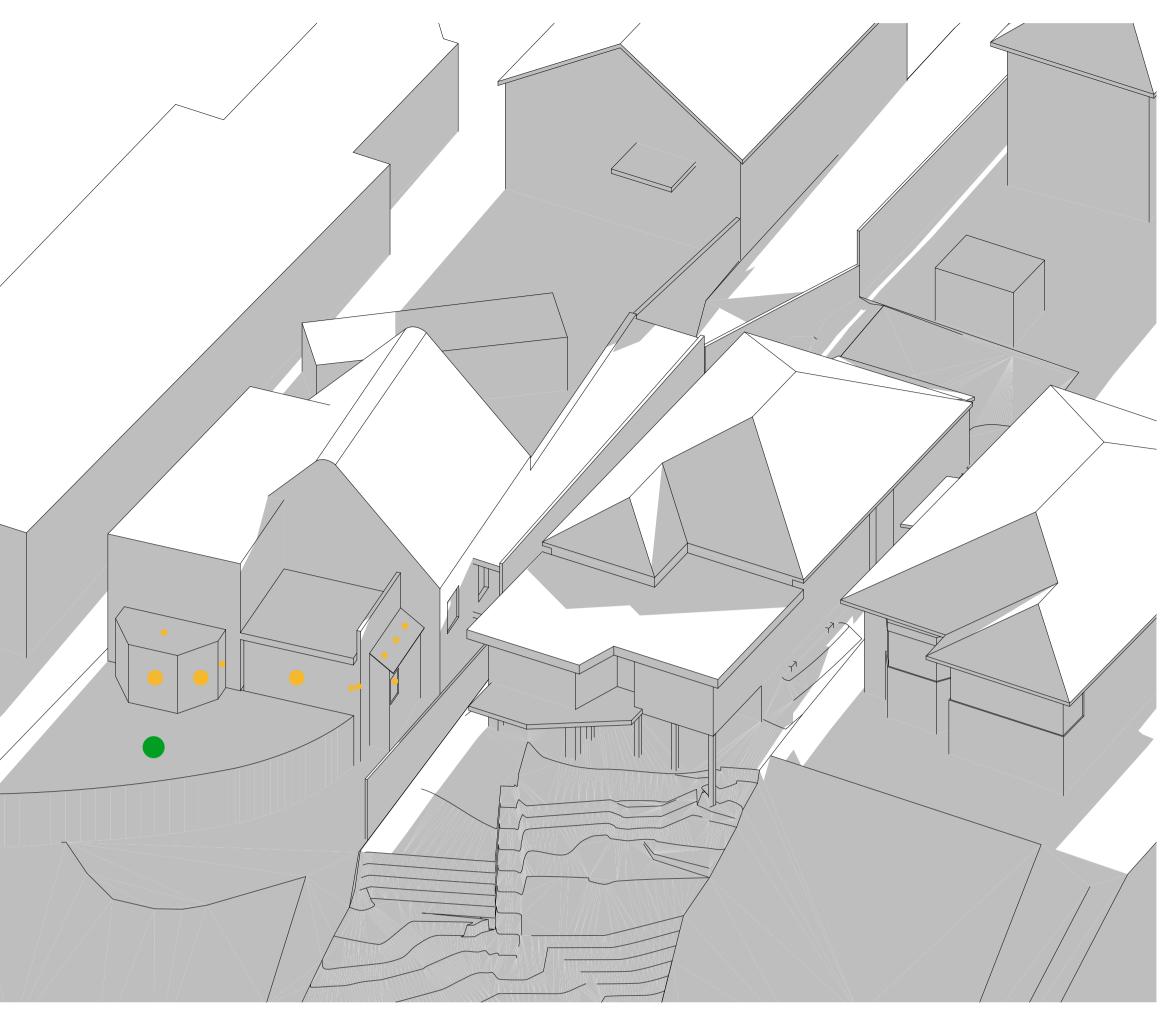

Existing - June 21 15:00



Proposed - June 21 15:00

Primary living room windows

Primary private open space

NOTE: Drawings subject to Architects Developed and Detail Design revisions. Not for Construction. To be read in conjunction with Specification and Consultant Drawings

## PATTERSON

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designed	**	peer review	**
drawn	**	checked	**
scale 1:100	@ A1	date 21/12/	2020

# Shadow Diagram 3D June 21 15:00

drawing set

#### **Development Application** Not For Construction


18010 sheet no.

The contractor must check and verify all drawings, details, dimensions and levels on site prior to commencing any work. Any discrepancies, errors or omissions must be reported to the architect, or suggestions for modifications made prior to work starting. Copyright in these drawings and all parts thereof remains at all times the property of Patterson Associates Limited.

Do not scale dimensions from drawings





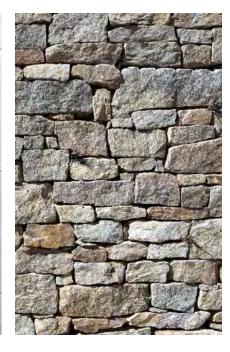








EXTERIOR



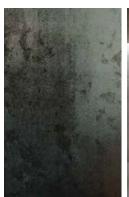









INTERIOR

#### **PATTERSON**

PATTERSON ASSOCIATES LTD REGISTERED ARCHITECTS NUMBER 1998

P.O. BOX 8778 SYMONDS ST, AUCKLAND, NEW ZEALAND TELEPHONE (09) 303-4004 FACSIMILE (09) 303-4001

#### 16 Addison Rd, Sydney

drawn	**	checked	**
designed	**	peer review	**
Geotechnical Engineer		Chambers Cons	ultants Ltd
Truss Designer		Buildable Layou	ts Ltd.
Structural Engineers		Law Sue Davison Ltd.	
Quantity Surveyors		Dean, Murray & Partners	

scale @ A1 date 21/12/2020

Material Palette

drawing set

#### Development Application Not For Construction

ref no. 18010

sheet no.

5.1

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