

pecifications.
All workmanship & materials shall be in accordance with the requirements of current editions
cluding amendments of the National Construction Code, relevant Australian Standards & loc
ouncil requirements.
Now materials are to be used throughout upless otherwise noted

LOT

DP

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SITE AREA = 533.8 m²

TRUE NORTH:

17229

AREA CALCULATIONS

 Concrete footings, slab, structural beams or any other structural members are to be designed by a practicing engineer.


26/90 Mona Vale Road, Mona Vale, NSW, 2103 PO Box 687, Dee Why, NSW, 2099 Mob. 0414 717 541 | Email. jjdraft@tpg.com.au www.jjdrafting.com.au ACN 651 693 346

15/03/2022	AMEDMENTS FOR PRELIM DRAWINGS	108 QUEENS PARAD
06/04/2022 06/04/2022	AMEDMENTS FOR PRELIM DRAWINGS DA DRAWINGS	CLIENT: PETER FARRUGIA
		DRAWING TITLE: SITE ANALYSIS PLAI


CLIENT: PETER FARRUGIA	
DRAWING TITLE: SITE ANALYSIS PLAN	


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955/22	JJ	DA.01		

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[GROSS FLOOR AREA - E	EXISTING	m²
			261.49m ²
[GROSS FLOOR AREA - F	PROPOSED	m²
		NC	CHANGES
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955/22	JJ	DA	.02

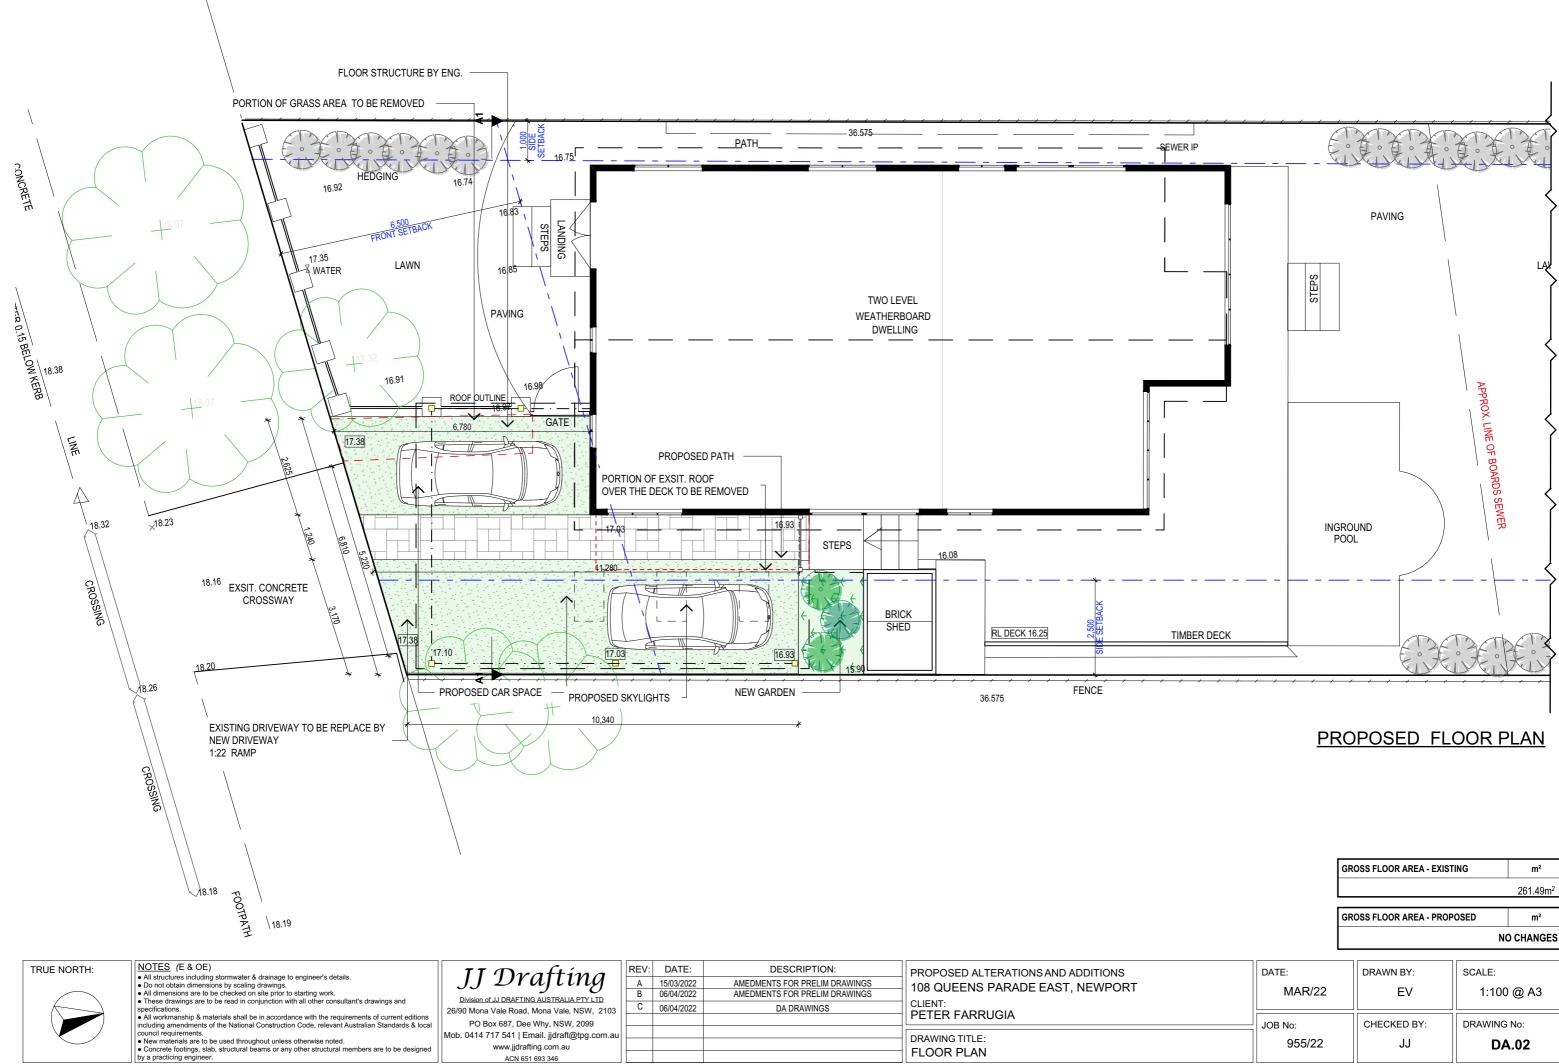

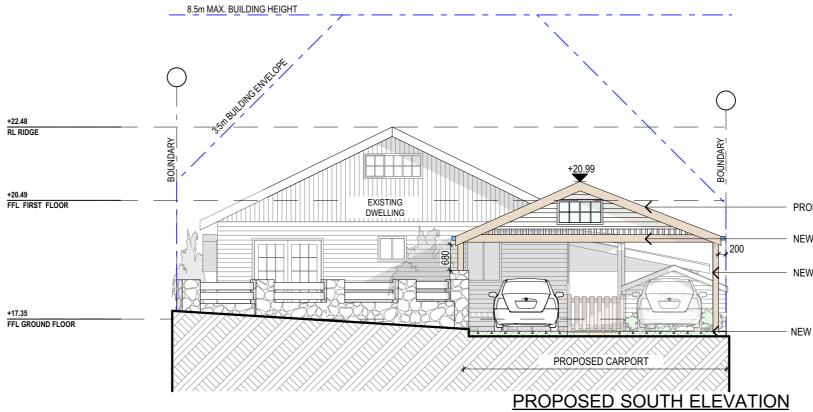

NOTES (E & OE) • All structures including stormwater & drainage to engineer's details. • Do not obtain dimensions by scaling drawings. • All dimensions are to be checked on site prior to starting work. • These drawings are to be read in conjunction with all other consultant's drawings and specifications.	JJ Drafting Division of JJ DRAFTING AUSTRALIA PTY LTD 26/90 Mona Vale Road, Mona Vale, NSW, 2103	REV: A B C	DATE: 15/03/2022 06/04/2022 06/04/2022	DESCRIPTION: AMEDMENTS FOR PRELIM DRAWINGS AMEDMENTS FOR PRELIM DRAWINGS DA DRAWINGS	PROPOSED ALTERATIONS AND ADDITIONS 108 QUEENS PARADE EAST, NEWPORT CLIENT:	DATE: MAR/22	DRAWN BY: EV	SCALE: 1:100 @ A3
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PROPOSED COLORBOND ROOF TO MATCH EXIST.

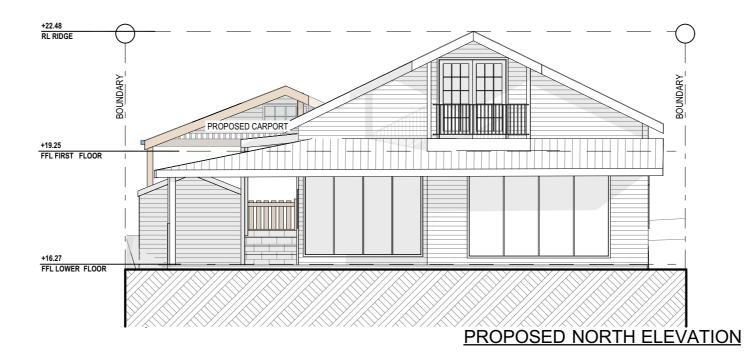NEW TIMBER BEAM BY ENG.

NEW TIMBER POST BY ENG.

NEW RC SLAB BY ENG



All stru Do no All din	IES (E & OE) structures including stormwater & drainage to engineer's details. not obtain dimensions by scaling drawings. Jimensions are to be checked on site prior to starting work. ise drawings are to be read in conjunction with all other consultant's drawings and fications.	JJ Drafting Division of JJ DRAFTING AUSTRALIA PTY LTD 26/90 Mona Vale Road, Mona Vale, NSW, 2103	REV: A B C	DATE: 15/03/2022 06/04/2022 06/04/2022	108 QUEENS PARADE EAST, NEWPORT CLIENT:	date: MAR/22	DRAWN BY: EV	SCALE: 1:100 @ A3
All wo including council r New n Concr	workmanship & materials shall be in accordance with the requirements of current editions ling amendments of the National Construction Code, relevant Australian Standards & local	PO Box 687, Dee Why, NSW, 2099 Mob. 0414 717 541 Email. jjdraft@tpg.com.au www.jjdrafting.com.au ACN 651 693 346			PETER FARRUGIA DRAWING TITLE: ELEVATIONS SHEET 2	JOB No: 955/22	CHECKED BY: JJ	DRAWING No: DA.04


8.5m MAX. BUILDING HEIGHT

PROPOSED WEST ELEVATION



TRUE NORTH:	NOTES (E & OE)	II Decafting a	REV: DATE:	DESCRIPTION:	PROPOSED ALTERATIONS AND ADDITIONS	DATE:	DRAWN BY:	SCALE:
	 All structures including stormwater & drainage to engineer's details. Do not obtain dimensions by scaling drawings. All dimensions are to be checked on site prior to starting work. 	JJ Drafting	A 15/03/2022 B 06/04/2022	AMEDMENTS FOR PRELIM DRAWINGS AMEDMENTS FOR PRELIM DRAWINGS	108 QUEENS PARADE EAST, NEWPORT	MAR/22	EV	1:100 @ A3
$ \longrightarrow $	 These drawings are to be read in conjunction with all other consultant's drawings and specifications. 	Division of JJ DRAFTING AUSTRALIA PTY LTD 26/90 Mona Vale Road, Mona Vale, NSW, 2103	C 06/04/2022	DA DRAWINGS				
	 All workmanship & materials shall be in accordance with the requirements of current editions including amendments of the National Construction Code, relevant Australian Standards & local 	PO Box 687, Dee Why, NSW, 2099			PETER FARRUGIA	JOB No:	CHECKED BY:	DRAWING No:
	council requirements. • New materials are to be used throughout unless otherwise noted. • Concrete footings, slab, structural beams or any other structural members are to be designed	Mob. 0414 717 541 Email. jjdraft@tpg.com.au www.jjdrafting.com.au				955/22	JJ	DA.05
	by a practicing engineer.	ACN 651 693 346			ELEVATIONS SHEET 3			

DRIVEWAY PROFILE

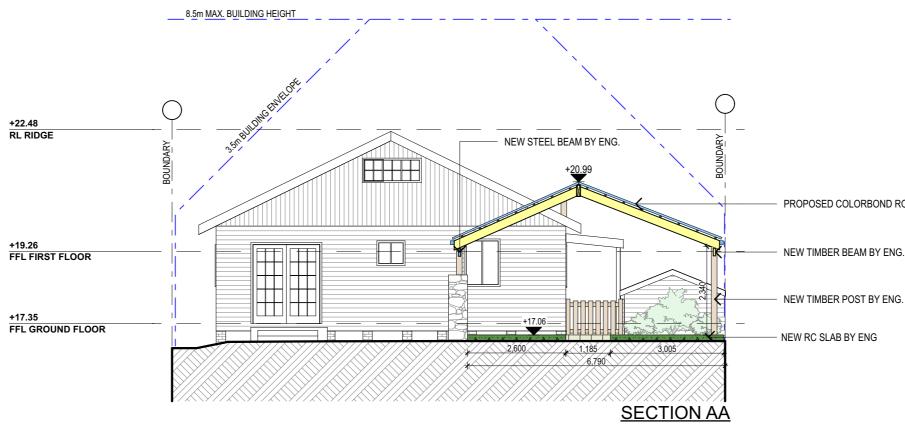

SPECIFICATION NOTES

- GROUND FLOOR TO BE REINFORCED CONCRETE SLAB IN ACCORDANCE WITH AS2870.

FLOOR:

BEARERS AND JOISTS: 5 SHALL BE INSTALLED TO COMPLY WITH AS1684 AS AMENDED FOR TIMBER COMPONENTS OR AS3620 FOR LIGHTWEIGHT STEEL FRAMING SECTIONS OR AS PER THE NASH ALTERNATIVES TO AS 3623.

ANT CAPS: - SHALL BE INSTALLED IN ACCORDANCE WITH AS3660.

PROFILED STEEL ROOF:

- COLORBOND ROOF CLADDING - NCC VOL.2 PART 3.5.1. - DESIGN AND INSTALLATION SHALL BE IN ACCORDANCE WITH AS/NZS 1562.

CONCRETE:

- SHALL BE IN ACCORDANCE WITH NCC VOL.1 PART B1.4 OR VOL.2 PART 3.2.3. - ALL WORKMANSHIP AND MATERIALS SHALL BE IN ACCORDANCE WITH CURRENT EDITIONS OF THE AS3600.

FOOTINGS:

- FOOTINGS TO BE IN ACCORDANCE WITH AS1480. - FOOTINGS TO BE IN ACCORDANCE WITH NCC VOL.2 PARTS 3.2.3, 3.2.4 AND 3.2.5 - ALL REINFORCEMENTS SHALL CONFORM TO AS1302, AS1303 AND AS1304

CARPENTRY:

- TIMBER TO COMPLY WITH AS1170.2 OR AS4055. - ALL WORKMANSHIP AND MATERIALS SHALL BE IN ACCORDANCE WITH AS1684 AND 1720 AS APPLICABLE.

TIMBER FRAMING:

- TO COMPLY WITH NCC VOL 2 PART 3.4 - GROUND FLOOR TIMBERS SHALL BE ONLY OF HARDWOOD, CYPRESS PINE OR PRESSURE TREATED RADIATA OR CANADA PINE BELOW A HEIGHT OF 300mm ABOVE FINISHED GROUND LEVEL AND MUST NOT BE BUILT INTO BRICKWORK. - SUBFLOOR VENTILATION SHALL CONFORM TO NCC VOL.2 PART 3.4.1. - IN BUSHFIRE PRONE AREAS SPECIAL CONDITIONS APPLY.

WHERE TERMITE BARLIERS NEEDT 0 BE INSPECTED, 400mm CLEARANCE IS REQUIRED BETWEEN THE UNDERSIDE OF BEARER AND GROUND SURFACE. - USE TREATED TIMBER WHERE REQUIRED FOR DURABILITY.

- DO NOT USE TIMBER UNSUITABLE FOR EXPOSURE TO MOISTURE IN EXPOSED LOCATION. - PROVIDE STRUCTURE BRACING IN ACCORDANCE WITH AS1684 - PROVIDE STRUCTURE TIEDOWN IN ACCORDANCE WITH AS1684 - USE GALVANISED FIXINGS WHERE EXPOSED TO WEATHER.

TERMITE CONTROL:

- TO BE IN ACCORDANCE WITH TO AS3660.1 - SHALL BE IN ACCORDANCE WITH NCC VOL.2 PART 3.1.4 OR VOL.1 PART B1.4.

FLASHING AND CAPPINGS:

- SELECTION AND INSTALLATION OF METAL RAINWATER GOODS REFER TO AS2180 - FLASH PROJECTIONS ABOVE THE ROOF WITH TWO PART FLASHINGS CONSISTING OF AN APRON FLASHING AND OVER FLASHING, WITH AT LEAST 100mm OVERLAP. PROVIDE FOR INDEPENDENT MOVEMENT BETWEEN ROOF AND PROJECTION.

CONCRETE BLOCKS OR BRICKS: - TO COMPLY WITH TO AS4455 MASONRY BUILDING BLOCKS/PAVER.

LIGHTING:

- 40% OF NEW OR ALTERED LIGHT FIXTURES TO BE FITTED WITH FLUORESCENT, COMPACT FLUORESCENT, OR LIGHT-EMITTING-DIODE (LED) LAMPS

DOORS & WINDOWS:

- ALL FRAMED WINDOWS SHALL BE INSTALLED IN ACCORDANCE WITH AS2047-48 FOR ALUMINIUM WINDOWS AND AS2047 FOR TIMBER WINDOWS.

ALUMINIUM FRAMED WINDOWS AND DOORS. - WEATHER STRIPPING IS TO BE PROVIDED TO ALL EXTERNAL WINDOWS AND DOORS.

SLIP RESISTANCE:

- MATERIALS TO BE USED FOR SURFACES OF FLOORS, STAIR LANDING, STEPS AND NOSINGS SHALL BE IN ACCORDANCE WITH THE CLASSIFICATIONS FOR SLIP RESISTANCE AS APPLY IN AS4586 AND HB198.

STORMWATER:

EAVES GUTTERS, VALLEY GUTTERS AND DOWPIPES - TO COMPLY WITH AS/NZS 2179 FOR METAL AND AS1273 FOR UPVC COMPONENTS.

- IN ACCORDANCE WITH NCC VOL 2 PART 3.5.3 - NEW DOWNPIPES TO BE CONNECTED INTO EXISTING STORMWATER LINE

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- COLORBOND GUTTERS AND DOWNPIPES
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- MINIMUM SLOPE OF EAVES AND GUTTERS 1:200

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PROPOSED COLORBOND ROOF TO MATCH EXIST.

WATERPROOFING FOR EXTERNAL TILED BALCONIES:

- WATERPROOFING TO COMPLY WITH AS4654

GLAZING:

- NCC VOL.1 PARTS B 1.4, D 3.12, F1.13 OR NCC VOL.2 PART 3.6

WASTE MANAGEMENT:

- ALL WASTE SHALL BE TAKEN AWAY BY TRUCKS TO A SUITABLE LANDFILL OR RECYCLE DEPOT. - ALL WASTE SHALL BE COVERED DURING TRANSPORTATION. - WASTE GENERATED DURING CONSTRUCTION SHALL BE PLACED IN STEEL BINS AND TAKEN AWAY BY AN APPROVED CONTRACTOR TO A APPROVED LANDFILL SITE.

SEDIMENT CONTROL:

A FILTER CLOTH SYSTEM SHALL BE INSTALLED TO STOP ANY SEDIMENT ENTERING COUNCILS STORMWATER SYSTEM.

NOTE:

ALL PLANS ARE TO BE READ IN CONJUNCTION AND COMPLY WITH THE BASIX CERTIFICATE, BUSHFIRE AND GEOTECH REPORTS.







CALCULATIONS		
SITE AREA		533.8m ²
LANDSCAPE CONTROL	50%	266.9m ²
EXISTING LANDSCAPED AREA	33.8%	180.57m ²
OUTDOOR RECREATIONAL AREA	6%	32.03m ²
PROPOSED LANDSCAPED AREA	33.7%	180.34m ²
TOTAL LANDSCAPED AREA	39%	212.37m ²
EXISTING HARD SURFACE AREA		320.96m ²
HARD SURFACE AREA TO BE RETAINED		315.3m ²
NEW HARD SURFACE AREA		5.83m ²
TOTAL HARD SURFACE AREA	60.2%	321.13m ²

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	Do not obtain dimensions by scaling drawings.	$\int \int \mathcal{L} \cap \mathcalL \cap $				108 QUEENS PARADE EAST, NEWPORT			4.4 4.000 0 40
	 All dimensions are to be checked on site prior to starting work. 	<i>J O</i>	B	06/04/2022	AMEDMENTS FOR PRELIM DRAWINGS		MAR/22	EV I	1:1, 1:200 @ A3
	These drawings are to be read in conjunction with all other consultant's drawings and	Division of JJ DRAFTING AUSTRALIA PTY LTD				CLIENT:			
	specifications.	26/90 Mona Vale Road, Mona Vale, NSW, 2103	11 0	06/04/2022	DA DRAWINGS				
	All workmanship & materials shall be in accordance with the requirements of current editions					PETER FARRUGIA			
	including amendments of the National Construction Code, relevant Australian Standards & local	PO Box 687, Dee Why, NSW, 2099					JOB No:	CHECKED BY:	DRAWING No:
	council requirements.	Mob. 0414 717 541 Email. jjdraft@tpg.com.au							
	 New materials are to be used throughout unless otherwise noted. 					DRAWING TITLE:	955/22		DA.07
	Concrete footings, slab, structural beams or any other structural members are to be designed	www.jjdrafting.com.au				LANDSCAPED AREA CALCULATION PLAN	500/22	00	DA.07
	by a practicing engineer.	ACN 651 693 346				LANDSCAFED AREA CALCULATION FLAN			

EXISTING LANDSCAPE AREA CALCULATION

PROPOSED LANDSCAPE AREA CALCULATION

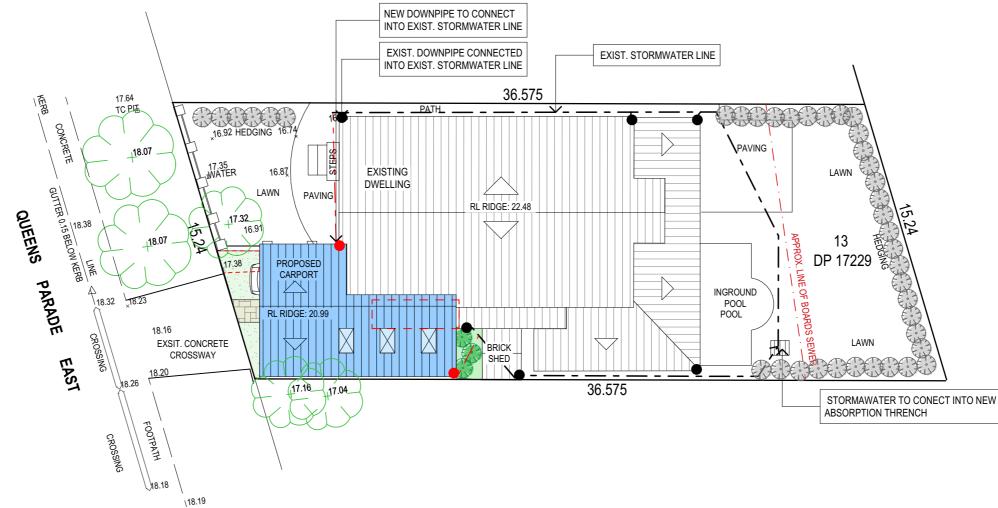

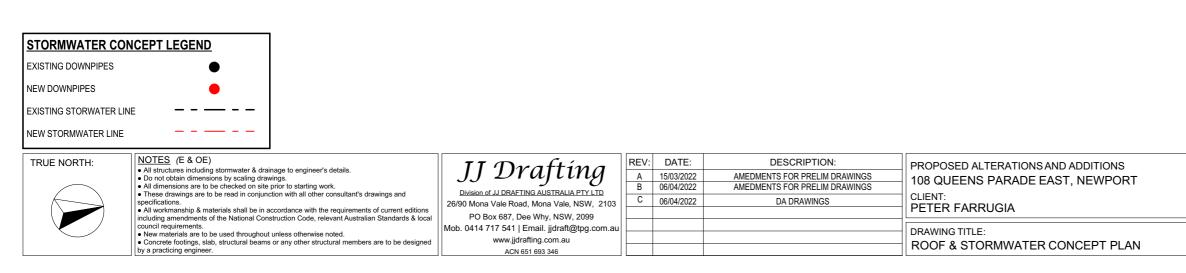

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ROOF & STORMWATER CONCEPT PLAN

NOTES

DESIGNATED SITE MANAGER/BUILDER

PRIOR TO COMMENCEMENT OF WORK A SITE MANAGER OR BUILDER MUST BE NOMINATED. THE SITE MANAGER OR BUILDER WILL BE RESPONSIBLE AND LIABLE FOR ALL WORKS CARRIED OUT ON THE SITE. THIS ASSUMES THE RESPONSIBILITY FOR THE ACTIONS OF ALL SUBCONTRACTED PARTIES AS WELL AS ADVISING THEM OF COUNCIL'S REQUIREMENTS WHEN CARRYING OUT WORKS

TOPSOIL MANAGEMENT

PRIOR TO THE STRIPPING OF TOPSOIL, THE VEGETATIVE COVER MUST BE REDUCED BY EITHER SLASHING OR MOWING. ALL TOPSOIL IS TO BE RETAINED AND PROTECTED FOR REUSE ON SITE. SOIL STOCKPILES MUST NOT BE LOCATED ON NATURE STRIPS, FOOTPATHS, ROADWAYS, KERBS, ACCESSWAYS, WITHIN DRAINAGE LINES/FLOWS/PATHS OR AROUND OR AGAINST TREE SHRUBS. SEDIMENT CONTROL MEASURES MUST BE INCORPORATED WITH ANY RESULTING STOCKPILE. THE STOCKPILE CAN BE PROTECTED FROM EROSION BY COVERING IT WITH AN MPERVIOUS MATERIAL, IN CONJUNCTION WITH THE INSTALLATION OF A SEDIMENT FENCE AROUND IT. IF STOCKPILES ARE TO REMAIN FOR MORE THAN ONE MONTH THEY ARE TO BE GRASSED IMMEDIATELY AND STABILISED WITHIN FOURTEEN DAYS. SURPLUS TOPSOIL MUST BE REASONABLY REMOVED FROM SITE.

BUILDING MATERIAL STOCKPILING

SUFFICIENT AREA MUST BE ALLOCATED WITHIN THE SITE FOR SUCH STORAGE OF BUILDING MATERIALS, DEMOLITION WASTE, WASTE CONTAINERS, ETC. AS WILL BE REQUIRED.

SEDIMENT FENCES

A SEDIMENT FENCE SHOULD BE LOCATED ALONG THE DOWNSLOPE BOUNDARY(S) OF THE SITE. ON THE CONSTRUCTION SIDE OF THE TURF FILTER STRIP OR NATIVE VEGETATION, AND AROUND ALL STOCKPILES OF MATERIAL ON THE SITE.

DUST CONTROL

ALL TRUCKS/UTES MUST COVER THEIR LOADS AT ALL TIMES. APPROPRIATE METHODS ARE TO BE EMPLOYED TO PREVENT BLOWING DUST CREATING AN UNACCEPTABLE HAZARD OR NUISANCE ON THE SITE OR DOWN WIND. PRODUCTION OF DUST CAN BE MINIMISED BY LIMITING AREA OF EARTHWORKS, WATERING AND PROGRESSIVE VEGETATION. WHERE DUST IS CREATED AS A RESULT WORKS AND/OR SOIL EXPOSURE, THE BARE SOIL AREAS MUST BE WATERED, DURING AND/OR AT THE END OF EACH DAY TO LAY THE DUST. EARTH MOVING ACTIVITIES SHOULD BE AVOIDED WHERE WINDS ARE SUFFICIENTLY STRONG ENOUGH TO RAISE VISIBLE DUST

EROSION & SEDIMENT CONTROLS

APPROPRIATE EROSION AND SEDIMENT CONTROLS MUST BE IMPLEMENTED ON ALL SITES THAT INVOLVE SOIL DISTURBANCE. THE MEASURES MUST BE IN PLACE PRIOR TO THE COMMENCEMENT OF WORK. THOSE CONTROLS ARE TO BE MONITORED AND MAINTAINED IN ORDER TO SERVE THEIR INTENDED FUNCTION FOR THE DURATION OF THE WORKS OR UNTIL SUCH TIME AS THE SITE IS FULLY STABILISED. IF ANY CONTROLS ARE DAMAGED OR BECOME INEFFECTIVE DURING THE COURSE OF THE WORKS THEY ARE TO BE REINSTATED OR REPLACED IMMEDIATELY. SUFFICIENT ACCESS TO THESE CONTROLS MUST BE PROVIDED IN CASE OF THE NEED TO REPAIR.

SEDIMENT TRAPS


WHERE A SEDIMENT FENCE IS NOT USED APPROPRIATE SEDIMENT TRAPS SHOULD BE LOCATED AT ALL POINTS WHERE STORMWATER LEAVES THE CONSTRUCTION SITE OR LEAVES THE GUTTER AND ENTERS THE DRAINAGE SYSTEM. A COMMON TECHNIQUE IS THE GRAVEL SAUSAGE.

DIVERSION CHANNELS


A DIVERSION CHANNEL IS AN EXCAVATED EARTH DITCH OR PATH. THESE STRUCTURES ARE USED TO INTERCEPT AND DIRECT RUN-OFF TO A DESIRED LOCATION WHERE POSSIBLE. ALL STORMWATER RUN-OFF FLOWING ONTO DISTURBED AREAS, INCLUDING STOCKPILES, MUST BE INTERCEPTED, DIVERTED AND/OR SAFELY DISPOSED OF. THIS CAN BE ACHIEVED BY CONSTRUCTING A TEMPORARY EARTH BANK AROUND THE UPSLOPE EXTENT OF THE CONSTRUCTION SITE WHERE THE DIVERSION DOES NOT AFFECT THE NEIGHBOURING PROPERTIES.


VEHICLE MOVEMENTS


TO LIMIT DISTURBANCE TO THE SITE AND TRACKING OF MATERIAL ONTO THE STREET ALL VEHICLES AND PLANT EQUIPMENT ARE TO USE A SINGLE ENTRY/EXIT POINT UNLESS COUNCIL HAS APPROVED ALTERNATIVE ARRANGEMENTS. ACCESS POINTS AND PARKING AREAS ARE TO BE STABILISED WITH COMPACTED SUB-GRADE ASAP AFTER THEIR FORMATION. IF SPILLAGE DOES OCCUR IT IS TO BE CONTAINED IMMEDIATELY AND CAREFULLY REMOVED. THE AREA AFFECTED IS TO BE RESTORED TO A STANDARD EQUAL TO OR BETTER THAN ITS PREVIOUS CONDITION. ALL VEHICLES ARE TO BE WASHED PRIOR TO EXISTING THE SITE. THIS SERVES THE PURPOSE OF REMOVING SITE MATERIAL ON THE VEHICLE AND PREVENTS IT FROM BEING DEPOSITED ON THE ROAD NETWORK ADJACENT TO THE SITE AND THUS, THE STORMWATER SYSTEM. NO VEHICLE ASSOCIATED WITH THE WORK IS TO BE PARKED ON A FOOTPATH OR PUBLIC RESERVE. ALL VEHICLES VISITING THE SITE DURING DEMOLITION, EXCAVATION AND/OR CONSTRU

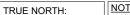

UCTION WORKS, A	RE TO COMPLY WITH THE PARKING REQUIREMENTS IN THAT AREA.		 × `		
NORTH:	NOTES (E & OE) All structures including stormwater & drainage to engineer's details. Do not obtain dimensions by scaling drawings. All dimensions are to be checked on site prior to starting work. These drawings are to be read in conjunction with all other consultant's drawings and specifications. All workmanship & materials shall be in accordance with the requirements of current editions including amendments of the National Construction Code, relevant Australian Standards & local council requirements. New materials are to be used throughout unless otherwise noted. Concrete footings, slab, structural beams or any other structural members are to be designed by a practicing engineer.	JJ Drafting Division of JJ DRAFTING AUSTRALIA PTY LTD 26/90 Mona Vale Road, Mona Vale, NSW, 2103 PO Box 687, Dee Why, NSW, 2099 Mob. 0414 717 541 Email. jjdraft@tpg.com.au www.jjdrafting.com.au ACN 651 693 346	 DATE: 15/03/2022 06/04/2022 06/04/2022	DESCRIPTION: AMEDMENTS FOR PRELIM DRAWINGS AMEDMENTS FOR PRELIM DRAWINGS DA DRAWINGS	PROPOSED ALTERAT 108 QUEENS PARA CLIENT: PETER FARRUGIA DRAWING TITLE: EROSION & SEDIM MANAGEMENT PLA

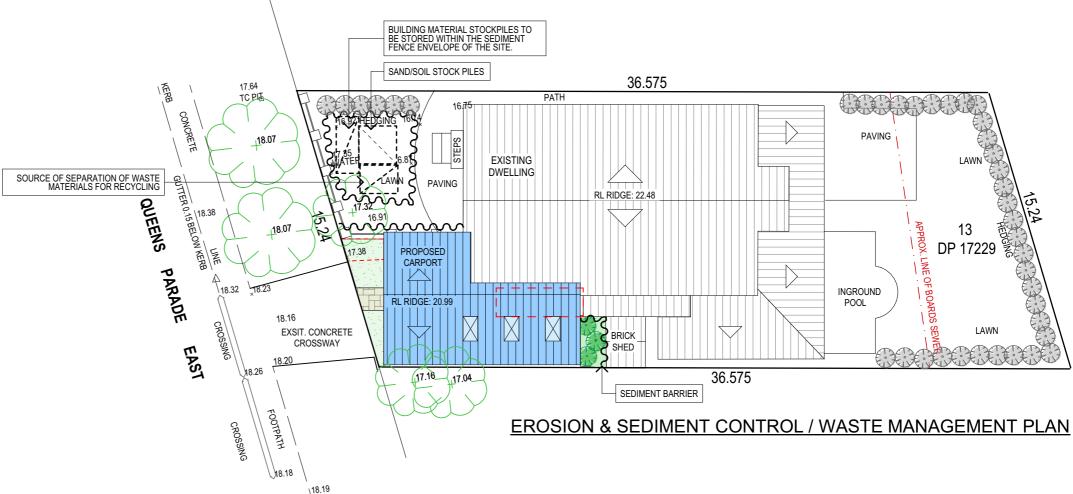


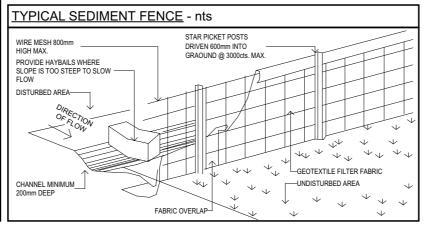

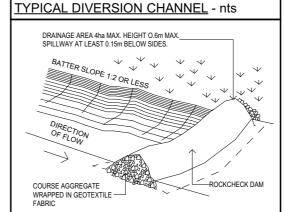

IONS AND ADDITIONS ADE EAST, NEWPORT IENT CONTROL / WASTE

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955/22	JJ	DA.09

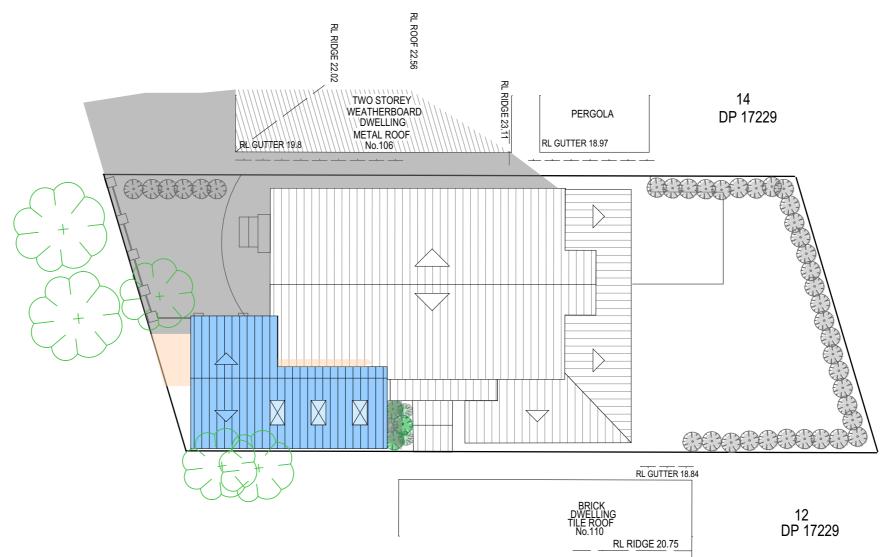

SHADOW DIAGRAM JUNE 21 9:00 am

21 JUNE SHADOW DIAGRAM LEGEND

EXISTING SHADOWS

NEW SHADOWS

TRUE NORTH:	 New materials are to be used throughout unless otherwise noted. Concrete footings, slab, structural beams or any other structural members are to be designed 	DY DY AUTON Division of JJ DRAFTING AUSTRALIA PTY LTD 26/90 Mona Vale Road, Mona Vale, NSW, 2103 PO Box 687, Dee Why, NSW, 2099 Mob. 0414 717 541 Email. jjdraft@tpg.com.au www.jjdrafting.com.au	DATE: 15/03/2022 06/04/2022 06/04/2022	DESCRIPTION: AMEDMENTS FOR PRELIM DRAWINGS AMEDMENTS FOR PRELIM DRAWINGS DA DRAWINGS	PROPOSED ALTERATIONS AND ADDITIONS 108 QUEENS PARADE EAST, NEWPORT CLIENT: PETER FARRUGIA DRAWING TITLE: SHADOW DIAGRAM JUNE 21 9:00 am
	 Concrete footings, slab, structural beams or any other structural members are to be designed by a practicing engineer. 	ACN 651 693 346			SHADOW DIAGRAM JUNE 21 9:00 am

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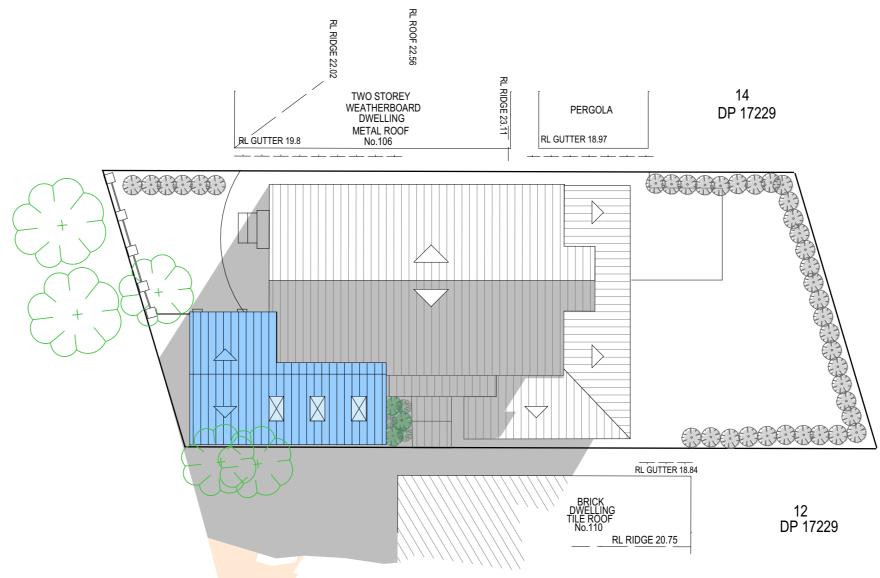


SHADOW DIAGRAM JUNE 21 12:00 pm

21 JUNE SHADOW DIAGRAM LEGEND

EXISTING SHADOWS NEW SHADOWS

DATE: MAR/22	DRAWN BY: EV	SCALE: 1:200 @ A3 DRAWING No: DA.11		
 JOB No: 955/22	CHECKED BY: JJ			



SHADOW DIAGRAM JUNE 21 3:00 pm

21 JUNE SHADOW DIAGRAM LEGEND

EXISTING SHADOWS

NEW SHADOWS

	All dimensions are to be checked on site prior to starting work. These drawings are to be read in conjunction with all other consultant's drawings and specifications. All workmanship & materials shall be in accordance with the requirements of current editions including amendments of the National Construction Code, relevant Australian Standards & local	JJ Drafting Division of JJ DRAETING AUSTRALIA PTY LTD 26/90 Mona Vale Road. Mona Vale. NSW. 2103	B	DATE: 15/03/2022 06/04/2022 06/04/2022	DESCRIPTION: AMEDMENTS FOR PRELIM DRAWINGS AMEDMENTS FOR PRELIM DRAWINGS DA DRAWINGS	PROPOSED ALTERATIONS AND ADDITIONS 108 QUEENS PARADE EAST, NEWPORT CLIENT:	DATE: MAR/22	DRAWN BY: EV	SCALE: 1:200 @ A3
		PO Box 687, Dee Why, NSW, 2099 Mob. 0414 717 541 Email. jjdraft@tpg.com.au				PETER FARRUGIA DRAWING TITLE: SHADOW DIAGRAM JUNE 21 3:00 pm	JOB No: 955/22	CHECKED BY: JJ	DRAWING No: DA.12