141 POWDERWORKS ROAD, ELANORA HEIGHTS 2101

NEW ATTACHED TWO STOREY DUAL OCCUPANCY & ADDITIONS TO EXISTING BRICK DWELLING

DEVELOPMENT APPLICATION

APPLICANTS:	MATT & NAOMI NOFFS
LOT/DP:	LOT101/DP842992
LGA:	NORTHERN BEACHES COUNCIL
ZONE:	R2 - LOW DENSITY RESIDENTIAL
FLOOD:	IS NOT A FLOOD CONTROL LOT
BUSHFIRE:	IS NOT A BUSHFIRE PRONE LOT
HERITAGE:	NOT IN A HERITAGE CONSERVATION AREA
	NOT A LOCAL HERITAGE ITEM OR DRAFT HERITAGE ITEM

DEVELOPMENT APPLICATION - DRAWING LIST

ID	DRAWING
DA-00	COVER SHEET
DA-01	NOTES AND STANDARDS
DA-02	SITE STAGING AND SEDIMENTATION PLAN
DA-10	SITE PLAN AND SITE ANALYSIS
DA-11	FLOOR PLAN - DUAL OCCUPANCY GROUND FLOOR
DA-12	FLOOR PLAN - DUAL OCCUPANCY FIRST FLOOR
DA-13	FLOOR PLAN - PROPOSED ADDITIONS TO EXISTING BRICK DWELLING
DA-14	ROOF PLAN
DA-15	DEMOLITION PLAN
DA-16	LANDSCAPING CONCEPT PLAN
DA-17	PLANTING SCHEDULE (PREPARED BY WILDER GARDEN CO.)
DA-20	ELEVATIONS
DA-21	ELEVATIONS
DA-22	SECTIONS
DA-23	SHADOW DIAGRAMS
DA-30	WINDOW SCHEDULE
DA-31	DOOR SCHEDULE
DA-32	FINISHES AND COLOURS
DA-33	BASIX DA REQUIREMENTS
3585	SURVEY (PREPARED BY GEOGRAPHIC SOLUTIONS SURVEYORS)
11682-C1.00	
11682-C1.01	STORMWATER MANAGEMENT - SHEET 2 (PREPARED BY WADDINGTON CONSULTING P/L)
11682-C1.02	STORMWATER DETAILS (PREPARED BY WADDINGTON CONSULTING P/L)
164/2020	PROPOSED CAR PARKING AREA (PREPARED BY TTPA)
164/2020	CAR PARKING AREA RLs AND GRÀDIENTS (PREPARED BY TTPA)
164/2020	SWEPT PATH ASSESSMENTS FOR B85 VEHICLE (PREPARED BY TTPA)





leights Search

EXISTING DWELLING

ROAD

MERRIDONG

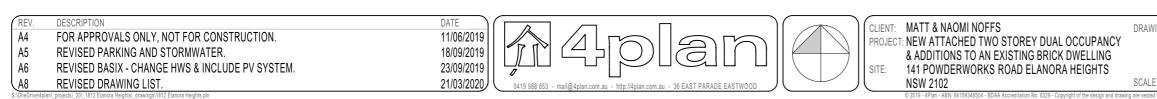

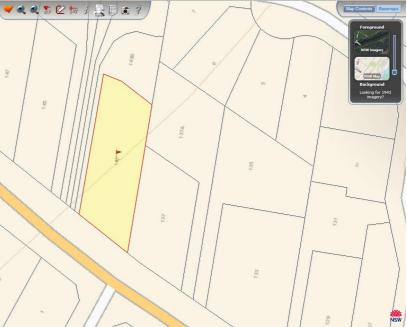



DRAWING ID: DA-00

DO NOT SCALE FROM DRAWINGS.

DRAWN:

ALM

REV. STATUS: APPROVALS

CREATED: 22nd JUNE 2018

DRAWING: COVER SHEET

SCALE: AS SHOWN @ A3

NOTES

1. CONFIRM ALL DIMENSIONS ON SITE BEFORE ORDERING MATERIALS AND STARTING CONSTRUCTION.

2. ALL WORK IS TO BE CARRIED OUT IN ACCORDANCE WITH ALL RELEVANT AUSTRALIAN STANDARDS, THE BUILDING CODE OF AUSTRALIA, NSW WORKCOVER AND ALL RELEVANT APPROVALS/REQUIREMENTS.

3. ALL WORKS TO BE IN ACCORDANCE WITH BASIX CERTIFICATE A323325 06 AND BASIX CERTIFCATE 1003317M 03 AND ALL ASSOCIATED DOCUMENTATION.

4. DEMOLISH EXISTING STRUCTURES AS SHOWN, WHERE REQUIRED, ALL DEMOLITION SHALL BE CARRIED OUT IN ACCORDANCE WITH AS 2601 AND NSW WORKCOVER REGULATIONS.

5. IF REQUIRED, ANY ASBESTOS REMOVAL SHALL BE UNDER TAKEN BY APPROPRIATELY QUALIFIED AND LICENSED CONTRACTORS AND ALL MATERIALS TREATED AND DISPOSED OF IN ACCORDANCE WITH NSW WORKCOVER REQUIREMENTS.

6. PROVIDE TERMITE TREATMENT TO WHOLE OF NEW CONSTRUCTION AREA IN ACCORDANCE WITH PART 3.1 OF VOLUME TWO OF THE BUILDING CODE OF AUSTRALIA AND AS 3660.

7. WHERE REQUIRED, PROVIDE WATER SERVICES, STORMWATER DRAINAGE, HOT WATER SERVICES AND SANITARY SERVICES, METERS, VENTS, WASTES, Etc. AS REQUIRED IN ACCORDANCE WITH AS 3500 AND AS 1547 AND THE BUILDING CODE OF AUSTRALIA. ALL NEW WATER PIPES ARE TO BE ACCOUSTICALLY INSULATED.

8. WHERE REQUIRED, PROVIDE ALL ELECTRICAL SERVICES, METERS, LIGHTING, EMERGENCY LIGHTING, SWITCHBOARDS, METERS, Etc. IN ACCORDANCE WITH AS 3000 AND AS 1680.

9. WHERE REQUIRED, ALL WET AREAS ARE TO BE WATER PROOFED, AND THE INSTALLATION CERTIFIED, IN ACCORDANCE WITH THE BUILDING CODE OF AUSTRALIA AND AS 4200.

10. WHERE REQUIRED, PROVIDE ALL TIMBER FRAMING, TRUSSES, BEAMS, POSTS, Etc. AS REQUIRED, ALL IN ACCORDANCE WITH THE BUILDING CODE OF AUSTRALIA AND AS 1684 TIMBER FRAMING CODE.

11. WHERE REQUIRED, PROVIDE ALL STEEL FRAMING, TRUSSES, BEAMS, COLUMNS, Etc. AS REQUIRED IN ACCORDANCE WITH THE BUILDING CODE OF AUSTRALIA AND AS 4100.

12. WHERE REQUIRED, PROVIDE ALL ROOFING AND ASSOCIATED GUTTERS, DOWNPIPES, FLASHINGS, INSULATION, Etc. IN ACCORDANCE WITH AS 2050, AS 2728, AS 4389, AND AS 3500 AND THE THE BUILDING CODE OF AUSTRALIA,.

13. WHERE REQUIRED, PROVIDE SMOKE ALARMS IN ACCORDANCE WITH THE BUILDING CODE OF AUSTRALIA AND AS 3786 AND AS 2293.

14. WHERE REQUIRED, PROVIDE ALL DOORS AND DOOR HARDWARE AS REQUIRED IN ACCORDANCE WITH AS 2688, AS 1909, AS 3959.

15. WHERE REQUIRED. PROVIDE ALL WINDOWS. FRAMES. GLAZING. Etc., IN ACCORDANCE WITH AS 1288, AS 3715, AS 4667, AS 3959 AND THE REQUIREMENTS OF THE BASIX REPORT/S.

16. WHERE REQUIRED, ALL PREPARATION FOR PAINTING AND PAINTING SHALL BE CARRIED OUT IN ACCORDANCE WITH AS 1627, AS 2311, AS 2312.

17. WHERE REQUIRED, PROVIDE ALL WALL AND FLOOR TILING IN ACCORDANCE WITH AS 1884 & AS 2358

DATE

02/06/2019

11/06/2019

18/09/2019

23/09/2019

0419 988 653 - mail@4nlan.com.au - http://4nlan.com.au - 36 FAST PARADE FAST)


REV.	DESCRIPTION

- A3 FOR APPROVALS ONLY, NOT FOR CONSTRUCTION
- A4 FOR APPROVALS ONLY, NOT FOR CONSTRUCTION. A5 REVISED PARKING AND STORMWATER.
- A6 REVISED BASIX - CHANGE HWS & INCLUDE PV SYSTEM.

SPECIFICATION

ALL WORKS ARE TO BE CARRIED OUT IN ACCORDANCE WITH BCA REQUIREMENTS & ALL RELEVANT AUSTRALIAN STANDARDS INCLUDING BUT NOT LIMITED TO THE FOLLOWING:

SURVEYS: TECHNICAL DRAWING SAFETY: WORK HEALTH & SAFETY REGULATIONS 2011 & SAFE WORK AUSTR SAFETY AT WORK - PRINCIPLES AND PRACTICES DEMOLITION: THE DEMOLITION OF STRUCTURES	AS 1100.40-1984 RALIA HEALTH AND AS 1470	DOORS & DOOR HARDY FLUSH DOORS AND JOU INSTALLATION WINDOWS & GLAZING: MATERIALS, SELECTION
WORK HEALTH & SAFETY REGULATIONS 2011 & SAFE WORK AUSTR SAFETY AT WORK - PRINCIPLES AND PRACTICES DEMOLITION:		
	AS 2601	CUT-TO-SIZE QUALITY LAMINATED AND TOUG METAL FINISHING - THE
EARTHWORKS & EXCAVATION: GEOTECHNICAL SITE INVESTIGATIONS EARTHWORKS	AS 1726 AS 1726	OF ALUMINUM AND ALU SAFETY GLAZING MATE
COMPACTION TESTING	AS 1289.5.41 & AS 1289.5.4.2	PAINTING: GUIDE TO THE PAINTIN GUIDE TO THE PROTEC
STORM WATER & HYDRAULICS: WASTEWATER STORMWATER	AS 1547 AS NZS 3500.3	BY THE USE OF PROTE METAL FINISHING - PRE CLEANING OF STEEL
PLUMBING & DRAINAGE - WATER SERVICES PLUMBING & DRAINAGE - SANITARY PLUMBING & DRAINAGE PLUMBING & DRAINAGE - HEATED WATER SERVICES COPPER PIPES & FITTINGS - INSTALLATION & COMMISSIONING	AS/NZS 3500.1 AS/NZS 3500.2. AS/NZS 3500.4 AS 4809	TILING: AN INTRODUCTORY GU SURFACE MATERIALS FLOOR COVERINGS - R
ELECTRICAL: DEGREES OF ELECTRICAL PROTECTION	AS 1939	ADHESIVES - FOR FIXIN
ELECTRICAL INSTALLATIONS ELECTRICAL WORK INTERIOR LIGHTING	AS/NZS 3000 AS/NZS 3000 AS/NZS 1680.	LANDSCAPING: SOILS FOR LANDSCAPI
TERMITE MANAGEMENT: TERMITE MANAGEMENT	AS 3660	PARKING: PARKING FACILITIES PARKING FACILITIES PARK
TIMBER FRAMING: TIMBER FRAMING CODE	AS1684	
CONCRETE & MASONRY:		
FORMWORK DESIGN & CONSTRUCTION STEEL REINFORCING MATERIALS	AS 3610 AS 1302, AS 1303 & AS 1304	
CONCRETE MATERIALS & CONSTRUCTION CONCRETE STRUCTURES FOR RETAINING LIQUIDS MATERIALS & CONSTRUCTION	AS 1379 AS 3600 AS 3735 AS 3700	
STRUCTURAL STEEL: MATERIALS, CONSTRUCTION, FABRICATION & ERECTION	AS 5700	
WATERPROOFING: PLIABLE BUILDING MEMBRANES & UNDERLAYS - MATERIALS/INSTALLATION	AS/NZS 4200.1,	
ROOFING: DESIGN AND INSTALLATION PRE-PAINTED AND ORGANIC FILM/METAL LAMINATE PRODUCTS ROOF PLUMBING	AS/NZS 4200.2 AS 1562.1 AS 2728 AS/NZS 3500.3.2	

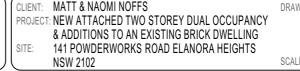

WARE: INERY DOORS **STANDARD**

AS 2688 & AS 3959 AS 1909

N AND INSTALLATION

AS 2047, AS 3959 & AS 1288 AS/NZS 4667 GHENED GLASS PROCESS AS/NZS 4667 ERMOSET POWDER COATING FOR ARCHITECTURAL APPLICATIONS AS 3715-2002 JMINUM ALLOY ERIALS IDENTIFY EACH PIECE OR PANEL AS 1288.

IG OF BUILDINGS AS/NZS 2311 CTION OF STRUCTURAL STEEL AGAINST ATMOSPHERIC CORROSION ECTIVE COATINGS AS/NZS 2312 EPARATION AND PRE-TREATMENT OF SURFACES - ABRASIVE BLAST AS 1627.4-2005

JIDE TO THE SLIP RESISTANCE OF PEDESTRIAN HB197:1999 RESILIENT SHEET AND TILES - INSTALLATION PRACTICES AS 1884 NG CERAMIC TILES AS 2358-1990


ING & GARDEN USE

AS 4419

ART 1 OFF-STREET CAR PARKING

AS/NZS 2890.1:2004

DRAWING: NOTES AND STANDARDS

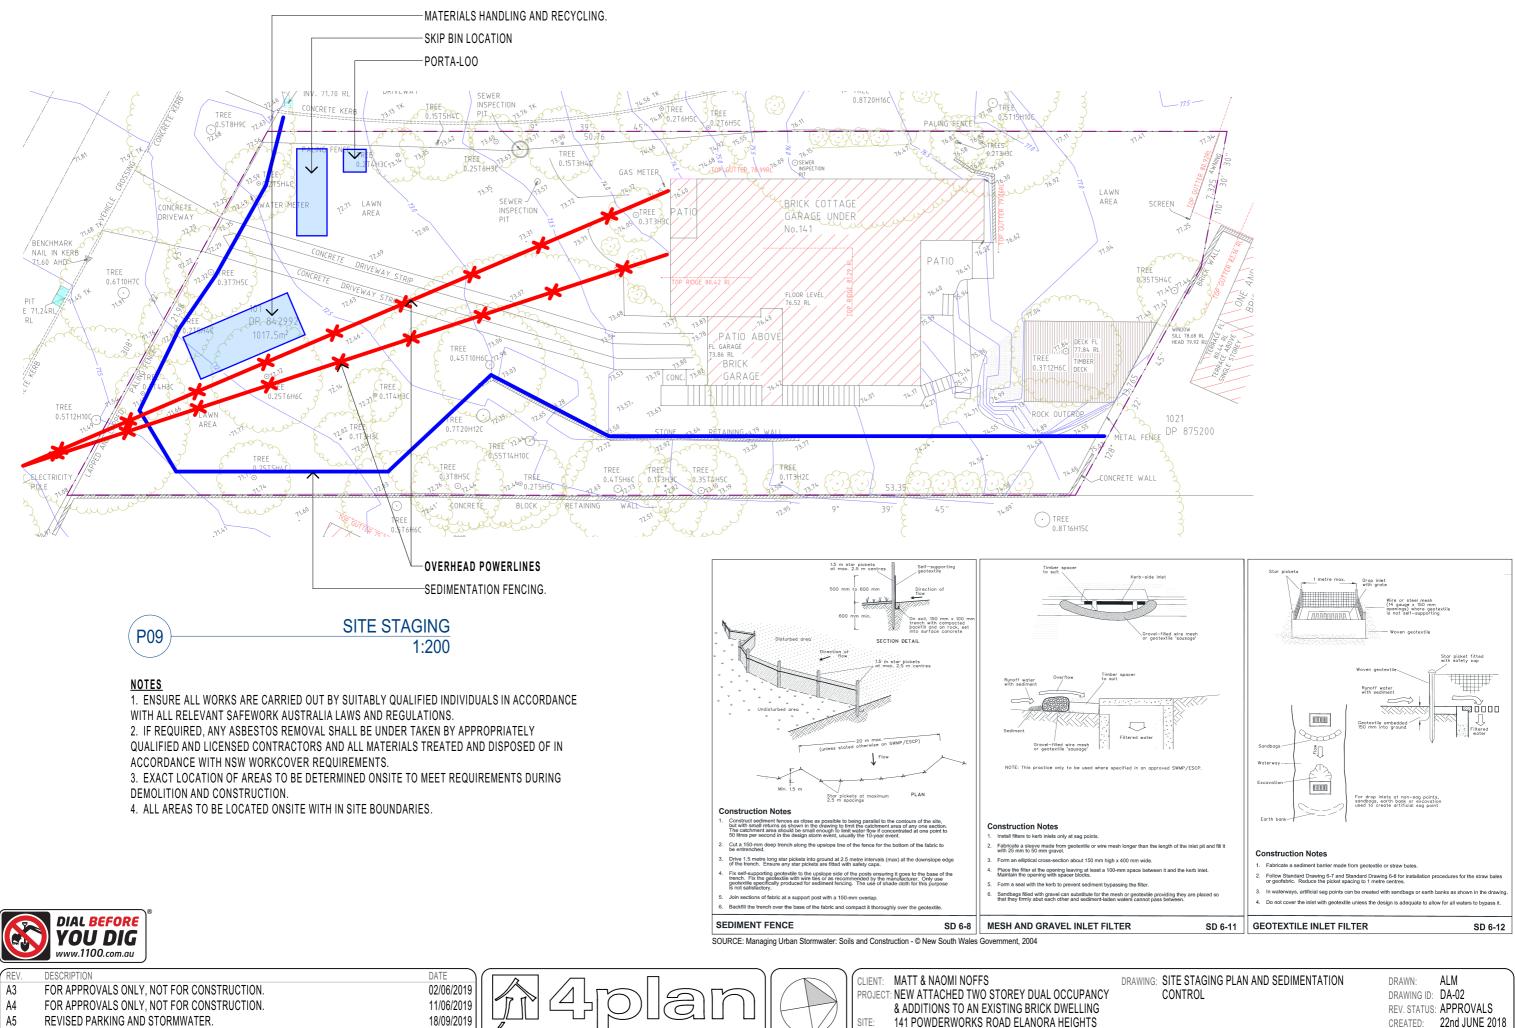


A6 REVISED BASIX - CHANGE HWS & INCLUDE PV SYSTEM. 23/09/2019 0419 988 653 - mail@4plan.com.au - http://4plan.com.au - 36 EAST PARADE EASTWO NSW 2102

DRAWN:	ALM
DRAWING ID:	DA-02
REV. STATUS:	APPROVALS
CREATED:	22nd JUNE 2018
DO NOT SCALE FRO	DM DRAWINGS.

SCALE: AS SHOWN @ A3

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RE	. DESCRIPTION	DATE			MATT & NAOMI NOFES	DRAWING:
A5	REVISED PARKING AND STORMWATER.	18/09/2019		PROJEC	T: NEW ATTACHED TWO STOREY DUAL OCCUPANCY	
A6	REVISED BASIX - CHANGE HWS & INCLUDE PV SYSTEM.	23/09/2019		TROOL	& ADDITIONS TO AN EXISTING BRICK DWELLING	
A7	REVISED - ADDED ACCESS DRIVEWAY DIMENSIONS	30/12/2019		SITE:	141 POWDERWORKS ROAD ELANORA HEIGHTS	
(A8	REVISED - PARKING, VEHICLE CROSSING AND DRIVEWAY GATE CHANGED.	14/03/2020	0419 988 653 - mail@4plan.com.au - http://4plan.com.au - 36 EAST PARADE EASTWOOD		NSW 2102	SCALE:
S:\OneDi	vel4plan_projects_20_1812 Elanora Heights_drawings\1812 Elanora Heights.pln			 -	© 2019 - 4Plan - ABN: 64159346504 - BDAA Accreditation No. 6329 - Copyright of the design and draw	ring are vested with 4P

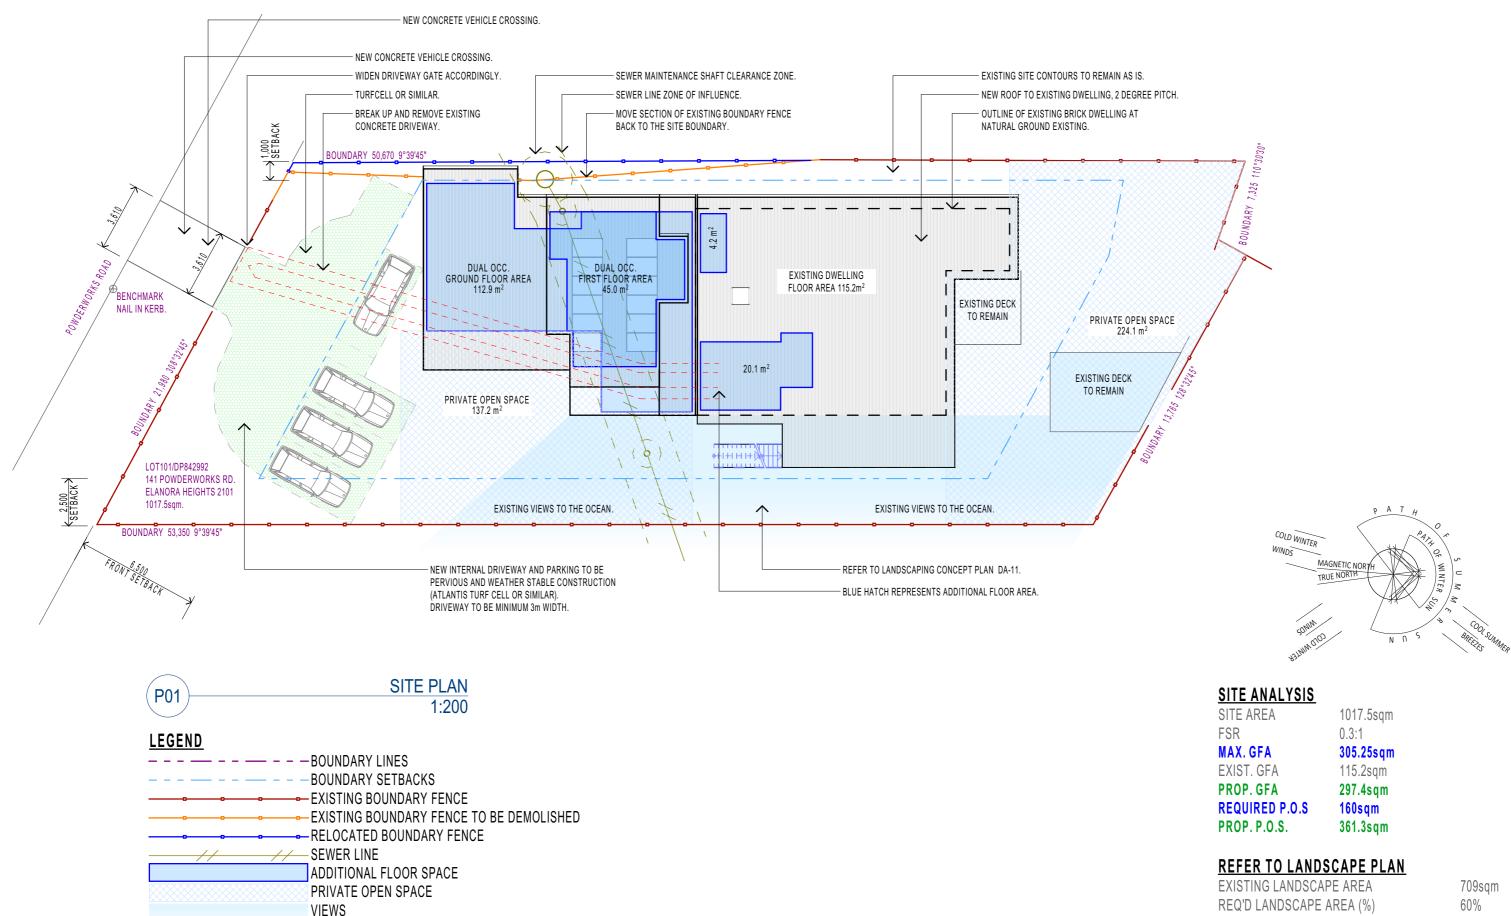TURFCELL (OR SIMILAR) DRIVEWAY AND PARKING

REQ'D LANDSCAPE AREA (%) **REQ'D LANDSCAPE AREA (sqm)** PROP. LANDSCAPE AREA (sqm) PROP. LANDSCAPE AREA LESS PARKING


60% 610.5sqm 615.4sqm 564.1sqm


NG: SITE PLAN AND SITE ANALYSIS

ALM DRAWN: DRAWING ID: DA-10 REV. STATUS: APPROVALS CREATED: 22nd JUNE 2018 DO NOT SCALE FROM DRAWINGS.

AS SHOWN @ A3

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DATE

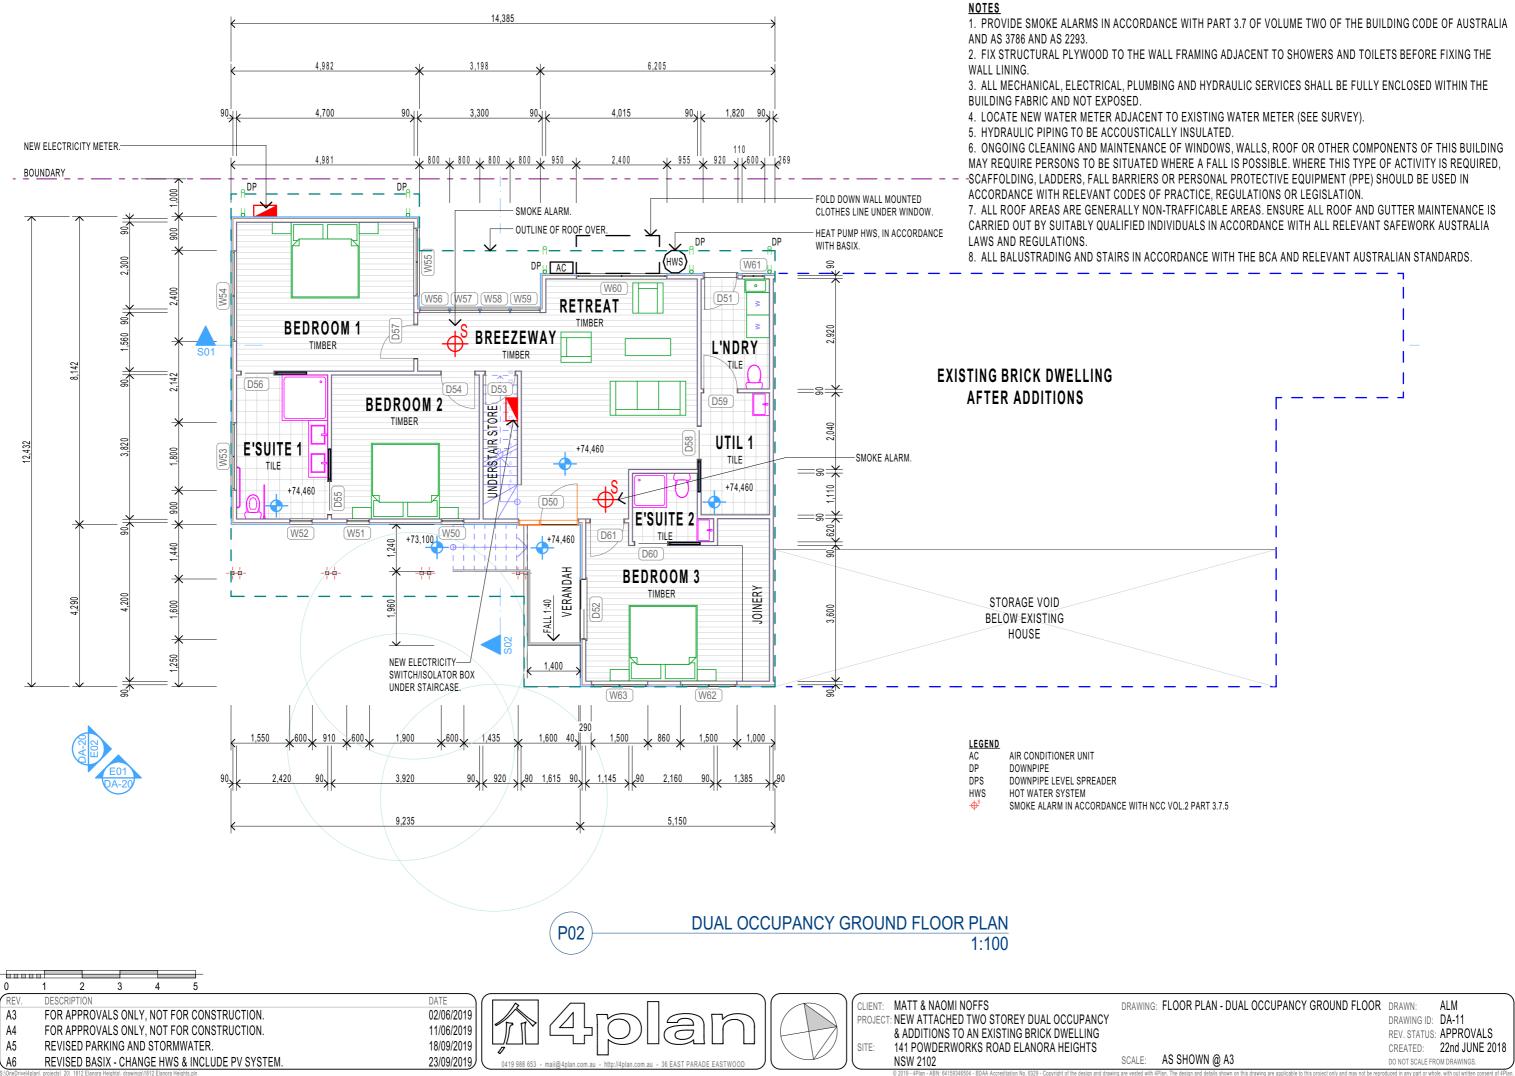02/06/2019

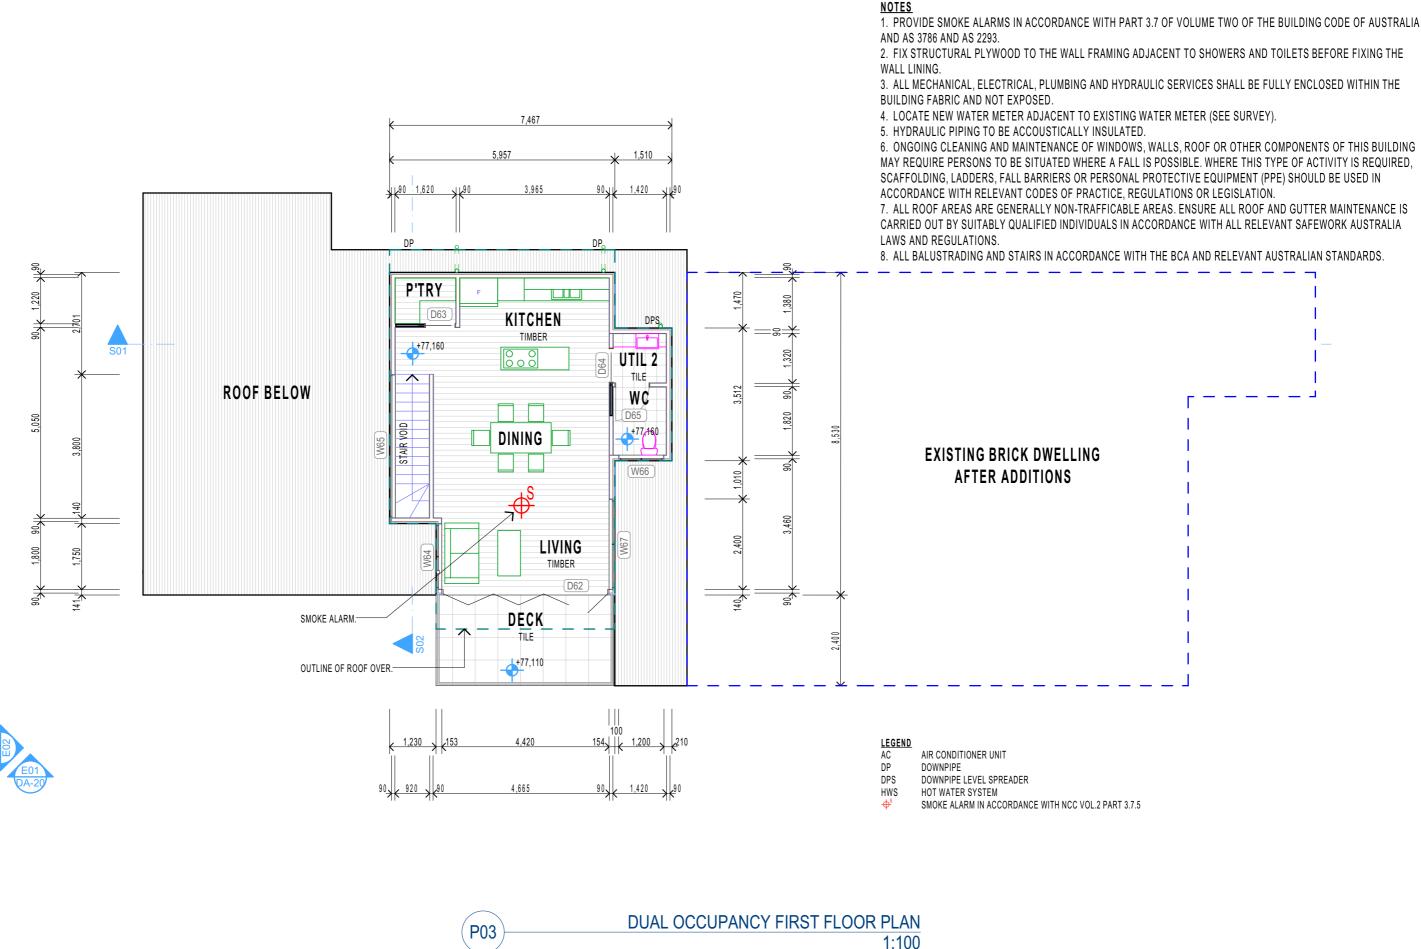11/06/2019

18/09/2019

23/09/2019

- A4 FOR APPROVALS ONLY, NOT FOR CONSTRUCTION.
- A5 REVISED PARKING AND STORMWATER.


A6 REVISED BASIX - CHANGE HWS & INCLUDE PV SYSTEM.

SITE:

PROJECT: NEW ATTACHED TWO STOREY DUAL OCCUPANCY & ADDITIONS TO AN EXISTING BRICK DWELLING 141 POWDERWORKS ROAD ELANORA HEIGHTS NSW 2102

CLIENT: MATT & NAOMI NOFFS




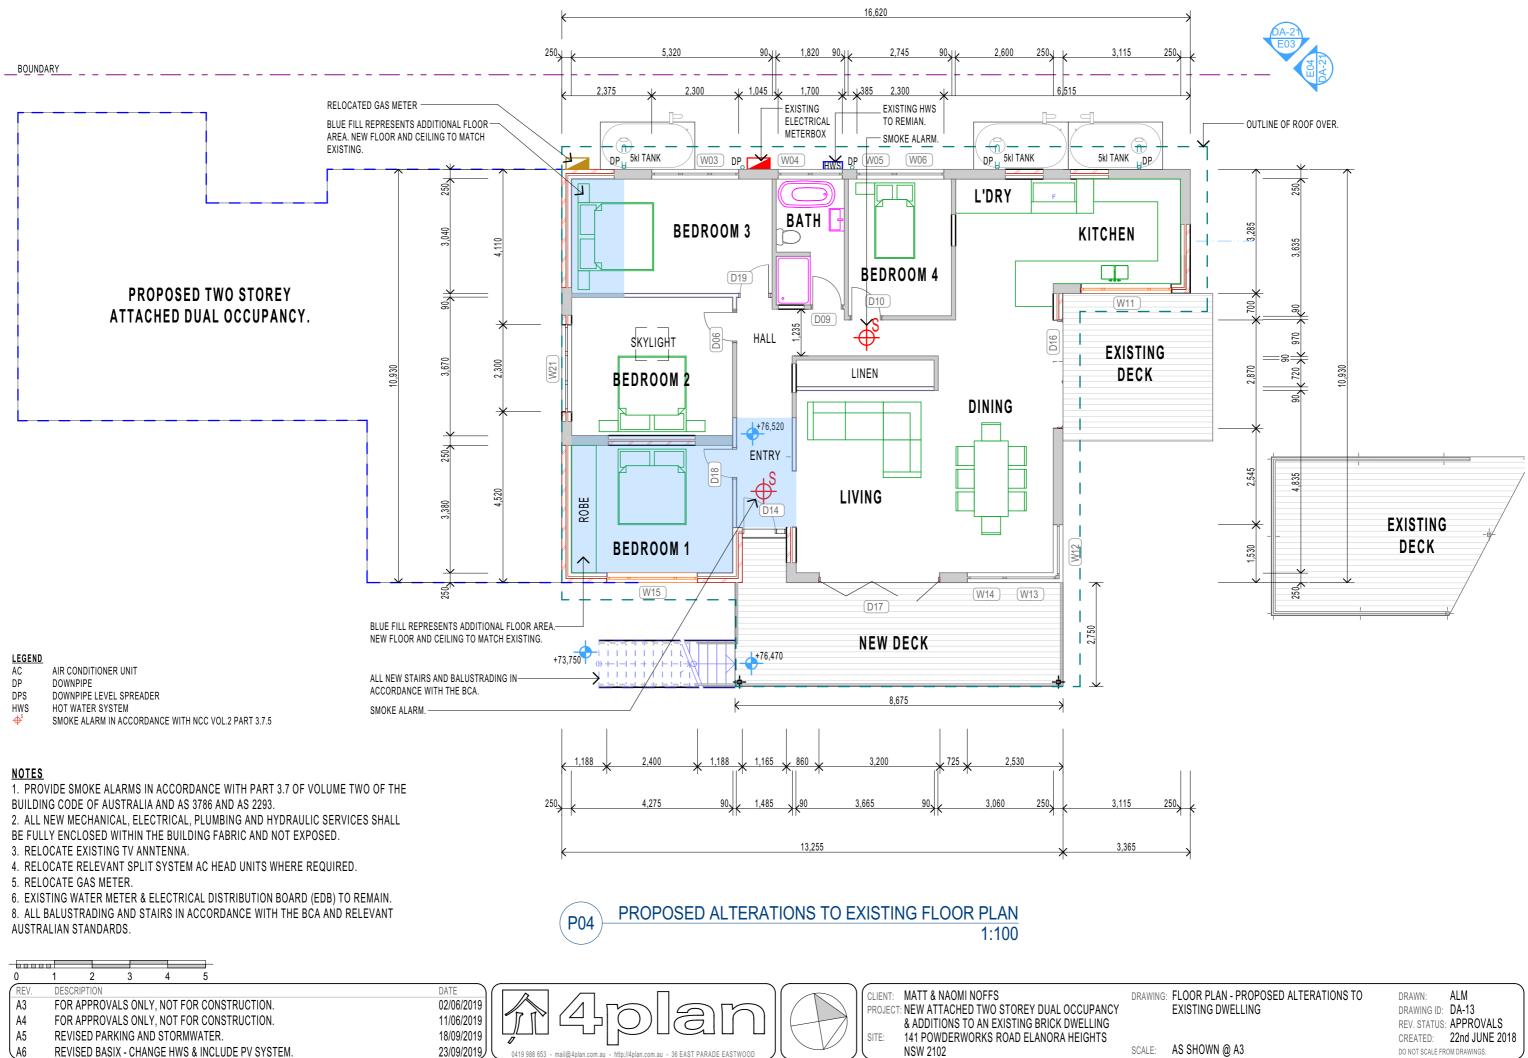

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SCALE: AS SHOWN @ A3



A4 FOR APPROVALS ONLY, NOT FOR CONSTRUCTION.
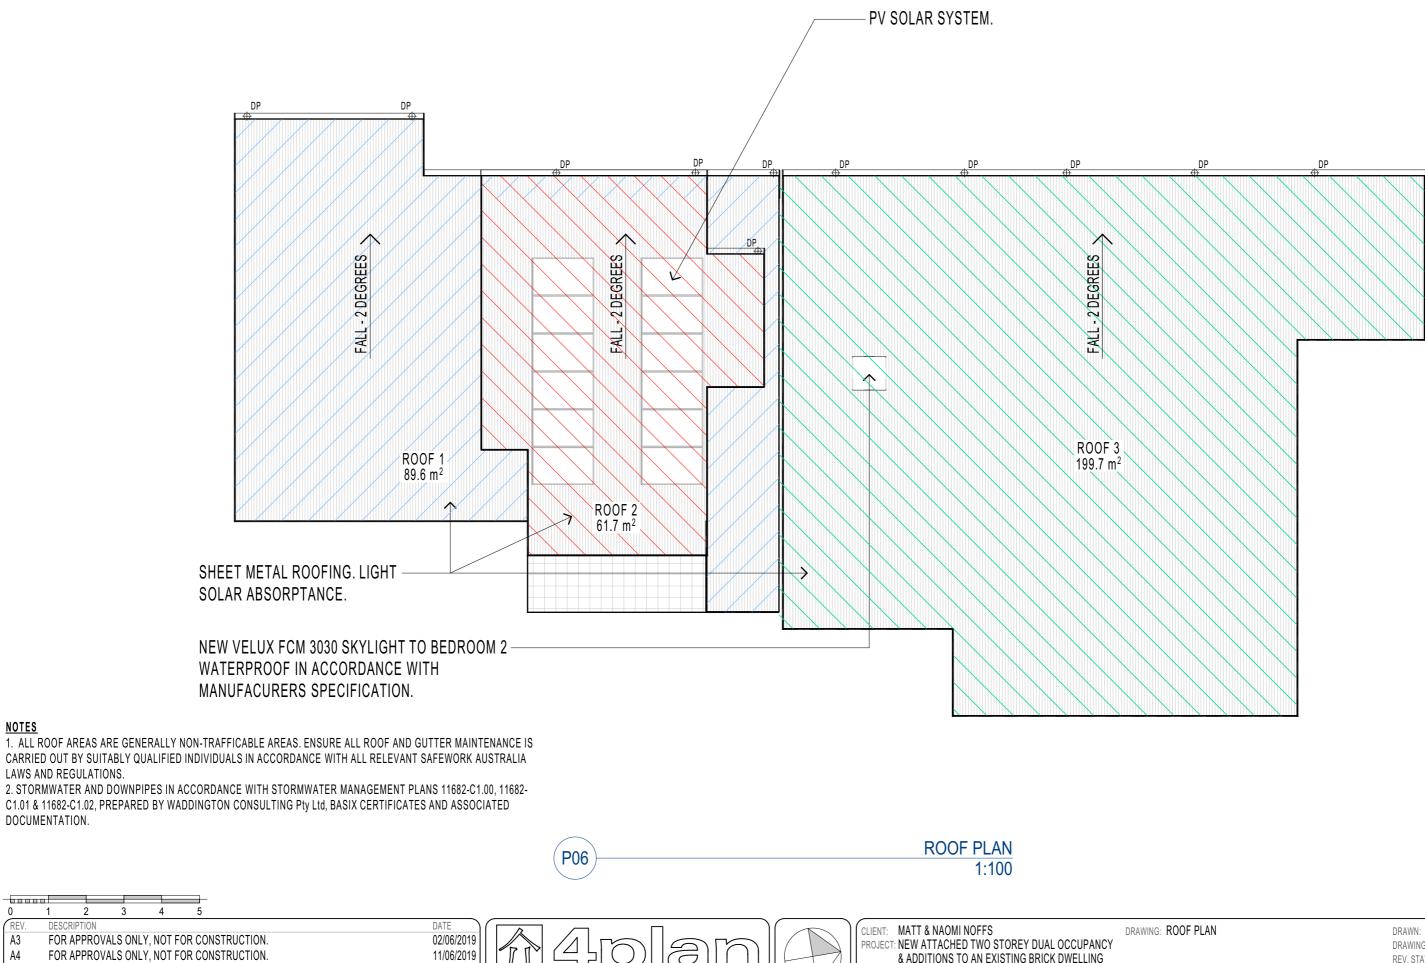
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DESCRIPTION

NOTES

LAWS AND REGULATIONS.

DOCUMENTATION.

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A5 REVISED PARKING AND STORMWATER.

A6 REVISED BASIX - CHANGE HWS & INCLUDE PV SYSTEM. 23/09/2019 0419 988 653 - mail@4plan.com.au - http://4plan.com.au - 36 EAST PARADE EASTWO


18/09/2019

& ADDITIONS TO AN EXISTING BRICK DWELLING SITE: 141 POWDERWORKS ROAD ELANORA HEIGHTS NSW 2102

ALM DRAWN: DRAWING ID: DA-14 REV. STATUS: APPROVALS CREATED: 22nd JUNE 2018 DO NOT SCALE FROM DRAWINGS.

SCALE: AS SHOWN @ A3

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NOTES
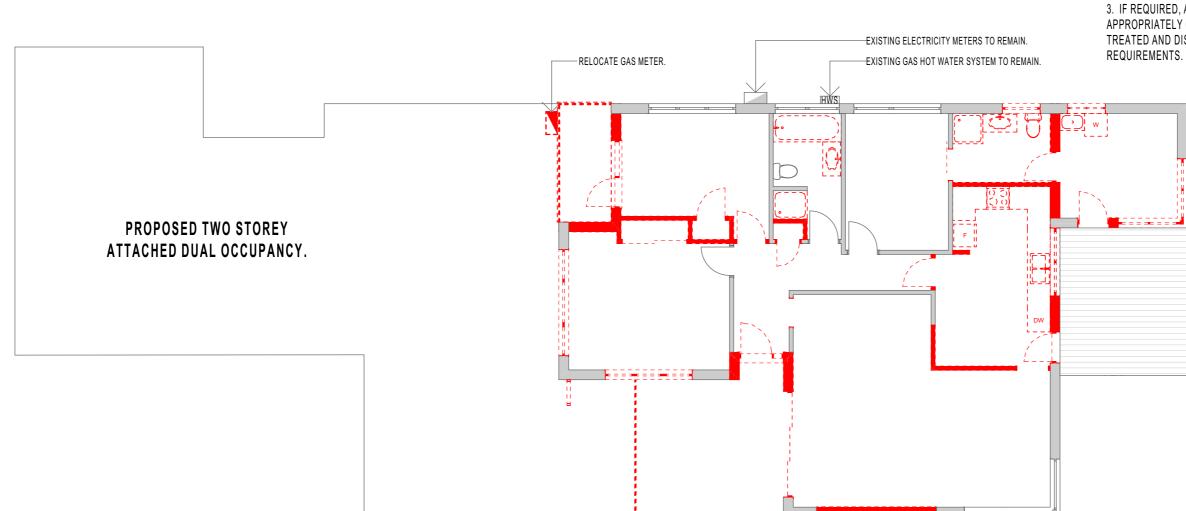
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1. DEMOLISH EXISTING STRUCTURES AS SHOWN (RED HATCH). WHERE REQUIRED, ALL DEMOLITION SHALL BE CARRIED OUT IN ACCORDANCE WITH AS 2601 AND NSW WORKCOVER REGULATIONS.

2. WHERE REQUIRED, ALL EXISTING SERVICES SHALL BE DISCONNECTED, TERMINATED, CAPPED ETC. IN ACCORDANCE WITH THE SUPPLY AUTHORITIES REQUIREMENTS. ANY BUILDING SERVICES SHALL BE RECONNECTED IN ACCORDANCE WITH THE SUPPLY AUTHORITIES PROCEDURES.

3. IF REQUIRED, ANY ASBESTOS REMOVAL SHALL BE UNDER TAKEN BY APPROPRIATELY QUALIFIED AND LICENSED CONTRACTORS AND ALL MATERIALS TREATED AND DISPOSED OF IN ACCORDANCE WITH NSW WORKCOVER




DRAWING: DEMOLITION PLAN

ALM DRAWN: DRAWING ID: DA-15 REV. STATUS: APPROVALS CREATED: 22nd JUNE 2018 DO NOT SCALE FROM DRAWINGS.

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EYE LEVEL ABOVE EXISTING PATIO (RL 76.43), EQUIVALENT TO EYE LEVEL ABOVE NEW DECK.

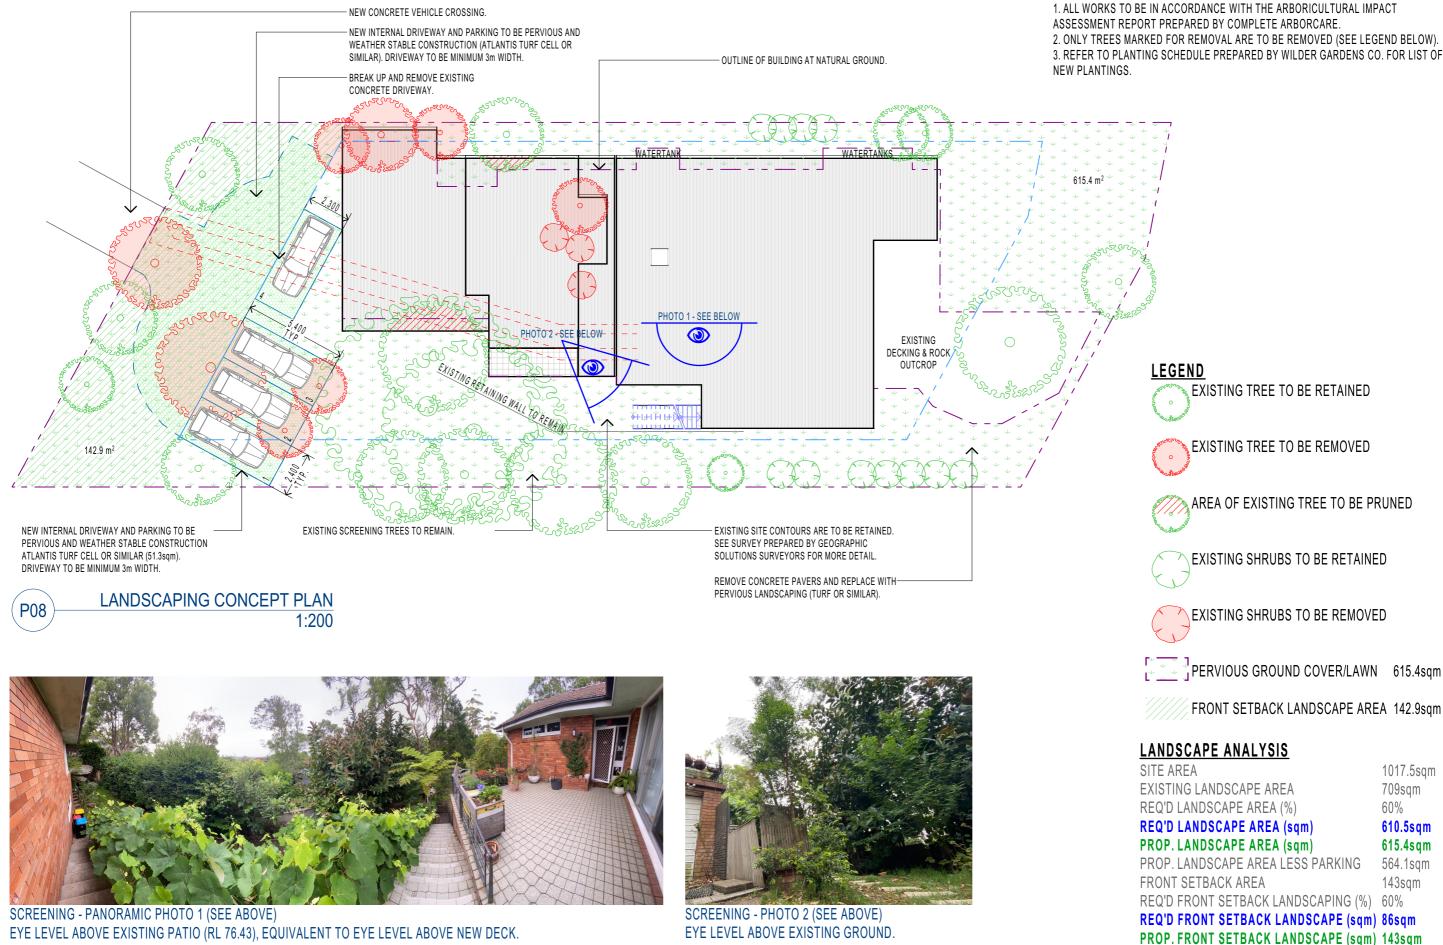

EYE LEVEL ABOVE EXISTING GROUND.

0 1 2 3 4 5 6 7 8 9 10

- DESCRIPTION
- A5 REVISED PARKING AND STORMWATER.
- A6 REVISED BASIX - CHANGE HWS & INCLUDE PV SYSTEM.
- A7 **REVISED - ADDED ACCESS DRIVEWAY DIMENSIONS**
- REVISED PARKING, VEHICLE CROSSING AND DRIVEWAY GATE CHANGED A8



<u>NOTES</u>

DRAWING: LANDSCAPING CONCEPT PLAN

Wilder Gardens .Co

Landscape Design for* 141 POWDER-WORKS ROAD, ELANORA HEIGHTS 2101.

Contact / Adam Byrne 0404 413 813 / wildergardensoz@gmail.com Lic No. 344757C



Backhousia myrtifolia -Grey myrtle



Correa alba - White

01





Leptospermum laevigatum -Coast Tea-Tree

Westringa Fruticosa -Coastal Rosemary

PLANTINGS



Syzygium australe -Lilly pilly



Grevillea sericea - Pink spider grevillea






Prostanthera ovalifolia

Myoporum parvifolium



Kangaroo Grass

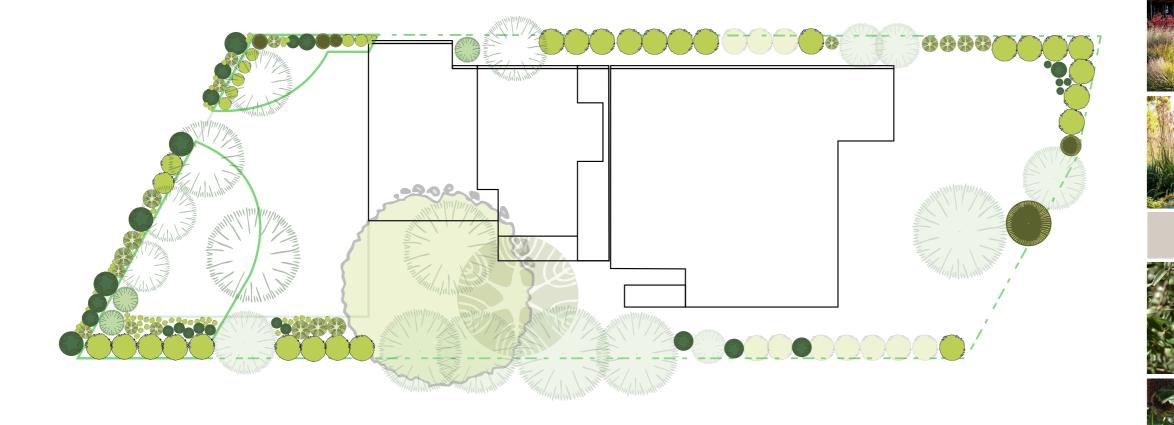





02



Actinotus helianthi -Flannel flower




Themeda australis /




Eremophila nivea – Emu Bush




Chrysocephalum - Yellow buttons

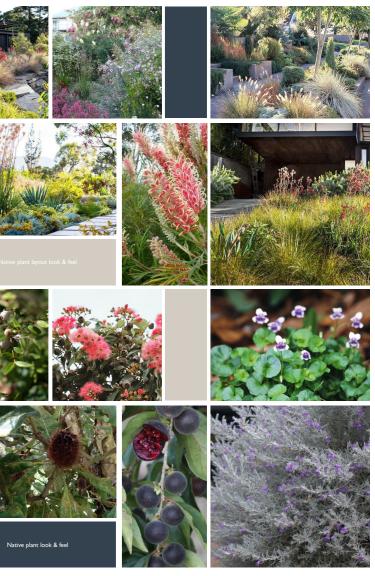

PLANTING LOOK & FEEL

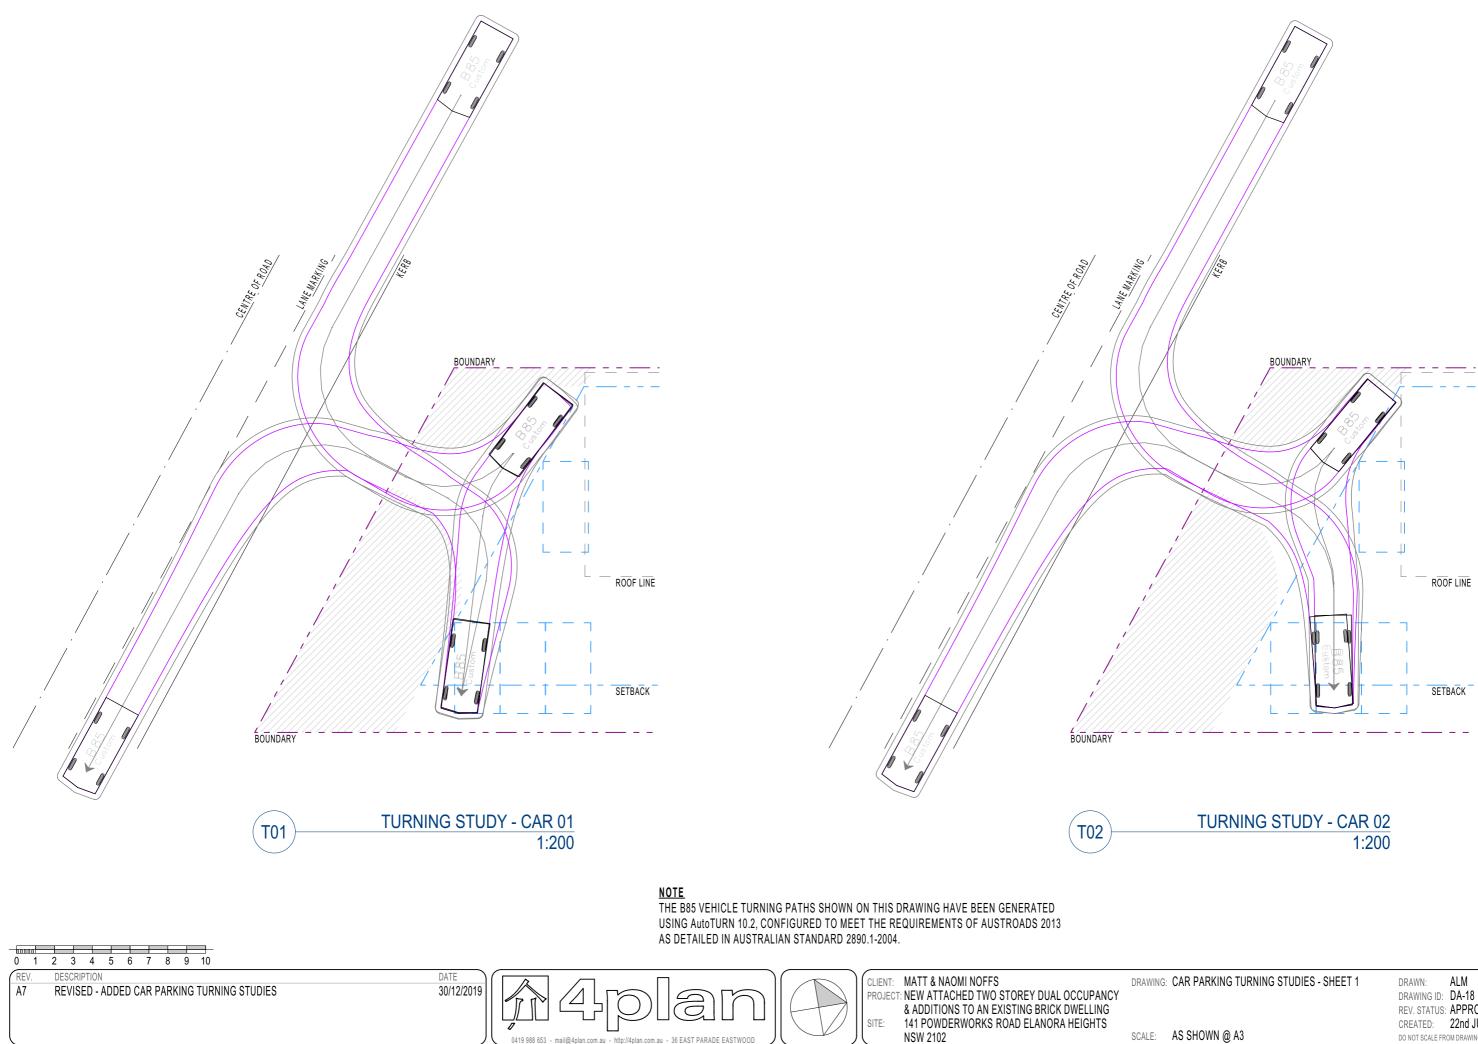

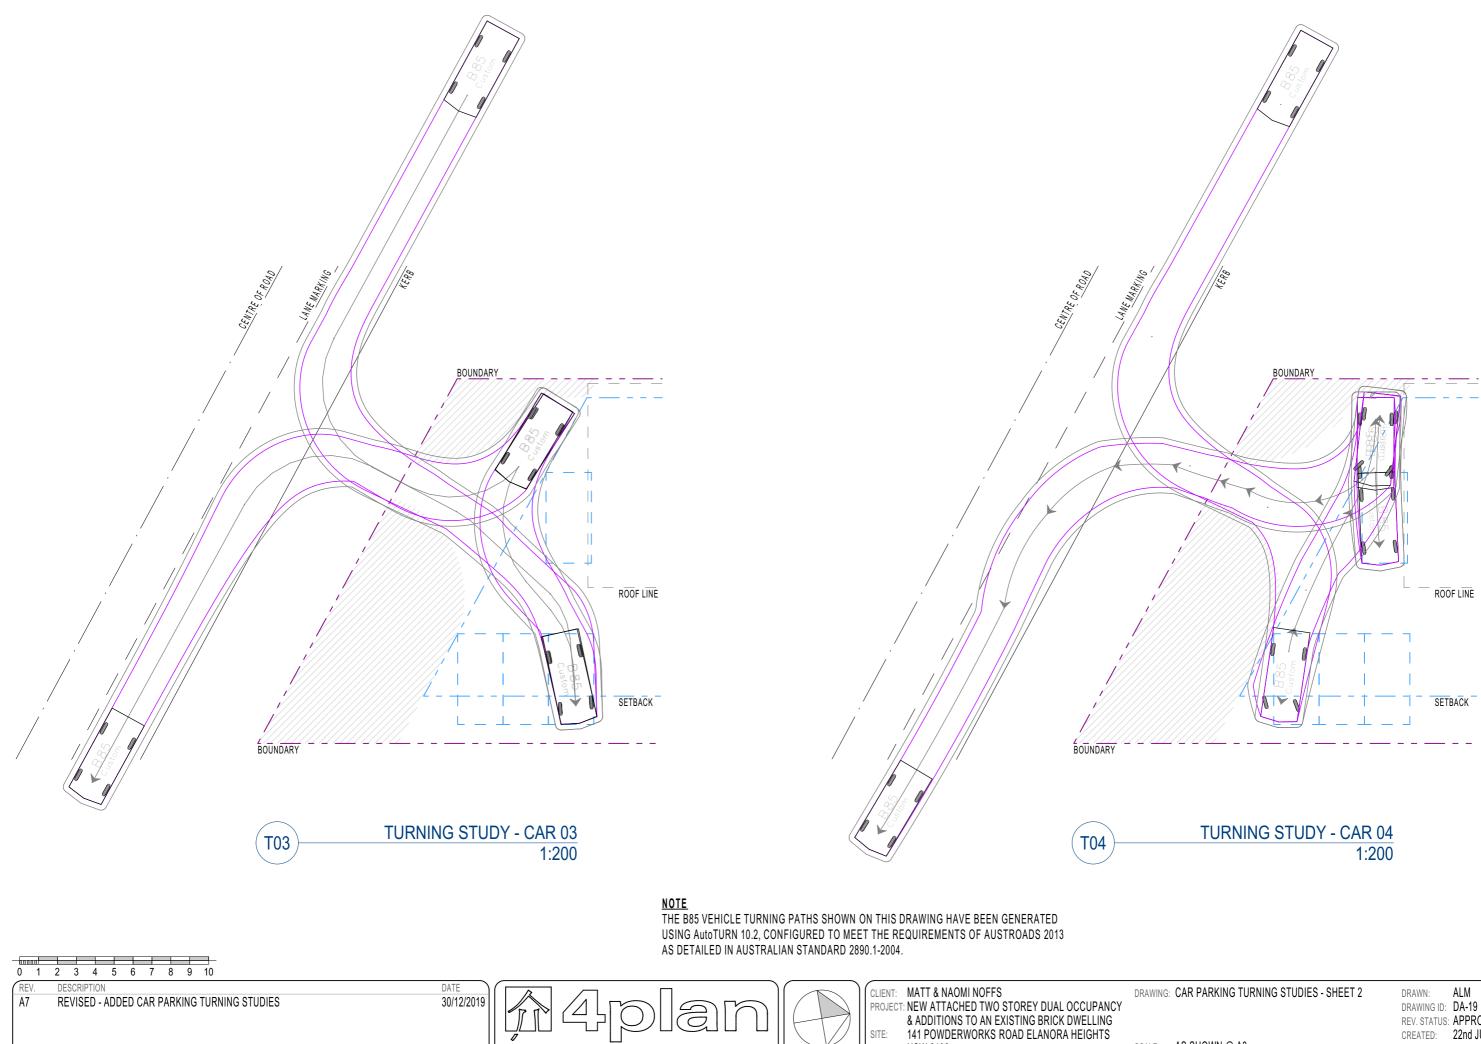

olan_projects_19\1812 Elanora Heights_drawings\1812 Elanora Heigh

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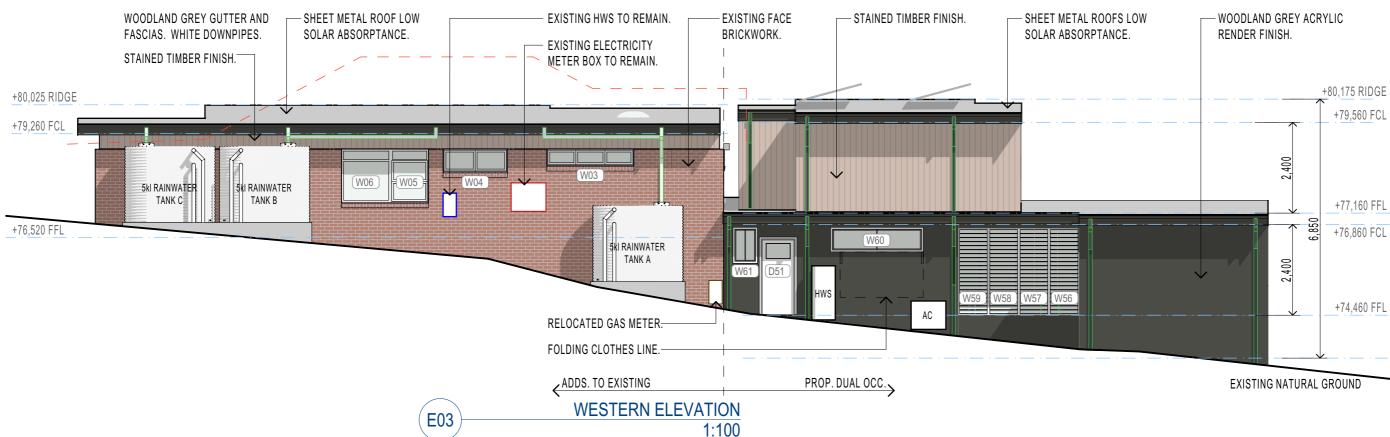


ALM DRAWING ID: DA-20 REV. STATUS: APPROVALS CREATED: 22nd JUNE 2018 DO NOT SCALE FROM DRAWINGS.

uced in any part or whole, with



WHITE WINDOW AND DOOR TRIMS.



PV SOLAR SYSTEM BEYOND.


ROOFS BEYOND.


DRAWING: ELEVATIONS

ALM DRAWN: DRAWING ID: DA-21 REV. STATUS: APPROVALS CREATED: 22nd JUNE 2018 DO NOT SCALE FROM DRAWINGS.

SCALE: AS SHOWN @ A3

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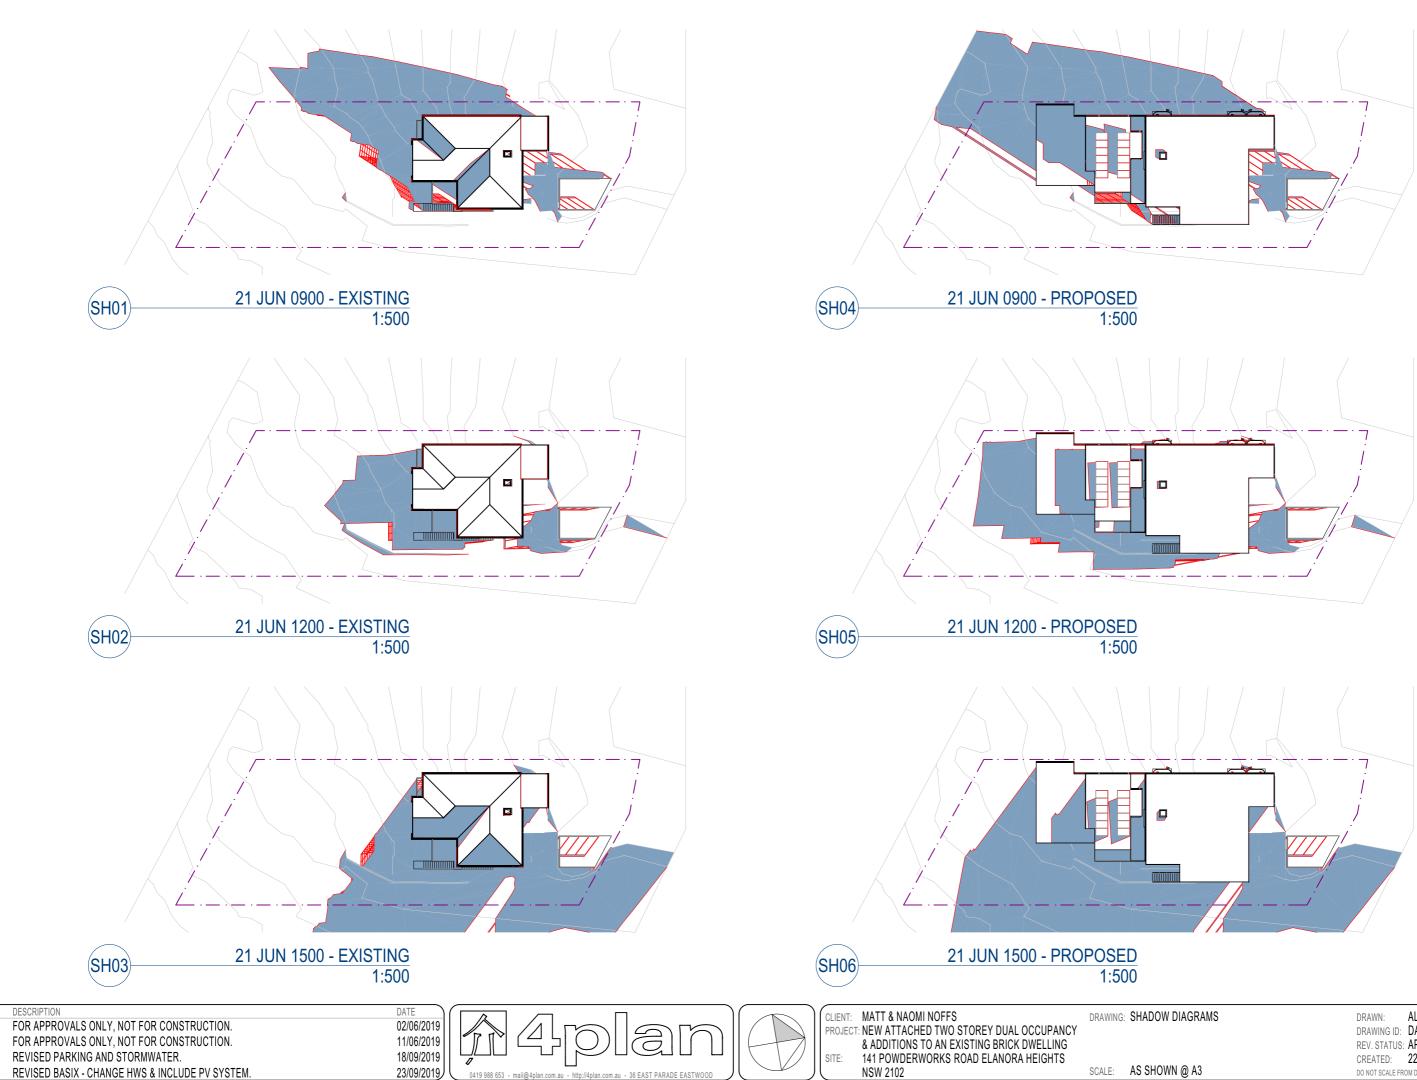
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SECTIONS	DRAWN: ALM
	DRAWING ID: DA-22
	REV. STATUS: APPROVALS
	CREATED: 22nd JUNE 2018
AS SHOWN @ A3	DO NOT SCALE FROM DRAWINGS.

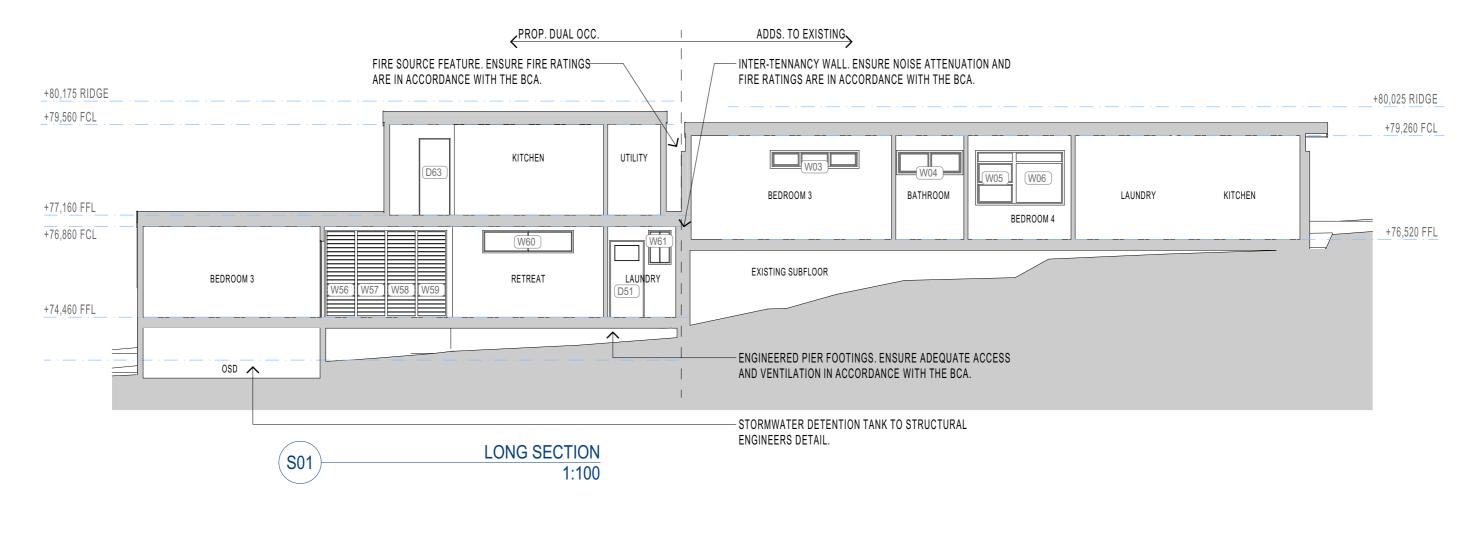
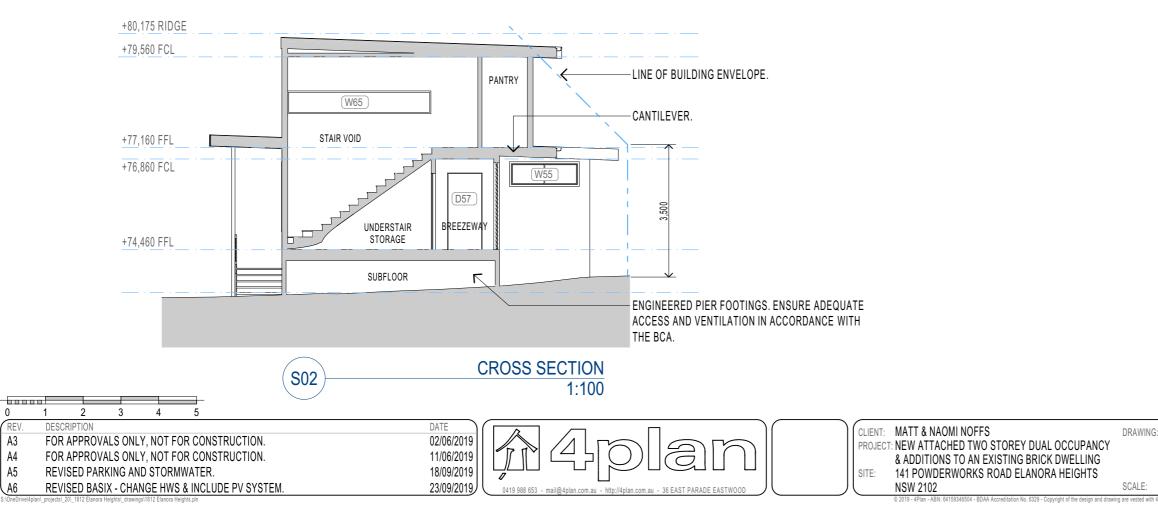
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DRAWN: ALM DRAWING ID: DA-23 REV. STATUS: APPROVALS CREATED: 22nd JUNE 2018 DO NOT SCALE FROM DRAWINGS.

WINDOW SCHEDUILE	E - ALL NEW WINDOWS	S IN ACCORDANCE W		/7						
ID	W03	W04	W05	+/ W06	W11	W12	W13	W14	W15	
RENO STATUS	Existing	Existing	Existing	Existing	New	Existing	Existing	Existing	New	-
DESCRIPTION	AWNING	AWNING	AWNING	FIXED	SLIDING	FIXED	FIXED	AWNING	SLIDING	
GLAZING	SINGLE CLEAR	SINGLE CLEAR	SINGLE CLEAR	SINGLE CLEAR	SINGLE LOW-E	SINGLE CLEAR	SINGLE CLEAR	SINGLE CLEAR	SINGLE LOW-E	
FRAME	TIMBER	TIMBER	TIMBER	TIMBER	TIMBER	TIMBER	TIMBER	TIMBER	TIMBER	
LOCATION	ALTS. BEDROOM 3	ALTS. BATHROOM	ALTS. BEDROOM 4	ALTS. BEDROOM 4	ALTS. KITCHEN	ALTS. DINING	ALTS. DINING	ALTS. DINING	ALTS. BEDROOM 1	
WxH	2,300×430	1,700×600	1,000×1,400	1,300×1,400	2,400×1,200	1,340×1,700	1,340×1,700	1,000×1,700	2,400×1,200	
AREA (sqm)	0.99	1.02	1.40	1,300×1,400	2,400×1,200	2.53	2.53	1.70	2,400×1,200	
SILL HEIGHT	1,900	1,730	930	930	1,100	630	630	630	1,100	
HEAD HEIGHT	2,330	2,330	2,330	2,330	2,300	2,330	2,330	2,330	2,300	
ORIENTATION	2,330 W	2,330 W	2,330 W	2,330 W	2,300 F	2,330 N	2,330 E	2,330 F	2,300 F	-
EAVES	600mm	600mm	600mm	600mm	450mm	450mm	2750mm	2750mm	450mm	-
OVERSHADOWING	N	N	N	N	4JOIIIII	N	N	N	430mm	-
COMMENTS	IN	IN .	IN	IN	IN	11	IN	IN	IN	-
										-
ELEVATION										
ID	W51	W52	W53	W54	W55	W56	W57	W58	W59	
RENO STATUS	New	New	New	New	New	New	New	New	New	
DESCRIPTION	CASEMENT	CASEMENT	SLIDING	SLIDING	SLIDING	LOUVRE	LOUVRE	LOUVRE	LOUVRE	
GLAZING	DBL GLAZE	DBL GLAZED	DBL GLAZED	DBL GLAZE	DBL GLAZE	SINGLE CLEAR	SINGLE CLEAR	SINGLE CLEAR	SINGLE CLEAR	
FRAME	METAL	METAL	METAL	METAL	METAL	METAL	METAL	METAL	METAL	
LOCATION	DUAL OCC. BEDROOM 2	DUAL OCC. ESUITE 1	DUAL OCC. ESUITE 1	DUAL OCC. BEDROOM 1	DUAL OCC. BEDROOM 1	DUAL OCC. BREEZEWAY	DUAL OCC. BREEZEWAY	DUAL OCC. BREEZEWAY	DUAL OCC. BREEZEWAY	[
WxH	600×1,800	600×1,800	1,800×600	2,400×1,500	1,800×600	800×2,300	800×2,300	800×2,300	800×2,300	
AREA (sqm)	1.08	1.08	1.08	3.60	1.08	1.84	1.84	1.84	1.84	
SILL HEIGHT	500	500	1,700	800	1,700	0	0	0	0	
HEAD HEIGHT	2,300	2,300	2,300	2,300	2,300	2,300	2,300	2,300	2,300	
ORIENTATION	E	E	S	S	N	W	W	W	W	
EAVES	1900mm	1900mm	Omm	Omm	PART	1450mm	1450mm	1450mm	1450mm	
OVERSHADOWING	N	N	N	N	N	N	N	N	N	
COMMENTS		FROSTED								
ELEVATION										
	W63	W64	W65	W66	W67	WS01				
RENO STATUS	New	New	New	New	New	New				
DESCRIPTION	SLIDING	SLIDING	FIXED	SLIDING	SLIDING	SKYLIGHT				
GLAZING	DBL GLAZE	DBL GLAZE	DBL GLAZE	SINGLE CLEAR	DBL GLAZE	DBL GLAZE				
FRAME	METAL	METAL	METAL	METAL	METAL	METAL				
LOCATION	DUAL OCC. BEDROOM 3	DUAL OCC. LIVING	DUAL OCC. STAIR VOID	DUAL OCC. WC	DUAL OCC. LIVING	ALTS. BEDROOM 2				
W x H	1,500×600	1,750×600	3,800×600	1,200×600	2,400×600					
AREA (sqm)	0.90	1.05	2.28	0.72	1.44					
SILL HEIGHT	1,700	2,080	1,200	2,080	2,080					
HEAD HEIGHT	2,300	2,680	1,800	2,680	2,680					
ORIENTATION	E	S	S	E	N	N/A				
EAVES	Omm	Omm	0mm	Omm	Omm	N/A				
OVERSHADOWING	N	N	N		N	N/A				
COMMENTS				FIRE SHUTTER FRL -/60/-						
ELEVATION						A				

A3 FOR APPROVALS ONLY, NOT FOR CONSTRUCTION.

A4 FOR APPROVALS ONLY, NOT FOR CONSTRUCTION.

A5 REVISED PARKING AND STORMWATER.

A6 REVISED BASIX - CHANGE HWS & INCLUDE PV SYSTEM.

 MATT & NAOMI NOFFS NEW ATTACHED TWO STOREY DUAL OCCUPANCY	DRAWING:	WINDOW SCHEDULE	DRAWN: ALM DRAWING ID: DA-30
& ADDITIONS TO AN EXISTING BRICK DWELLING 141 POWDERWORKS ROAD ELANORA HEIGHTS			REV. STATUS: APPROVALS CREATED: 22nd JUNE 2018
NSW 2102	SCALE:	AS SHOWN @ A3	DO NOT SCALE FROM DRAWINGS.
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W20	W21	W50
Existing	New	New
FIXED	SLIDING	CASEMENT
SINGLE CLEAR	DBL GLAZE	DBL GLAZE
TIMBER	METAL	METAL
ALTS. UNDERCROFT	ALTS. BEDROOM 2	DUAL OCC. BEDROOM 2
1,900×600	2,300×430	600×1,800
1.14	0.99	1.08
1,740	1,900	500
2,340	2,330	2,300
E	S	E
2750mm	0mm	1900mm
Ν	Ν	Ν
	FIRE SHUTTER FRL -/60/-	
W60	W61	W62
New	New	New
SLIDING	SLIDING	SLIDING
DBL GLAZE	SINGLE CLEAR	DBL GLAZE
METAL	METAL	METAL
DUAL OCC. RETREAT	DUAL OCC. LAUNDRY	DUAL OCC. BEDROOM 3
2,400×600	600×900	1,500×600
1.44	0.54	0.90
1,700	1,400	1,700
2,300	2,300	2,300
W	W	ΕΕ
600mm	600mm	0mm
N	N	N

NOTE: WINDOWS TO BE DEMOLISHED DO NOT APPEAR IN SCHEDULE.

DOOR SCHEDULE -	ALL NEW DOORS WITH	H GLAZING IN ACCOR	DANCE WITH BASIX	AND AS2047								
ID	D06	D09	D10	D14	D16	D17	D18	D19	D50	D51	D52	D53
RENO STATUS	Existing	Existing	Existing	New	New	New	New	New	New	New	New	New
DESCRIPTION	HINGED INTERNAL	HINGED INTERNAL	HINGED INTERNAL	HINGED ENTRY	BIFOLD	BIFOLD	HINGED INTERNAL	HINGED INTERNAL	SOLID HINGE w. HIGH	HINGED ENTRY	SINGLE SLIDING	HINGED INTERNAL
GLAZING	NO	NO	NO	SINGLE CLEAR	SINGLE LOW-E	SINGLE LOW-E	NO	NO	SINGLE CLEAR	SINGLE CLEAR	DBL GLAZE	NO
MATERIAL	TIMBER	TIMBER	TIMBER	TIMBER	IMPROVED ALUMINIUM	IMPROVED ALUMINIUM	TIMBER	TIMBER	TIMBER	TIMBER	METAL	TIMBER
LOCATION	ALTS. BEDROOM 2	ALTS. BATHROOM	ALTS. BEDROOM 4	ALTS. ENTRY	ALTS. DINING	ALTS. LIVING	ALTS. BEDROOM 1	ALTS. BEDROOM 3	DUAL OCC. ENTRY	DUAL OCC. LAUNDRY	DUAL OCC. BEDROOM 3	DUAL OCC. UNDERSTA
WxH	830×2,030	830×2,030	830×2,030	1,165×2,330	2,870×2,300	3,200×2,300	830×2,030	830×2,030	1,600×2,400	920×2,030	1,600×2,400	820×2,030
AREA (sqm)	1.68	1.68	1.68	2.71	6.60	7.36	1.68	1.68	3.84	1.87	3.84	1.66
ORIENTATION	N/A	N/A	N/A	E	Ν	E	N/A	N/A	E	W	S	N/A
EAVES	N/A	N/A	N/A	3750mm	450mm	2750mm	N/A	N/A	4200mm	600mm	1400mm	N/A
OVERSHADOWING	N/A	N/A	N/A	N	Ν	N	N/A	N/A	N	Ν	N	N/A
COMMENTS							TO MATCH EXISTING	TO MATCH EXISTING				
ELEVATION												
ID	D54	D55	D56	D57	D58	D59	D60	D61	D62	D63	D64	D65
RENO STATUS	New	New	New	New	New	New	New	New	New	New	New	New
DESCRIPTION	HINGED INTERNAL	CAVITY SLIDER	CAVITY SLIDER	HINGED INTERNAL	CAVITY SLIDER	HINGED INTERNAL	CAVITY SLIDER	HINGED INTERNAL	BIFOLD	CAVITY SLIDER	CAVITY SLIDER	HINGED INTERNAL
GLAZING	NO	NO	NO	NO	NO	NO	NO	NO	DBL GLAZE	NO	NO	NO
MATERIAL	TIMBER	TIMBER	TIMBER	TIMBER	TIMBER	TIMBER	TIMBER	TIMBER	METAL	TIMBER	TIMBER	TIMBER
LOCATION	DUAL OCC. BEDROOM 2	DUAL OCC. ENSUITE 1	DUAL OCC. ENSUITE 1	DUAL OCC. BEDROOM 1	DUAL OCC. UTILITY	DUAL OCC. LAUNDRY	DUAL OCC. ENSUITE 2	DUAL OCC. BEDROOM 3	DUAL OCC. LIVING	DUAL OCC. PANTRY	DUAL OCC. UTILITY 2	DUAL OCC. WC
WxH	920×2,030	900×2,030	900×2,030	920×2,030	900×2,030	920×2,030	900×2,030	920×2,030	4,420×2,400	820×2,030	920×2,030	920×2,030
AREA (sqm)	1.87	1.83	1.83	1.87	1.83	1.87	1.83	1.87	10.61	1.66	1.87	1.87
ORIENTATION	N/A	N/A	N/A	N/A	N/A	N/A	N/A	N/A	E	N/A	N/A	N/A
EAVES	N/A	N/A	N/A	N/A	N/A	N/A	N/A	N/A	900mm	N/A	N/A	N/A
OVERSHADOWING	N/A	N/A	N/A	N/A	N/A	N/A	N/A	N/A	N	N/A	N/A	N/A
COMMENTS												
ELEVATION												
ID	D66	D67	D68									
RENO STATUS	Existing	Existing	New									
DESCRIPTION	HINGED ENTRY	ROLLER	ROLLER									
GLAZING	NO	NO	NO							NOTE: DOORS TO) BE DEMOLISHED DO NO	T APPEAR IN SCHEDULE.
MATERIAL	TIMBER	METAL	METAL									
LOCATION	ALTS. UNDERCROFT	ALTS. UNDERCROFT	ALTS. UNDERCROFT									
WxH	820×2,040	2,690×2,300	1,500×2,300									
AREA (sqm)	1.67	6.19	3.45									
ORIENTATION	E	N/A	E									
EAVES	N/A	N/A	N/A									
OVERSHADOWING	N/A	N/A	N/A									
COMMENTS												
ELEVATION												

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A4 FOR APPROVALS ONLY, NOT FOR CONSTRUCTION.

A5 REVISED PARKING AND STORMWATER.

REVISED BASIX - CHANGE HWS & INCLUDE PV SYSTEM. A6





DRAWING: DOOR SCHEDULE



(REV.	DESCRIPTION	DATE		RAWIN
	A4	FOR APPROVALS ONLY, NOT FOR CONSTRUCTION.	11/06/2019		VANNIN
	A5	REVISED PARKING AND STORMWATER.	18/09/2019	Image: Project: New All Acheb Two STOREY DUAL OCCUPANCY Image: Project: New All Acheb Two STOREY DUAL OCCUPANCY & ADDITIONS TO AN EXISTING BRICK DWELLING	
	A6	REVISED BASIX - CHANGE HWS & INCLUDE PV SYSTEM.	23/09/2019		
U	A8	REVISED COLOUR SCHEME.	21/03/2020	0419 988 653 - mail@4plan.com.au - http://4plan.com.au - 36 EAST PARADE EASTWOOD NSW 2102 SC	CALE:
S:\C	OneDrive\4plan	_projects_20_1812 Elanora Heights_drawings\1812 Elanora Heights.pln		© 2019 - 4Plan - ABN: 64159346504 - BDAA Accreditation No. 6329 - Copyright of the design and drawing are	vested wit

NG: FINISHES AND COLOURS

DRAWN: ALM DRAWING ID: DA-32 REV. STATUS: APPROVALS CREATED: 22nd JUNE 2018 DO NOT SCALE FROM DRAWINGS.

AS SHOWN @ A3

h APlan. The design and deta duced in any part or whole, with

Toilets 4 Star Kitchen Taps 4 Star Bathroom Taps 4 Star Individual water tank 2000 litres (min.) collecting run off from at least 100sqm of roof area. Connected to landscaping and toilets. Calazing Windows & Glazzd Doors REQUIREMENT REQUIREMENT Star NERGY Reduine ventilation Individual water tank 2000 litres (min.) collecting run off from at least 100sqm of roof area. Electric heat pump – air sourced, fewer than 15 STCs. Bathroom ventilation Individual fan ducted to façade or roof. Manually switched. Individual fan ducted to façade or roof. Manually switched. V15 E 2.8 nil Eavers ≥ Timber or uPVC, single pryor/tic low-e, distance (m) Cooling living areas Ceiling fans and single-phase air-conditioning (1 star zoned). D14 E 0.5 nil Eaves ≥ Timber or uPVC, single pryor/tic low-e, distance (m) 450mm (U-value: 3.9), SHGC: 0.4) Natural lighting 2 Bathrooms. Single-phase air-conditioning (1 star zoned). D16 N 6.6 nil Eaves ≥ Timber or uPVC, single pryor/tic low dividual fan ducted to coolitioning (1 star zoned). D17 E 7.3 nil Eaves ≥ Timber or uPVC, single pryor/tic low dividual water (u-value: 4.48, SHGC: 0.46) 450mm (U-value: 4.48, SHGC: 0.46)	e construction of the residen	REQUIREMENT		the construction of the CONSTRUCTION	REQUIRE	MENT					
at least 100sqm of roof area. Windows & Glazed Windows & Glazed<	To Ki	loilets Kitchen Taps	Star Star	Insulation	External wall: brick veneer				Ceiling: R2.32 (up), roof: foil/sarking		
Hot Water System Bathroom ventilation Electric heat pump – air sourced, fewer than 15 STCs. Tag Orientation Area (sqm) Overshadow (sqm) Shading Device distance (m) Frame & Glass Bathroom ventilation Individual fan ducted to façade or roof. Manually switched. Minully switched. Mis Farme & Glass Device distance (m) Device (u-value: 3.99, SHGC: 0.4) Laundry ventilation Individual fan ducted to façade or roof. Manually switched. W15 E 2.8 nil Eaves 2 Timber or uPVC, single pryolytic low-e, (U-value: 3.99, SHGC: 0.4) Cooling living areas Ceiling fans and single-phase air-conditioning (1 star zoned). D14 E 0.5 nil Eaves 2 Timber or uPVC, single pryolytic low-e, (U-value: 5.71, SHGC: 0.66) Heating living areas Single-phase air-conditioning (1 star zoned). D16 N 6.6 nil Eaves 2 Improved aluminium, single pryolytic low 450mm (U-value: 4.48, SHGC: 0.46) (U-value: 4.48, SHGC: 0.47) (U-value:	at	at least 100sqm of roof area.	Connected to landscaping and toilets.	Windows & Glazed	Windows,		hading de	vices must be insta	lled in accordar	nce with the specification listed in BASIX certificate	
Laundry ventilation Individual fan ducted to façade or roof. Manually switched. W15 E 2.8 nil Eaves ≥ Timber or uPVC, single pyrolytic low-e, 450m Cooling living areas Ceiling fans and single-phase air-conditioning (1 star zoned). D14 E 0.5 nil Eaves ≥ Timber or uPVC, single pyrolytic low-e, 450m Cooling bedrooms Single-phase air-conditioning (1 star zoned). D14 E 0.5 nil Eaves ≥ Timber or uPVC, single pyrolytic low-e, 450m Heating living areas Single-phase air-conditioning (1 star zoned). D14 E 0.5 nil Eaves ≥ Timber or uPVC, single pyrolytic low-e, 450m Heating bedrooms Single-phase air-conditioning (1 star zoned). D16 N 6.6 nil Eaves ≥ Improved aluminium, single pyrolytic low 450m No. 2 Bathrooms. D17 E 7.3 nil Eaves ≥ Improved aluminium, single pyrolytic low 450m Appliances Electric cooktop & electric oven. Private clothes drying line. W11 S 1.0 nil none Standard aluminium, clear/air gap/clear, (U-value: 3.9, SHGC: 0.4) Alternative energy 1.6kW photovoltaic system. W11	Hi Bi	Hot Water System Bathroom ventilation	Individual fan ducted to façade or roof. Manually switched.	Doors		Orientation		height x		Frame & Glass	
Heating living areasSingle-phase air-conditioning (1 star zoned).900mm(U-value: 5.71, SHGČ: 0.66)Heating bedroomsSingle-phase air-conditioning (1 star zoned).D16N6.6nilEaves ≥Improved aluminium, single pyrolytic lowNatural lighting2 Bathrooms.2 Bathrooms.D17E7.3nilEaves ≥Improved aluminium, single pyrolytic lowPool/SpaNo.D17E7.3nilEaves ≥Improved aluminium, single pyrolytic lowAppliancesElectric cooktop & electric oven.900mm(U-value: 4.48, SHGC: 0.46)100mm(U-value: 4.48, SHGC: 0.46)Alternative energy1.6kW photovoltaic system.W21S1.0nilnoneStandard aluminium, clear/airW11E2.9nilEaves ≥Timber or uPVC, single pyrolytic low-e, 450mm450mm(U-value: 3.99, SHGC: 0.4)			Individual fan ducted to façade or roof. Manually switched.		W15	E	2.8	nil			
Heating bedrooms Natural lightingSingle-phase air-conditioning (1 star zoned).D16N6.6nilEaves ≥Improved aluminium, single pyrolytic low 450mmPool/Spa2 Bathrooms.No.D17E7.3nilEaves ≥Improved aluminium, single pyrolytic low 450mmPool/SpaNo.D17E7.3nilEaves ≥Improved aluminium, single pyrolytic low 400mmAppliancesElectric cooktop & electric oven.900mm(U-value: 4.48, SHGC: 0.46)Private clothes drying line.W21S1.0nilnoneStandard aluminium, clear/air gap/clear, (U-value: 5.34, SHGC: 0.67)Alternative energy1.6kW photovoltaic system.W11E2.9nilEaves ≥Timber or uPVC, single pyrolytic low-e, 450mm					D14	E	0.5	nil			
Pool/SpaNo.D17E7.3nilEaves ≥Improved aluminium, single pyrolytic lowAppliancesElectric cooktop & electric oven.900mm(U-value: 4.48, SHGC: 0.46)Private clothes drying line.W21S1.0nilnoneStandard aluminium, clear/air gap/clear, (U-value: 5.34, SHGC: 0.67)Alternative energy1.6kW photovoltaic system.W11E2.9nilEaves ≥Timber or uPVC, single pyrolytic low-e, 450mm	H	leating bedrooms			D16	Ν	6.6	nil		Improved aluminium, single pyrolytic low-e, (U-value: 4.48, SHGC: 0.46)	
Private clothes drying line.W21S1.0nilnoneStandard aluminium, clear/air gap/clear, (U-value: 5.34, SHGC: 0.67)Alternative energy1.6kW photovoltaic system.W11E2.9nilEaves ≥Timber or uPVC, single pyrolytic low-e, 450mm	Po	Pool/Spa			D17	E	7.3	nil		Improved aluminium, single pyrolytic low-e,	
450mm (U-value: 3.99, SHGC: 0.4)			Private clothes drying line.		W21	S	1.0	nil	none	Standard aluminium, clear/air gap/clear,	
					W11	E	2.9	nil			
				Skylights							
Tag Area (sqm) Shading Device Frame & Glass					Tag WS01	Area (sqm) 0.77		Shading Device No shading devi		Frame & Glass Aluminium, moulded pla (or U-value: 6.21, SHG0	



DESCRIPTION REV.

A3 FOR APPROVALS ONLY, NOT FOR CONSTRUCTION.

- A4 FOR APPROVALS ONLY, NOT FOR CONSTRUCTION.
- A5 REVISED PARKING AND STORMWATER.

A6 REVISED BASIX - CHANGE HWS & INCLUDE PV SYSTEM.



)	CLIENT: MATT & NAOMI NOFFS PROJECT: NEW ATTACHED TWO STOREY DUAL OCCUPANCY & ADDITIONS TO AN EXISTING BRICK DWELLING SITE: 141 POWDERWORKS ROAD ELANORA HEIGHTS NSW 2102	DRAWI
	PROJECT: NEW ATTACHED TWO STOREY DUAL OCCUPANCY	
	& ADDITIONS TO AN EXISTING BRICK DWELLING	
	SITE: 141 POWDERWORKS ROAD ELANORA HEIGHTS	
J	NSW 2102	SCALE

WING: BASIX DA REQUIREMENTS

NSW 2102 SCALE: AS STOVIN W AS DOVIN WAY 100000 SCALE FKUM UKAYNINGS.

