# G.J. Gardner. HOMES

## **PROJECT: NEW DWELLING ADDRESS: 12 SCALES PARADE BALGOWLAH HEIGHTS**

LOT #: 30 DP #: 5840

DRAWING LIST			
DRAWING No	DRAWING NAME	REVISION	DATE
A01	COVER SHEET	F	15/12/2020
A02	EXISTING SURVEY PLAN	F	15/12/2020
A03	SITE PLAN	F	15/12/2020
A04	LANDSCAPE PLAN	F	15/12/2020
A05	GROUND FLOOR PLAN	F	15/12/2020
A06	FIRST FLOOR PLAN	F	15/12/2020
A07	ELEVATIONS	F	15/12/2020
A08	ELEVATIONS	F	15/12/2020
A09	SECTIONS	F	15/12/2020
A10	DEMOLITION PLAN	F	15/12/2020
A11	SHADOW DIAGRAM	F	15/12/2020
A12	EROSION & SEDIMENT PLAN	F	15/12/2020
A13	BASIX COMMITMENT	F	15/12/2020
A14	WASTE MANAGEMENT	F	15/12/2020
A15	SITE ANALYSIS	F	15/12/2020
A16	DRIVEWAY DETAIL	F	15/12/2020
A17	CONCRETE SLAB PLAN	F	15/12/2020

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TO G.J. GARDNER HOMES





G.J. Gardner. HOMES **Builders Details** 

KJR SUITE 302 5 CELEBRATION DRIVE BELLA VISTA NSW 2153 ABN 15 078 937 238 (02) 8883 4344 kjrdrafting@kjr.net.au

MILLER

SCALE: 1:100

DRAWING TITLE: COVER SHEET 12 SCALES PARADE BALGOWLAH HEIGHTS



DRAWING REVISION SCHEDULE

	DRAWING REVISION SCHEDULE		
No.	AMENDMENTS	DATE	
Α	FIRST ISSUE	31/08/2020	
В	CHANGES AS PER EMAIL 03/09/2020	10/09/2020	
С	CHANGES AS PER EMAIL 17/09/2020	24/09/2020	
D	CHANGES AS PER EMAIL 08/10/2020	16/10/2020	
E	CHANGES AS PER EMAIL 22/10/2020	03/11/2020	
F	UPDATE TO FULL SET DA ISSUE	15/12/2020	

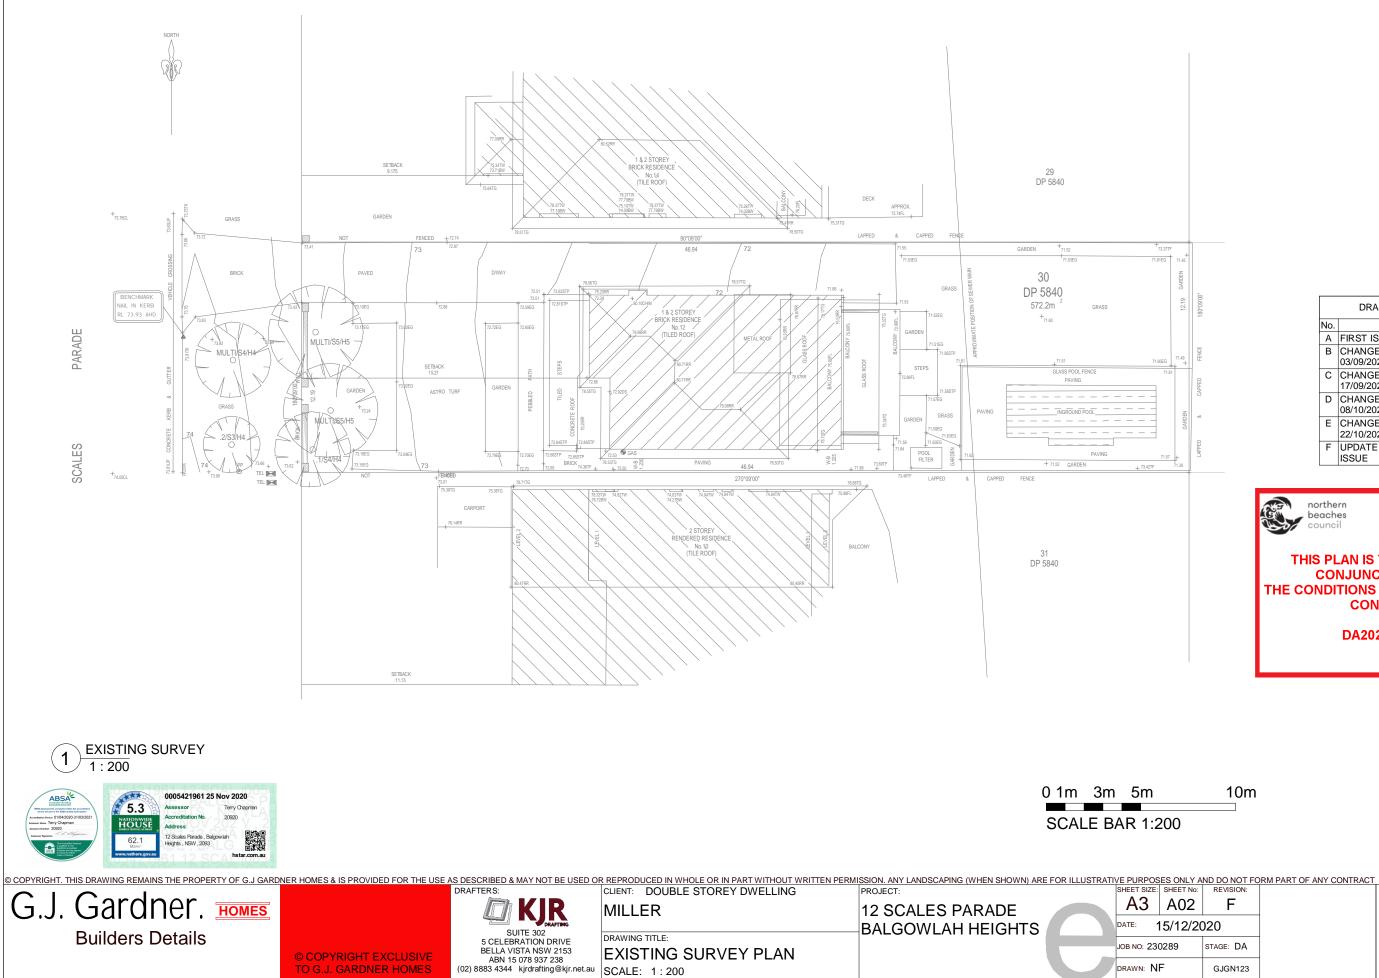


## THIS PLAN IS TO BE READ IN **CONJUNCTION WITH** THE CONDITIONS OF DEVELOPMENT CONSENT

## DA2020/1764

NLY A	ND DO NOT FO	ORM PART OF ANY CONTRACT	
ET No:	REVISION:		I/WE HAVE CHECKED THE PLANS AND AGREE THEY ACCURATELY
01	F		DEPICT THE HOUSE FOR CONSTRUCTION. ANY VARIATIONS REQUESTED AFTER SIGNING WILL INCUR A PROCESSING FEE IN ADDITION TO THE COST OF THE VARIATION ITEMIS AND ANY FURTHER PI ANS TO BE PREPARED
2/20	)20		FURTHER PLANS TO BE PREPARED.
	STAGE: DA		OWNER SIGNED: DATE:
	GJGN123		BUILDER SIGNED: DATE:





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No.	AMENDMENTS	DATE	
А	FIRST ISSUE	31/08/2020	
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F	UPDATE TO FULL SET DA ISSUE	15/12/2020	



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2/2020		
	STAGE: DA	
	GJGN123	

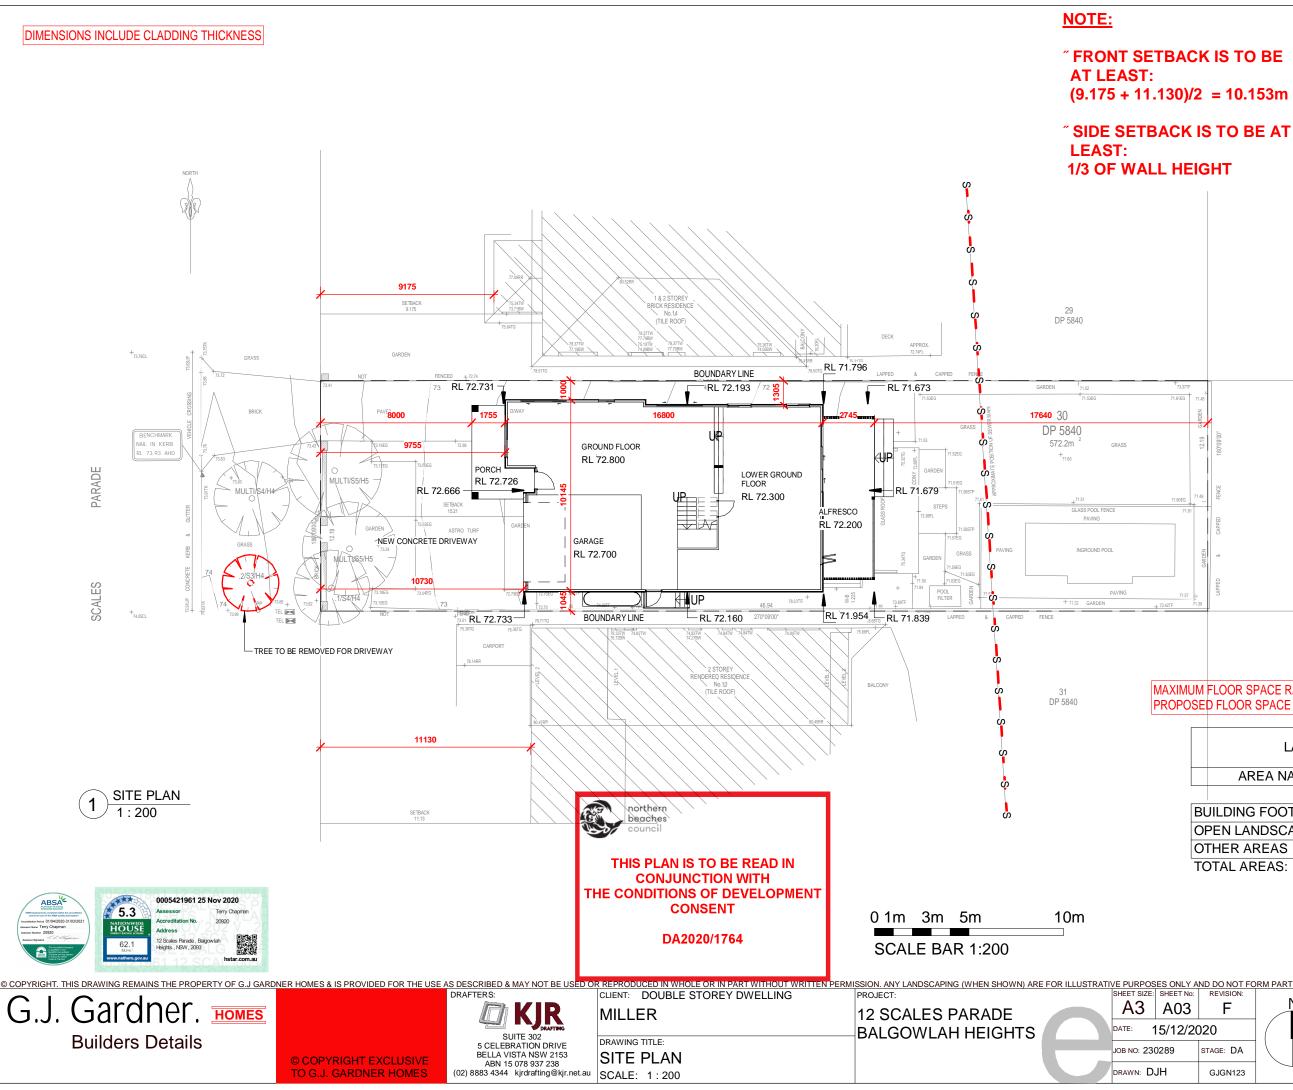
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OWNER SIGNED	DATE

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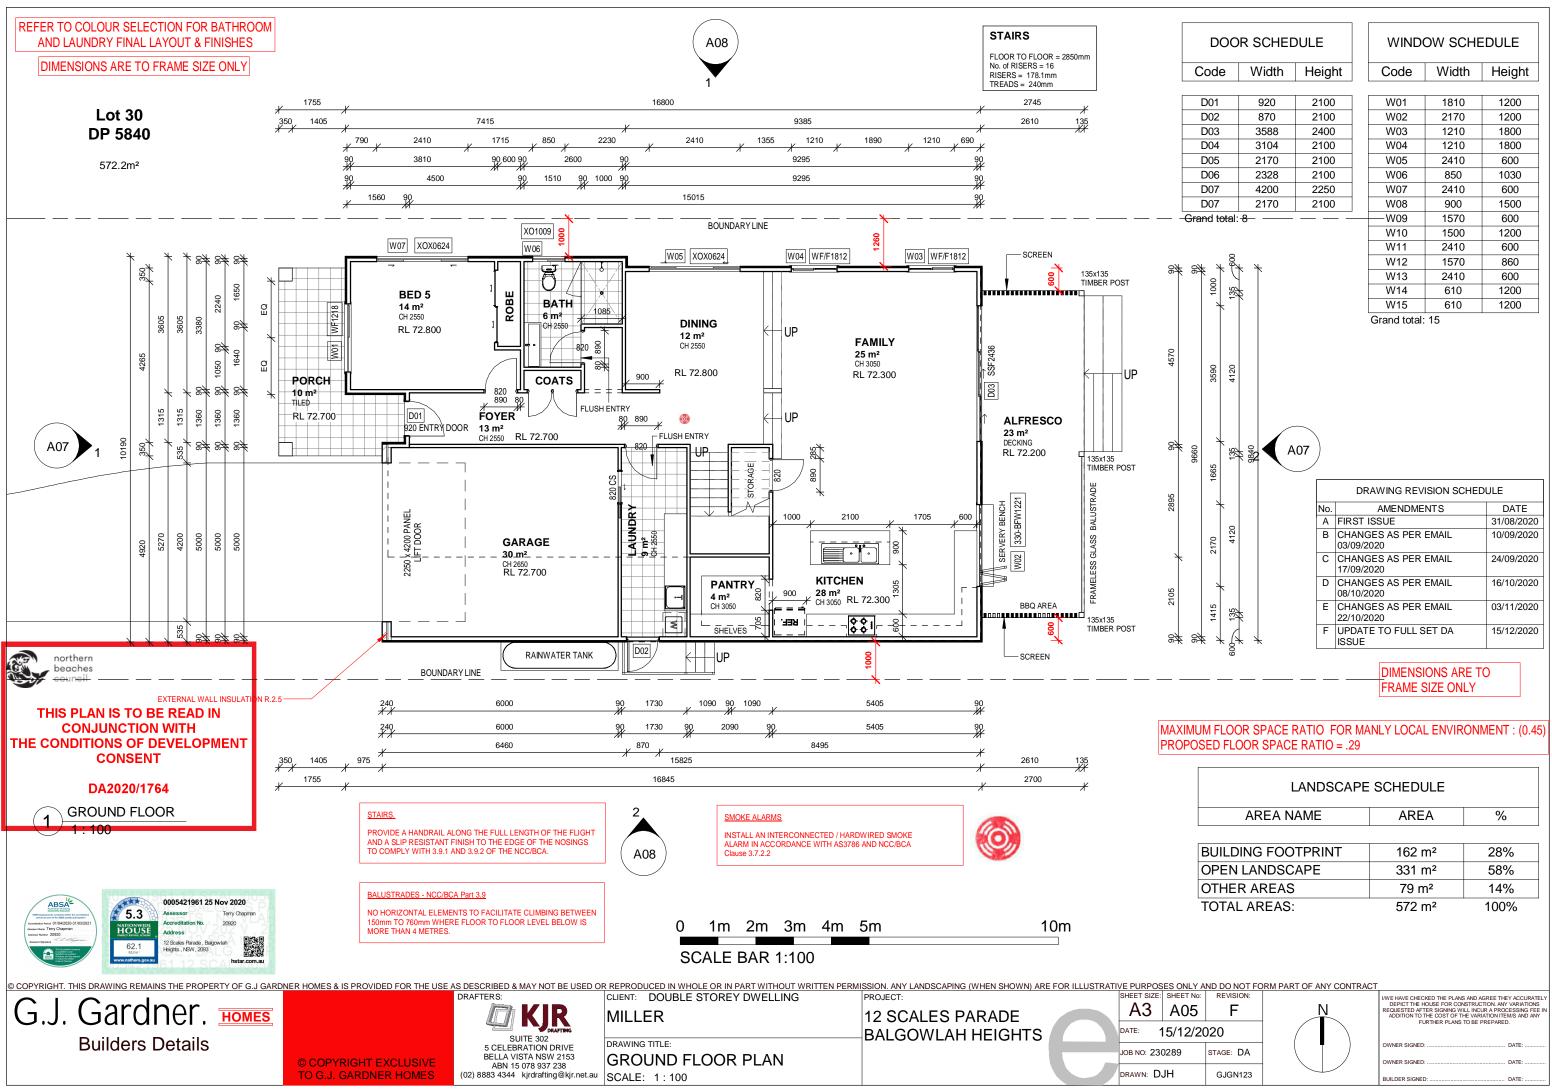
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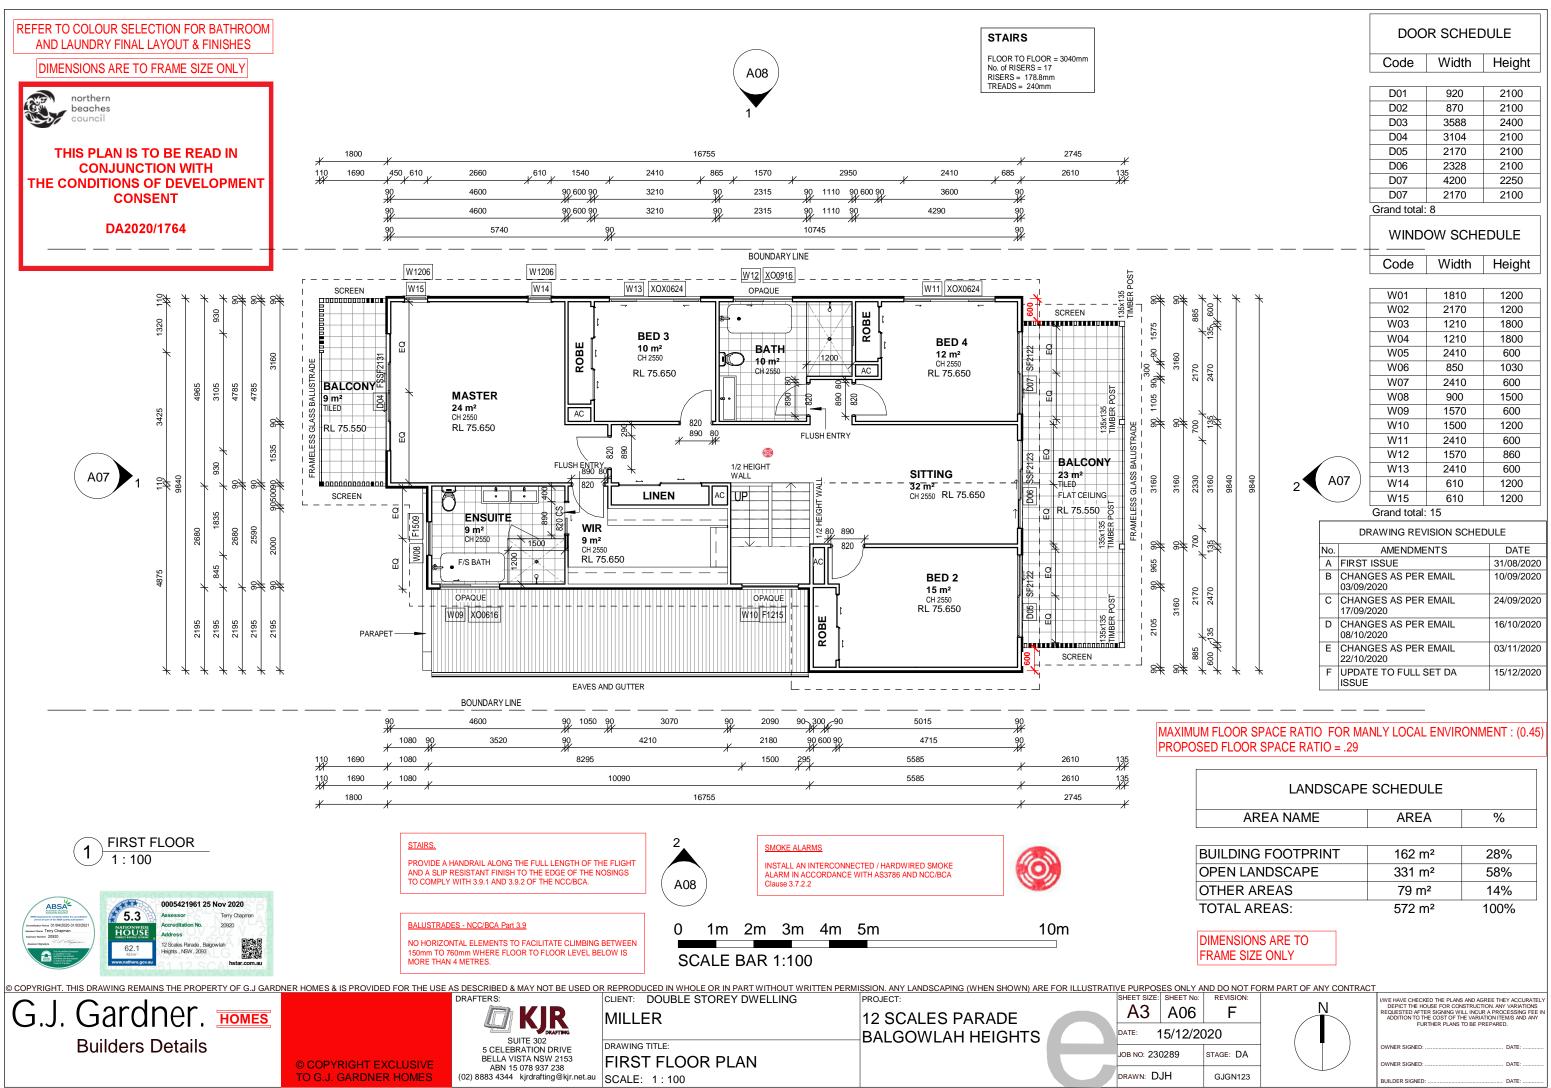


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		С	CHANG 17/09/20	ES AS PER EMAIL	24/09/2020
	GARDEN 8	D		ES AS PER EMAIL	16/10/2020
71.57	LAPPED	E		ES AS PER EMAIL	03/11/2020
7	1.39	F		E TO FULL SET DA	15/12/2020
			ISSUE		
				NLY LOCAL ENVIR	
		SPACE RATIO			
		LANDSU	JAPE	SCHEDULE	
F	AR	EA NAME		AREA	%
L					]
	BUILDING	FOOTPRINT		162 m²	28%
	OPEN LAP	NDSCAPE		331 m²	58%
	OTHER A	REAS		79 m²	14%
•	TOTAL AR	REAS:		572 m²	100%
				DIMENSIONS	INCLUDE
				CLADDING TH	HICKNESS
ONLY A	AND DO NOT FC	ORM PART OF ANY C	ONTRAC	г	
ET No:	REVISION:	N		I/W E HAVE CHECKED THE PLAN	IS AND AGREE THEY ACCURATE
~~				REQUESTED AFTER SIGNING W ADDITION TO THE COST OF T FURTHER PLANS	INSTRUCTION. ANY VARIATIONS VILL INCUR A PROCESSING FEE THE VARIATION ITEM/S AND ANY S TO BE PREPARED.
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	•				
	•				DATE:
03 12/2	020			OWNER SIGNED:	DATE:

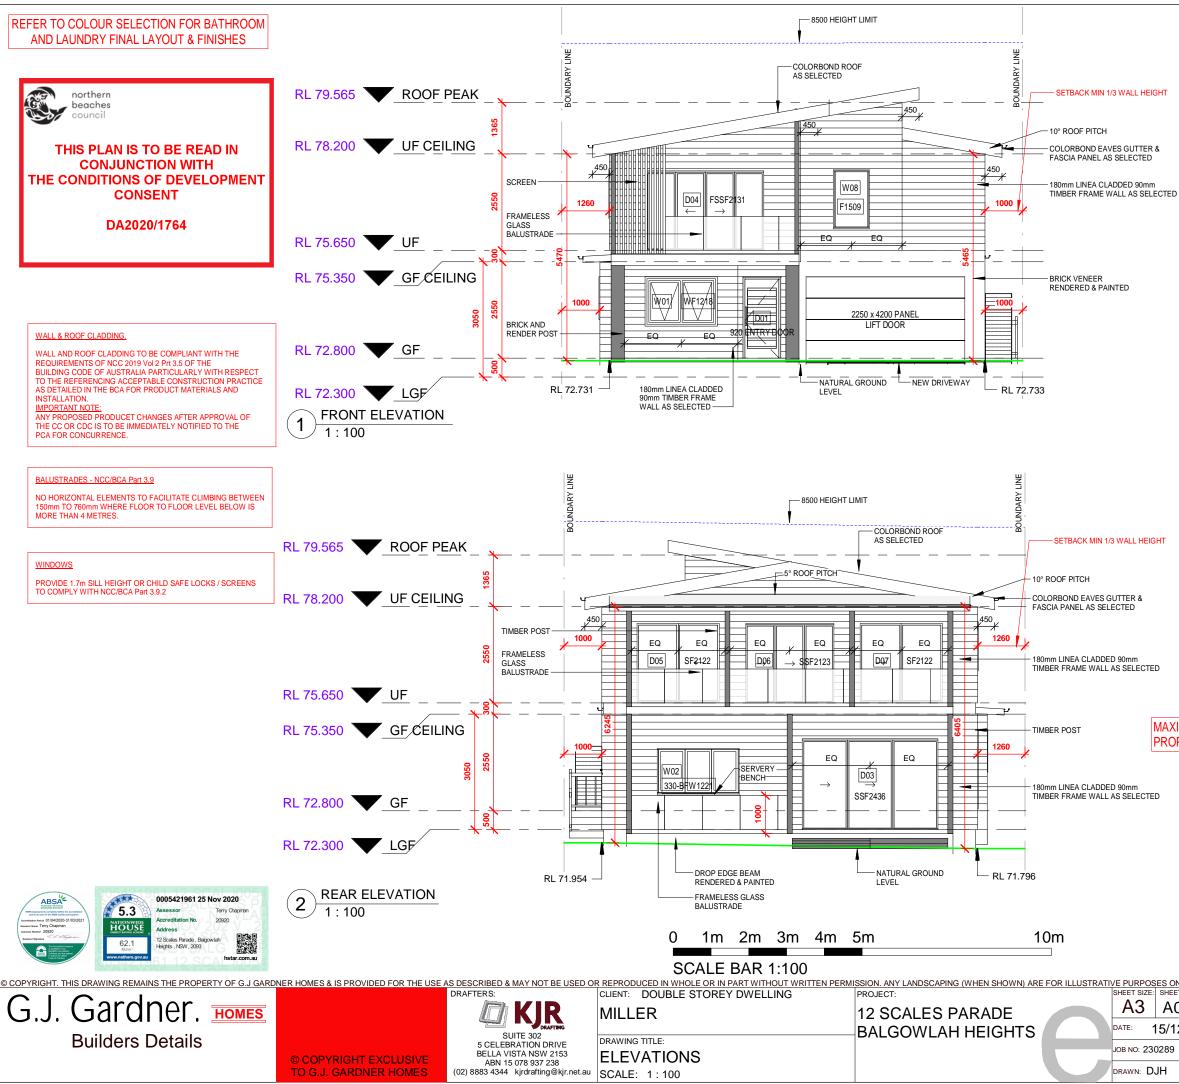
## DRAWING REVISION SCHEDULE AMENDMENTS DATE 6 No. DP 584A FIRST ISSUE 31/08/2020 B CHANGES AS PER EMAIL 10/09/2020



LANDSCAPE SCHEDULE		
AREA NAME	AREA	%
BUILDING FOOTPRINT	162 m²	28%
OPEN LANDSCAPE	331 m²	58%
OTHER AREAS	79 m²	14%
TOTAL AREAS:	572 m²	100%



	LANDSCAPE SCHEDULE				
	AREA NAME		AREA	%	
_					
E	BUILDING	FOOTPRINT	162 m²	28%	
C	OPEN LAN	NDSCAPE	331 m²	58%	
C	OTHER AF	REAS	79 m²	14%	
٦	FOTAL AR	REAS:	572 m²	100%	
F	DIMENSIONS ARE TO FRAME SIZE ONLY				
No:	REVISION:	ORM PART OF ANY CONTRAC	I/WE HAVE CHECKED THE PLANS	AND AGREE THEY ACCURATELY	
6	F	N	DEPICT THE HOUSE FOR CON REQUESTED AFTER SIGNING WI ADDITION TO THE COST OF TH	ISTRUCTION. ANY VARIATIONS LL INCUR A PROCESSING FEE IN HE VARIATION ITEM/S AND ANY TO BE PREPARED.	
/20	020		FUR THER PLANS	IU DE FREPARED.	
	STAGE: DA		OWNER SIGNED:		
	GJGN123		BUILDER SIGNED:		



## DOOR SCHEDULE

Code	Width	Height		
D01	920	2100		
D02	870	2100		
D03	3588	2400		
D04	3104	2100		
D05	2170	2100		
D06	2328	2100		
D07	4200	2250		
D07	2170	2100		
Grand total: 8				

Grand total: 8

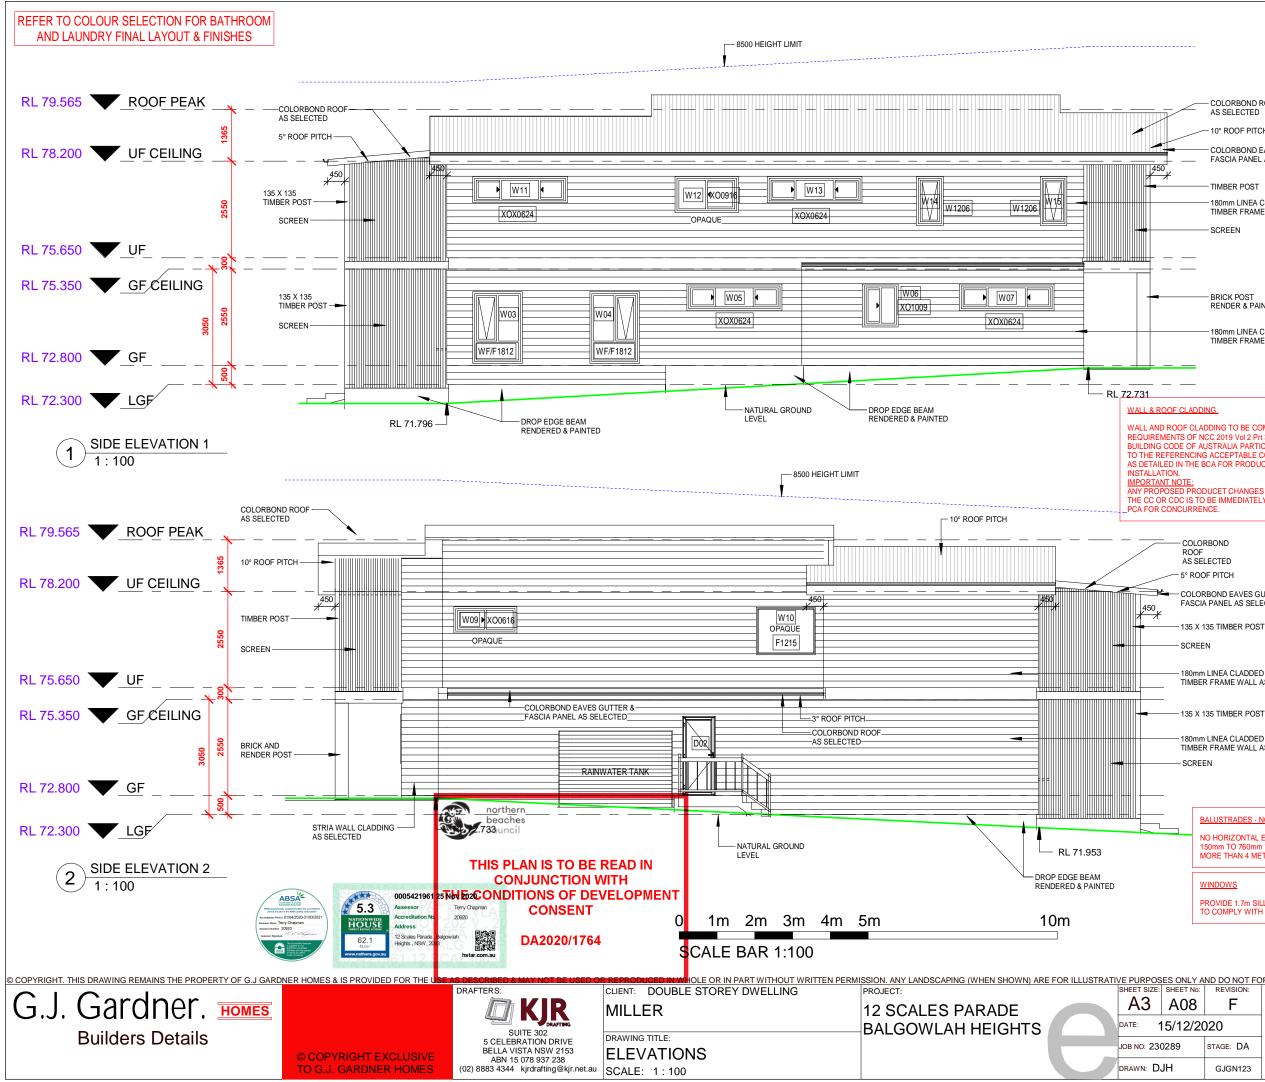
WINDOW SCHEDULE				
Code	Width	Height		
W01	1810	1200		
W02	2170	1200		
W03	1210	1800		
W04	1210	1800		
W05	2410	600		
W06	850	1030		
W07	2410	600		
W08	900	1500		
W09	1570	600		
W10	1500	1200		
W11	2410	600		
W12	1570	860		
W13	2410	600		
W14	610	1200		
W15	610	1200		
W15 Grand total:		1200		

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## MAXIMUM FLOOR SPACE RATIO FOR MANLY LOCAL ENVIRONMENT : (0.45 PROPOSED FLOOR SPACE RATIO = .29

LANDSCAPE SCHEDULE						
AREA NAME	AREA	%				
BUILDING FOOTPRINT	162 m²	28%				
OPEN LANDSCAPE	331 m²	58%				
OTHER AREAS	79 m²	14%				
TOTAL AREAS:	572 m <sup>2</sup>	100%				

ONLY A	ND DO NOT FC	ORM PART OF ANY CONTRACT		
EET No:	REVISION:		I/WE HAVE CHECKED THE PLANS AND AGREE THE	Y ACCURATELY
07	F		DEPICT THE HOUSE FOR CONSTRUCTION. ANY REQUESTED AFTER SIGNING WILL INCUR A PROC ADDITION TO THE COST OF THE VARIATION ITE	CESSING FEE IN M/S AND ANY
12/2020			FURTHER PLANS TO BE PREPARED	).
9	STAGE: DA		OWNER SIGNED:	DATE:
	GJGN123			DATE:



		DOOR SCHEDULE				
		Code	Width	Height		
	[	D01	920	2100		
COLORBOND ROOF		D02	870	2100		
		D03	3588	2400		
10° ROOF PITCH		D04	3104	2100		
COLORBOND EAVES GUTTER &	-	D05	2170	2100		
FASCIA PANEL AS SELECTED	-	D06	2328	2100		
TIMBER POST	-	D07	4200	2250		
		D07	2170	2100		
	TED	Grand total:	8			
SCREEN		WINDOW SCHEDUL				
		Code	Width	Height		
	[	W01	1810	1200		
		W02	2170	1200		
180mm LINEA CLADDED 90mm		W03	1210	1800		
TIMBER FRAME WALL AS SELEC	TED	W04	1210	1800		
		W05	2410	600		
		W06	850	1030		
		W07	2410	600		
CLADDING.		W08	900	1500		
		W09	1570	600		
OF CLADDING TO BE COMPLIANT WITH TH TS OF NCC 2019 Vol 2 Prt 3.5 OF THE	1E	W10	1500	1200		
E OF AUSTRALIA PARTICULARLY WITH RE		W11	2410	600		
RENCING ACCEPTABLE CONSTRUCTION P N THE BCA FOR PRODUCT MATERIALS AN		W12	1570	860		
l. OTE:		W13	2410	600		
D PRODUCET CHANGES AFTER APPROVA		W14	610	1200		
IC IS TO BE IMMEDIATELY NOTIFIED TO TH CURRENCE.	ΗE	W15	610	1200		
		Grand total:	15			
- COLORBOND	DF	RAWING RE	ISION SCHE	DULE		

- COLORBOND ROOF	DRAWING REVISION SCHEDULE				
AS SELECTED	No.	AMENDMENTS	DATE		
-5° ROOF PITCH	Α	FIRST ISSUE	31/08/2020		
- COLORBOND EAVES GUTTER & FASCIA PANEL AS SELECTED	В	CHANGES AS PER EMAIL 03/09/2020	10/09/2020		
- 135 X 135 TIMBER POST	С	CHANGES AS PER EMAIL 17/09/2020	24/09/2020		
SCREEN	D	CHANGES AS PER EMAIL 08/10/2020	16/10/2020		
- 180mm LINEA CLADDED 90mm		CHANGES AS PER EMAIL 22/10/2020	03/11/2020		
TIMBER FRAME WALL AS SELECTED	F	UPDATE TO FULL SET DA ISSUE	15/12/2020		

135 X 135 TIMBER POST

- 180mm LINEA CLADDED 90mm TIMBER FRAME WALL AS SELECTED SCREEN

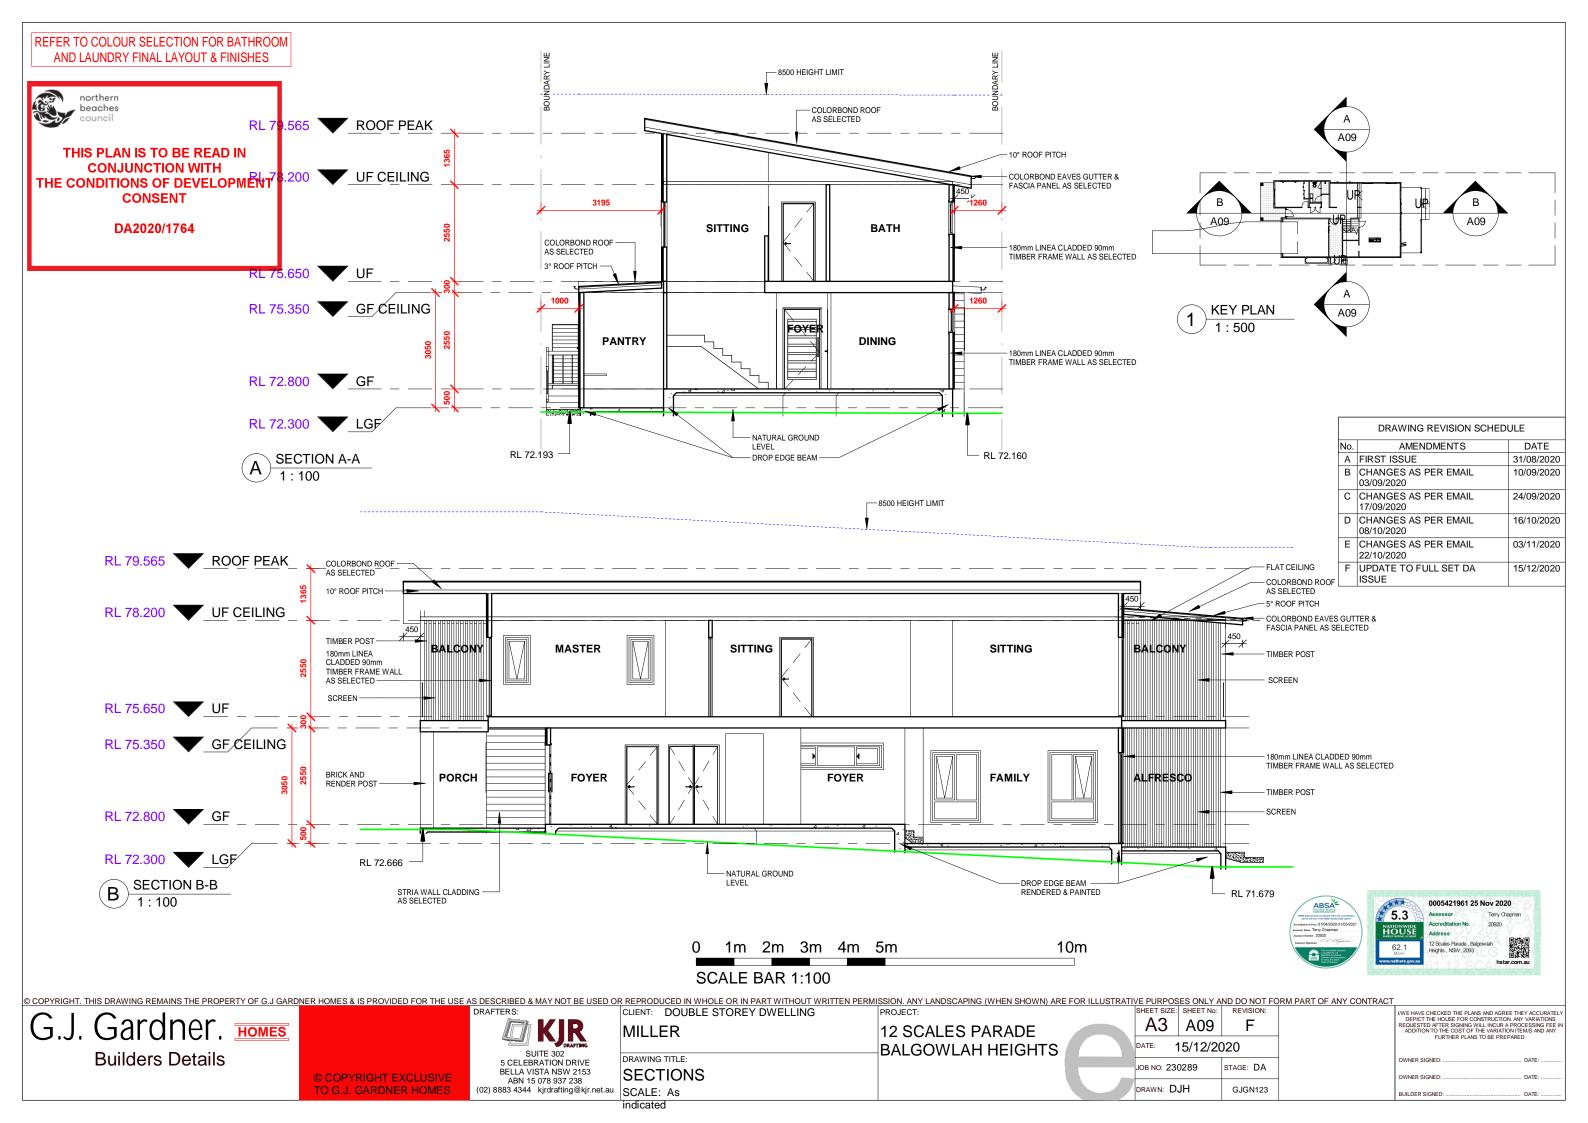
BALUSTRADES - NCC/BCA Part 3.9

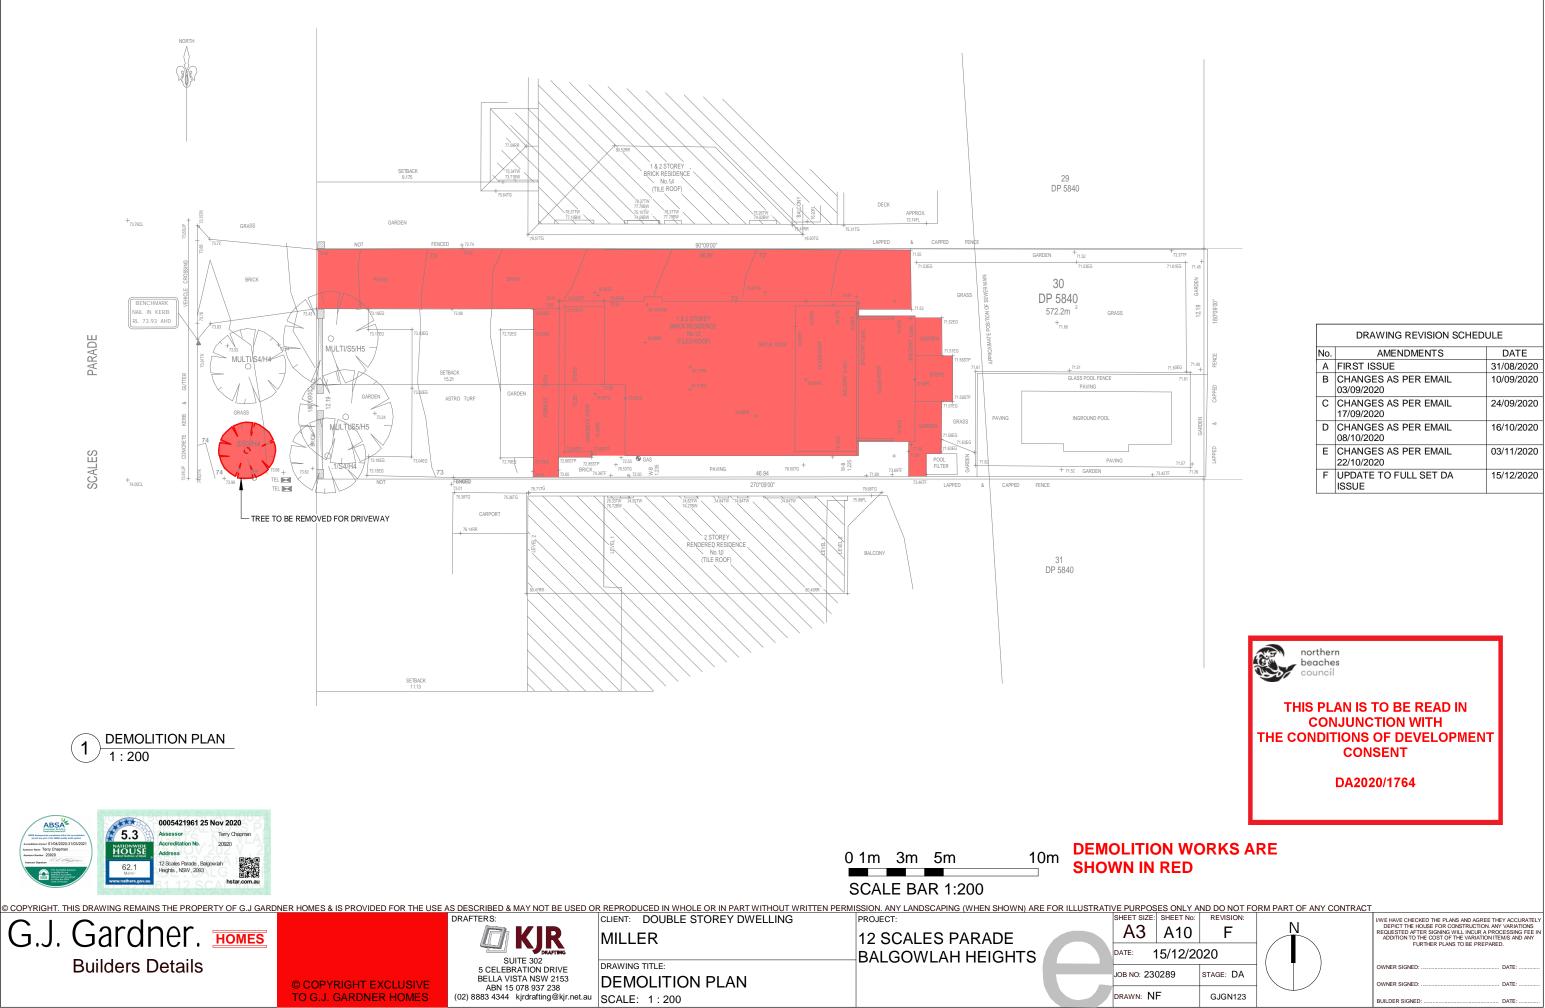
NO HORIZONTAL ELEMENTS TO FACILITATE CLIMBING BETWEEN 150mm TO 760mm WHERE FLOOR TO FLOOR LEVEL BELOW IS MORE THAN 4 METRES.

WINDOWS

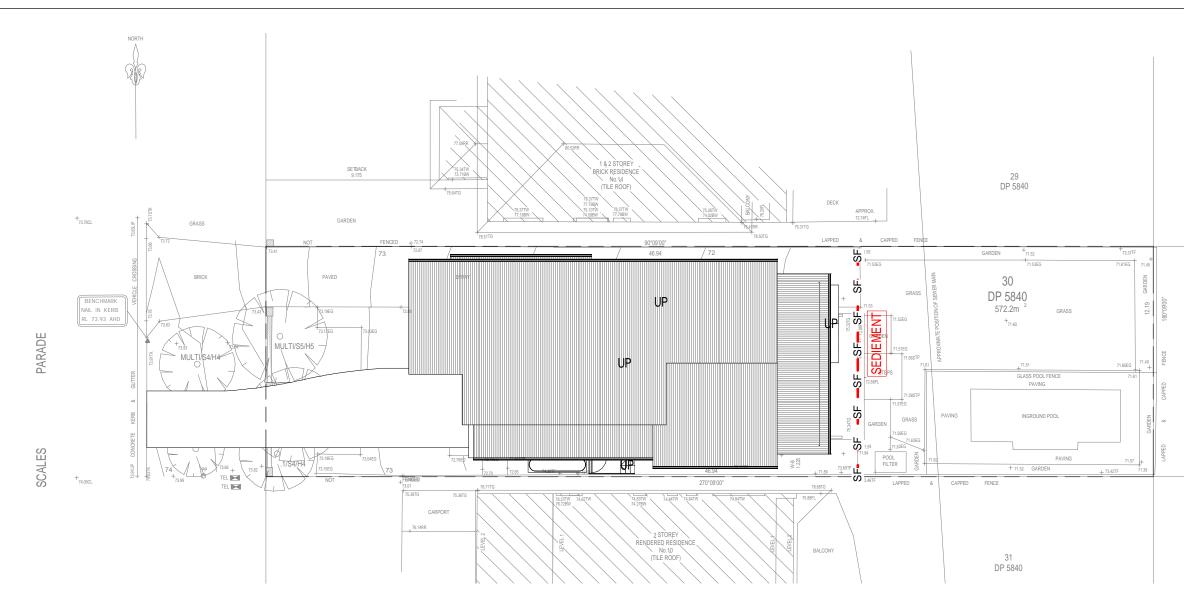
PROVIDE 1.7m SILL HEIGHT OR CHILD SAFE LOCKS / SCREENS TO COMPLY WITH NCC/BCA Part 3.9.2

ONLY A	ND DO NOT FC	DRM PART OF ANY CONTRACT		
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12/2020			FURTHER PLANS TO BE PREPARED.	
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	GJGN123		OWNER SIGNED:         DATE:           BUILDER SIGNED:         DATE:	
		*		_

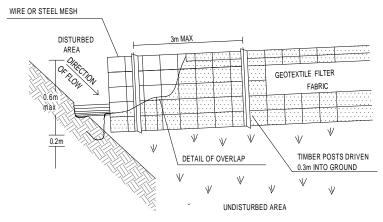




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### **EROISION & SEDMIENT** 1 1:200



## SEDIMENT FENCE DETAILS

## **SEDIMENT CONTROL NOTES:**

- ALL EROSION AND SEDIMENTATION CONTROL MEASURES, INCLUDING REVEGETATION AND STORAGE OF SOIL & TOP SOIL SHALL BE IMPLEMENTED TO THE STANDARDS OF THE SOIL CONSERVATION OF NSW. - ALL THE DRAINAGE WORKS SHALL BE CONSTRUCTED AND STABILISED AS EARLY AS POSSIBLE DURING

DEVELOPMENT.

- SEDIMENT TRAPS SHALL BE CONSTRUCTED AROUND ALL INLET PITS, CONSISTING OF 300mm WIDE x 300mm DEEP TRENCH.

- ALL SEDIMENT BASINS AND TRAPS SHALL BE CLEANED WHEN THE STRUCTURES ARE A 60% FULL OF SOIL MATERIALS, INCLUDING THE MAINTENANCE PERIOD.

- TOPSOIL FROM ALL AREAS THAT WILL BE DISTURBED TO STRIPPED AND STOCKPILED.

- SOIL AND TOPSOIL STOCKPILES SHALL BE LOCATED AWAY FROM DRAINAGE LINES AREA AREAS WHERE WATER MAY CONCENTRATE.

- STOCKPILE TOPSOIL SEPARATELY FROM SUBSOIL

- STRIPPING OF GRASS AND VEGETATION ETC. FROM SITE SHALL BE KEPT TO A MINIMUM.

- FILTER SHALL BE CONSTRUCTED BY STRECTCHING A FILTER FABRIC (PROPEX OR APPROVED EQUIVALENT

BETWEEN POST AT 3m CENTRES. FABRIC SHALL BE BURIED 150mm ALONG ITS LOWER EDGE.

- ALL DISTURBED AREAS SHALL BE REVEGETATED AS SOON AS THE RELEVANT WORKS ARE COMPLETED.

ALL SEDIMENT CONTROL STRUCTURES TO BE INSPECTED AFTER EACH RAINFALL EVENT FOR STRUCTURAL DAMAGE AND ALL TRAPPED SEDIMENT TO BE REMOVED TO A NOMINATED SOIL STOCKPILE SITE.

## **BOUNDARY NOTES:**

- BOUNDARY INFORMATION SUPPLIED BY OWNER - CONFIRM ALL BOUNDARY INFORMATION PRIOR TO COMMENCEMENT OF WORK. **SETOUT NOTES:** 

- BOUNDARY DIMENSIONS AND LOCATION OF DWELLING TO BE CONFIRMED AND SETOUT BY SURVEYOR PRIOR TO COMMENCEMENT OF WORK. - BUILDER TO BE PRESENT TO CONFIRM PREFERENCE TO LOCATION.

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SCAL	_E	BA	١R	1

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northerr beaches

## THIS PLAN IS TO BE READ IN **CONJUNCTION WITH** THE CONDITIONS OF DEVELOPMENT CONSENT

## DA2020/1764

DP 5840

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2/20	)20		FURTHER PLANS TO BE PREPARED.
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			OWNER SIGNED: DATE:
	GJGN123		BUILDER SIGNED: DATE:

## WASTE MANAGEMENT PLAN FOR PROPOSED 2 STOREY DWELLING AT: **12 SCALES PARADE, BALGOWLAH HEIGHTS**

DEMOL	ITION PH	ASE			CONST	<b>RUCTION F</b>	PHASE		
MATERIAI	LS ON-SITE	DESTINATIO	N		MATERIA	LS ON-SITE		DESTINATION	
		Reuse & Recycl	ing	Disposal				Reuse & Recycling	Disposal
Type of materials	Estimated volume (m3)	On-Site Specify proposed reuse or on-site recycling method	Offsite Specify contractor and recycling outlet	Specify contractor or landfill site	Type of materials	volume	On-Site Specify proposed reuse or on-site recycling method	Offsite Specify contractor and recycling outlet	Specify contractor or landfill sit
Green waste	2	Chip and compost for landscaping and new gardens	-	Nil to landfill	Excavation Material		Re-use for backfill under slab Remove top soil and stockpil for use in landscaping		
Bricks	Nil			Nil to landfill	Green waste	Nil			
					Bricks	Nil			
Concrete	20		Waste Management centre for recycling	Nil to landfill	Concrete	2		Excess concrete returned to supplier	Nil to landfill
Timber	10	Used for formwork and studwork, site shed	Long lengths of good quality timber	Nil to landfill	Timber	2		Excess timber returned to supplier	Nil to landfill
		or temporary fence	to Timber Recycling Company. Lengths less than 1 meter to Waste Management centre for recycling		Plasterboard	0.5		Excess plasterboard returned to supplier	Nil to landfill
Plasterboard	10		Waste Management centre	Taken to landfill	Roof colorbond	0.5		Excess colorbond roof returned to supplier	Nil to landfill
Roof tiles	8		Good tiles to Waste Management centre for recycling; sell to second hand building supplies	Nil to landfill	Metals	0.1		Waste Management centre for recycling	Nil to landfill
Metals	2		Waste Management centre for	Nil to landfill	USE O	F PREMISE	6		
			recycling		Type of Was	te to be Generate	per week (m3)	Dn-Site Destination Specify proposed reuse or	
Asbestos	5		Cart to licensed asbestos tip	Taken to landfil				on-site recycling method	
					Food, genera	al domestic waste	0.4	Bins located on site Disposal via co rubbish remova	



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TO G.J. GARDNER HOMES

**KJR** SUITE 302 5 CELEBRATION DRIVE BELLA VISTA NSW 2153 ABN 15 078 937 238 (02) 8883 4344 kjrdrafting@kjr.net.au

MILLER

SCALE: 1:1

DRAWING TITLE: WASTE MANAGEMENT

Paper, Cardboard

Glass, Bottles

12 SCALES PARADE BALGOWLAH HEIGHTS

0.1

0.1

Bins located on site

Bins located on site



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northern beaches council

## DA2020/1764

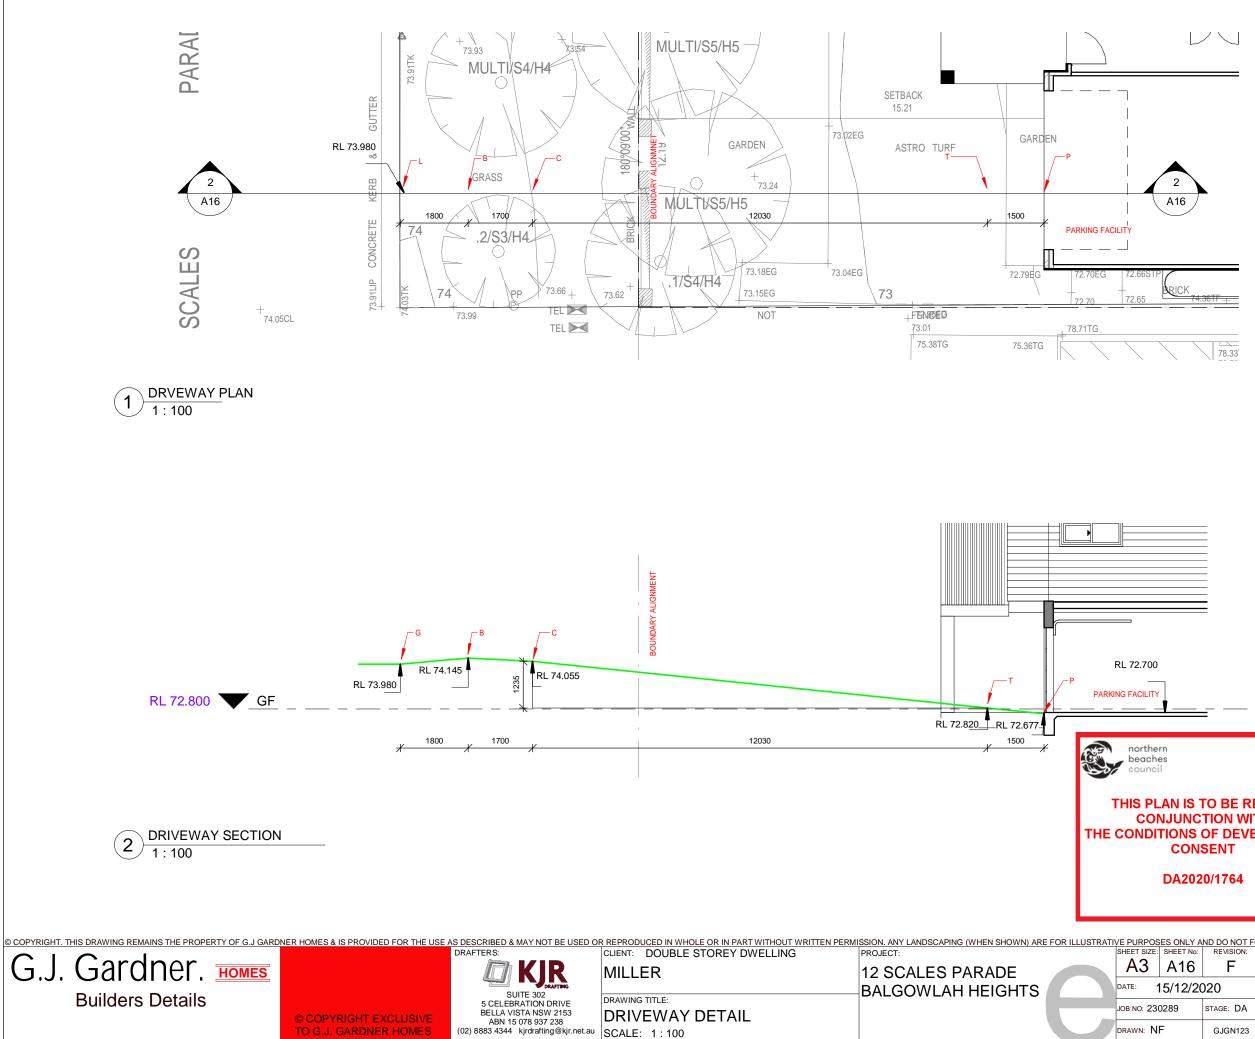
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Disposal via council recycling collection

Disposal via council recycling collection

NLY A	ND DO NOT	FORM PART	OF ANY	CONTRACT

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12/2020		
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)	STAGE: DA	
		OWNER SIGNED: DATE:
	GJGN123	BUILDER SIGNED: DATE:



IS TO BE RE INCTION WIT NS OF DEVEI ONSENT 2020/1764	Н	ALFRESCO BALCONY FIRST FLOOR GARAGE GROUND PORCH TOTAL AREAS:	23 m <sup>2</sup> 32 m <sup>2</sup> 127 m <sup>2</sup> 30 m <sup>2</sup> 124 m <sup>2</sup> 11 m <sup>2</sup> 348 m <sup>2</sup>	7%           9%           37%           9%           36%           3%           100%
INLY AND DO NOT FORM PART OF AN ET No: REVISION: 16 F 2/2020		IWE HAVE CHECKED THE DEPICT THE HOUSE FO REQUESTED AFTER SIGN ADDITION TO THE COS'	IR CONSTRUCTION. ING WILL INCUR A F I OF THE VARIATION LANS TO BE PREP/	. ANY VARIATIONS PROCESSING FEE IN N ITEM/S AND ANY ARED.
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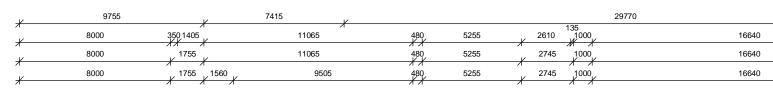
SPACES

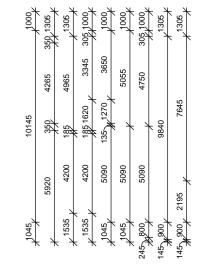
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AREA

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G.J. Gardner.

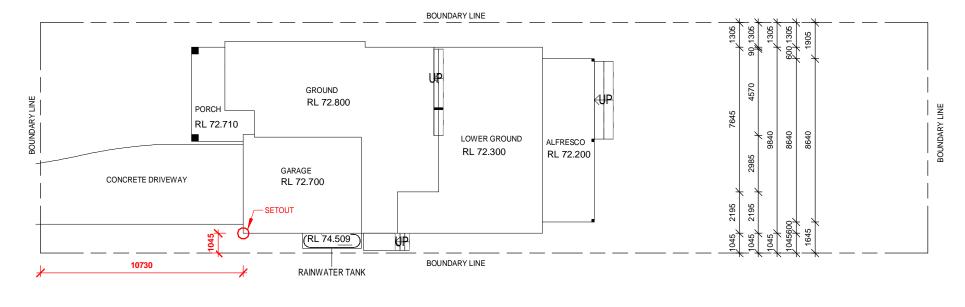
**Builders Details** 

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HOMES

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TO G.J. GARDNER HOMES



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CONCRETE SLAB PLAN

**KJR** 

SUITE 302

5 CELEBRATION DRIVE BELLA VISTA NSW 2153

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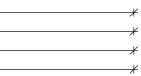
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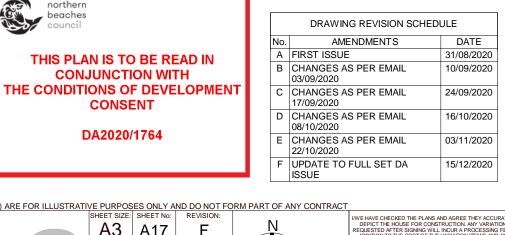
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CLIENT: DOUBLE STOREY DWELLING
PROJECT:
SHEET No: REVISION:
N A3 A17 12 SCALES PARADE DATE: BALGOWLAH HEIGHTS JOB NO: 230289 DRAWN: NF

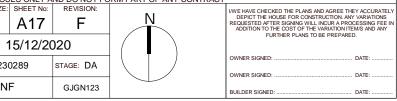
northern beaches council

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## PROPOSED RESIDENTIAL DEVELOPMENT 12 SCALES PARADE, BALGOLWAH HEIGHTS STORMWATER MANAGEMENT PLANS

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## **GENERAL NOTES:**

1. THESE THE PLANS SHALL BE READ IN CONJUCTION WITH OTHER RELEVANT CONSULTANTS'S PLANS, SPECIFICATIONS, CONDITIONS OF DEVELOPMENT CONCEST AND CONSTRUCTION CERTIFICATE REQUIREMENTS. WHERE DISCREPANCIES ARE FOUND NASTASI & ASSOCIATES MUST BE CONTACTED IMMEDIATELY FOR VERIFICATION.

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- 2. WHERE THESE PLANS ARE NOTED FOR DEVELOPMENT APPLICATION PURPOSES ONLY, THEY SHALL NOT BE USED FOR OBTAINING A CONSTRUCTION CERTIFICATE NOR USED FOR CONSTRUCTION PURPOSES.
- SUBSOIL DRAINAGE SHALL BE DESIGNED AND DETAILED BY THE STRUCTURAL ENGINEER. SUBSOIL DRAINAGE SHALL NOT BE CONNECTED INTO THE STORMWATER SYSTEM IDENTIFIED ON THESE PLAN UNLESS APPROVED BY NASTASI & ASSOCIATES ENGINEERS.

### STORMWATER CONSTRUCTION NOTES:

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- 1. ALL WORK SHALL BE CARRIED OUT IN ACCORDANCE WITH AS/NZS 3500 (CURRENT EDITION) AND THE REQUIREMENTS OF THE LOCAL COUNCIL'S POLICIES AND CODES
- 2. THE MINIMUM SIZE OF THE STORMWATER DRAINS SHALL NOT BE LESS THAN DN 90 FOR CLASS 1 BUILDINGS AND DN100 FOR OTHER CLASSES OF BUILDING OR AS REQUIRED BY REGULATORY AUTHORITY
- 3. THE MINIMUM GRADIENT OF STORMWATER DRAINS SHALL BE 1%, UNLESS NOTED OTHERWISE
- 4. COUNCIL'S TREE PRESERVATION ORDER IS TO BE STRICTLY ADHERED TO . NO TREES SHALL BE REMOVED UNTIL PERMIT IS OBTAINED
- 5. PUBLIC UTILITY SERVICES ARE TO BE ADJUSTED AS NECESSARY AT THE CLIENT'S EXPENSE
- 6. ALL PITS TO BE BENCHED AND STREAMLINED. PROVIDE STEP IRONS FOR ALL PITS OVER 1.2m DEEP
- 7. ALL PITS IN AN EASEMENT OR TRAFFICABLE AREA ARE TO BE PRE-CAST OR CASTIN-SITU OR APPROVED EQUIVALENT
- 8. MAKE SMOOTH JUNCTION WITH ALL EXISTING WORK
- 9. VEHICULAR ACCESS AND ALL SERVICES TO BE MAINTAINED AT ALL TIMES TO ADJOINING PROPERTIES AFFECTED BY CONSTRUCTION
- SERVICES SHOWN ON THESE PLANS HAVE BEEN LOCATED FROM INFORMATION SUPPLIED BY THE RELEVANT AUTHORITIES AND FIELD INVESTIGATIONS AND ARE NOT GUARANTEED COMPLETE NOR CORRECT. IT IS THE CLIENT & CONTRACTOR'S RESPONSIBILITY TO LOCATE ALL PRIOR TO CONSTRUCTION
- 11. ANY VARIATION TO THE WORKS AS SHOWN ON THE APPROVED DRAWINGS ARE TO BE CONFIRMED BY NASTASI & ASSOCIATES PRIOR TO THEIR COMMENCEMENT

## RAINWATER RE-USE NOTES:

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- 1. RAINWATER SUPPLY PLUMBING TO BE CONNECTED TO OUTLETS WHERE REQUIRED BY BASIX CERTIFICATE (BY OTHERS)
- TOWN WATER CONNECTION TO RAINWATER TANK TO THE SATISFACTION OF THE REGULATORY AUTHORITY. THIS WAY REQUIRE PROVISION OF:
   2.1. PERMANENT AIR GAP
   2.2. BACKFLOW PREVENTION DEVICE
- 3. NO DIRECT CONNECTION BETWEEN TOWN WATER SUPPLY AND THE RAINWATER SUPPLY
- 4. AN APPROVED STOP VALVE AND/OR PRESSURE LIMITING VALVE AT THE RAINWATER TANK
- PROVIDE AT LEAST ONE EXTERNAL HOSE COCK ON THE TOWN WATER SUPPLY FOR FIRE FIGHTING
   PROVIDE APPROPRIATE FLOAT VALVES AND/OR SOLENOID VALVES TO CONTROL TOWN WATER SUPPLY
- INLET TO TANK IN ORDER TO ACHIEVE THE TOP-UP INDICATED ON THE TYPICAL DETAIL
- 7. ALL PLUMBING WORKS ARE TO BE CARRIED OUT BY LICENSED PLUMBERS IN ACCORDANCE WITH AS/NZS3500.1 NATIONAL PLUMBING AND DRAINAGE CODE
- 8. PRESSURE PUMP ELECTRICAL CONNECTION TO BE CARRIED OUT BY A LICENSED ELECTRICIAN
- 9. ONLY ROOF RUN-OFF IS TO BE DIRECTED TO THE RAINWATER TANK. SURFACE WATER INLETS ARE NOT BE CONNECTED
- 10. PIPE MATERIALS FOR RAINWATER SUPPLY PLUMBING ARE TO BE APPROVED MATERIALS TO AS/NZE3500 PART 1 SECTION 2 AND TO BE CLEARLY AND PERMANENTLY IDENTIFIED AS 'RAINWATER'. THIS MAY BE ACHIEVED FOR BELOW GROUND PIPES USING IDENTIFICATION TAPE (MADE IN ACCORDANCE WITH AS2648) OR FOR ABOVE FROUND PIPES BY USING ADHESIVE PIPE MARKERS (MAKE IN ACCORDANCE WITH AS1345)
- 11. EVERY RAINWATER SUPPLY OUTLET POINT AND THE RAINWATER TANK ARE TO BE LABELED 'RAINWATER' ON A METALLIC SIGN IN ACCORDANCE WITH AS1316\9
- 12. ALL INLETS AND OUTLETS TO THE RAINWATER TANK ARE TO HAVE SUITABLE MEASURES PROVIDED TO PREVENT MOSQUITO AND VERMIN ENTRY.

### EROSION AND SEDIMENT NOTES:

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- 1. THESE THE PLANS SHALL BE READ IN CONJUCTION WITH EROSION AND SEDIMENT CONTROL DETAILS AS ATTACHED
- 2. THE CONTRACTOR SHALL IMPLEMENT ALL SOIL EROSION AND SEDIMENT CONTROL MEASURE AS NECESSARY AND TO THE SATISFACTION OF THE RELEVANT LOCAL AUTHORITY PRIOR TO THE COMMENCEMENT ANY DURING CONSTRUCTION. NO DISTURBANCE TO THE SITE SHALL BE PERMITTED OTHER THAN IN THE IMMEDIATE AREA OF THE WORKS AND NO MATERIAL SHALL BE REMOVED FROM THE SITE WITHOUT THE RELEVANT LOCAL AUTHORITY APPROVAL. ALL EROSION AND SEDIMENT CONTROL DEVICES TO BE INSTALLED AND MAINTAINED IN ACCORDANCE WITH STANDARDS OUTLINED IN NSW DEPARTMENT OF HOUSING'S "MANAGING URBAN STORWWATER - SOILS AND CONSTRUCTIONS"
- 3. TOPSOIL SHALL BE STRIPPED AND STOCKPILED OUTSIDE HAZARD AREA SUCH AS DRAINAGE LINES. THIS TOPSOIL SHALL BE RESPREAD LATER ON AREAS TO BE REVEGETATED AND STABILIZED ONLY. TOPSOIL SHALL NOT BE RESPREAD ON ANY OTHER AREA UNLESS SPECIFICALLY INSTRUCTED BY THE SUPERINTENDENT. IF THEY ARE TO REMAIN LONGER THAN ONE MONTH STOCK PILES SHALL BE PROTECTED FROM EROSION BY COVERING THEM WITH A MULCH AND HYDROSEDING AND, IF NECESSARY, BY LOCATING BANKS OR DRAINS DOWNSTREAM OF A STOCKPILE TO RETARD SILT LADEN RUNOFF
- 4. THE CONTRACTOR SHALL REGULARLY MAINTAIN ALL EROSION AND SEDIMENT CONTROL DEVICES AND REMOVE ACLUMULATED SILT FROM SUCH DEVICES SUCH THAT MORE THAN 60% OF THEIR CAPACITY IS LOST. ALL THE SILT IS TO BE PLACED OUTSIDE THE LIMIT OF WORKS. THE PERIOD FOR MAINTAINING THESE DEVICES SHALL BE AT LEAST UNTIL ALL DRISTURBED AREAS ARE REVEGETATED AND FURTHER AS MAY BE DIRECTED BY SUPERINTENDENT. OR COUNCIL
- 5. VEHICULAR TRAFFIC SHALL BE CONTROLLED DURING CONSTRUCTION CONFINING ACCESS WHERE POSSIBLE TO NOMINATED STABILISED ACCESS POINTS
- 6. THE CONTRACTOR SHALL IMPLEMENT DUST CONTROL BY REGULAR WETTING DOWN DISTURBED
- 7. ALL DRAINAGE PIPE INLETS TO BE CAPPED UNTIL
  - DOWNPIPES CONNECTED
     PITS CONSTRUCTED AND PROTECTED WITH SILT BARRIER

## MINIMUM PIPE COVER NOTES:

LOCATION	MINIMUM COVER		
NO SUBJECT TO VEHICLE LOADING	100mm SINGLE RESIDENTIAL		
SUBJECT TO VEHICLE LOADING	450mm WHERE NOT IN A ROAD		
UNDER A SEALED ROAD	600mm		
UNSEALED ROAD	750mm		
PAVED DRIVEWAY	100mm PLUS DEPTH OF CONCRETE		

SEE AS2032 INSTALLATION OF UPVC PIPES FOR FURTHER INFORMATION.

CONCRETE PIPE COVER SHALL BE IN ACCORDANCE WITH AS3725-1989 LOADS ON BURIED CONCRETE PIPES, HOWEVER A MINIMUM COVER OF 450mm WILL APPLY.

WHERE INSUFFICIENT COVER IS PROVIDED, THE PIPE SHALL BE COVERED AT LEAST 50mm THICK OVERLAY AND SHALL BE PAVED WITH AT LEAST:

- 150 mm REINFORCED CONCRETE WHERE SUBJECT TO HEAVY VEHICLE TRAFFIC
- 75mm THICKNESS OF BRICK OR 100mm OF CONCRETE PAVING WHERE SUBJECT TO LIGHT VEHICLE TRAFFIC, OR 50mm THICK BRICK OR CONCRETE PAVING WHERE NOT SUBJECT TO VEHICLE TRAFFIC

## SURFACE STORMWATER PIT NOTES:

<u>PIT DEPTH (mm)</u>	MINIMUM PIT SIZE (mm)
UP TO 600 mm	450 x 450
FROM 600mm TO LESS THAN 900mm	600 x 600
FROM 900mm	900 x 900

ALL BASEMENT PIT TO BE FITTED WITH HEAVY DUTY CLASS C GRATE & FRAME

	EGEND
	DENOTES BELOW GROUND ON-SITE DETENTION TANK
	DENOTES ON-SITE DETENTION BASIN
op	DENOTES Ø100 DOWNPIPE (U.N.O)
olb	DENOTES INSPECTION OPENING WITH SCREW Down Lid at Finished Surface Level
€ <sup>PB</sup>	DENOTED PLANTER BOX DRAINS
€ <sup>FD</sup>	DENOTED FLOOR DRAINS
Œ	DENOTED CLEANING EYE
	STORMWATER PIT - SOLID COVER
	STORHWATER PIT - GRATED INLET
0	DENOTES GRATED DRAIN
<u>2000000000000000000000000000000000000</u>	DENOTES ABSORPTION TRENCH
И	DENOTES NON RETURN VALVE
>>>>>	DENOTES OVERLAND FLOW PATH
L	INVERT LEVEL
тк	TOP OF KERB
RL	REDUCED LEVEL/SURFACE LEVEL
RL 17.09 +	PROPOSED FINISH SURFACE LEVEL
<u>100</u> <b>≫</b>	DENOTED Ø100mm PVC (SEWER GRADE) @1% MIN. FALL U.N.O FOR RAINWATER RE-USE
<u>100</u> <b>》</b>	DENOTED Ø100mm PVC (SEWER GRADE) @1% MIN. FALL U.N.O
<u>15</u> 0 <b>≫</b>	DENOTED Ø150mm PVC (SEWER GRADE) @1% Min. Fall U.N.O
<u></u>	DENOTED Ø225mm PVC (SEWER GRADE) @0.5% Min. Fall U.N.O
G	DENOTE AGG PIPE
	DENOTE RAINWATER TANK

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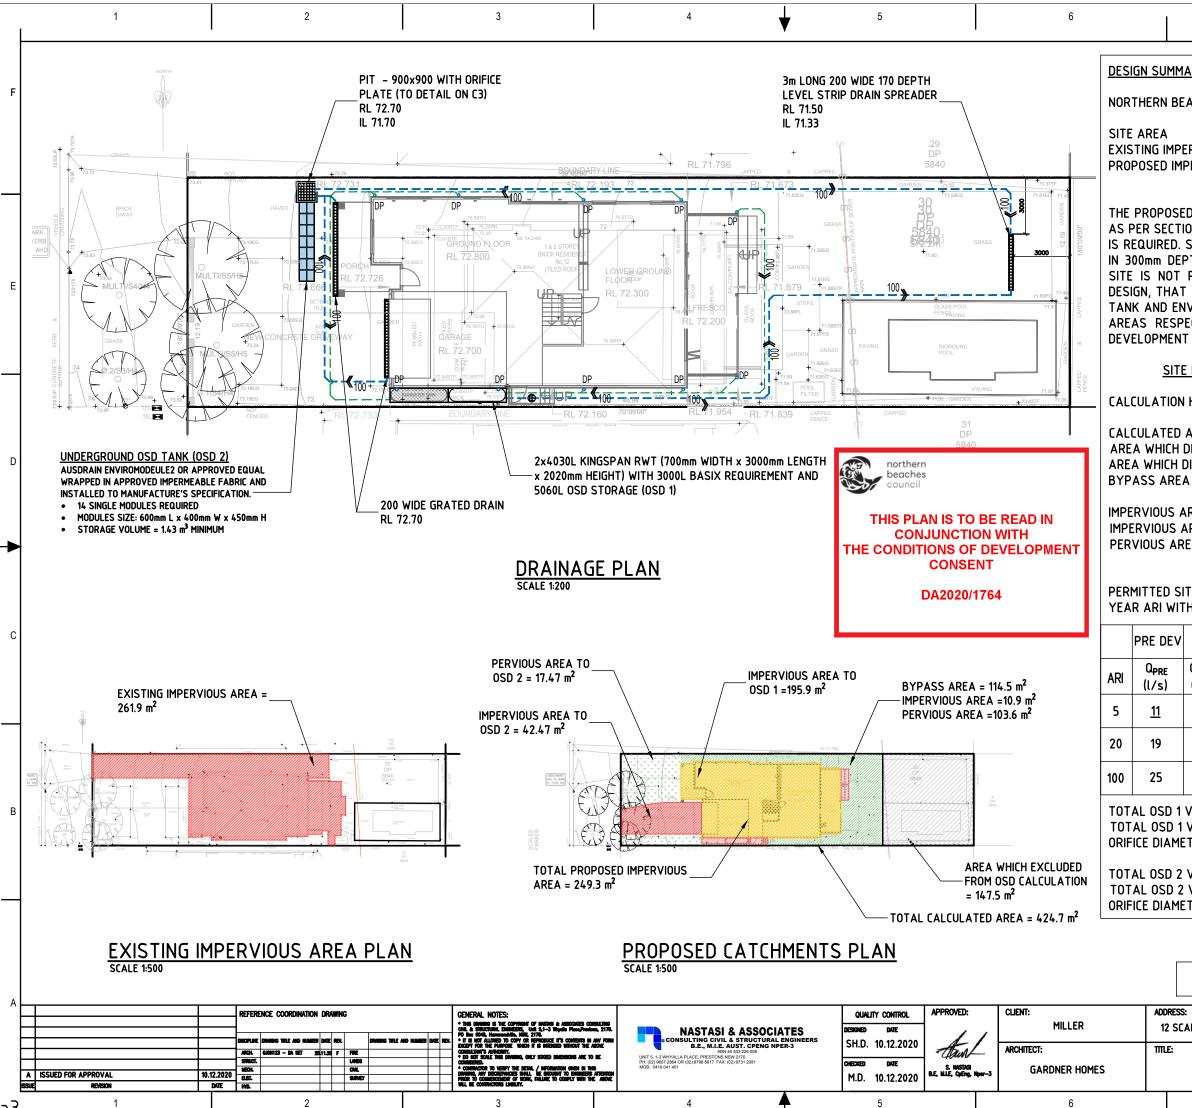




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	SCHEDULE OF DRAWING	
DESCRIPTION	SHEET NUMBER	
VER SHEET & NOTES	ព	
AINAGE PLANS	0	Е
D 1 PLAN & DETAILS	3	
D 2 PLAN & DETAILS	(4	
ORMWATER DETAILS	G	
SCALES PARADE	A council THIS PLAN IS TO BE READ IN CONJUNCTION WITH THE CONDITIONS OF DEVELOPM CONSENT DA2020/1764 LOCATION MAP	D C
		В



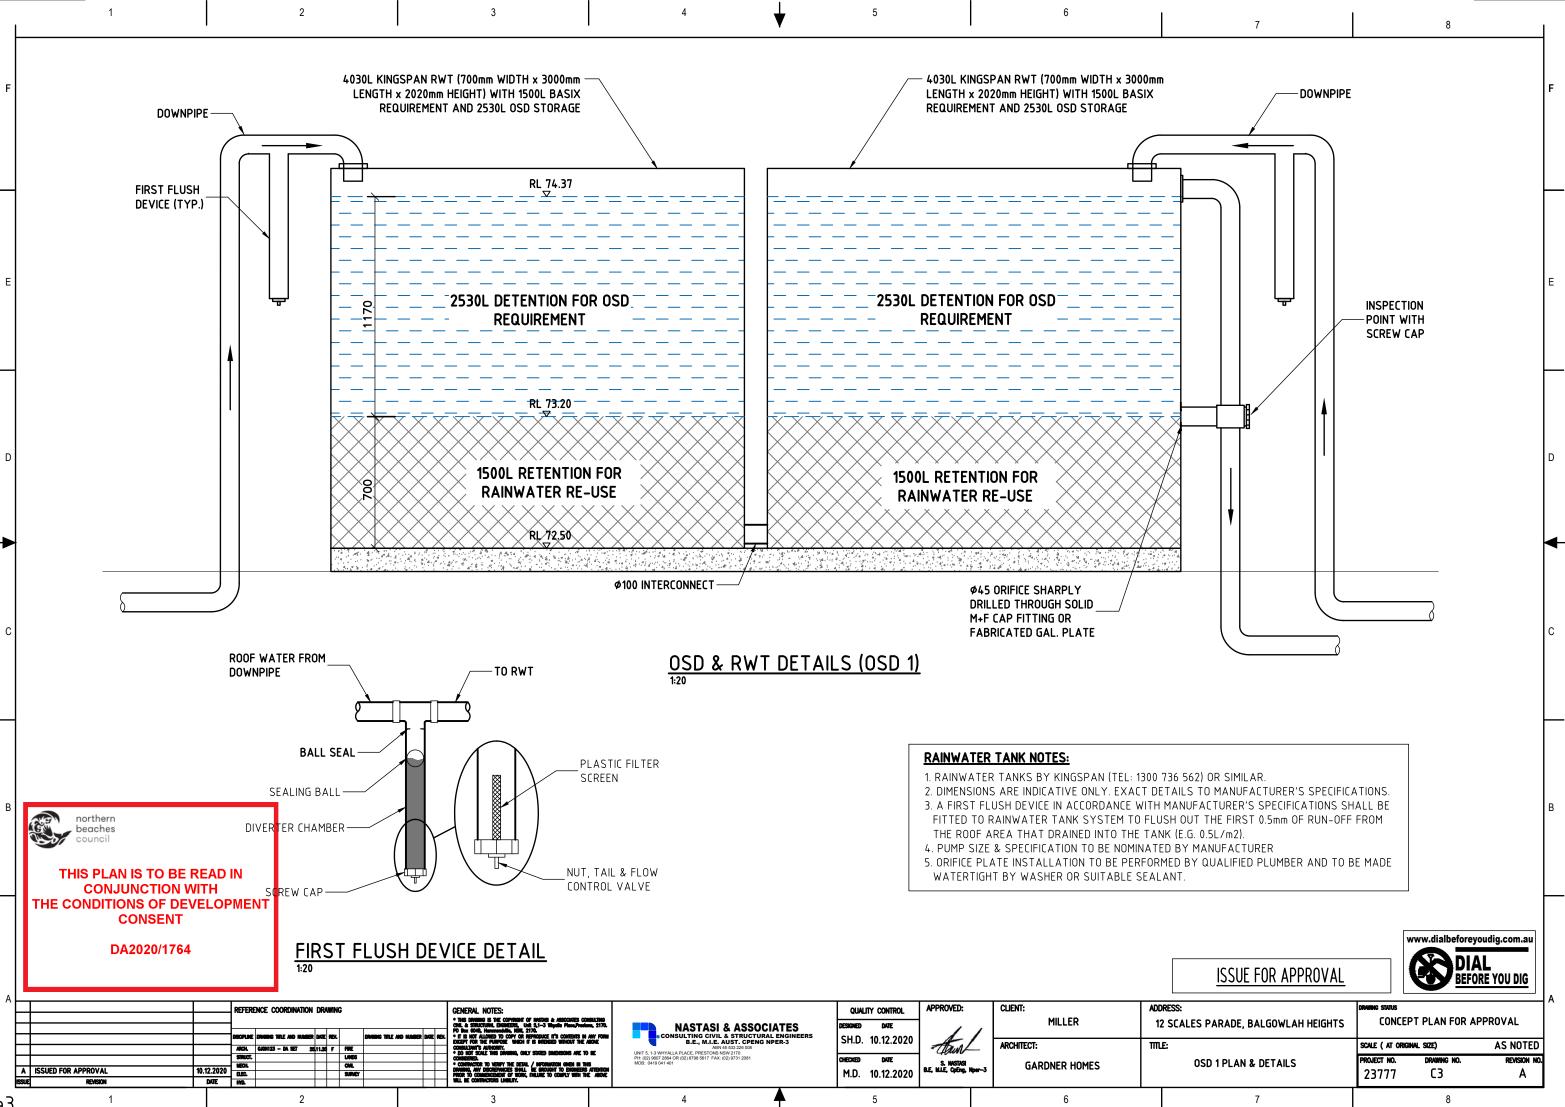
LES PARADE, BALGOWLAH HEIGHTS	CONCEPT PLAN FOR APPROVAL		PPROVAL
	SCALE ( AT ORIGINAL SIZE)		AS NOTED
COVER SHEET & NOTES	PROJECT NO.	DRAWING NO.	REVISION NO.
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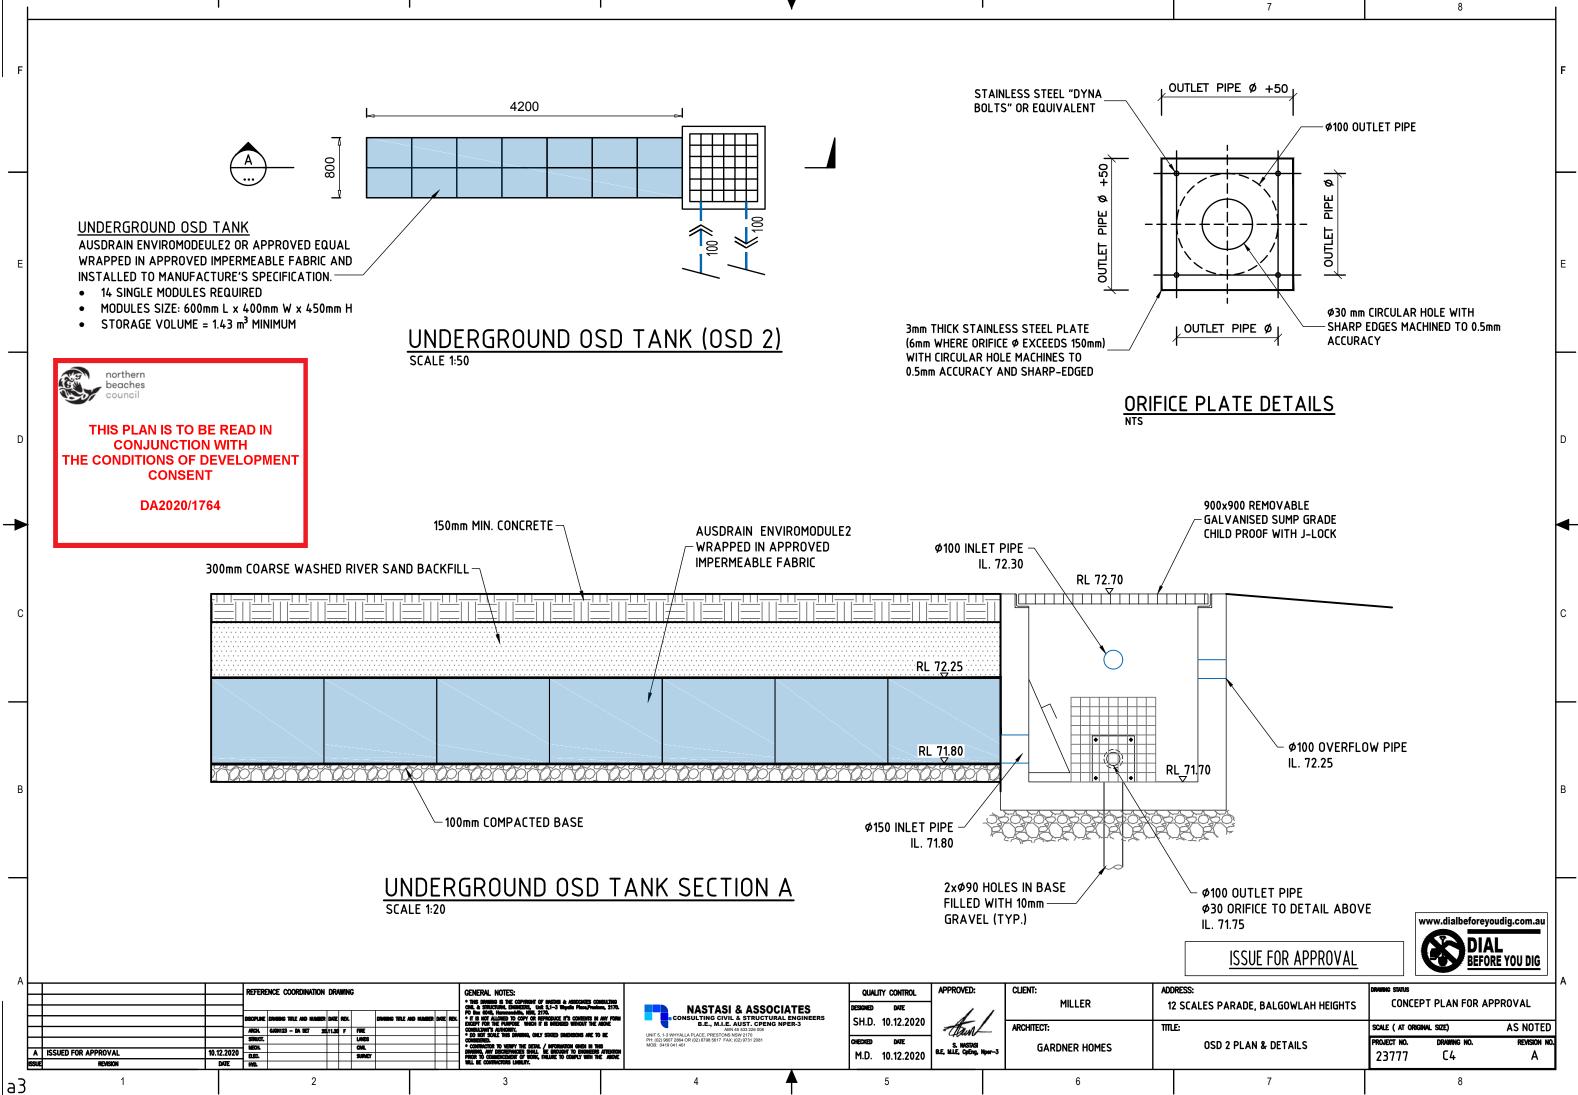
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ARY									
ACH COUNCIL – MANLY DCP							F		
= 572.2 m <sup>2</sup> ERVIOUS AREA = 318.6 m <sup>2</sup> (55.7%) PERVIOUS AREA = 306 m <sup>2</sup> (53.5%)									
D DEVELOPMENT IS SINGLE DWELLING. THE SITE IS IN ZONE 1, ON 4 OF THE ON-SITE STORMWATER MANAGEMENT 2003, OSD SINCE THE SLOP OF THE LAND IS TO THE REAR AND ROCK IS PTH AT THE REAR, CAPTURING THE WATER OF THE WHOLE POSSIBLE. ALSO, SINCE POOL AREA WILL REMAIN IN NEW AREA EXCLUDED FROM THE CALCULATION. OSD/RAINWATER VIROMODUL HAVE BEEN DESIGNED FOR ROOF AND DRIVEWAY ECTIVELY. DISCHARGE TO REAR IS RESTRICTED TO PRE T AS PER COUNCIL DCP AND AS SHEET FLOW.								E	
DISCHARGE ASSESSMENT BY DRAINS ILSAX MODEL							<u> </u>		
	HAVE BEEN DONE BASED ON RE-DEVELOPMENT AREA								
AREA =424.7 $m^2$ DISCHARGE TO OSD 1 = 195.9 $m^2$ DISCHARGE TO OSD 2 = 59.90 $m^2$ A = 114.5 $m^2$ (91% LANDSCAPE)							D		
REA TO OSD 1 (ROOF) = 195.9 m <sup>2</sup> AREA TO OSD 2 (DRIVEWAY) = 42.47 m <sup>2</sup> EA TO OSD 2 (LANDSCAPE)= 17.47 m <sup>2</sup>									
TE DISCHARGE IS LIMITED TO PRE-DEVELOPMENT OF THE 5 H 35% IMPERVIOUS AREA.									
POST DEV		OSD 1 VOLUME	Ø <sub>osd 1</sub> Orifice	OSD 2 VOLUME	Ø <sub>0SD 2</sub> ORIFICE	F C			
Q <sub>OSD 1</sub> (l/s)	Q <sub>OSD 2</sub> (l/s)	Q <sub>BYPASS</sub> (l/s)	Q <sub>POST</sub> (l/s)	(m <sup>3</sup> )	(mm)	(m <sup>3</sup> )	(mm)		
3.0	1.0	3.0	7.0	2.49	45	0.54	30		
4.0	1.0	5.0	10.0	3.56	45	0.87	30		
4.0	1.0	6.0	11.0	4.92	45	1.25	30		
VOLUME REQUIRED = 4.92 m <sup>3</sup> AT 1% AEP VOLUME PROVIDED = 5.06 m <sup>3</sup> TER FOR TANK = 45mm VOLUME REQUIRED = 1.25 m <sup>3</sup> AT 1% AEP VOLUME PROVIDED = 1.43 m <sup>3</sup>									
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SCALE (AT ORIGINAL SIZE) AS NOTED DRAINAGE PLAN PROJECT NO. DRAWING NO. REVISION NO. 23777 C2 A									
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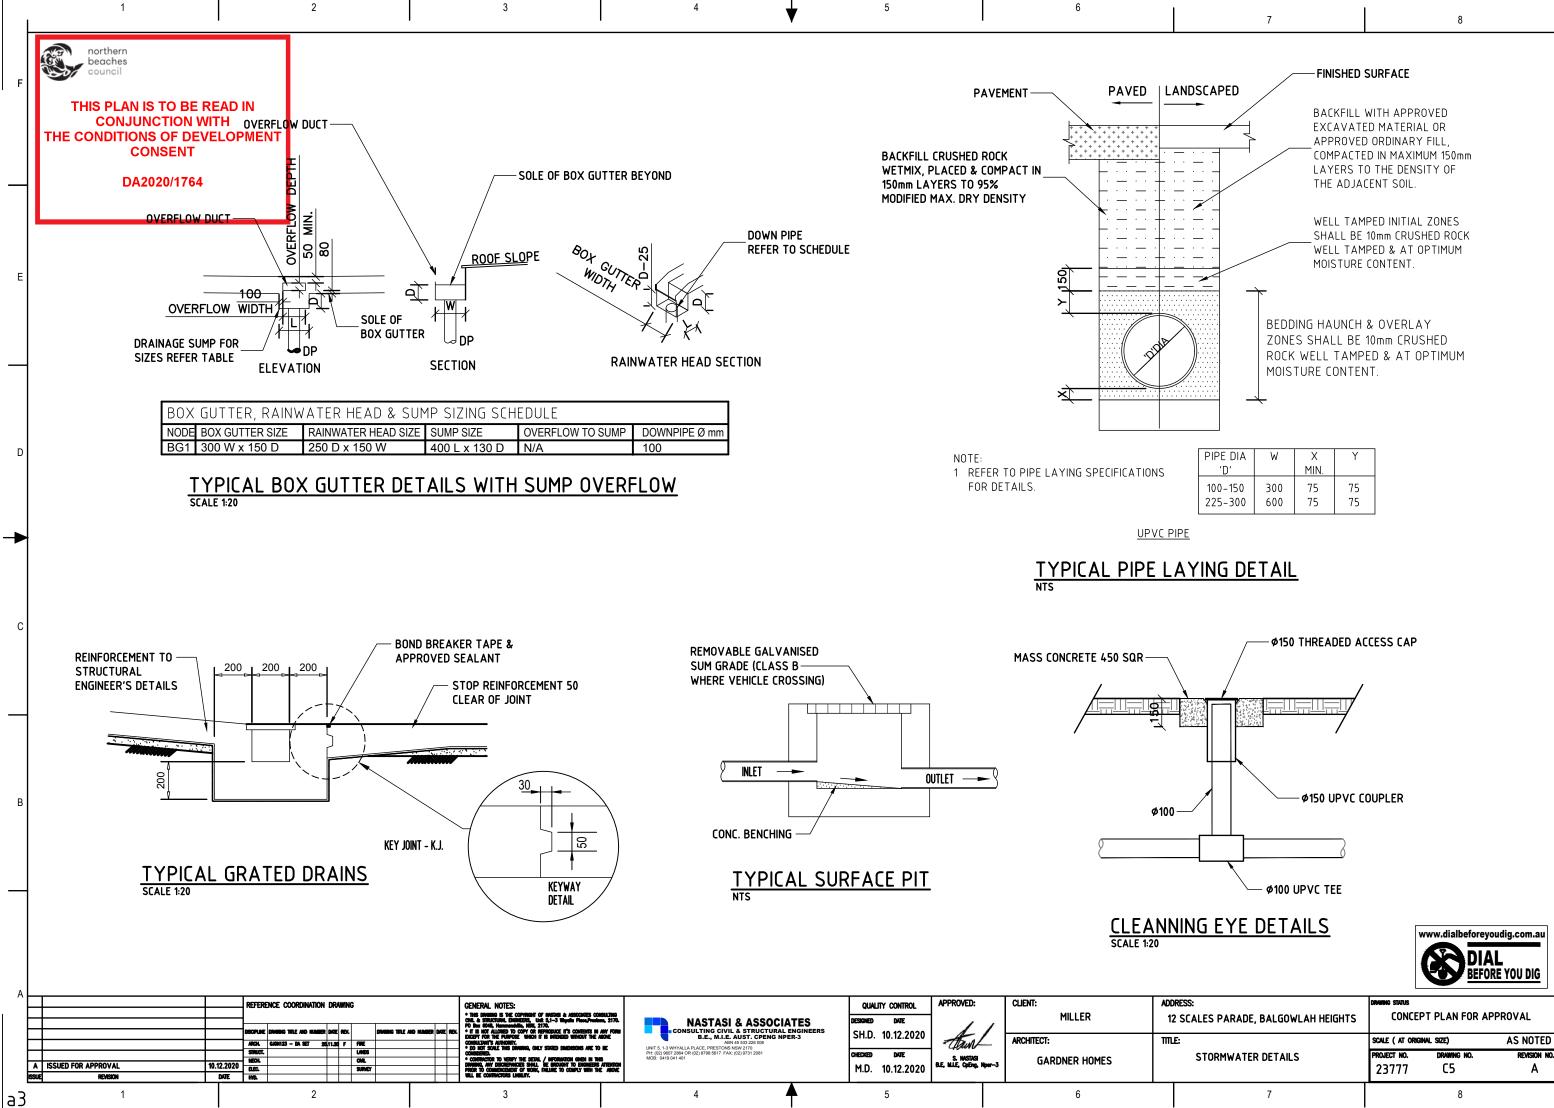


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PIPE DIA	W	Х	Y
'D'		MIN.	
100-150	300	75	75
225-300	600	75	75

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