


SYMBOLS	
F.F.L.	FINISHED FLOOR LEVEL
F.G.L.	FINISHED GARAGE LEVEL
Т.К.	TOP OF KERB
* 11.0	FINISHED LEVEL
+ 11.0	EXISTING LEVEL
S.L.	SURFACE LEVEL
I.L.	INVERT LEVEL
20 R	ROOF CATCHMENT AREA (m2)
20	IMPERVIOUS CATCHMENT AREA (m2)
20 L	LANDSCAPED CATCHMENT AREA (m2)
● DP	Ø100 DOWN PIPE OR EQUIVALENT
SP	SPREADER
• VD	VERTICAL DROP
• VR	VERTICAL RISER
- OF	SAFETY OVERFLOW
	RAIN WATER HEAD & DOWN PIPE
$\otimes$	CLEAN OUT POINT
⊜ SUMP	Ø150 SUMP
	CONCRETE COVER JUNCTION PIT
	GRATED INLET PIT 450x450
	200Wx100D GRATED DRAIN WITH 2% BTM SLOPE
	STORMWATER PIPE
	SUSPENDED STORMWATER PIPE
_	STORMWATER PIPE TO RWT
	PUMP LINE
	Ø100 SUBSOIL PIPE
	SILT FENCE
$\langle \Box$	OVERLAND FLOW
$\leftarrow$	FALLS

## EROSION CONTROL NOTES

- 1. ALL EROSION AND SILTATION CONTROL DEVICES ARE TO BE PLACED PRIOR TO THE COMMENCEMENT OF ANY CONSTRUCTION WORKS, AND ALL SILT TRAPS ARE TO HAVE
- DEPOSITED SILT REMOVED REGULARLY DURING CONSTRUCTION. 2. ALL TREES ARE TO BE PRESERVED UNLESS INDICATED OTHERWISE ON THE ARCHITECT'S OR LANDSCAPE ARCHITECT'S DRAWINGS. EXISTING GRASS COVER SHALL BE MAINTAINED
- EXCEPT IN AREAS CLEARED FOR BUILDINGS, PAVEMENTS ETC. 3. INSTALL TEMPORARY SEDIMENT BARRIERS TO ALL INLET PITS LIKELY TO COLLECT SILT
- LADDEN WATER, TO COUNCIL'S STANDARDS
- 4. NOT WITHSTANDING DETAILS SHOWN IT IS THE CONTRACTORS SOLE RESPONSIBILITY TO ENSURE THAT ALL SITE ACTIVITIES COMPLY WITH THE REQUIREMENTS OF THE CLEAN
- WATERS ACT.
- 5. ALL TOPSOIL TO BE CONSERVED FOR RE-USE ON SITE

- NOTES 1. ALL LINES ARE TO BE Ø100 U.P.V.C @ MIN 1.0% GRADE UNLESS NOTED OTHERWISE. CHARGED LINES TO BE SEWER GRADE & SEALED.
- 2. IT IS THE CONTRACTORS RESPONSIBILITY TO LOCATE & LEVEL ALL EXISTING SERVICES PRIOR TO THE COMMENCEMENT OF ANY EARTHWORKS.
- 3. ALL PIPES TO HAVE MIN 150mm COVER IF LOCATED WITHIN PROPERTY.
- 4. ALL PITS IN DRIVEWAYS TO BE 450x450 CONCRETE AND ALL PITS IN LANDSCAPED AREAS TO BE 450x450 PLASTIC. 5. PITS LESS THAN 600 DEEP MAY BE BRICK, PRECAST OR CONCRETE.
- 6. PITS DEEPER THAN 900 MUST BE 900x900 AND HAVE STEP RUNGS AT 300 CENTRES. 7. ALL BALCONIES AND ROOFS TO BE DRAINED AND TO HAVE SAFETY OVERFLOWS IN
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- 8. ALL EXTERNAL SLABS TO BE WATERPROOFED.
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- 13. ALL WORK WITHIN COUNCIL RESERVE TO BE INSPECTED BY COUNCIL PRIOR TO CONSTRUCTION.
- 14. COUNCIL'S ISSUED FOOTWAY DESIGN LEVELS TO BE INCORPORATED INTO THE FINISHED LEVELS ONCE ISSUED BY COUNCIL.
- 15. ALL WORK SHALL BE IN ACCORDANCE WITH B.C.A. AND A.S.3500.3. 16. EXISTING STORMWATER PIPE LOCATIONS HAVE BEEN ASSUMED. PLUMBER TO INSPECT PRIOR TO WORKS AND UPGRADE PIPES AS NECESSARY.

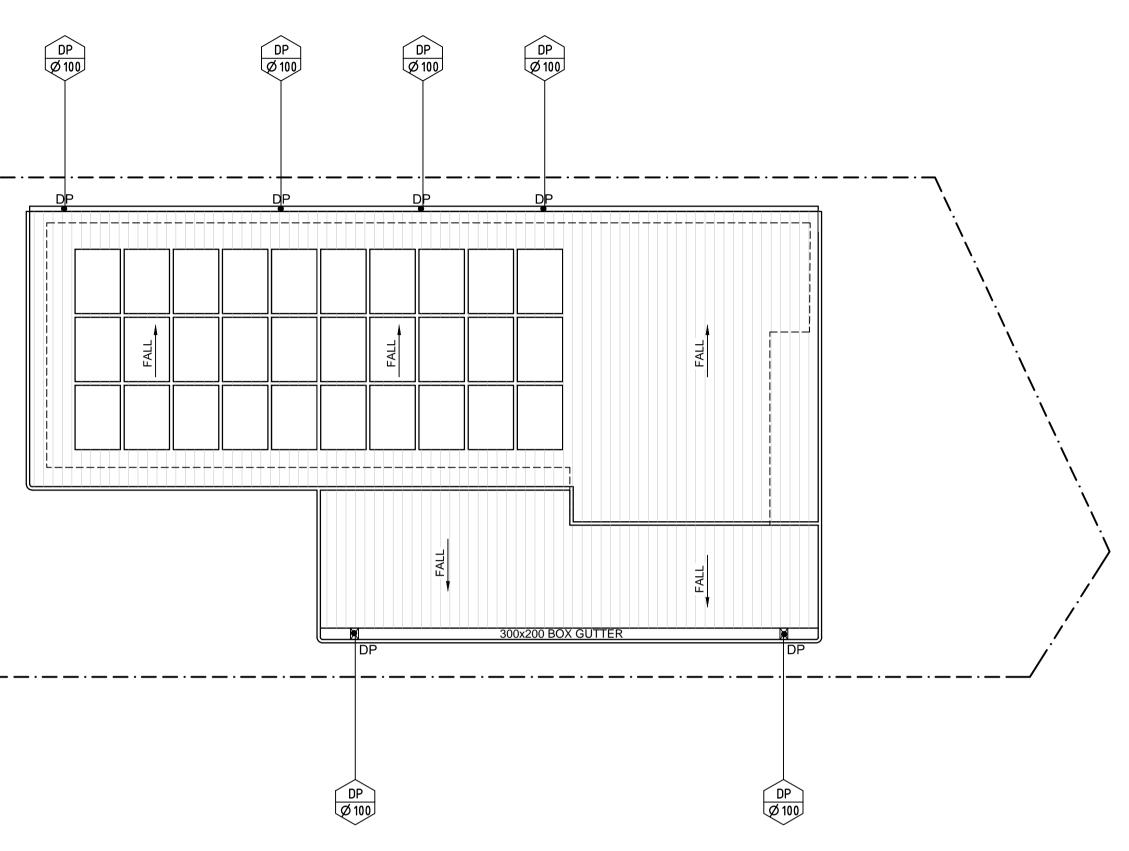

# ROOF DRAINAGE PLAN

SCALE 1:100 NOTE:


- 1. MINIMUM ROOF FALL 1% TO OUTLETS
- WATERPROOF ALL CONCRETE ROOFS
   PROVIDE SAFETY OVERFLOW TO ALL ROOFS
- 4. ALL DOWNPIPES CHARGED TO THE RAINWATER TANK ARE TO BE SEALED UP TO GUTTER
- LEVEL & BE PRESSURE TESTED AND CERTIFIED. 5. ALL DOWNPIPES TO BE CONSTRUCTED OF ONE MATERIAL FOR AESTHETICS REASONS
- AND PAINTED TO PROTECT THEM AGAINST ULTRA-VIOLET LIGHT DAMAGE.

**REFER TO DRAWING No. SW04** FOR ALL DRAINAGE DETAILS

## ISSUE FOR DA ONLY





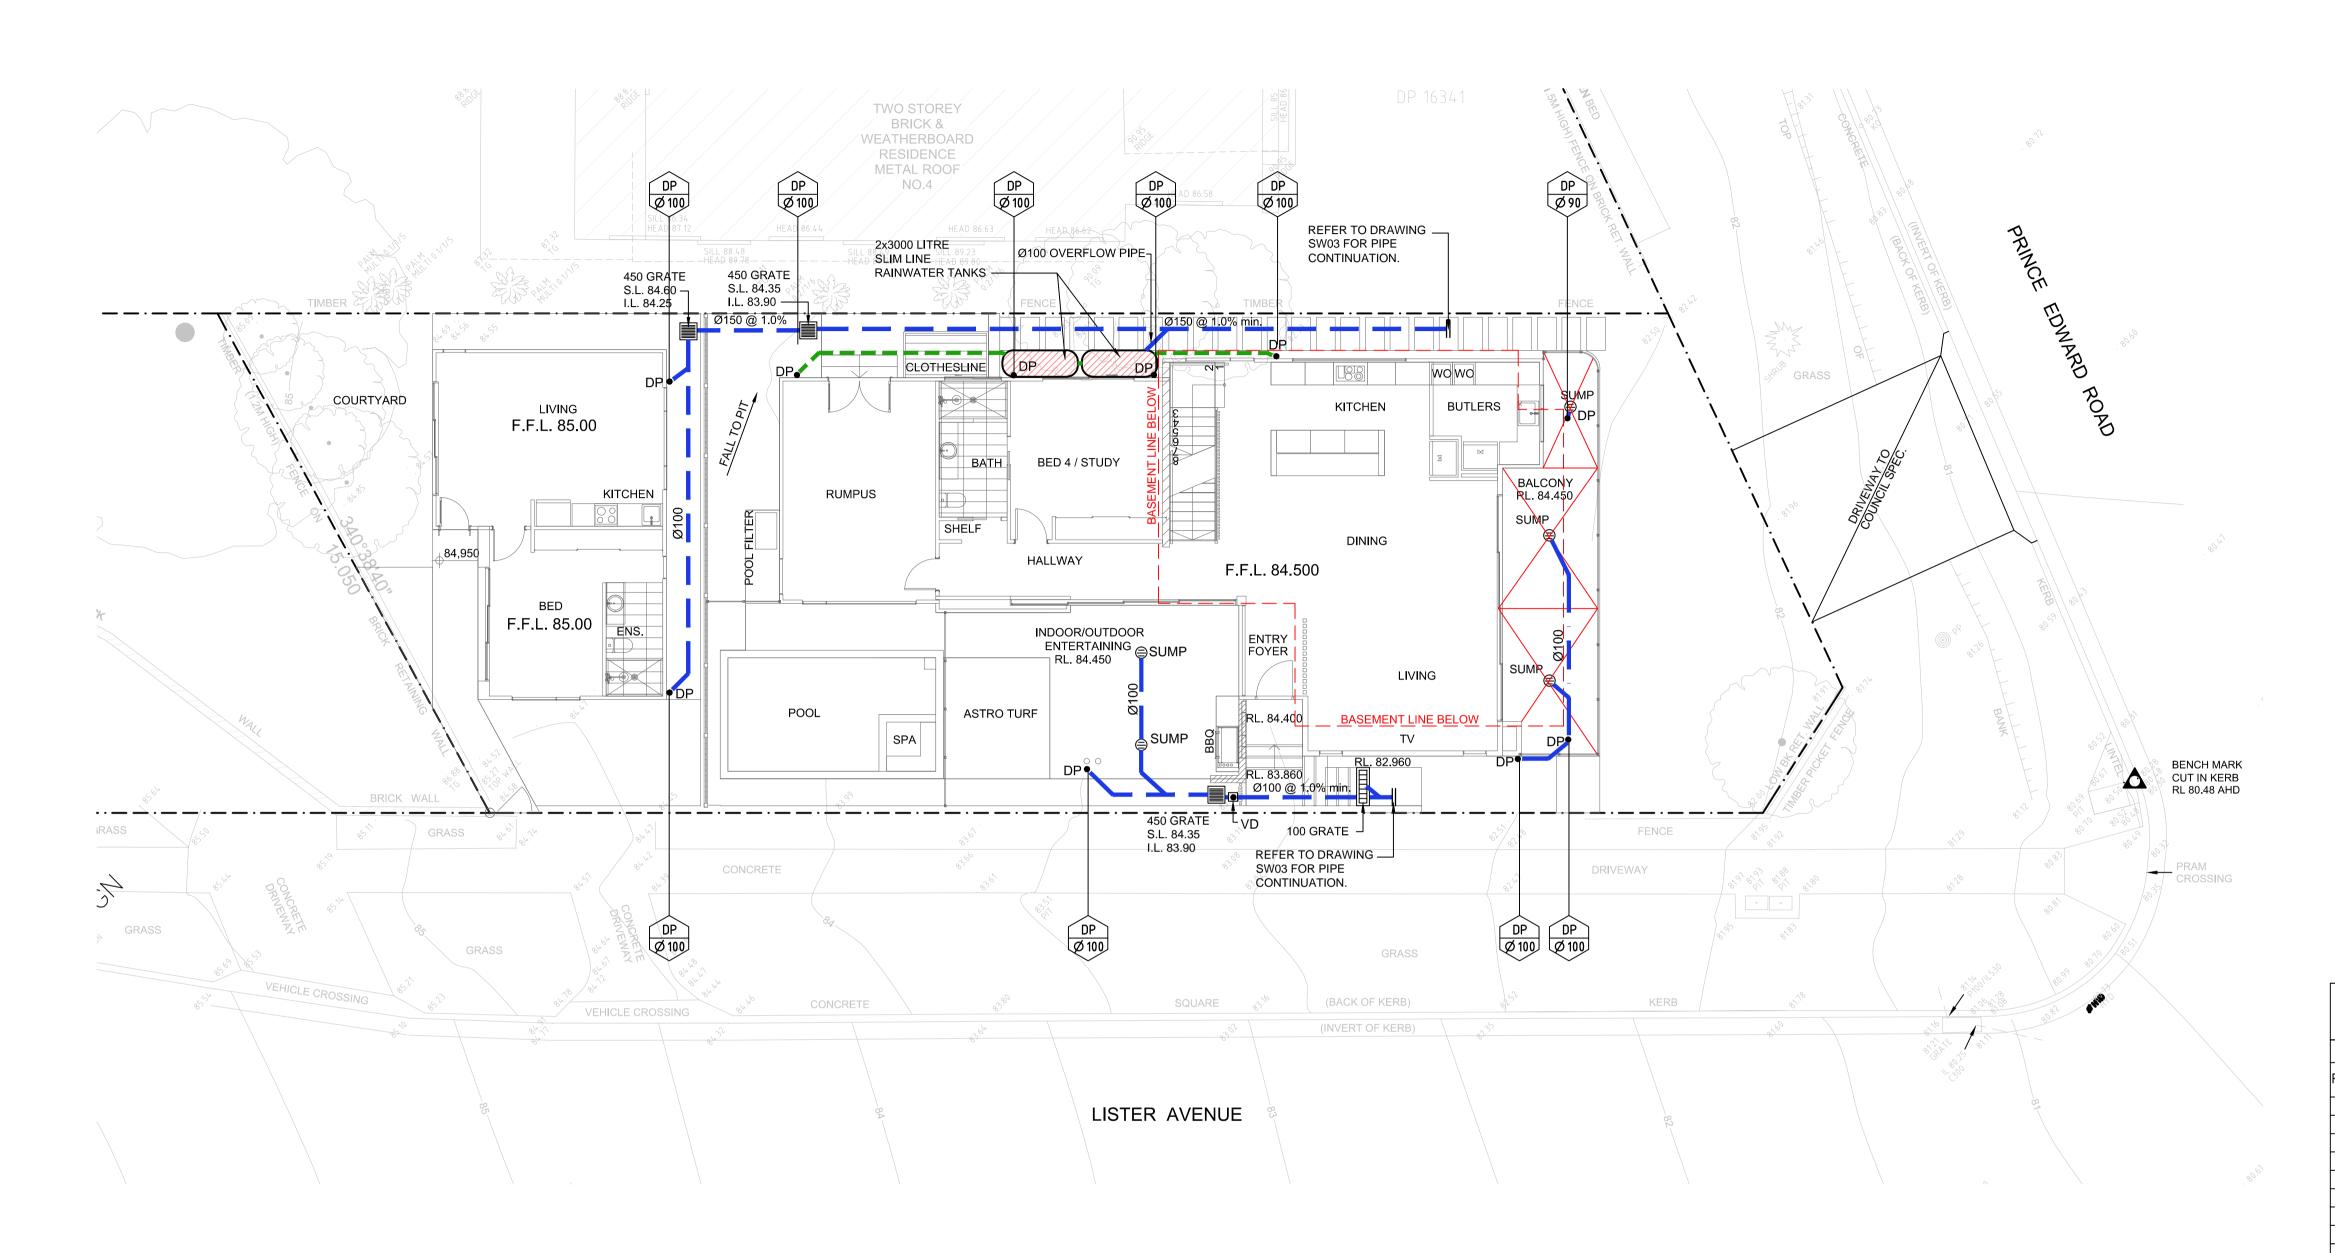

SYMBOLS	
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F.G.L.	FINISHED GARAGE LEVEL
T.K.	TOP OF KERB
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+ 11.0	EXISTING LEVEL
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	CONCRETE COVER JUNCTION PIT
	GRATED INLET PIT 450x450
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	STORMWATER PIPE TO RWT
	PUMP LINE
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<u> </u>	SILT FENCE
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<b>—</b>	FALLS

## EROSION CONTROL NOTES

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- WATERS ACT. 5. ALL TOPSOIL TO BE CONSERVED FOR RE-USE ON SITE

#### NOTES

- 1. ALL LINES ARE TO BE Ø100 U.P.V.C @ MIN 1.0% GRADE UNLESS NOTED OTHERWISE. CHARGED LINES TO BE SEWER GRADE & SEALED.
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# GROUND FLOOR DRAINAGE PLAN

#### SCALE 1:100 NOTE:

- MINIMUM ROOF FALL 1% TO OUTLETS
   WATERPROOF ALL CONCRETE ROOFS
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   PROVIDE SAFETY OVERFLOW TO ALL ROOFS
- ALL BALCONIES TO HAVE FLOOR WASTE AND 1% FALL WITH SAFETY OVERFLOW
   ALL DOWNPIPES CHARGED TO THE RAINWATER TANK ARE TO BE SEALED UP TO GUTTER
- LEVEL & BE PRESSURE TESTED AND CERTIFIED.
- 6. ALL DOWNPIPES TO BE CONSTRUCTED OF ONE MATERIAL FOR AESTHETICS REASONS AND PAINTED TO PROTECT THEM AGAINST ULTRA-VIOLET LIGHT DAMAGE.

REFER TO DRAWING No. SW04 FOR ALL DRAINAGE DETAILS

# ISSUE FOR DA ONLY

# ISSUE FOR DA Revision A 05.12.2024 ISSUE FOR DA

PROJECT: PROPOSED NEW RESIDENCE 2 PRINCE EDWARD ROAD, SEAFORTH


COUNCIL: NORTHERN BEACHES

CLIENT: SOPHIA & STUART NAYLOR


BUILDER:

ARCHITECT: NEW PARADIGM DESIGN PTY LTD


DRAWING TITLE: GROUND FLOOR DRAINAGE PLAN

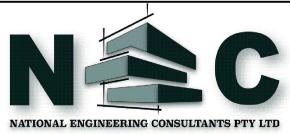

3/10 Childs Road, Chipping Norton, NSW 2170

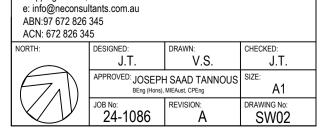



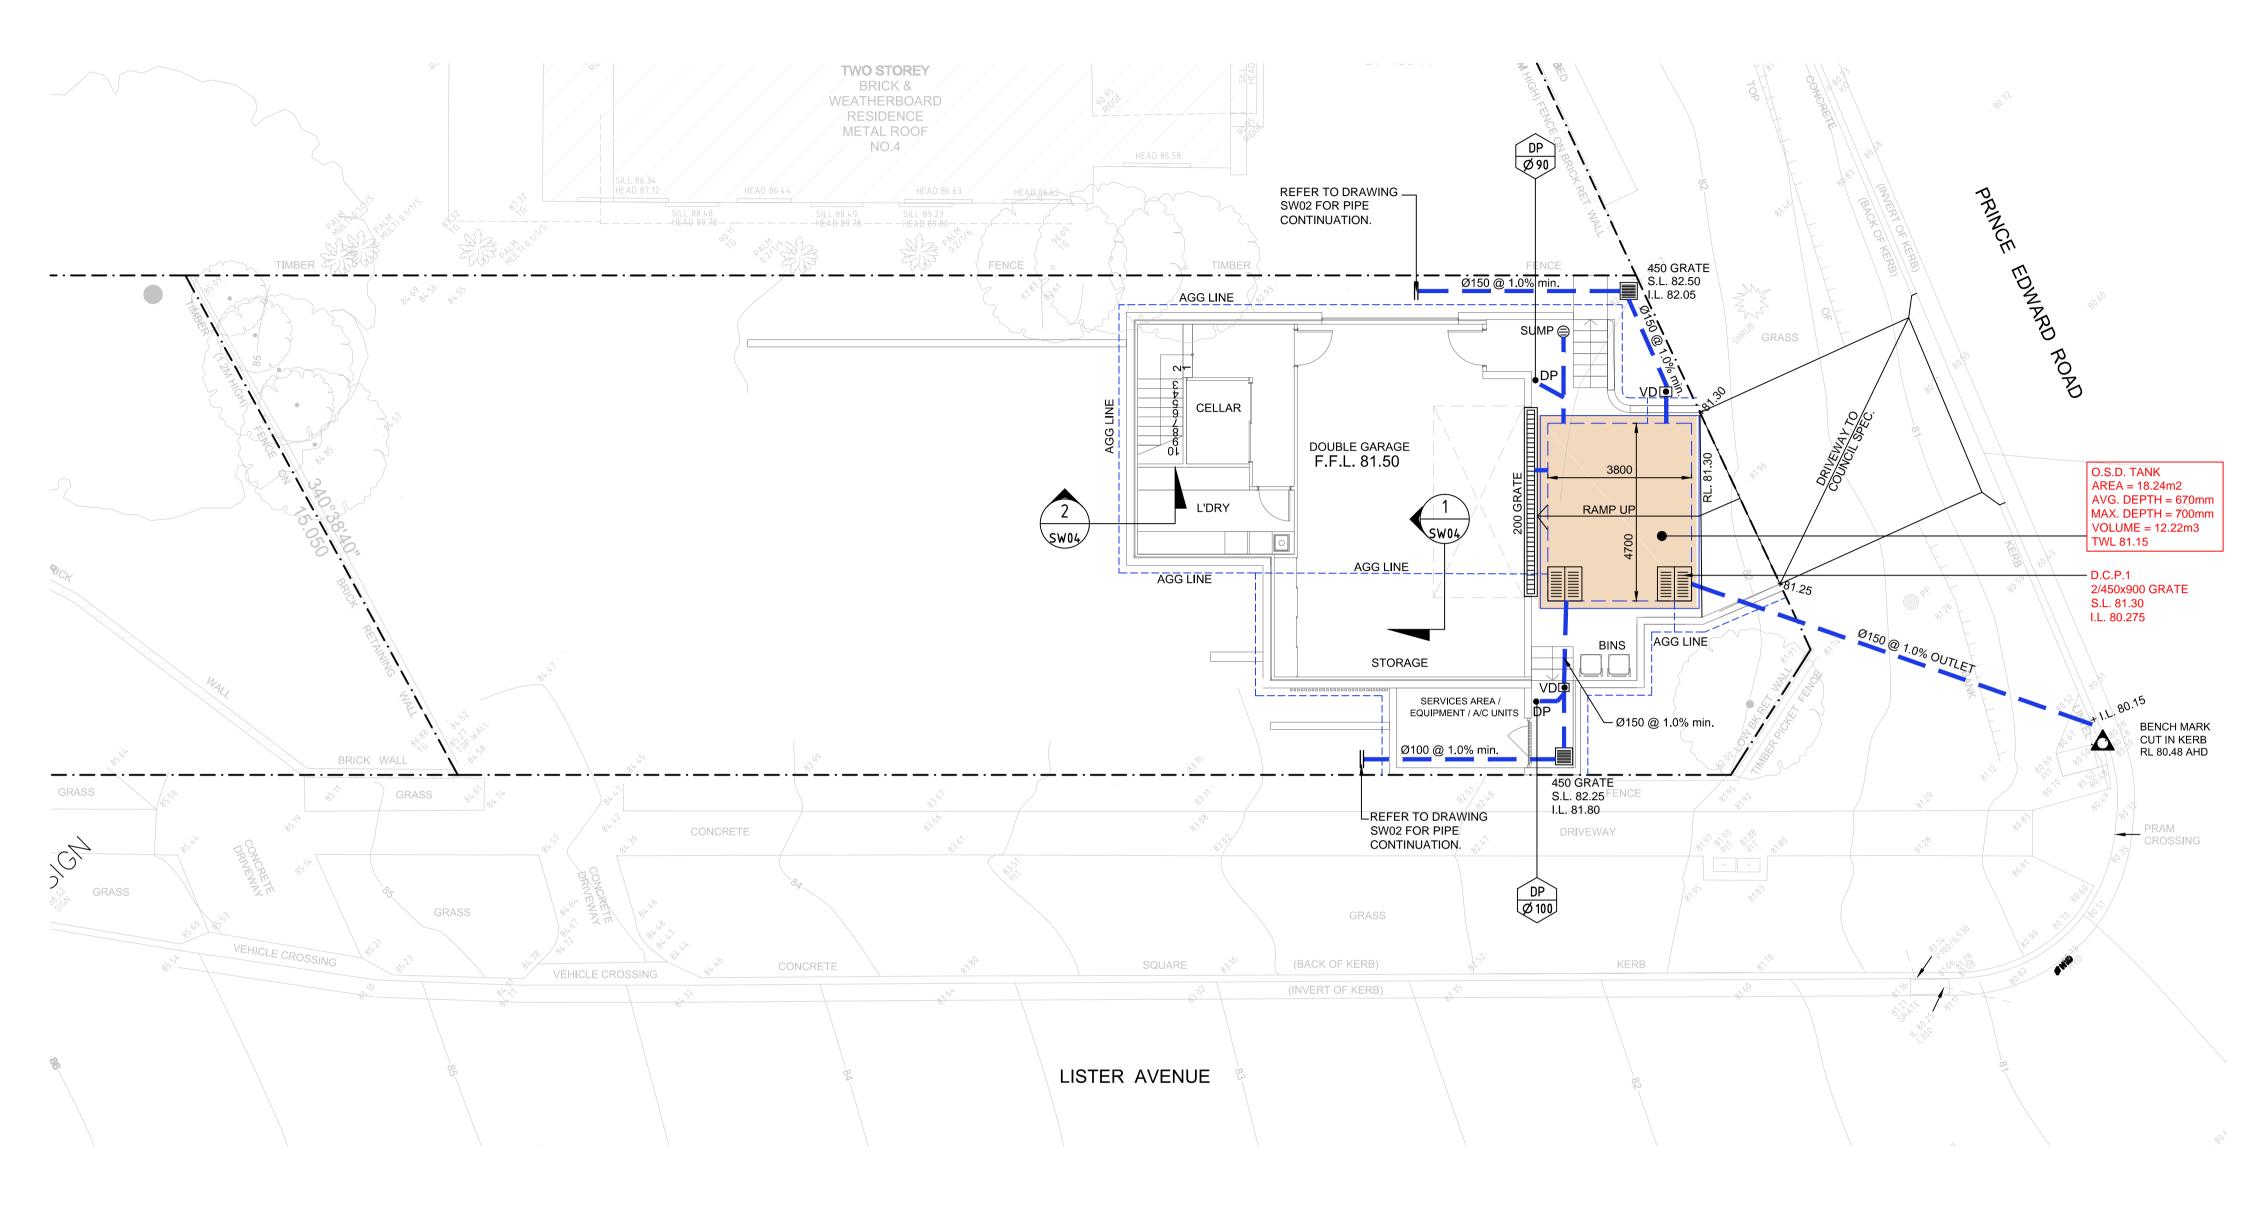

SYMBOLS	)
F.F.L.	FINISHED FLOOR LEVEL
F.G.L.	FINISHED GARAGE LEVEL
T.K.	TOP OF KERB
* 11.0	FINISHED LEVEL
+ 11.0	EXISTING LEVEL
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## EROSION CONTROL NOTES

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- 5. ALL TOPSOIL TO BE CONSERVED FOR RE-USE ON SITE

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   EXISTING STORMWATER PIPE LOCATIONS HAVE BEEN ASSUMED. PLUMBER TO INSPECT PRIOR TO WORKS AND UPGRADE PIPES AS NECESSARY.

# **BASEMENT DRAINAGE PLAN**

#### SCALE 1:100 NOTE:

- 1. ENGINEER TO INSPECT D.C.P.1 DURING CONSTRUCTION
- MINIMUM ROOF FALL 1% TO OUTLETS
   WATERPROOF ALL CONCRETE ROOFS
- PROVIDE SAFETY OVERFLOW TO ALL ROOFS
   ALL BALCONIES TO HAVE FLOOR WASTE AND 1% FALL WITH SAFETY OVERFLOW
- ALL DOWNPIPES CHARGED TO THE RAINWATER TANK ARE TO BE SEALED UP TO GUTTER
- LEVEL & BE PRESSURE TESTED AND CERTIFIED. 7. ALL DOWNPIPES TO BE CONSTRUCTED OF ONE MATERIAL FOR AESTHETICS REASONS
- AND PAINTED TO PROTECT THEM AGAINST ULTRA-VIOLET LIGHT DAMAGE.

REFER TO DRAWING No. SW04 FOR ALL DRAINAGE DETAILS

# ISSUE FOR DA ONLY

# ISSUE FOR DA Revision A 05.12.2024 ISSUE FOR DA

PROJECT: PROPOSED NEW RESIDENCE 2 PRINCE EDWARD ROAD, SEAFORTH

COUNCIL: NORTHERN BEACHES

CLIENT: SOPHIA & STUART NAYLOR

BUILDER:

ABN:97 672 826 345 ACN: 672 826 345

DESIGNED

ARCHITECT: NEW PARADIGM DESIGN PTY LTD

DRAWING TITLE: BASEMENT DRAINAGE PLAN




J.T. V.S.

APPROVED: JOSEPH SAAD TANNOUS BEng (Hons), MIEAust, CPEng A1 JOB NO: REVISION: DRAWING NO: 24-1086 A SW03

CHECKED:

J.T.

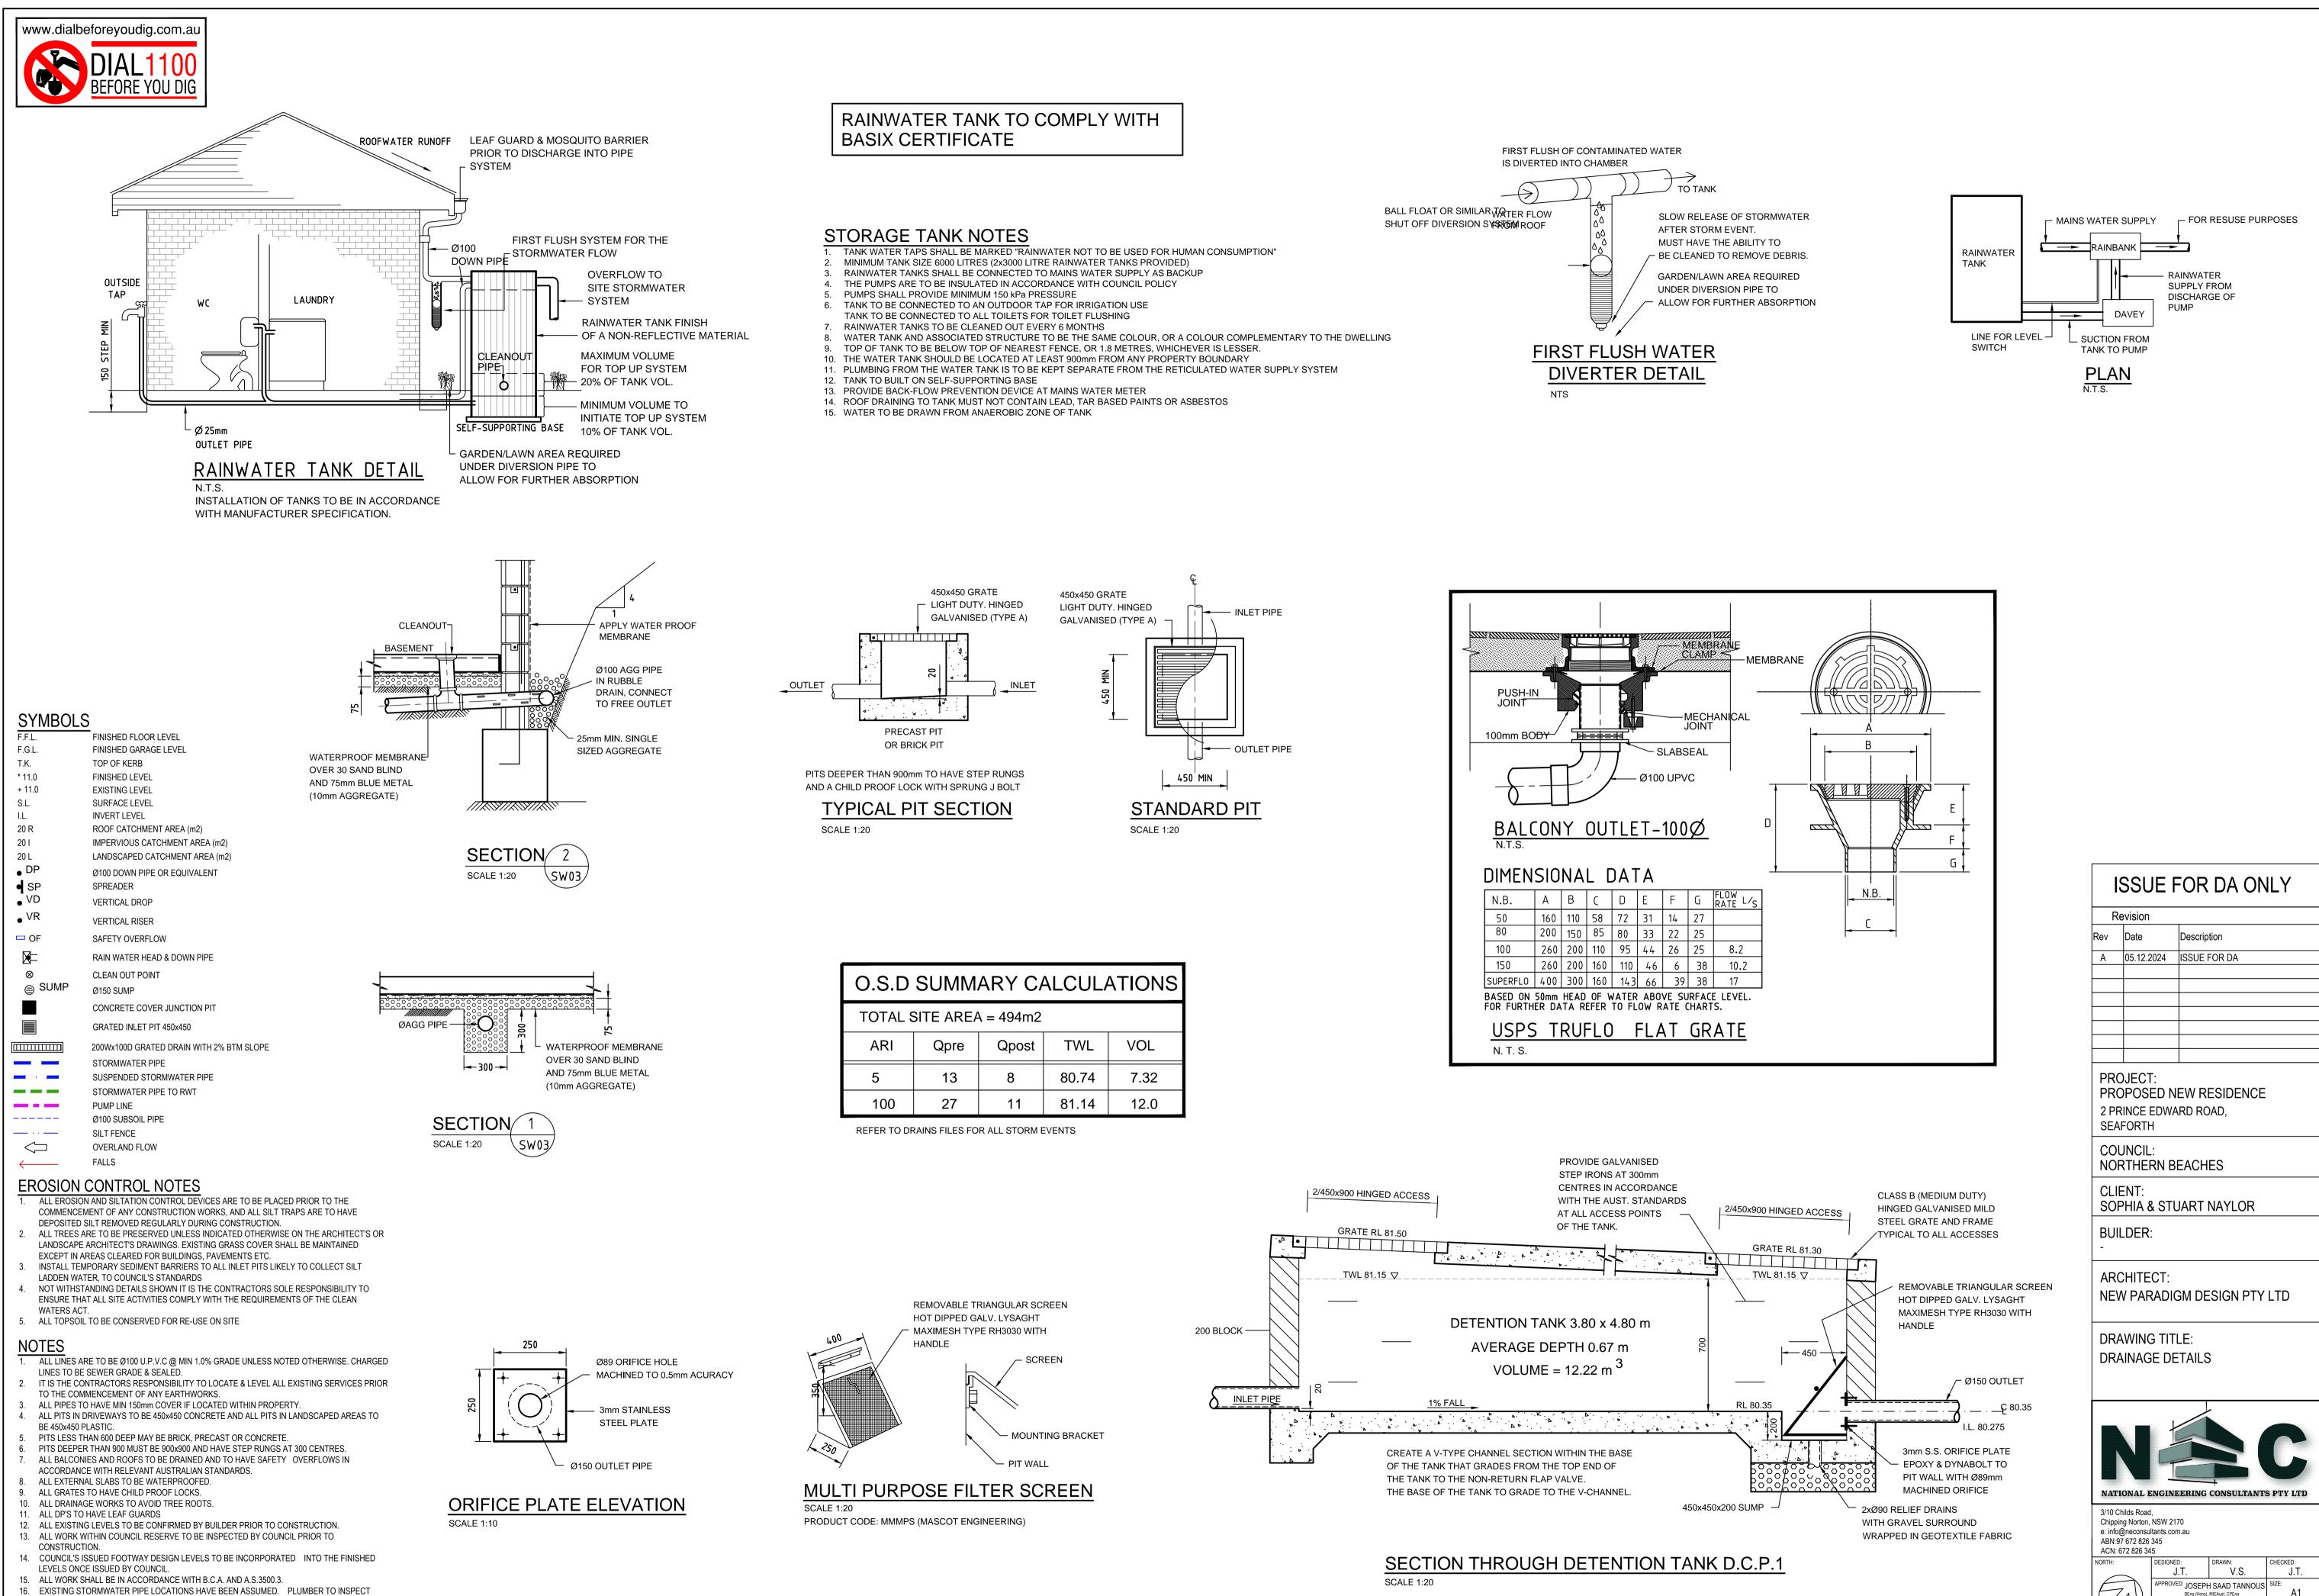

- 16. EXISTING STORMWATER PIPE LOCATIONS HAVE BEEN ASSUMED. PLUMBER TO INSPECT PRIOR TO WORKS AND UPGRADE PIPES AS NECESSARY.

.S.D SUMMARY CALCULATIONS
OTAL SITE AREA = 494m2

ARI	Qpre	Qpost	TWL	VOL	
5	13	8	80.74	7.32	
100	27	11	81.14	12.0	

BEng (Hons), MIEAust, CPEng


REVISION:

Α

DRAWING No: SW04

JOB №: 24-1086



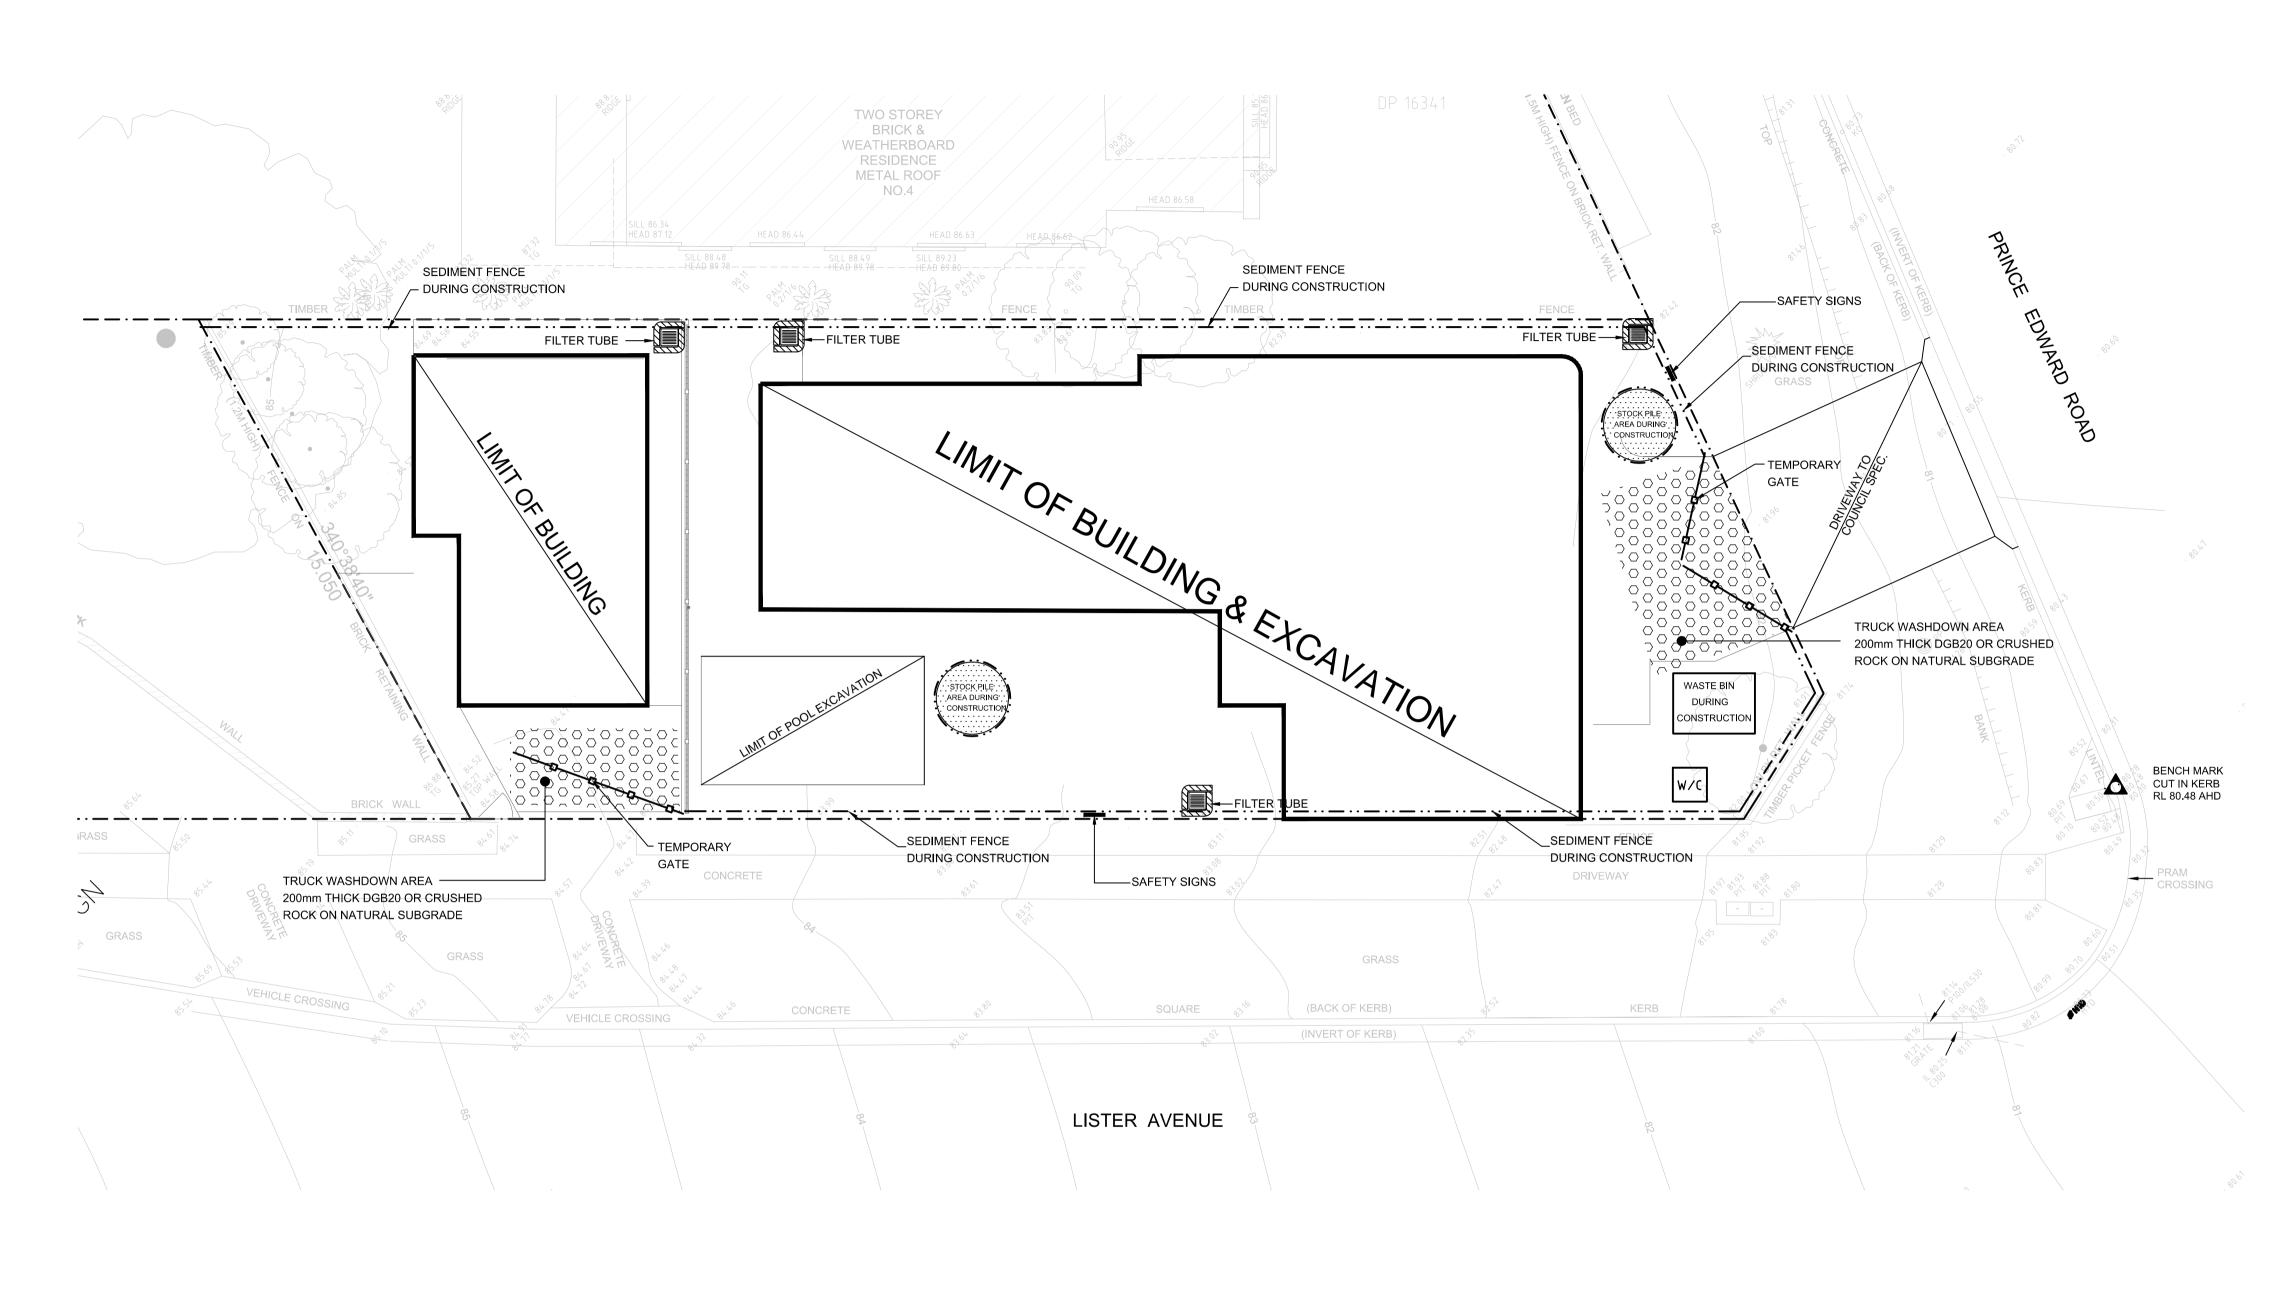

1.0.2.	
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<u> </u>	SILT FENCE
$\langle \Box$	OVERLAND FLOW
~	FALLS
N	-

FINISHED FLOOR LEVEL

FINISHED GARAGE LEVEL

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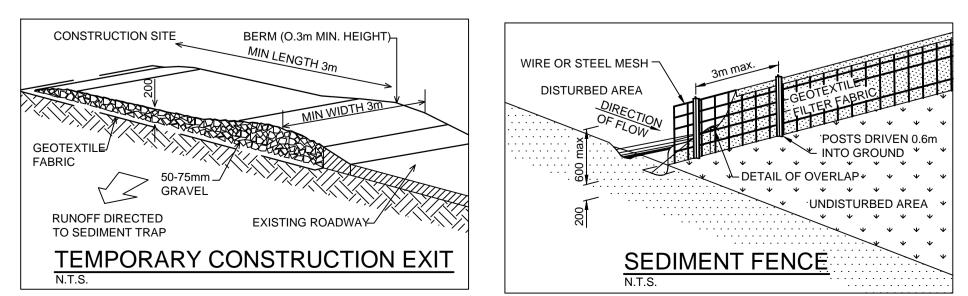
SYMBOLS


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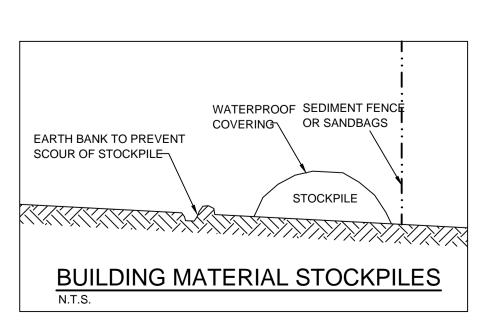


# SEDIMENT CONTROL NOTES

- STANDARDS OF SOIL CONSERVATION N.S.W. 2. ALL DRAINAGE WORKS SHALL BE CONSTRUCTED AND STABILIZED AS
- EARLY AS POSSIBLE DURING DEVELOPMENT.
- 4. ALL SEDIMENT BASINS AND TRAPS SHALL BE CLEANED WHEN THE
- INCLUDING DURING THE MAINTENANCE PERIOD. RELEVANT WORKS ARE COMPLETED.
- 6. AND AREAS WHERE WATER MAY CONCENTRATE.
- FILTER SHALL BE CONSTRUCTED BY STRETCHING A FILTER FABRIC
- 8. CONTROL SURFACE WATER FLOW IN A MANNER THAT: A- DIVERTS RUN-OFF AROUND DISTURBED AREAS

# SOIL & WATER MANAGEMENT PLAN

NOTE: CONNECT DOWN PIPES AS SOON AS ROOF IS ON.

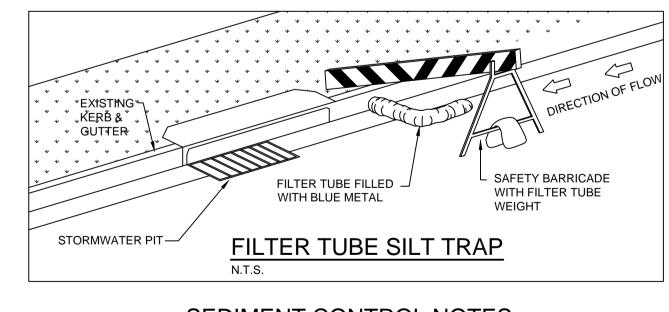

ALL EROSION AND SEDIMENTATION CONTROL MEASURES, INCLUDING REVEGETATION AND STORAGE OF SOIL, SHALL BE IMPLEMENTED TO THE

3. SEDIMENT TRAPS SHALL BE CONSTRUCTED AROUND ALL INLET PITS, CONSISTING OF 300mm WIDE x 300mm DEEP TRENCH.

STRUCTURES ARE A MINIMUM OF 60% FULL OF SOIL MATERIALS, 5. ALL DISTURBED AREAS SHALL BE REVEGETATED AS SOON AS THE

SOIL AND STOCKPILES SHALL BE LOCATED AWAY FROM DRAINAGE LINES

(PROPEX OR APPROVED EQUIVALENT BETWEEN POST AT 3.0M CENTERS. FABRIC SHALL BE BURIED 150 mm ALONG ITS LOWER EDGE.

B- MINIMISES SLOPE AND FLOW DISTANCE WITHIN DISTURBED AREAS C- ENSURES SURFACE RUN-OFF OCCURS AT NON-ERODABLE VELOCITIES D- ENSURES DISTURBED AREAS ARE PROMPTLY REHABILITATED

# **ISSUE FOR DA ONLY**

# Revision Description Date Rev A 05.12.2024 ISSUE FOR DA

PROJECT: PROPOSED NEW RESIDENCE 2 PRINCE EDWARD ROAD, SEAFORTH

COUNCIL: NORTHERN BEACHES

CLIENT: SOPHIA & STUART NAYLOR

BUILDER:

**ARCHITECT:** NEW PARADIGM DESIGN PTY LTD

DRAWING TITLE: SOIL & WATER MANAGEMENT PLAN



3/10 Childs Road, Chipping Norton, NSW 2170 e: info@neconsultants.com.au

