ALTERATIONS AND ADDITIONS TO EXISTING DWELLING, INCLUDING NEW SWIMMING POOL AND ASSOCIATED LANDSCAPING

#### 22 HILLCREST AVENUE MONA VALE NSW 2103

#### DA DOCUMENTATION SCHEDULE

DWG NO.	SUBSET	TITLE	SCALE	REV.	DATE	STATUS
DA-000	COVER & SITE INFORMATION	COVER PAGE & DRAWING SCHEDULES		01	20/11/24	DEVELOPMENT APPLICATION
DA-001	COVER & SITE INFORMATION	SITE PLAN	1:200	01	20/11/24	DEVELOPMENT APPLICATION
DA-100	GENERAL ARRANGEMENT PLANS	LOWER GROUND FLOOR	1:100	01	20/11/24	DEVELOPMENT APPLICATION
DA-101	GENERAL ARRANGEMENT PLANS	GROUND FLOOR	1:100	01	20/11/24	DEVELOPMENT APPLICATION
DA-102	GENERAL ARRANGEMENT PLANS	FIRST FLOOR	1:100	01	20/11/24	DEVELOPMENT APPLICATION
DA-300	ELEVATIONS	SHEET 01	1:100	01	20/11/24	DEVELOPMENT APPLICATION
DA-301	ELEVATIONS	SHEET 02	1:100	01	20/11/24	DEVELOPMENT APPLICATION
DA-302	ELEVATIONS	SHEET 02	1:100	01	20/11/24	DEVELOPMENT APPLICATION
DA-400	SECTIONS	SHEET 01	1:100	01	20/11/24	DEVELOPMENT APPLICATION
DA-401	SECTIONS	SHEET 02	1:100	01	20/11/24	DEVELOPMENT APPLICATION
DA-500	SITE STRATEGY PLANS	LANDSCAPE CONCEPT PLANS	1:200	01	20/11/24	DEVELOPMENT APPLICATION
DA-501	SITE STRATEGY PLANS	SITE ANALYSIS PLANS	1:200	01	20/11/24	DEVELOPMENT APPLICATION
DA-502	SITE STRATEGY PLANS	WASTE MANAGEMENT, EROSION & SEDIMENT CONTROL PLAN	1:200	01	20/11/24	DEVELOPMENT APPLICATION
DA-503	SITE STRATEGY PLANS	HARD & SOFT LANDSCAPE CALCULATIONS	1:250	01	20/11/24	DEVELOPMENT APPLICATION
DA-504	SITE STRATEGY PLANS	BUILDING BLANKETS		01	20/11/24	DEVELOPMENT APPLICATION
DA-800	POOL DETAILS/ DRIVEWAY PLANS	SHEET 01	1:100	01	20/11/24	DEVELOPMENT APPLICATION
DA-900	SHADOW DIAGRAMS	SHADOW DIAGRAM 9am	1:250	01	20/11/24	DEVELOPMENT APPLICATION
DA-901	SHADOW DIAGRAMS	SHADOW DIAGRAM 12pm	1:250	01	20/11/24	DEVELOPMENT APPLICATION
DA-902	SHADOW DIAGRAMS	SHADOW DIAGRAM 3pm	1:250	01	20/11/24	DEVELOPMENT APPLICATION

### **EXTERNAL FINISHES**





2. Vertical Timber Screening



3. Glass Balustrading



4. Mid-Grev Bagged Brick



1. Vertical Timber Cladding

5. Grey Stone Paving and Hardstand



7. Infinity Edge Pool



8. Dark Aluminum Doors and Windows

#### SCHEDULE OF BASIX COMMITMENTS

### POOL AND SPA

Painwater tank The applicant must install a rainwater tank of at least 7393.75 litres on the site. This rainwater tank must meet, and be installed in accordance with, the requirements of all applicable regulatory authorities. The applicant must configure the rainwater tank to collect rainwater runoff from at least 120 square metres of roof area. The applicant must connect the rainwater tank to a tap located within 10 metres of the edge of the pool. Outdoor swimming pool The swimming pool must be outdoors. The swimming pool must not have a capacity greater than 47 kilolitres.

The swimming pool must have a pool cover. The applicant must install a pool pump timer for the swimming pool. The applicant must install the following heating system for the swimming pool that is part of this development: solar (electric boosted).

Outdoor spa The swimming pool must not have a capacity greater than 9 kilolitres.

The swimming pool must have a spa cover. The applicant must install a spa pump timer for the swimming pool. The applicant must install the following heating system for the outdoor spa that is part of this development: solar (electric boosted).

### FIXTURES AND SYSTEMS

Hot Water The applicant must install the following hot water system in the development: gas instantaneous.

diode (LED) lamps Fixtures

The applicant must ensure new or altered showerheads have a flow rate no greater than 9 litres per minute or a 3 star water rating. The applicant must ensure new or altered toilets have a flow rate no greater than 4 litres per average flush or a minimum 3 star water rating. The applicant must ensure new or altered taps have a flow rate no greater than 9 litres per minute or minimum 3 star water rating.

### CONSTRUCTION

Insulation requirements The applicant must construct the new or altered construction (floor(s), walls, and ceilings/roofs) in accordance with the specifications listed in the table below, except that a) additional insulation is not required where the area of new construction is less than 2m2, b) insulation specified is not required for parts of altered construction where insulation already exists. Construction, Additional insulation required (R-value), Other specifications

concrete slab on ground floor: nil, N/A suspended floor above garage: concrete (R0.7), nil, N/A external wall: brick veneer, R1.16 (or R1.70 including construction) external wall: framed (weatherboard, fibro, metal clad), R1.30 (or R1.70 including construction) flat ceiling, pitched roof, ceiling: R1.45 (up), roof: foil backed blanket (55mm), medium (solar absorptance 0.475 - 0.70)

#### GLAZING REQUIREMENTS


Windows and Glazed Doors The applicant must install the windows, glazed doors and shading devices, in accordance with the specifications listed in the table below. Relevant overshadowing specifications must be satisfied for each window and glazed door. Helevant overshadowing specifications must be satisfied for each window and glazed door. The following requirements must also be satisfied in relation to each window and glazed door: Each window or glazed door with standard aluminium or timber frames and single clear or toned glass may either match the description, or, have a U-value and a Solar Heat Gain Coefficient (SHGC) no greater than that listed in the table below. Total system U-values and SHGCs must be calculated in accordance with National Fenestration Rating Council (NFRC) conditions. For projections described in millimetres, the leading edge of each eave, pergola, verandah, balcony or awning must be no more than 500 mm above the head of the window or glazed door and no more than 2400 mm above the sill. Pergolas with polycarbonate roof or similar translucent material must have a shading coefficient of less than 0.35. Pergolas with polycarbonate root or similar translucent material must have a flazed door to relate the paragle along Pergolas with fixed battens must have battens parallel to the window or glazed door above which they are situated, unless the pergola also shades a perpendicular window. The spacing between battens must not be more than 50 mm. Overshadowing buildings or vegetation must be of the height and distance from the centre and the base of the window and glazed door, as specified in the 'overshadowing' column in the table below

specified in the 'overshadowing' column in the table below.'
Window: A door no. Orientation Area of glass inc. frame (m2) Overshadowing Height (m) Distance (m) Shading device Frame and glass type W1 NE 204 00 eave/verandah/pergola/balcony >=900 mm, standard aluminium, single clear, (or U-value: 7.63, SHGC: 0.75)
D1 NE 14.56 0 eave/verandah/pergola/balcony >=900 mm standard aluminium, single clear, (or U-value: 7.63, SHGC: 0.75)
D2 NE 26 00 eave/verandah/pergola/balcony >=900 mm standard aluminium, single clear, (or U-value: 7.63, SHGC: 0.75)
D3 SE 1.5 0 0 none. standard aluminium, single clear, (or U-value: 7.63, SHGC: 0.75)
D3 SE 1.5 0 0 none. standard aluminium, single clear, (or U-value: 7.63, SHGC: 0.75)
D5 NE 1.92 0 0 eave/verandah/pergola/balcony >=900 mm standard aluminium, single clear, (or U-value: 7.63, SHGC: 0.75)
D5 NE 1.92 0 0 eave/verandah/pergola/balcony >=900 mm standard aluminium, single clear, (or U-value: 7.63, SHGC: 0.75)
D6 NE 45.36 0 0 eave/verandah/pergola/balcony >=900 mm standard aluminium, single clear, (or U-value: 7.63, SHGC: 0.75)
D6 NE 45.36 0 0 eave/verandah/pergola/balcony >=900 mm standard aluminium, single clear, (or U-value: 7.63, SHGC: 0.75)
W3 SE 14.04 0 0 none. standard aluminium, single clear, (or U-value: 7.63, SHGC: 0.75)
D7 SW 11.57 0 0 none, standard aluminium, single clear, (or U-value: 7.63, SHGC: 0.75)
D8 SW 2.70 0 none, standard aluminium, single clear, (or U-value: 7.63, SHGC: 0.75)
D9 SW 8.37 0 0 none standard aluminium, single clear, (or U-value: 7.63, SHGC: 0.75)
D10 SW 2.21 1.6 2 awning (adjustable) >=900 mm standard aluminium, single clear, (or U-value: 7.63, SHGC: 0.75)
W1 NW 1.21 5 2 none standard aluminium, single clear, (or U-value: 7.63, SHGC: 0.75)
W7 NW 1.21 5 2 none standard aluminium, single clear, (or U-value: 7.63, SHGC: 0.75)
W1 NW 4.27 5 2 none standard aluminium, single clear, (or U-value: 7.63, SHGC: 0.75)
W1 NW 1.21 W13 NW 1.66 0 0 awning (fixed) >=900 mm standard aluminium, single clear, (or U-value: 7.63, SHGC: 0.75)

	KEY:           DENOTES EXISTING STRUCTURE TO BE RETAINED           DENOTES PROPOSED NEW STRUCTURE	PROJECT: ALTERATIONS AND ADDITIONS TO EXISTING DWELLING, INCLUDING NEW SWIMMING POOL AND ASSOCIATED LANDSCAPING	PROJECT STAGE: DEVELOPMENT APPLICATI
	DENOTES AREA OF SOFT LANDSCAPING     DENOTES AREA OF SWIMMING POOL     DENOTES EXISTING STRUCTURE TO BE DEMOLISHED	CLIENT: ZLAT AND BECC JOVANOV	DRAWING TITLE: COVER & SITE INFORMATION: CO' & DRAWING SCHEDULES
NOTE: THESE DRAWINGS ARE NOT FOR CONSTRUCTION. FOR DA APPROVAL ONLY NOTE: NO NOT SCALE OF THIS DRAWING NOTE: ALL WORKS TO BE IN ACCORDANCE WITH THE R.C.C. 2022 NOTE: ALL WORKS TO BE IN ACCORDANCE WITH THE RELEVANT AUSTRALIAN STANDARDS NOTE: ALL WORKS TO BE IN ACCORDANCE WITH THE BASIX REQUIREMENTS	DENOTES PROPOSED ADDITION DENOTES PROPOSED ALERATIONS	LOCATION: 22 HILLCREST AVENUE, MONA VALE, NSW	SCALE: @ A3


Lighting The applicant must ensure a minimum of 40% of new or altered light fixtures are fitted with fluorescent, compact fluorescent, or light-emitting-

GE: LICATION	<b>DATE OF ISSUE:</b> 20/11/24	rama
L <b>E:</b> N: COVER PAGE DULES	DRAWING NO. DA-000	nominated architect Thomas Martin naw reg. 410430 6 / 20 AVLAN PARADE AVALON BEACH, NSW 2107 www.ramaarchitects.com
	REVISION: 01	<ul> <li>Info@ramaachikeds.com</li> <li>ABN 612 73 425</li> <li>COPYRIGHT OF RAMA ARCHITECTS PTY, LTD.</li> <li>THIS DRWING IS NOT TO BE USED OF REPRODUCED IN ARY FORM WITHOUT CONSENT.</li> <li>DO NOT SCALE FROM THIS DRWING</li> </ul>

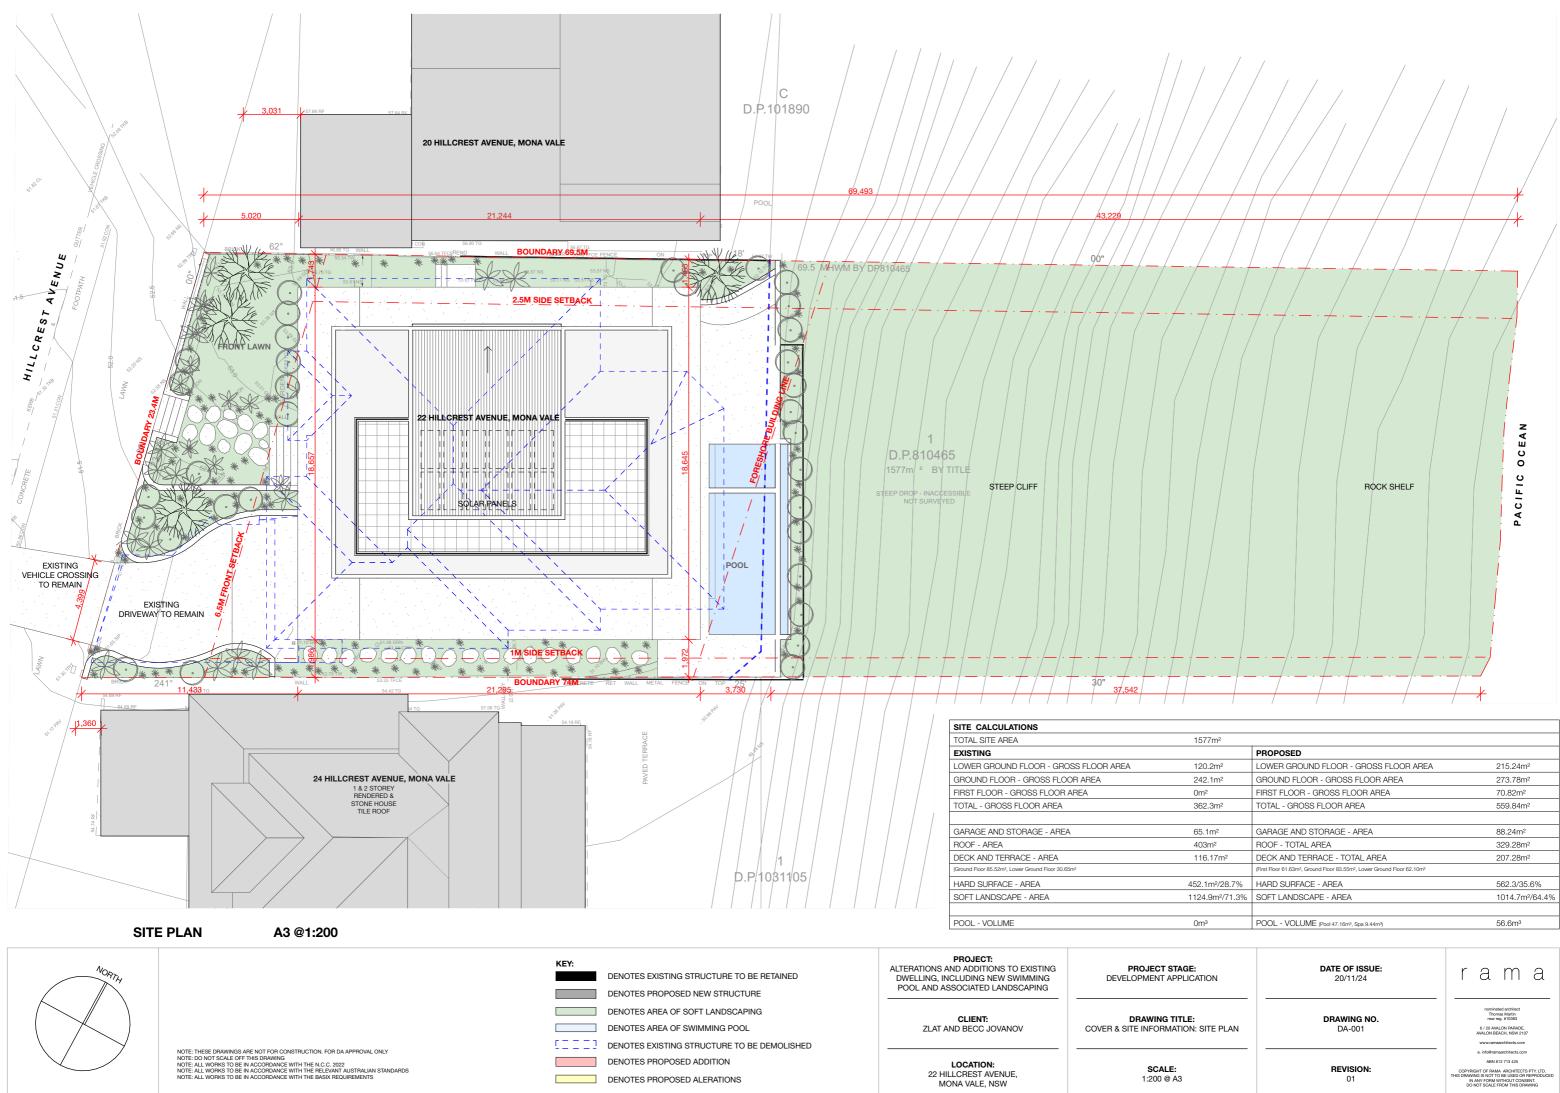


1577m <sup>2</sup>		
	PROPOSED	
120.2m <sup>2</sup>	LOWER GROUND FLOOR - GROSS FLOOR AREA	215.24m <sup>2</sup>
242.1m <sup>2</sup>	GROUND FLOOR - GROSS FLOOR AREA	273.78m <sup>2</sup>
0m <sup>2</sup>	FIRST FLOOR - GROSS FLOOR AREA	70.82m <sup>2</sup>
362.3m <sup>2</sup>	TOTAL - GROSS FLOOR AREA	559.84m <sup>2</sup>
65.1m <sup>2</sup>	GARAGE AND STORAGE - AREA	88.24m <sup>2</sup>
403m <sup>2</sup>	ROOF - TOTAL AREA	329.28m <sup>2</sup>
116.17m <sup>2</sup>	DECK AND TERRACE - TOTAL AREA	207.28m <sup>2</sup>
	(First Floor 61.63m <sup>2</sup> , Ground Floor 83.55m <sup>2</sup> , Lower Ground Floor 62.10m <sup>2</sup>	
452.1m <sup>2</sup> /28.7%	HARD SURFACE - AREA	562.3/35.6%
1124.9m <sup>2</sup> /71.3%	SOFT LANDSCAPE - AREA	1014.7m <sup>2</sup> /64.4%
0m <sup>3</sup>	POOL - VOLUME (Pool 47.16m <sup>3</sup> , Spa 9.44m <sup>9</sup> )	56.6m <sup>3</sup>

GE: LICATION	<b>DATE OF ISSUE:</b> 20/11/24	r a m a	
<b>LE:</b> ON: SITE PLAN	DRAWING NO. DA-001	nominsted architect Thomas Martin new reg. #10583 6 / 20 AWLON \$PAADE AWALON BEACH, NSW 2107 www.ramaarchitect.com	
	REVISION: 01	e. info@ramaarchitects.com ABN 612 713 425 COPYRIGHT OF RAMA. ARCHITECTS PTV. LTD. THIS DRAWING IS NOTT OB EUSE OR REPRODUCED IN ANY FORM WITHOUT CONSENT. DO NOT SCALE EED AT USE DRAWING	

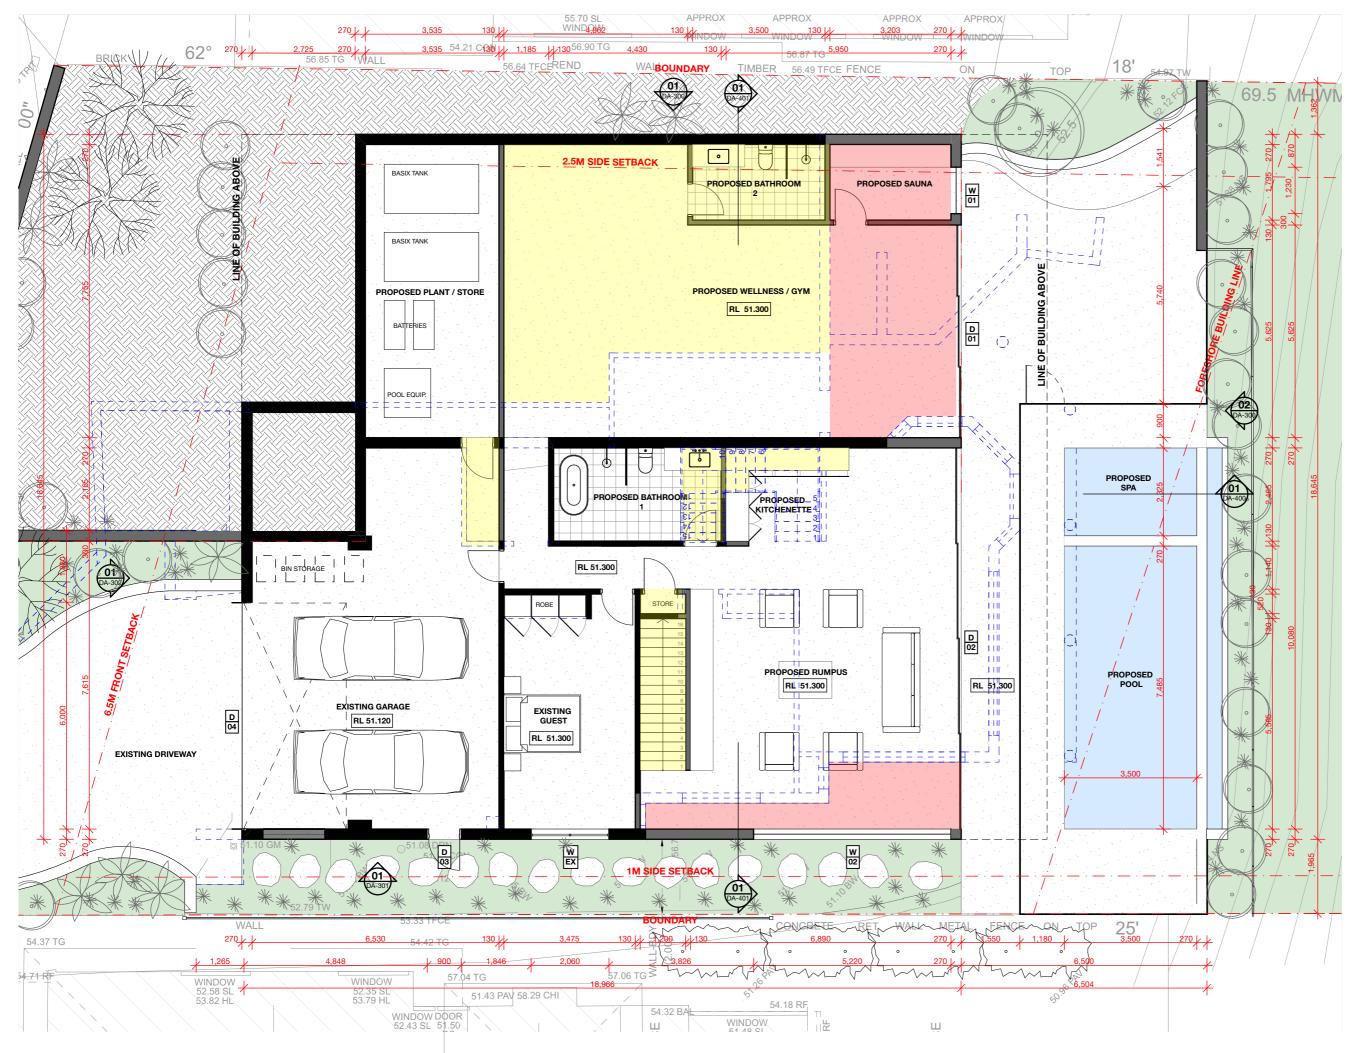


NORTH
NOTE: THESE DRAWINGS ARE NOT FOR CONSTRUCTION. FOR DA APPROVAL ONLY NOTE: DO NOT SCALE OFF THIS DRAWING NOTE: ALL WORKS TO BE IN ACCORDANCE WITH THE N.C.C. 2019 NOTE: ALL WORKS TO BE IN ACCORDANCE WITH THE N.C.C. 2019 NOTE: ALL WORKS TO BE IN ACCORDANCE WITH THE RELEVANT AUSTRALIANS TANDARDS NOTE: ALL WORKS TO BE IN ACCORDANCE WITH THE BASIX REQUIREMENTS KEY: DENOTES EXISTING STRUCTURE TO BE RETAINED
DENOTES PROPOSED NEW STRUCTURE DENOTES AREA OF SOFT LANDSCAPING DENOTES AREA OF SWIMMING POOL C C C C C C C C C C C C C C C C C C C
PROJECT: ALTERATIONS AND ADDITIONS TO EXISTING DWELLING, INCLUDING NEW SWIMMING POOL AND ASSOCIATED LANDSCAPING CLIENT: ZLAT AND BECC JOVANOV LOCATION: 22 HILLCREST AVENUE, MONA VALE, NSW
PROJECT STAGE: DEVELOPMENT APPLICATION DRAWING TITLE: GENERAL ARRANGEMENT PLANS: LOWER GROUND FLOOR
SCALE: 1:100 @ A3 DATE OF ISSUE: 20/11/24
DRAWING NO. DA-100  REVISION: 01
r a m a nominated architect Thomas Martin men mg, #10880 6 / 20 AMALON MPARAE AND REACH NSY 2107 www.zemaarchitects.com

ABN 612 713 425 COPYRIGHT OF RAMA. ARCHITECTS PTY. LTD. HIS DRAWING IS NOT TO BE USED OR REPRODUCED IN ANY FORM WITHOUT CONSENT. DO NOT SCALE FROM THIS DRAWING

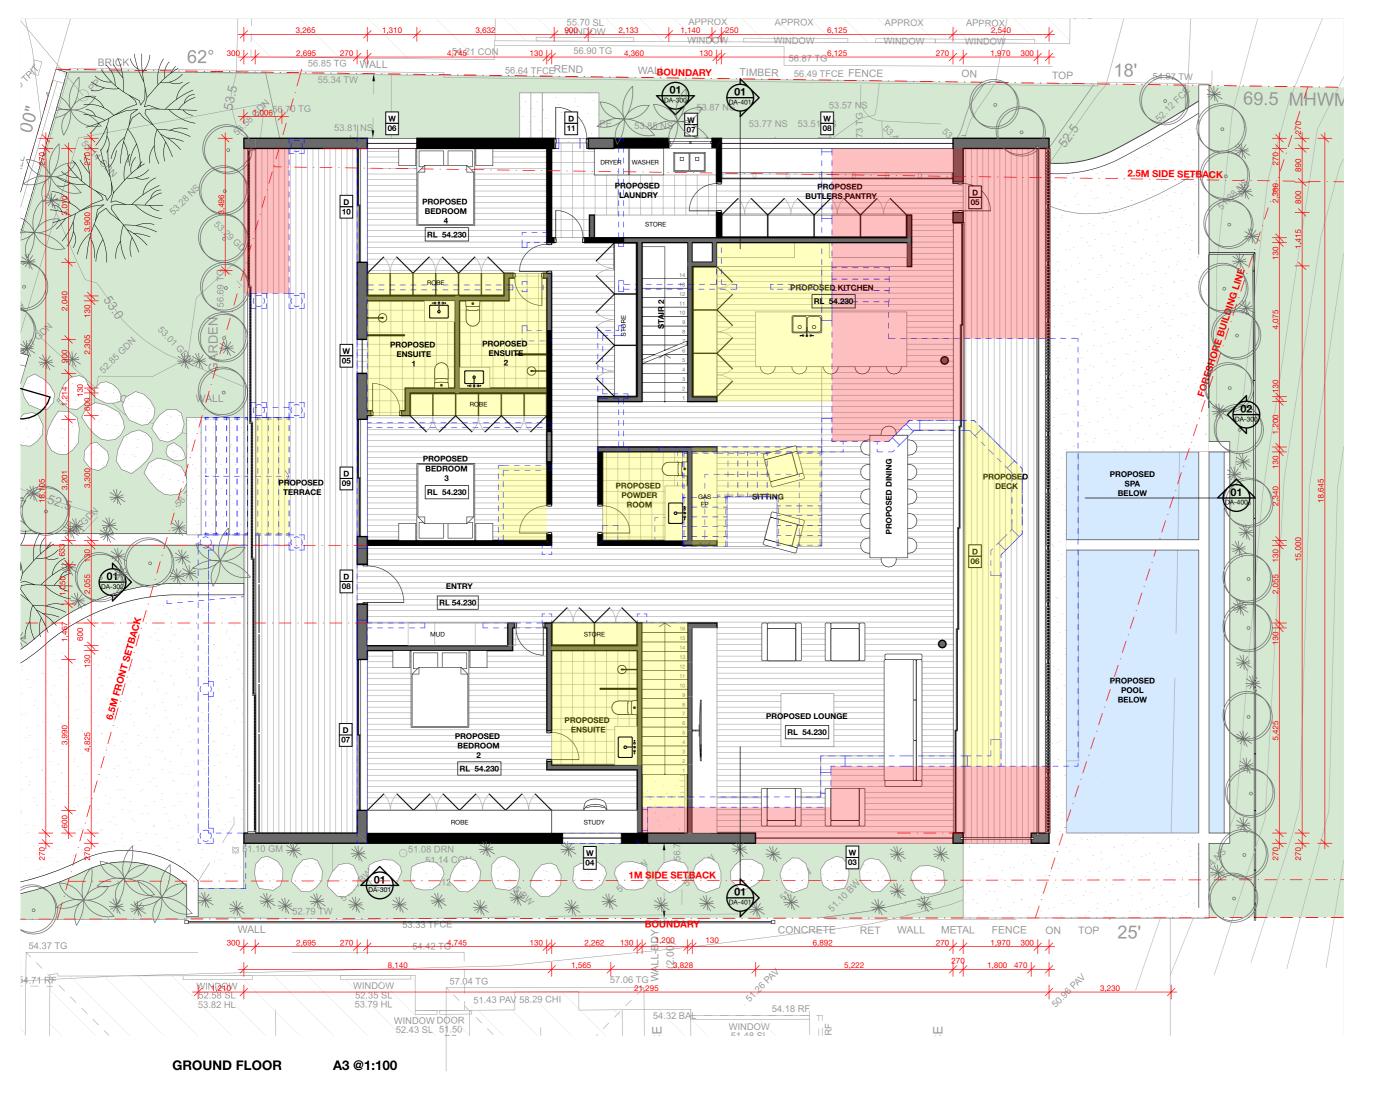


Nom
NOTE: THESE DRAWINGS ARE NOT FOR CONSTRUCTION. FOR DA APPROVAL ONLY NOTE: DO NT SCALE OFF THIS DRAWING NOTE: ALL WORKS TO BE IN ACCORDANCE WITH THE N.C.C. 2019 NOTE: ALL WORKS TO BE IN ACCORDANCE WITH THE N.C.C. 2019 NOTE: ALL WORKS TO BE IN ACCORDANCE WITH THE N.C.C. 2019 NOTE: ALL WORKS TO BE IN ACCORDANCE WITH THE BASIX REQUIREMENTS <b>KEY:</b> DENOTES EXISTING STRUCTURE TO BE RETAINED DENOTES PROPOSED NEW STRUCTURE DENOTES AREA OF SOFT LANDSCAPING DENOTES AREA OF SWIMMING POOL L DENOTES EXISTING STRUCTURE TO BE
DEMOLISHED DEMOLISHED DENOTES AREA OF PROPOSED ADDITION DENOTES AREA OF PROPOSED ALTERATIONS PROJECT: ALTERATIONS AND ADDITIONS TO EXISTING DWELLING, INCLUDING NEW SWIMMING POOL AND ASSOCIATED LANDSCAPING
CLIENT: ZLAT AND BECC JOVANOV 
PROJECT STAGE: DEVELOPMENT APPLICATION 
GENERAL ARRANGEMENT PLANS: GROUND FLOOR SCALE: 1:100 @ A3
DATE OF ISSUE: 20/11/24 DRAWING NO. DA-101
<b>REVISION:</b> 01
r a m a nominated withher Themas March Bergs J Holds All All BEACH, NEW 2107 www.amarachiteds.com


ABN 612 /13 425 COPYRIGHT OF RAMA ARCHITECTS PTY, LTD. HIS DRAWING IS NOT TO BE USED OR REPRODUCEL IN ANY FORM WITHOUT CONSENT. DO NOT SCALE FROM THIS DRAWING

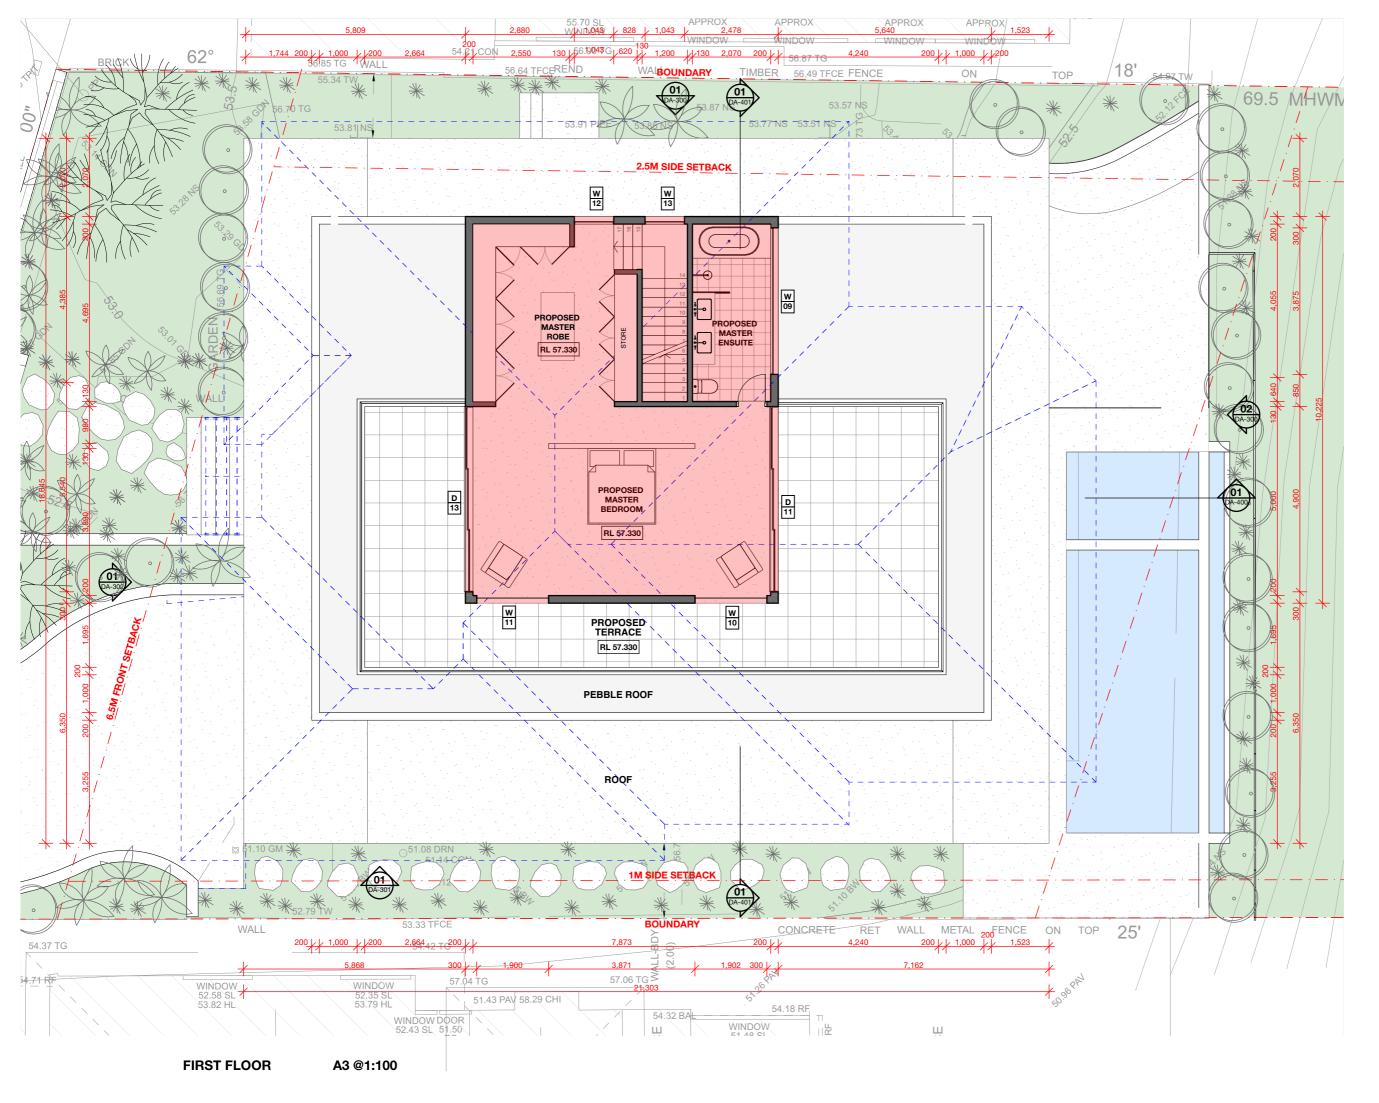

NORTH		
NOTE: THESE DRAWINGS ARE NOT FOR CONSTRUCTION. FOR DA APPROVAL ONLY NOTE: DO NOT SCALE OFF THIS DRAWING NOTE: ALL WORKS TO BE IN ACCORDANCE WITH THE N.C.C. 2019 NOTE: ALL WORKS TO BE IN ACCORDANCE WITH THE RELEVANT AN ETAIL WORKS TO BE IN ACCORDANCE WITH THE BASIX REQUIREMENTS KEY: DENOTES EXISTING		
STRUCTURE TO BE RETAINED         DENOTES PROPOSED NEW         STRUCTURE         DENOTES AREA OF SOFT         LANDSCAPING         DENOTES AREA OF SWIMMING         POOL         E = = 3         DENOTES EXISTING         STRUCTURE TO BE         DEMOLISHED         DENOTES AREA OF         PROPOSED ADDITION         DENOTES AREA OF         PROPOSED ADDITION		
PROPOSED ALTERATIONS  PROJECT: ALTERATIONS AND ADDITIONS TO EXISTING DWELLING, INCLUDING NEW SWIMMING POOL AND ASSOCIATED LANDSCAPING  CLIENT: ZLAT AND BECC JOVANOV  LOCATION:		
22 HILLCREST AVENUE, MONA VALE, NSW  PROJECT STAGE: DEVELOPMENT APPLICATION  DRAWING TITLE: GENERAL ARRANGEMENT PLANS: FIRST FLOOR		
SCALE: 1:100 @ A3 DATE OF ISSUE: 20/11/24		
DRAWING NO. DA-102 REVISION: 01		
r a m a normatical achiect reas a 10033 & / 20 AMACE NORMACE AMALON BLOCK, NOW 2107 www.armatchiects.com		


ABN 612 713 425 COPYRIGHT OF RAMA ARCHITECTS PTY. LTD. HIS DRAWING IS NOT TO BE USED OR REPRODUCED IN ANY FORM WITHOUT CONSENT. DO NOT SCALE FROM THIS DRAWING

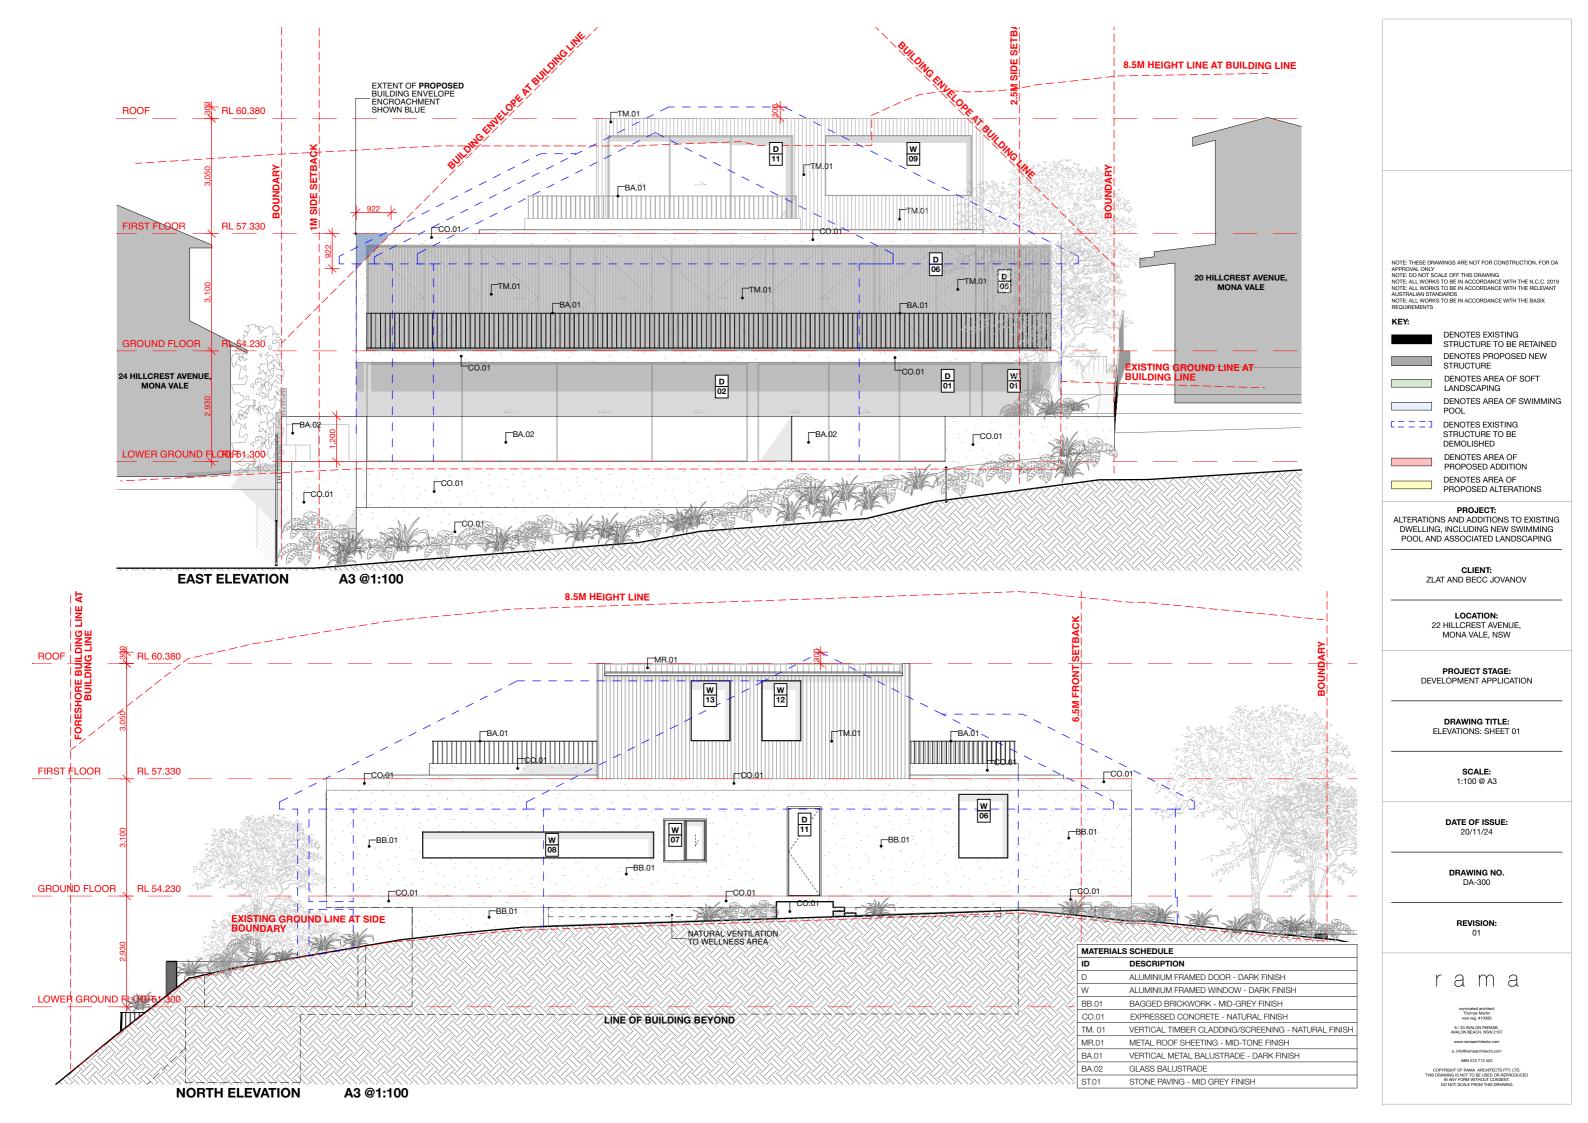

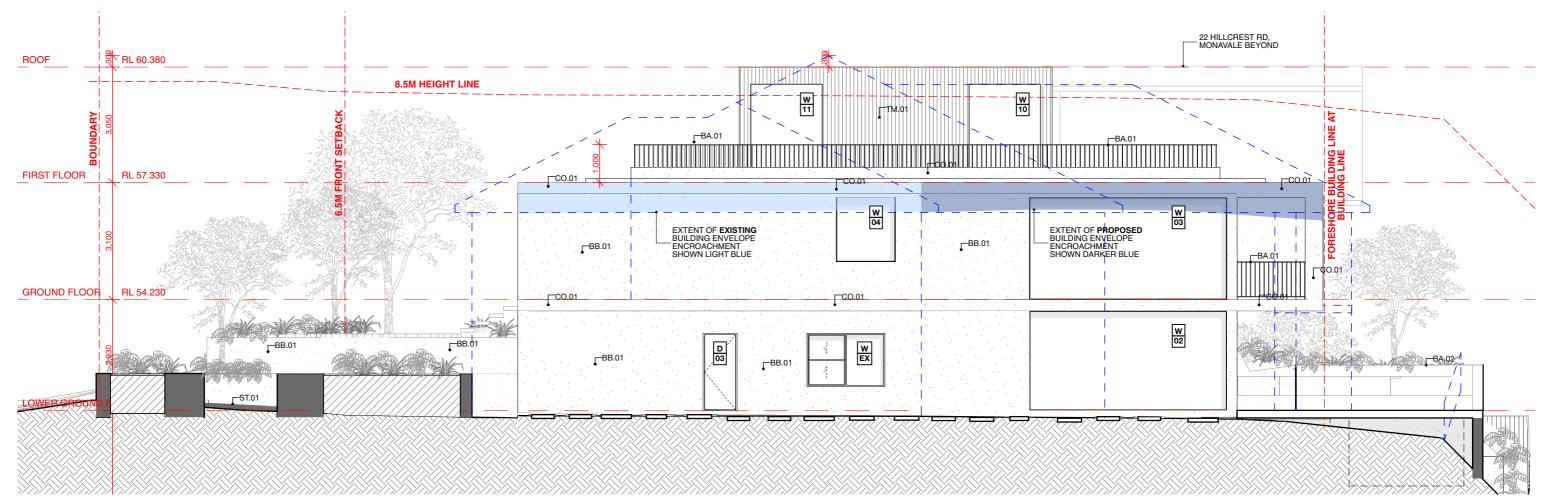


SOUTH ELEVATION


A3 @1:100

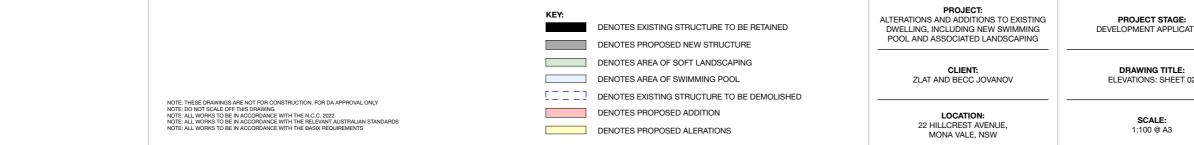


MATERIALS SCHEDULE			
ID DESCRIPTION			
D	ALUMINIUM FRAMED DOOR - DARK FINISH		
W	ALUMINIUM FRAMED WINDOW - DARK FINISH		
BB.01	BAGGED BRICKWORK - MID-GREY FINISH		
CO.01	EXPRESSED CONCRETE - NATURAL FINISH		
TM. 01	VERTICAL TIMBER CLADDING/SCREENING - NATURAL FINISH		
MR.01	METAL ROOF SHEETING - MID-TONE FINISH		
BA.01	VERTICAL METAL BALUSTRADE - DARK FINISH		
BA.02	GLASS BALUSTRADE		
ST.01	STONE PAVING - MID GREY FINISH		

AGE: PLICATION	<b>DATE OF ISSUE:</b> 20/11/24	r a m a
TLE: EET 02	DRAWING NO. DA-301	nominated architect Thomas Marits new mg. #1033 6 / 20 ANLON IPAGADE. AVALON IBACH, NSW 2107 www.umasarchitects.com
3	REVISION: 01	e. Info@ramaarchitects.com ABN 612 73 425 CoPrecision for EnAwa, Acchinectos, pry LTD, THIS DRAWING IS NOT TO BE USED OR REPRODUCED IN IAW FORM WITHOUT CONSENT. DO NOT SCALE FROM THIS DRAWING

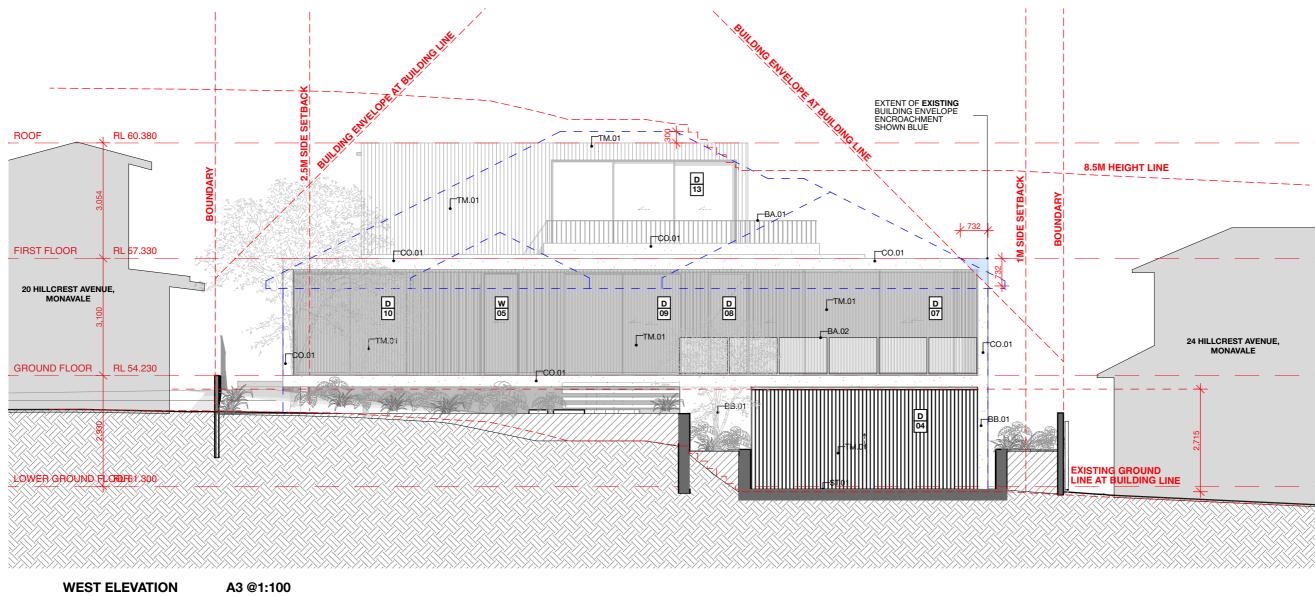

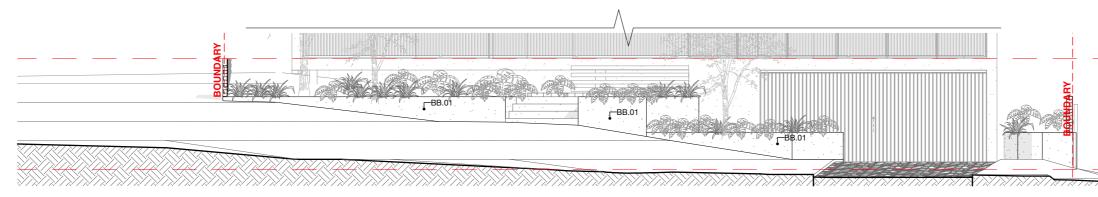


FRONT FENCE ELEVATION A3 @1:100

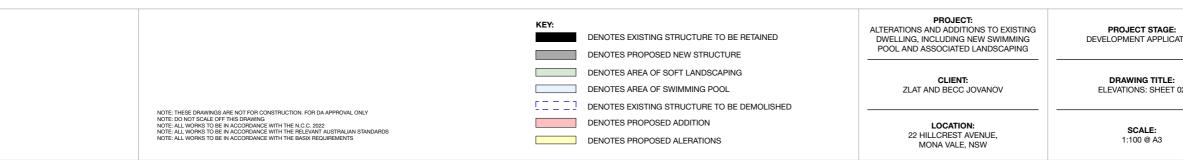



ID DESCRIPTION	
D ALUMINIUM FRAMED DOOR - DARK FINISH	
W	ALUMINIUM FRAMED WINDOW - DARK FINISH
BB.01	BAGGED BRICKWORK - MID-GREY FINISH
CO.01	EXPRESSED CONCRETE - NATURAL FINISH
TM. 01	VERTICAL TIMBER CLADDING/SCREENING - NATURAL FINISH
MR.01	METAL ROOF SHEETING - MID-TONE FINISH
BA.01	VERTICAL METAL BALUSTRADE - DARK FINISH
BA.02	GLASS BALUSTRADE
ST.01 STONE PAVING - MID GREY FINISH	


AGE: PLICATION	<b>DATE OF ISSUE:</b> 20/11/24	rama
<b>'LE:</b> EET 02	DRAWING NO. DA-302	nominated architect Thomas Martin new reg. #1088 6 / 20 AWALON PARADE. AWALON BEACH, NWX 1007 www.ramaarchitects.com
5	REVISION: 01	e. info@ramaarchitects.com ABN 612 713 425 COPYRIGHT OF RAMA. ARCHITECTS PTY. LTD. THIS DRAWING IS NOT TO BE USED OR REPRODUCED IN ARY FORM WITHOUT CONSENT. DO NOT SCALE FROM WITHOUT CONSENT.

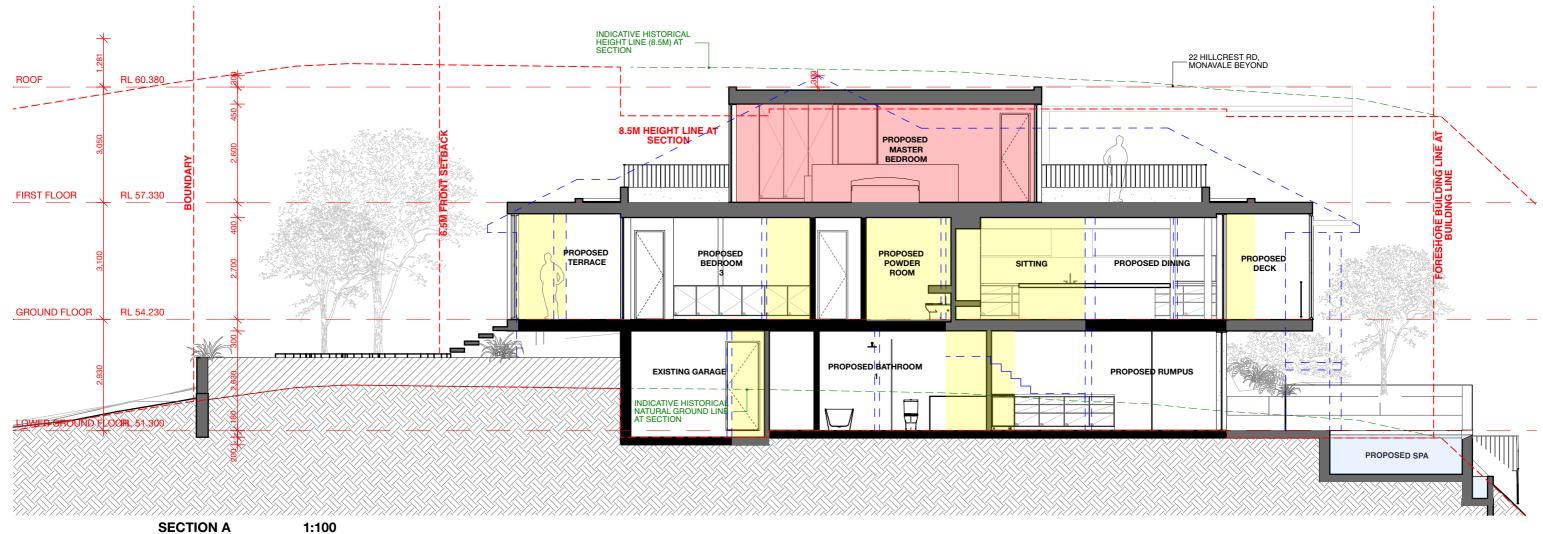

**SECTION A** 

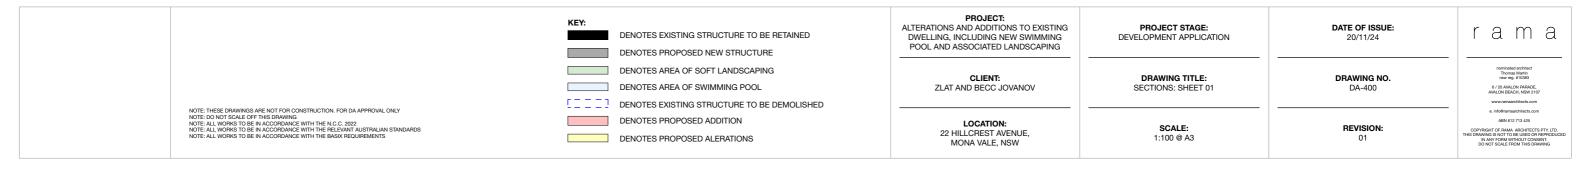


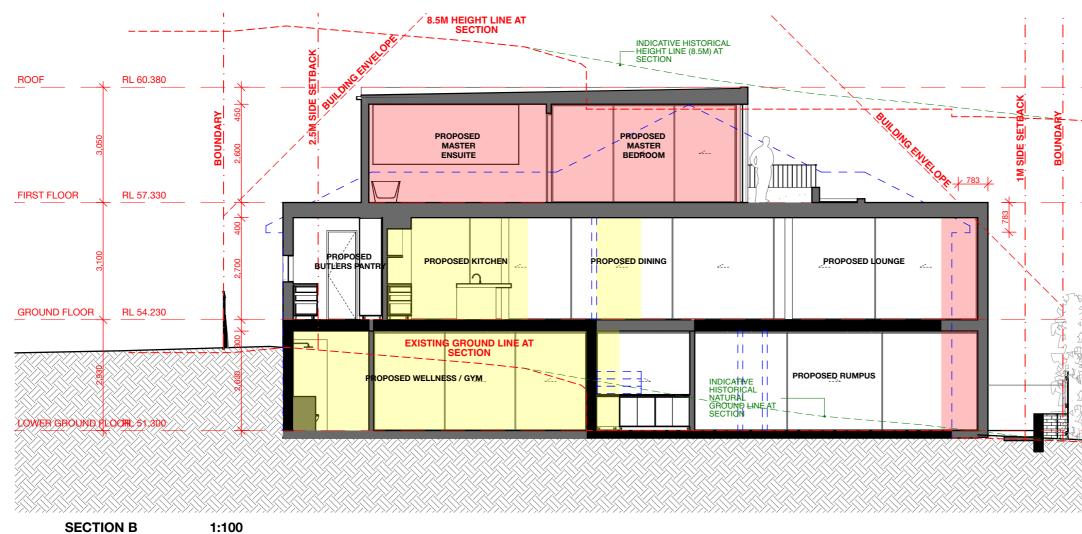

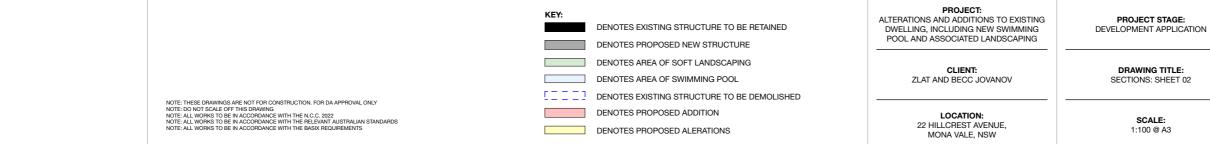



 
 Definition
 Date of issue: 20/11/24
 Image: Constraint of the constraint of the

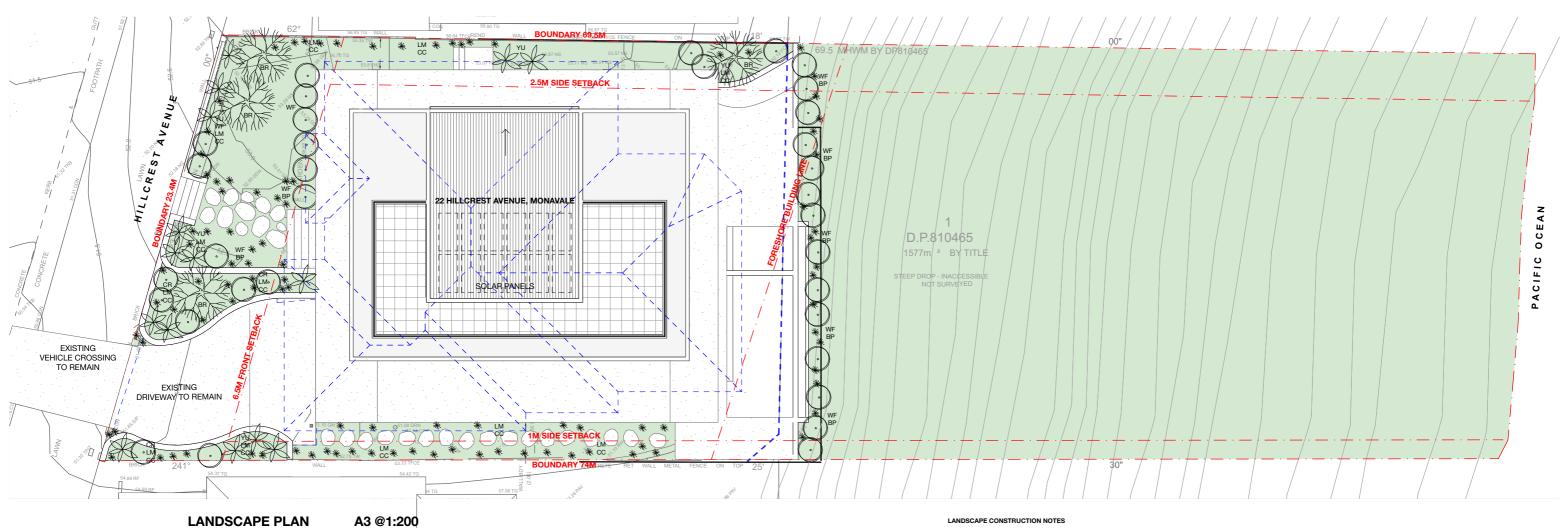

# TREE PROTECTION All trees nominated to be retained are to be protected throughout the duration of the demolition and All trees nominated to be retained are to be protected throughout the duration of the demolition and construction periods. All tree protection enclosures must be established prior to commencement of demolition works and shall comprise a fence enclosure around the TPZ of the tree. The project Arborist must be present to supervise any excavation, trenching or tunneling within the PZ of any retained trees if required. Keep the area within the enclosure free of construction material and debris. Do not place bulk materials and harmful materials under or near trees. Do not place spoil from excavations against tree trunks. Prevent wind- blown materials such as cement from harming trees and plants. Do not cut tree roots exceeding 50mm diameter. Where it is necessary to cut tree roots, use handsaw, cut cleanly, do not nip with machinery and such that the cutting does not unduly disturb the remaining root system.

system. If damage does occur to a tree, the project Arborist is to attend prior to repairing damage and during repair work. If a tree is damaged and repair work is considered impractical, or is attempted and fails, give notice and obtain instructions.

#### SUBSOIL

SUBSOIL Excavate to bring the subsoil to a minimum of 300mm below finished design levels, to allow for infilling with topsoil mix. Break up the soil to a further depth of 100mm. Remove all building rubble, waste oil, cement and other material harmful to plant growth from planting beds prior to placement of topsoil. Cultivate to a minimum depth of 100mm over areas to be planted or grassed. Do not disturb services or tree roots; if necessary, cultivate these areas by hand. During cultivation, thoroughly mix in materials required to be incorporated in to the subsoil. Remove stones exceeding 25mm, clode of earth exceeding 60mm, and weeds, rubbish or other deleterious material brought to the surface during cultivation. Tim the surface to the required design levels after cultivation. Confirm that the planting beds are free draining. If not install sub-soil drainage lines and connect to stormwater system. Apply additives after ripping or cultivation and incorporate into the upper 100mm layer of the subsoil.

#### TOPSOIL

Where possible use site topsoil and compost mixed at a rate of 4 soil : 1 compost, thoroughly mixed Where possible use site topsoil and compost mixed at a rate of 4 soil : 1 compost, thoroughly mixed before placement. If imported soil is required soil shall be same or similar to Australian Native Landscapes Premium garden mix or similar for garden bed areas or Turl Underlay mix for turl areas. Spread topsoil on the prepared subsoil and grade evenly, making the necessary allowances so that required finished levels and contours are achieved after light compaction. Compact lightly and uniformly in 150mm layers. Avoid differential subsidence and excess compaction and produce a finished topsoil surface which is ready for planting.

Spread topsoil to the following typical depths: Planting beds: 300mm Grass areas: 100mm

LOCATION: 22 HILLCREST AVENUE,

MONA VALE, NSW

PI ANTING trees: excavate a plant hole to twice the diameter of the root ball and at least 100mm deeper than the root ball. break up the base of the hole to a further depth of 100mm, and loosen the compacted sides of the

hole. shrubs/ground covers: excavate a hole big enough for the plant plus 100mm all round, provide plants which have large healthy root systems, with no evidence of root curl, restriction or damage, are vigorous, well established, free from disease and pests, of good form consistent with the species or variety, and are hardened off, not soft or forced, and suitable for planting in the natural climatic conditions prevailing at the site. Trees: provide trees which, unless required to be multi-stemmed, have a single leading shoot. trees

PROJECT: ALTERATIONS AND ADDITIONS TO EXISTING PROJECT STAGE: DWELLING INCLUDING NEW SWIMMING DEVELOPMENT APPLICATION POOL AND ASSOCIATED LANDSCAPING DRAWING TITLE: CLIENT: ZLAT AND BECC JOVANOV

SITE STRATEGY PLANS: LANDSCAPE CONCEPT PLANS

SCALE: 1:200 @ A3

LANDSCAPE LEGEND ID DESCRIPTION N/ PROPOSED TREE PROPOSED SHRUBS AND ACCENTS PROPOSED GRASSES AND GROUNDS COVERS \*\* PROPOSED LANDSCAPED AREA PROPOSED POOL AREA

PLANT SCHEDULE						
ID	QUANTITY	BOTANICAL NAME	COMMON NAME	SIZE		
TREES						
BR	4	BANKSIA ROBUR	SWAMP BANKSIA	75L		
SHRUB	S/ACCENTS					
WF	22	WESTRINGRIA FRUITCOSA	COASTAL ROSEMARY	300MM		
YU	14	YUKKA ELEPHANTIPES	YUKKA	500MM		
CR	8	CORREA ALBA	WHITE NATIVE FUSCHIA	200MM		
GRASSES/GROUND COVERS						
BP	34	BANKSIA SPINULOSA	BIRTHDAY CANDLES BANKSIA	150MM		
CC	42	CASUARINA GLAUCA	COUSIN IT GRASS	150MM		
LM	54	LIROPE 'EVERGREEN GIANT'	GIANT MONDO GRASS	150MM		

NOTE: THESE DRAWINGS ARE NOT FOR CONSTRUCTION. FOR DA APPROVAL ONLY NOTE: DO NOT SCALE OFF THIS DRAWING NOTE: ALL WORKS TO BE IN ACCORDANCE WITH THE N.C.C. 2022 NOTE: ALL WORKS TO BE IN ACCORDANCE WITH THE RELEVANT AUSTRALIAN STANDARDS NOTE: ALL WORKS TO BE IN ACCORDANCE WITH THE BASIX REQUIREMENTS

DENOTES EXISTING STRUCTURE TO BE RETAINED

DENOTES PROPOSED NEW STRUCTURE

DENOTES AREA OF SOFT LANDSCAPING

DENOTES AREA OF SWIMMING POOL


DENOTES EXISTING STRUCTURE TO BE DEMOLISHED

DENOTES PROPOSED ADDITION

DENOTES PROPOSED ALERATIONS

[]]] 

KEY:

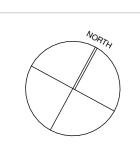

should be staked as specified. Label at least one plant of each species or variety in a batch using a durable, readable tag. do not plant in unsuitable weather conditions such as extreme heat, cold, wind or rain. in other than sandy soils, suspend excavation when the soil is wet, or during frost periods. When the hold is of the correct size, remove the plant from the container with minimum disturbance to the root ball. ensure that the root ball is moist and place in the final position, in the hole and plumb, with the top soil level of the plant root ball level with the finished surface of the surrounding soil, or 75mm below paving level to allow placement of mulch. backfill with topsoil mixture. Igitply tamp and water to eliminate air pockets. ensure that topsoil is not placed over the top of the rootball, so that the plant stem is the same height as in the container. Thoroughly water plants before planting and immediately after planting. In planting beds and individual plantings, place slow release fertiliser pellets around plants at the time of planting at the rate recommended by the manufacturer.

#### MULCHING

All garden bed areas are to be mulched to 75mm depth with same or similar to Forest Blend. Provide mulch/gravel which is free of deleterious and extraneous matter such as stones, soil, weeds and sticks. Place mulch/gravel clear of plant stems, and rake to an even surface flush with the surrounding finished levels.

FERTILISER

Fertiliser is to be slow release fertiliser equivalent to "Osmocote" and is to be applied at manufacturer's specified rates

DRAINAGE

Envirued: Ensure adequate drainage to all garden beds, gravel and lawn areas. Install 100mm agricultural pipe with sock as required in garden beds and behind all retaining walls. Agricultural pipes to drain to junction pit, and connect to stormwater system. Ensure paved areas are free draining, Install pits if required. (Refer to Hydraulic Engineering).

#### RETAINING WALLS

Retaining walls to be constructed as per Engineer's details.

#### CONCRETE WORKS

AURATION AND A CONTRACT AND A CONTRA

MAINTENANCE Throughout the planting establishment period (minimum 12 weeks), carry out maintenance work including watering, mowing, weeding, rubbish memoval, fertilising, pest and disease control, reseeding, returning, staking and trying, replanting, outlivating, purung, hedges clipping, aerating, reinstatement of mulch, renovating, top dressing and keeping the site neat and tidy. Continue to replace failed, damaged or stolen plants

> DATE OF ISSUE: 20/11/24

DRAWING NO. DA-500

Thomas Martin nsw reg. #10383

r a m a


6 / 20 AVALON PARADE, AVALON BEACH, NSW 2103 www.ramaarchitects.cor


e. info@ramaarchitects.com


ABN 612 713 425

OF RAMA ARCHITECTS S NOT TO BE USED OR R IN ANY FORM WITHOUT DO NOT SCALE FROM TH

REVISION 01

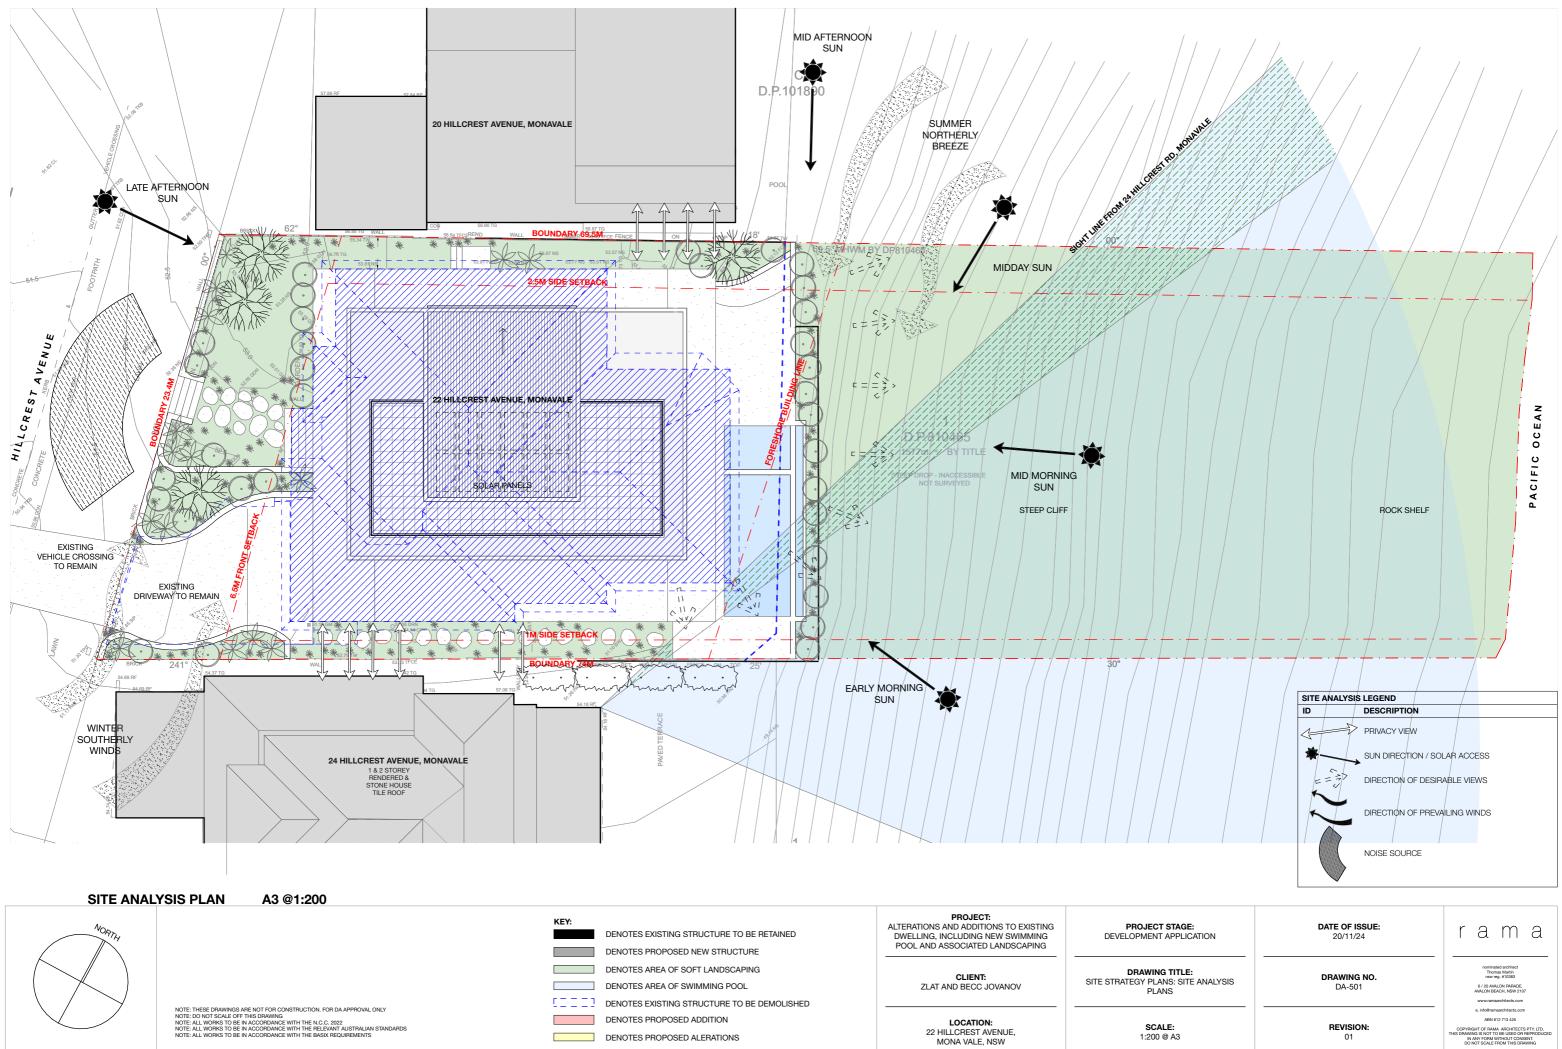

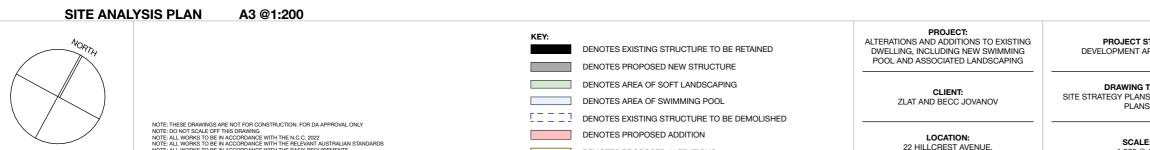

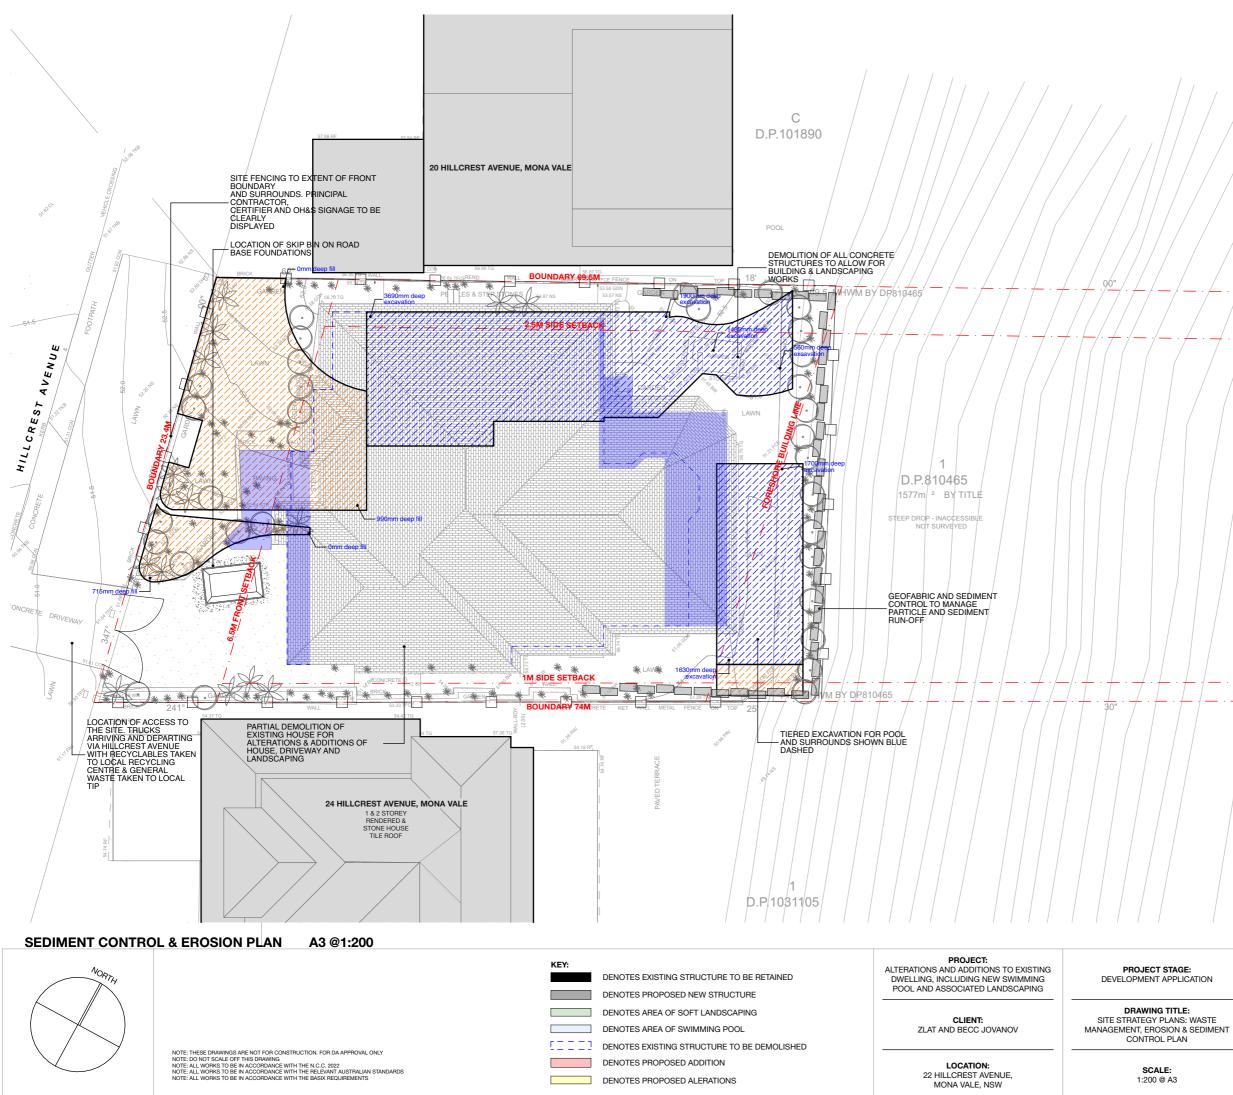

		PACIFIC OCEAN
	SEDIMENT EROSION CONTROL LEG	iEND
	ID DESCRIPTION HAY BAIL AND GEOFABRI	с
	SKIP BIN ON ROAD BASE	FOUNDATIONS
	EXTENT OF DEMOLITION	
	EXTENT OF FILL	
	EXTENT OF EXCAVATION	
IE: ICATION	<b>DATE OF ISSUE:</b> 20/11/24	r a m a

DRAWING NO. DA-502


Thomas Martin nsw reg. #10383 6 / 20 AVALON PARADE, AVALON BEACH, NSW 2107


www.ramaarchitects.com


e. info@ramaarchitects.com ABN 612 713 425


**REVISION:** 01

T OF RAMA ARCHITECTS RAWING IS NOT TO BE USED IN ANY FORM WITHOUT ( DO NOT SCALE FROM THI

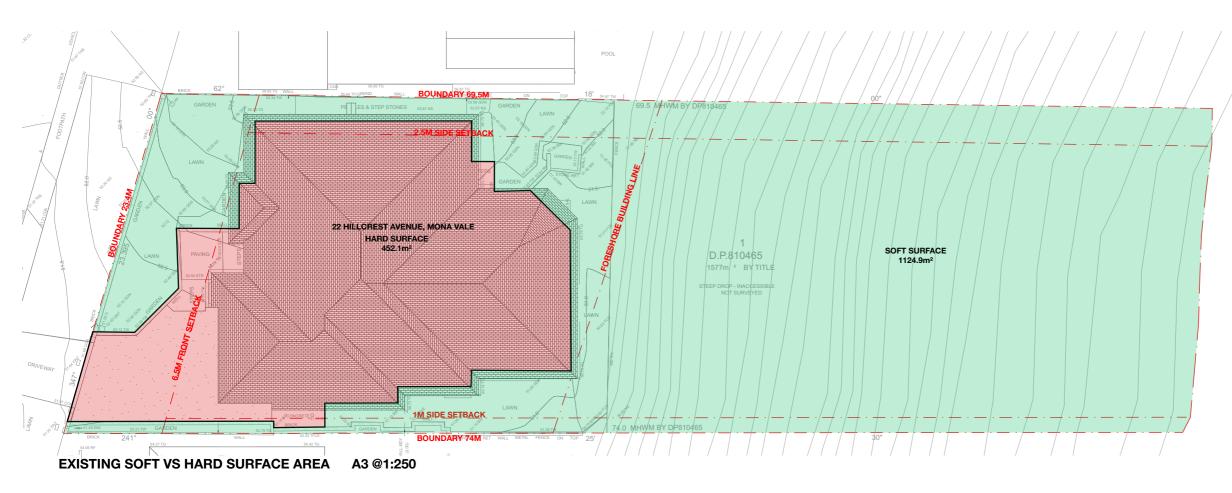

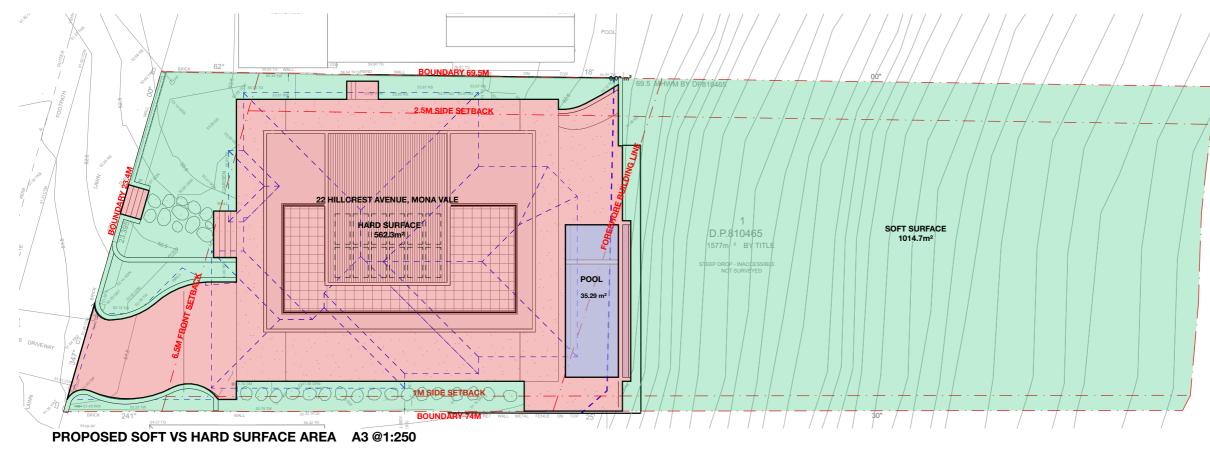

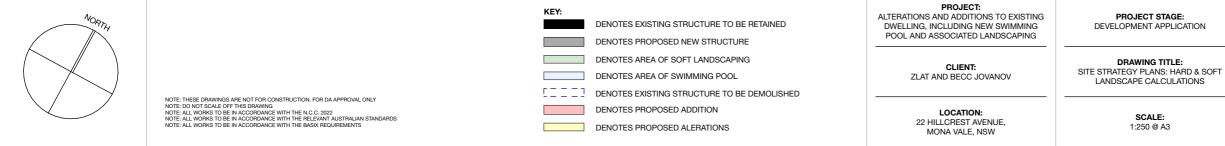

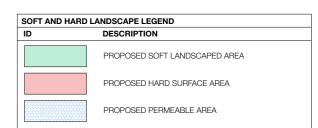

### EXISTING LANDSCAPE CALCULATIONS

TOTAL SITE LANDSCAPED OPEN SPACE HARD SURFACE

1577m<sup>2</sup>

1124.9m<sup>2</sup> or 71.3% 452.1m<sup>2</sup> or 28.7%

#### PROPOSED LANDSCAPE CALCULATIONS

TOTAL SITE

1577m<sup>2</sup>

LANDSCAPED OPEN SPACE HARD SURFACE (INCL. POOL)

1014.7m<sup>2</sup> or 64.4%

562.3m<sup>2</sup> or 35.6%

POOL AREA

35.29m<sup>2</sup>

DATE OF ISSUE: 20/11/24

DRAWING NO. DA-503

Thomas Martin nsw reg. #10383 6 / 20 AVALON PARADE, AVALON BEACH, NSW 2107


r a m a

www.ramaarchitects.com


e. info@ramaarchitects.com ABN 612 713 425

T OF RAMA ARCHITECTS P IS NOT TO BE USED OR RE RAWING IS NOT TO BE GOLD . IN ANY FORM WITHOUT CONS DO NOT SCALE FROM THIS DP


**REVISION:** 01

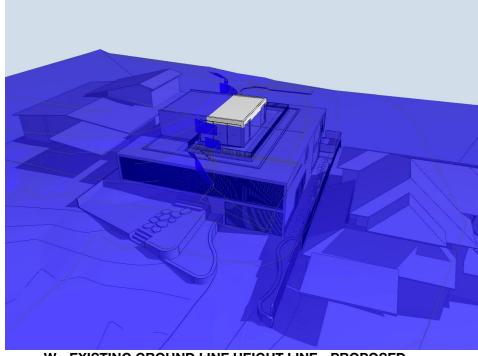


W - EXISTING GROUND LINE HEIGHT LINE - PROPOSED

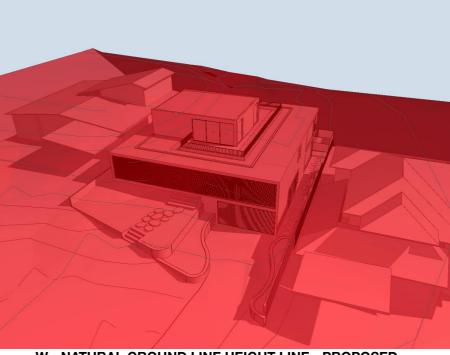


W - NATURAL GROUND LINE HEIGHT LINE - PROPOSED

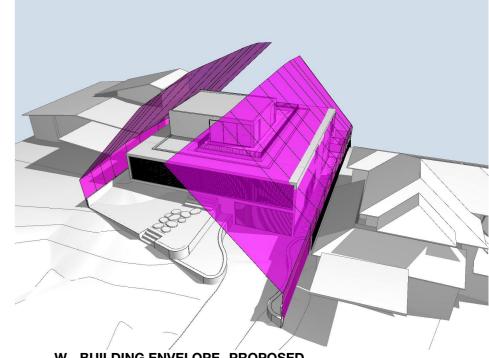


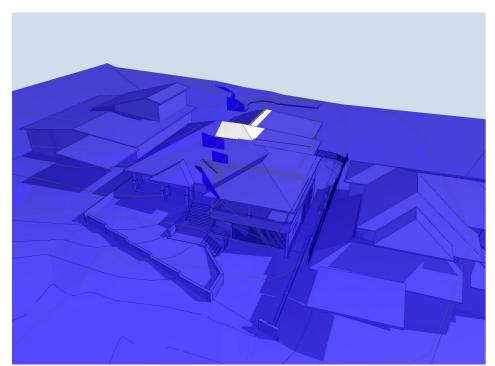


W - EXISTING GROUND LINE HEIGHT LINE - EXISTING

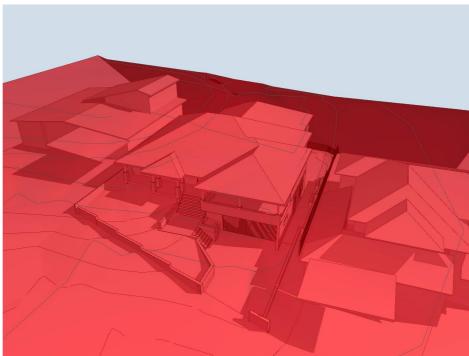

W - NATURAL GROUND LINE HEIGHT LINE - EXISTING

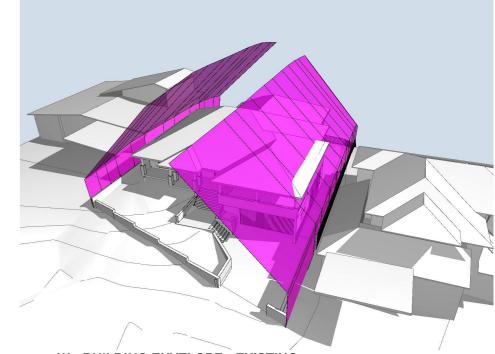

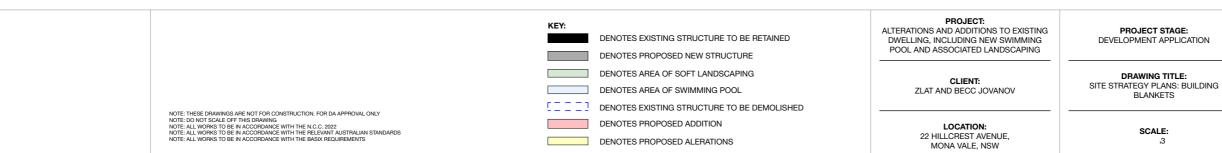

W - BUILDING ENVELOPE - PROPOSED

W - BUILDING ENVELOPE - EXISTING

**DATE OF ISSUE:** 20/11/24

DRAWING NO. DA-504

Thomas Martin nsw reg. #10383


6 / 20 AVALON PARADE, WALON BEACH, NSW 210


ABN 612 713 425


r a m a

**REVISION:** 01

RAMA ARCHITE IN ANY

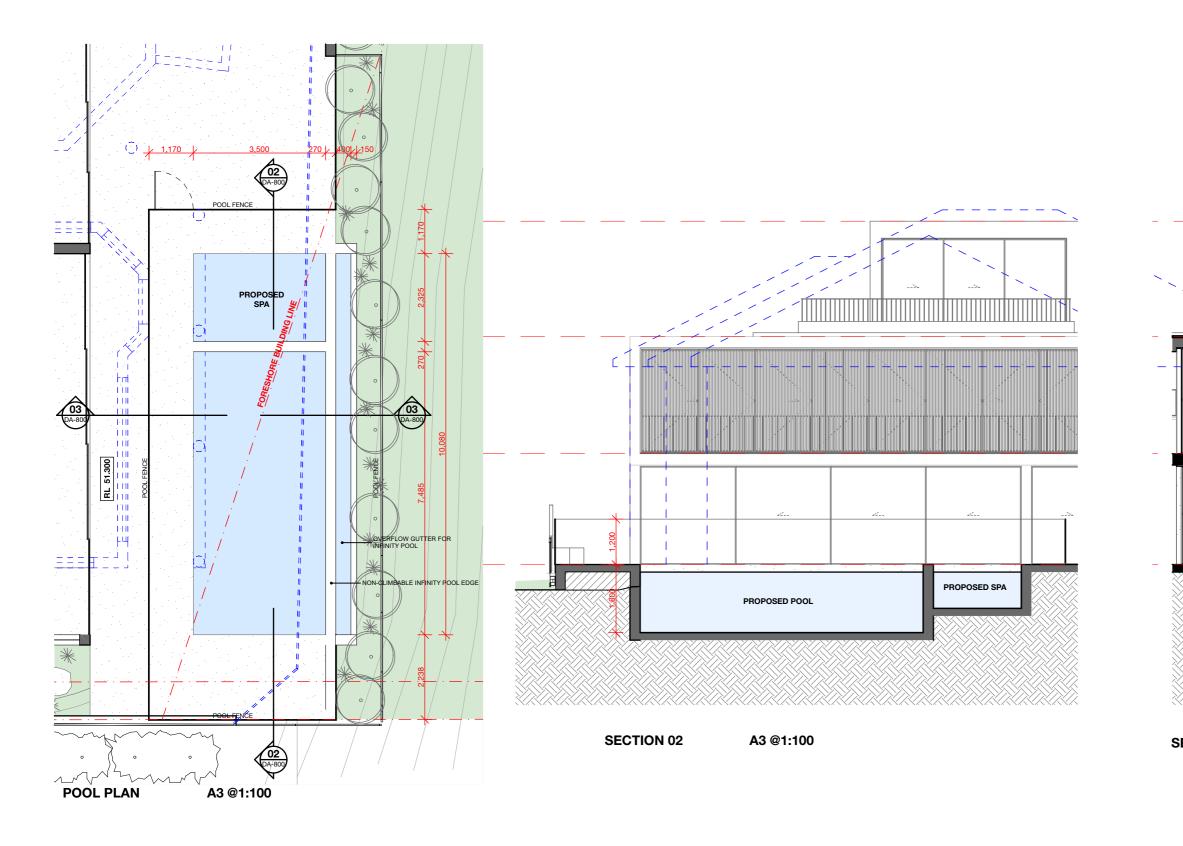

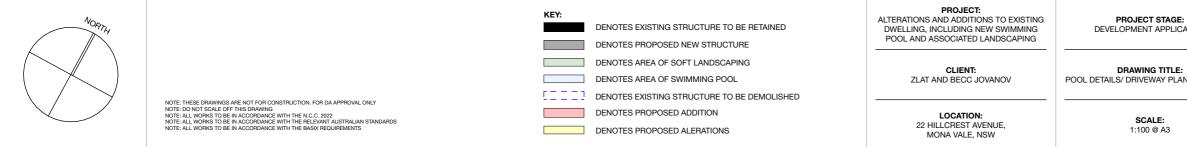


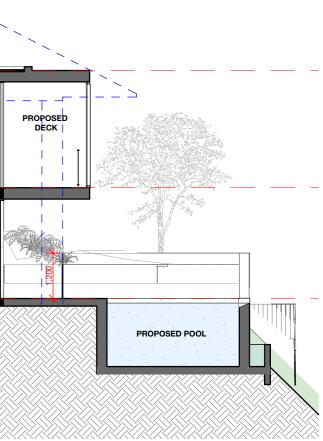


**SECTION 03** 

A3 @1:100

<b>SE:</b> ICATION	<b>DATE OF ISSUE:</b> 20/11/24	r a m a
E: LANS: SHEET 01	DRAWING NO. DA-800	nominated architect Thomas Martin new reg. #10830 6 / 20 AWALON PARADE AWALON BEACH, NSW 2107 www.amaarchitects.com
	REVISION: 01	e. Info@ramaarchitects.com ABN 012 713 425 COPPRIGHT OF RAMA, AR-VIETGTS PTV LTD. THIS DRAWING IS NOT TO BE USED OR REPRODUCED IN RAYY FORM WITHOUT CONSENT. DO NOT SCALE FROM THIS DRAWING

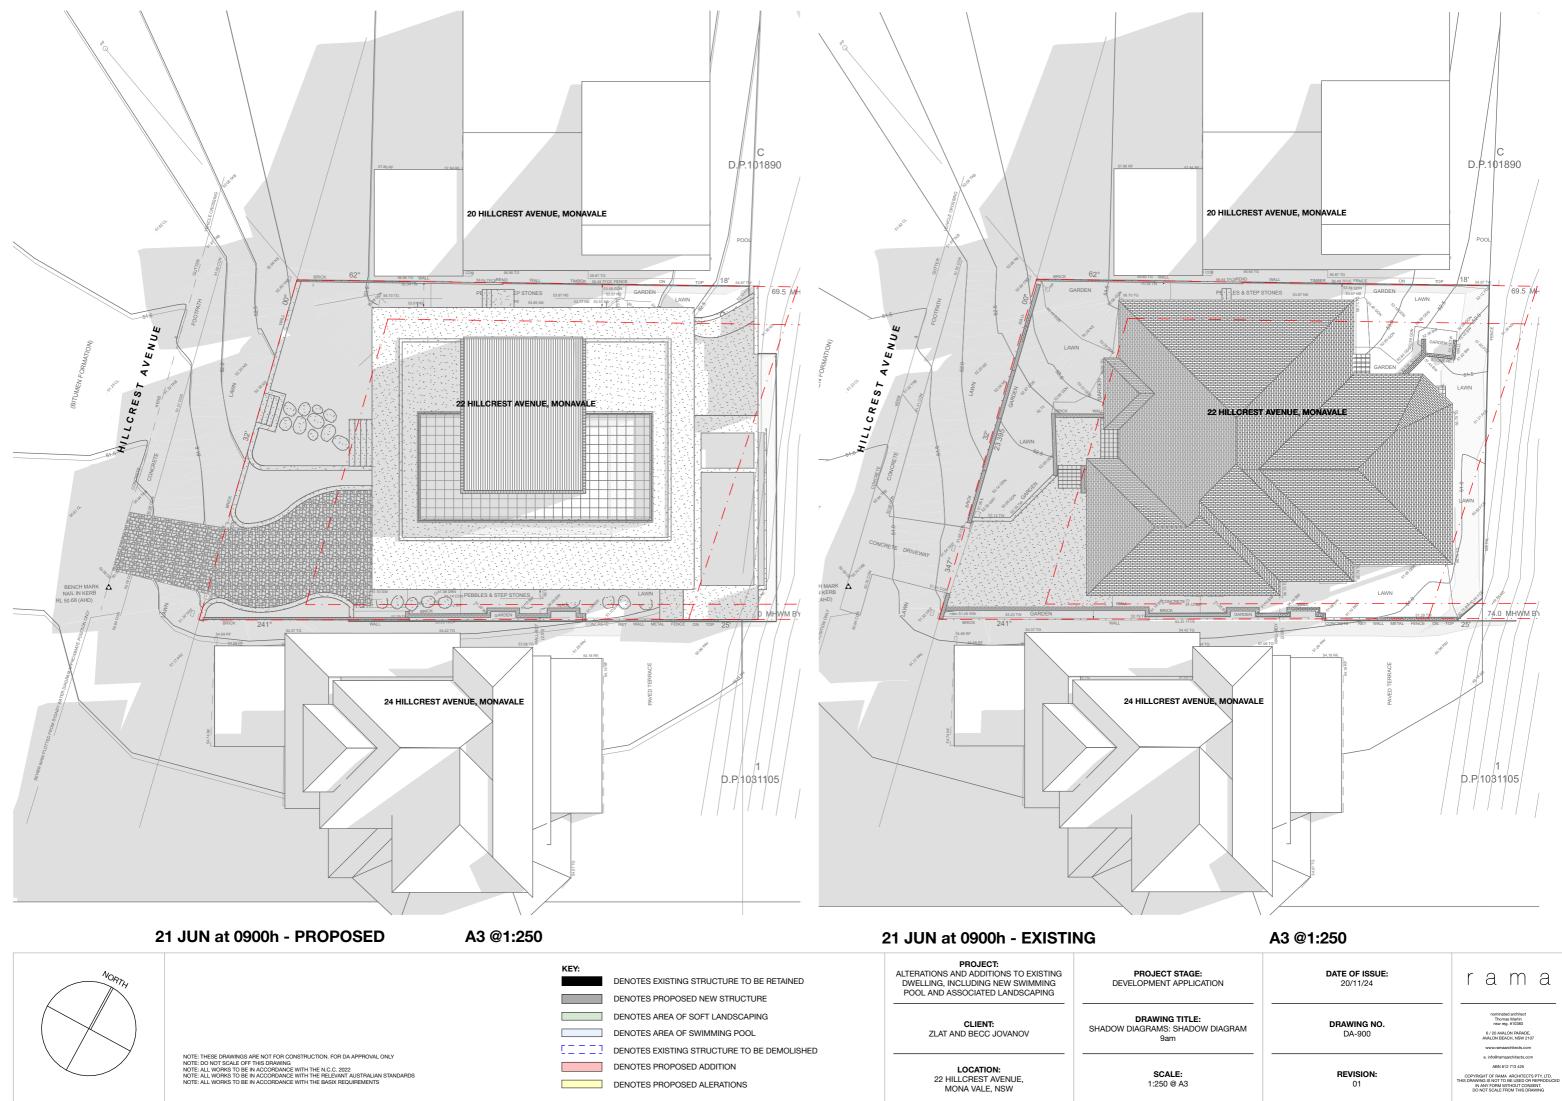

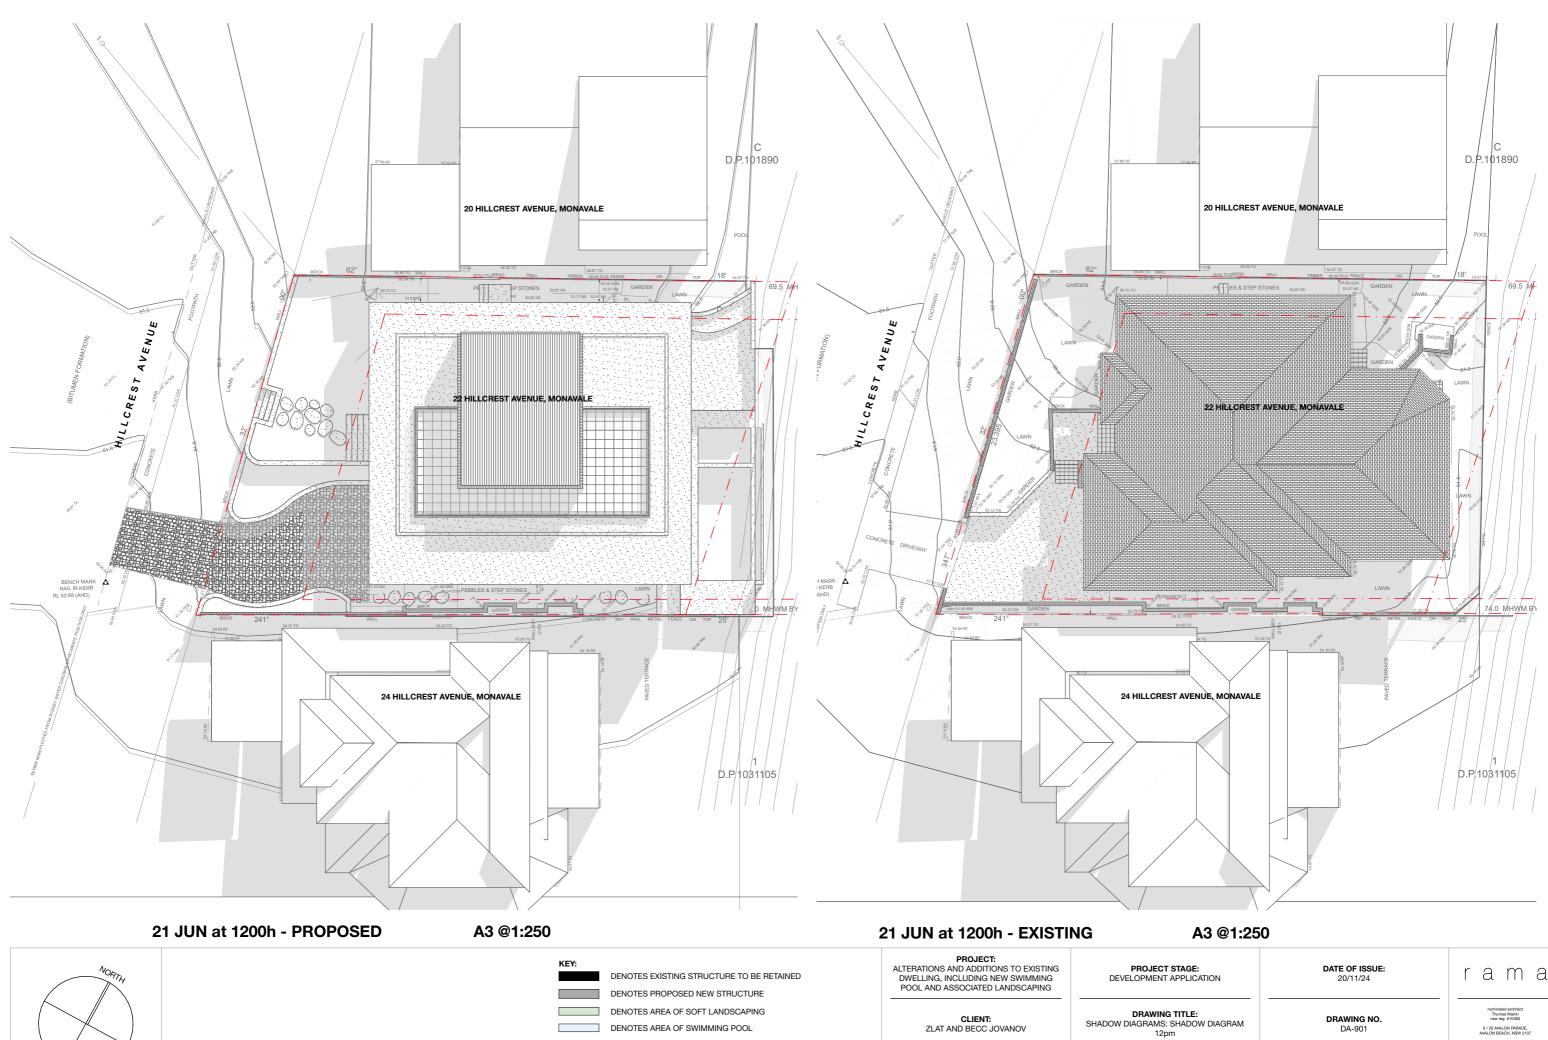

NOTE: THESE DRAWINGS ARE NOT FOR CONSTRUCTION. FOR DA APPROVAL ONLY NOTE: DO NOT SCALE OFF THIS DRAWING NOTE: ALL WORKS TO BE IN ACCORDANCE WITH THE N.C.C. 2022 NOTE: ALL WORKS TO BE IN ACCORDANCE WITH THE RELEVANT AUSTRALIAN STANDARDS NOTE: ALL WORKS TO BE IN ACCORDANCE WITH THE BASIN REQUIREMENTS


[] ] ] ] DENOTES EXISTING STRUCTURE TO BE DEMOLISHED DENOTES PROPOSED ADDITION

DENOTES PROPOSED ALERATIONS

LOCATION: 22 HILLCREST AVENUE, MONA VALE, NSW

SCALE: 1:250 @ A3

r a m a www.ramaarchitects.com e. info@ramaarchitects.com ABN 612 713 425 **REVISION:** DPYRIGHT OF RAMA ARCHITECTS P DRAWING IS NOT TO BE USED OR RE IN ANY FORM WITHOUT CONSEN DO NOT SCALE FROM THIS DRAW 01

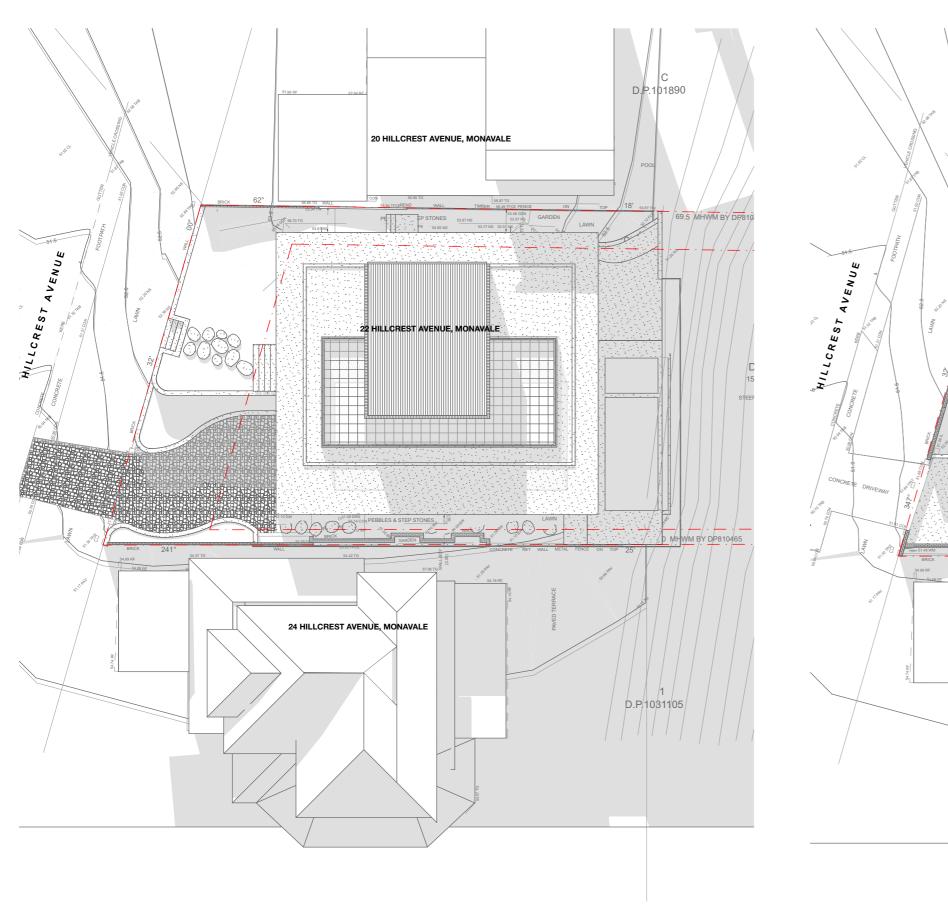

A3 @1:250


21 JUN at 1500h - PROPOSED


## 21 JUN at 1500h - EXISTING

GARDEN

-

241

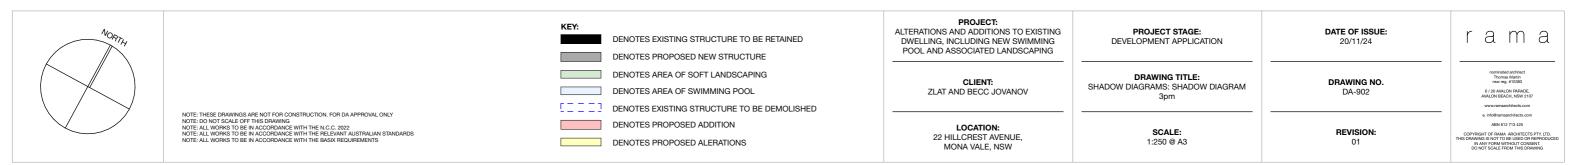

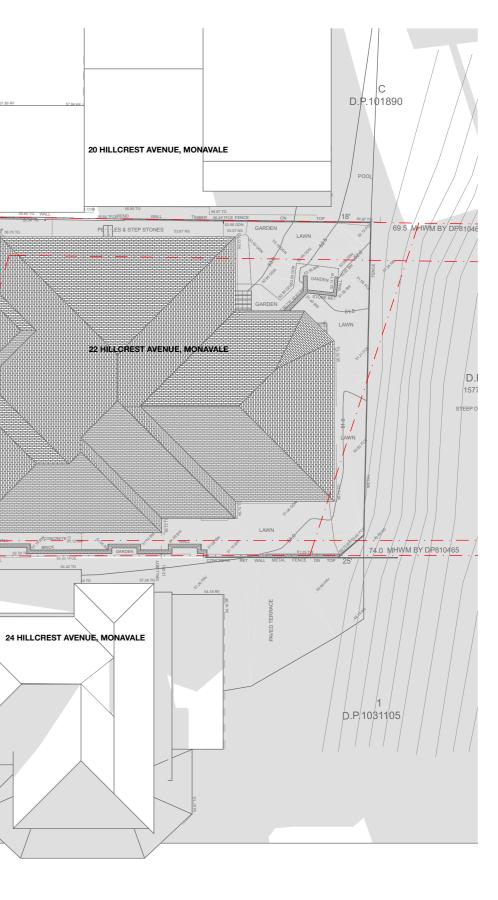

A3 @1:250