




**SITE DRAINAGE PLAN**  
SCALE 1:100

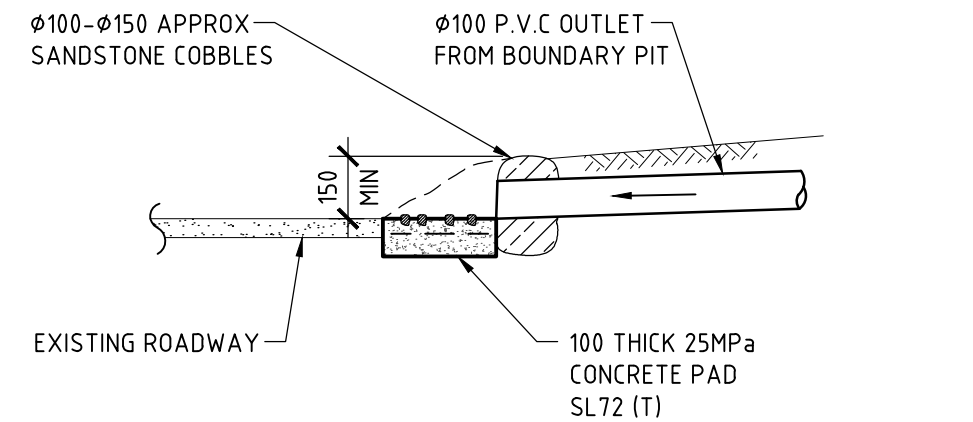


**SECTION ELEVATION**

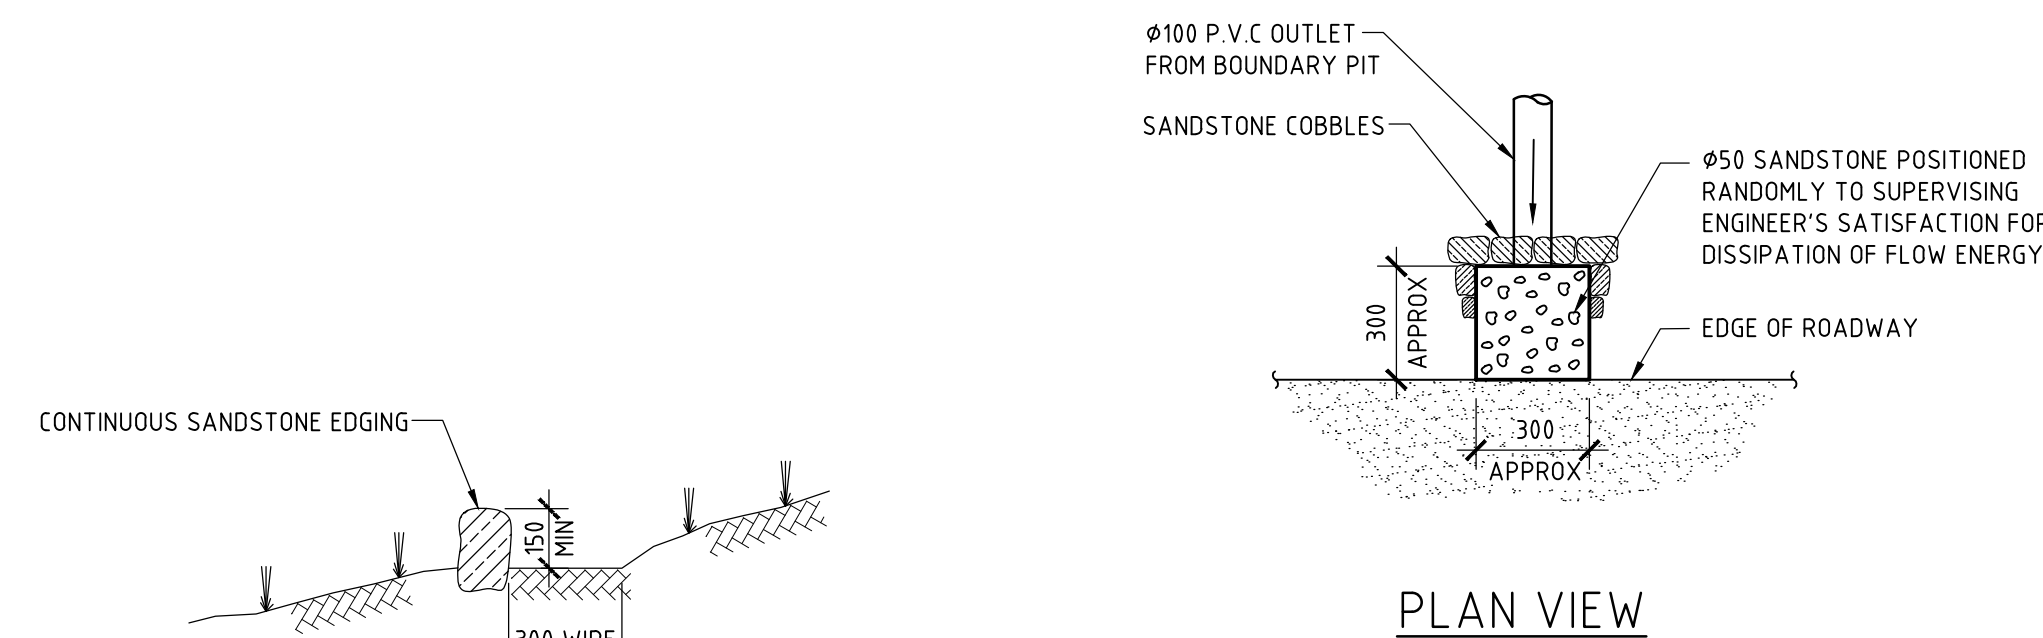


**PLAN VIEW**

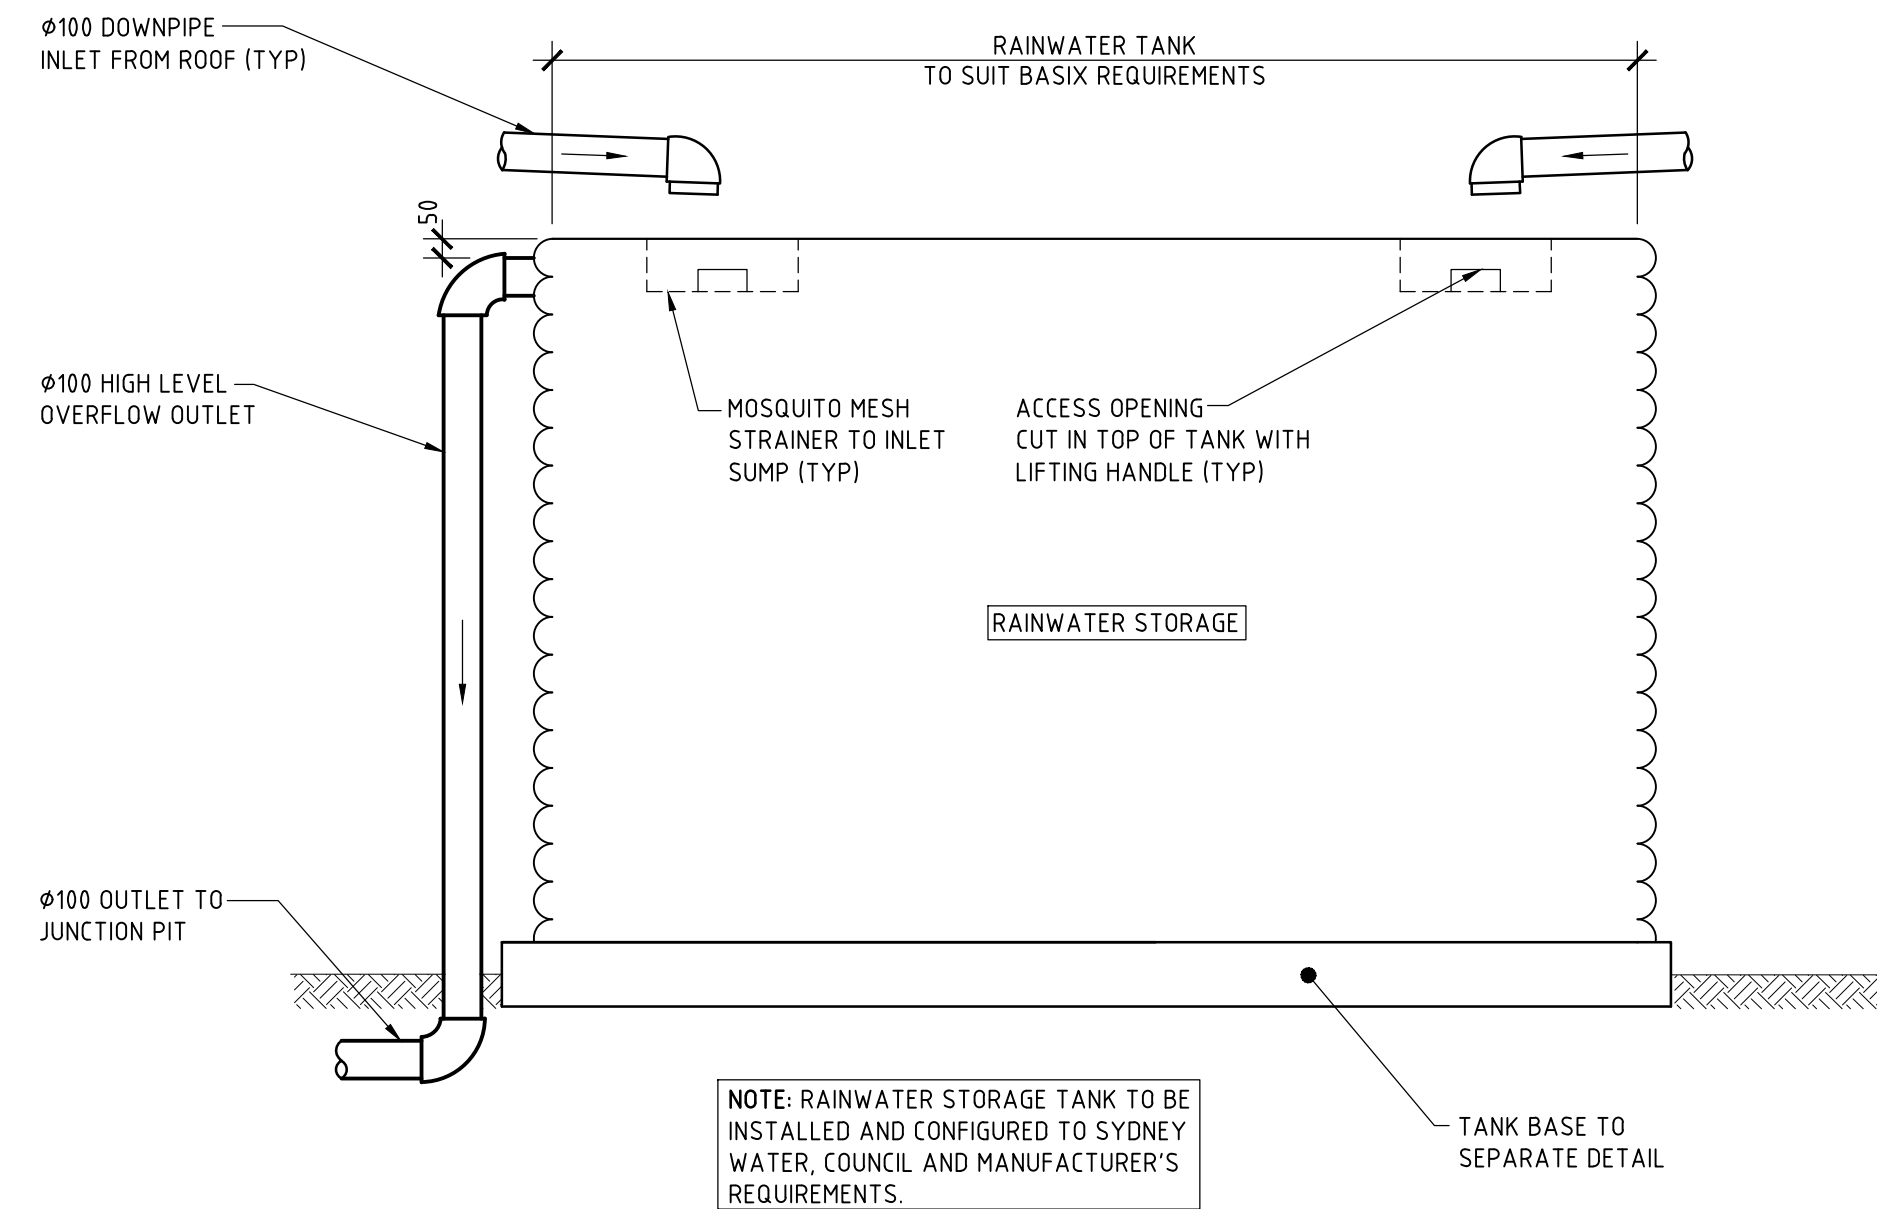

**DETAIL A**  
SCALE 1:20  
TYPICAL RAINWATER STORAGE TANK

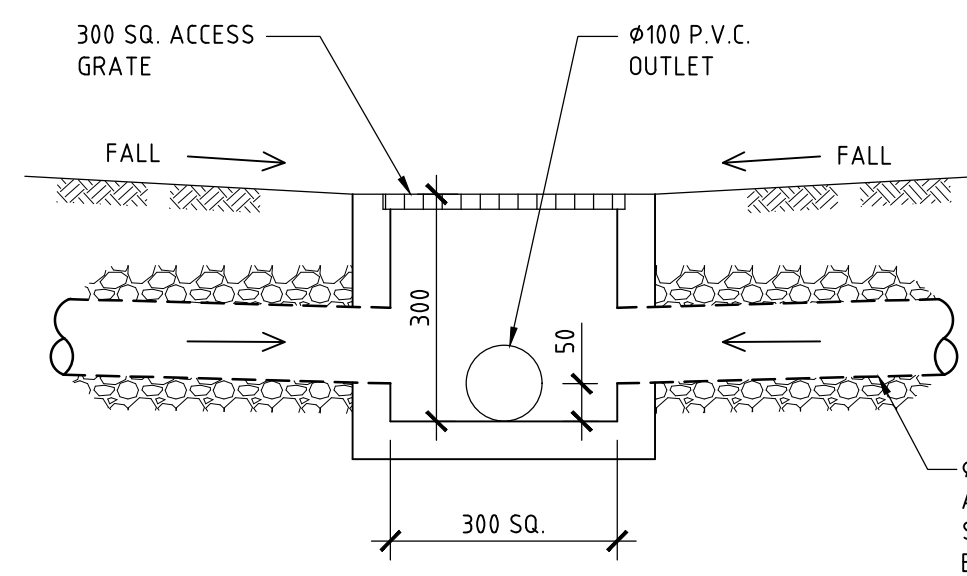

**DETAIL B**  
SCALE 1:10  
TYPICAL SURFACE INLET PIT DETAIL

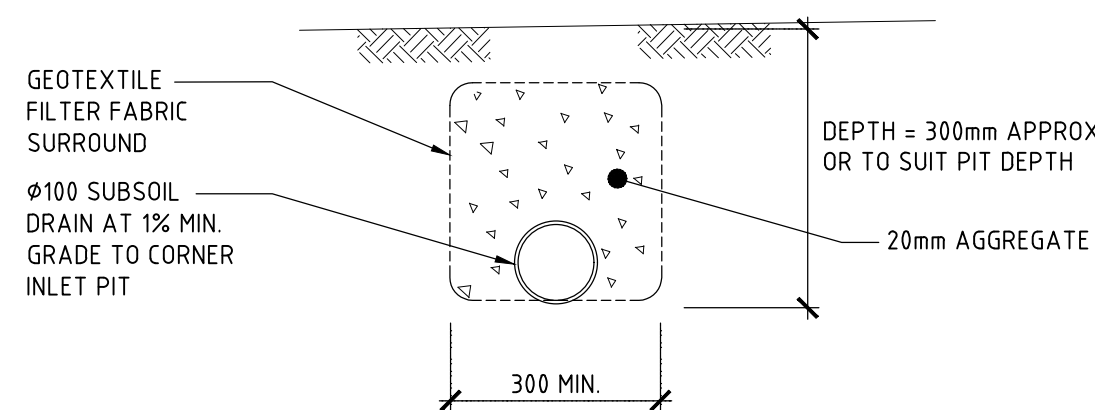

**DETAIL C**  
SCALE 1:10  
TYPICAL SUB-SOIL DRAIN DETAIL

**DETAIL D**  
SCALE 1:20  
TYPICAL LANDSCAPED CATCH DRAIN DETAIL

**DETAIL E**  
SCALE 1:20  
TYPICAL PIPED OUTLET TO UNFORMED ROADWAY

**SITE DATA**

STORMWATER SYSTEM DESIGN DATA	
SITE DATA	
SITE AREA = 576.7 m <sup>2</sup> (100%)	
PROPOSED IMPERVIOUS AREA = 355.6 m <sup>2</sup> (62%)	
PROPOSED LANDSCAPED AREA = 221.1 m <sup>2</sup> (38%)	
EXISTING IMPERVIOUS AREA = 297.2 m <sup>2</sup> (51%)	
EXISTING LANDSCAPED AREA = 279.5 m <sup>2</sup> (49%)	

ISSUE	DATE	REVISION

TITLE <b>STORMWATER MANAGEMENT PLAN</b> 62 WAKEHURST PARKWAY, NORTH NARRABEEN			
DRAWN ALG	DATE 12 AUGUST 2019	CHECKED 	SCALE 1:100 1:20 1:10
TAYLOR CONSULTING CIVIL & STRUCTURAL ENGINEERS			