

BASIX COMPLIANCE REPORT

Prepared for: MOJO Homes

Job Address: LOT 12, 220 POWDERWORKS ROAD, INGLESIDE NSW 2101

Report By: Hayley Smith **RE Job number: ME0111** Client Job number: 651945 Date: 9 November 2021

Nationwide House Energy Rating Scheme NatHERS Certificate No. 0006770572

Generated on 09 Nov 2021 using BERS Pro v4.4.0.6 (3.21)

Property

Address 220 Powderworks Road, Ingleside,

NSW, 2101

Lot/DP 12/25143

NCC Class*

Type **New Dwelling**

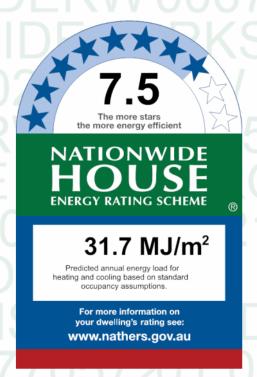
Plans

Main Plan 651945

Prepared by Mojo Homes

Construction and environmen

Assessed floor ar	rea (m²)*	Exposure Type
Conditioned*	171.0	Open
Unconditioned*	49.0	NatHERS climate zone
Total	219.0	56
Garage	36.0	



Thermal performance

Heating Cooling MJ/m^2



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Business name Residential Engineering

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Phone 02 9896 5494

Accreditation No. DMN/18/1861

Assessor Accrediting Organisation

Design Matters National

Declaration of interest Declaration completed: no conflicts

About the rating

NatHERS software models the expected thermal energy loads using information about the design and construction, climate and common patterns of household use. The software does not take into account appliances, apart from the airflow impacts from ceiling fans.

Verification

To verify this certificate, scan the QR code or visit



hstar.com.au/QR/Generate?

p=ylEFaPraf.

When using either link, ensure you are visiting hstar.com.au

National Construction Code (NCC) requirements

The NCC's requirements for NatHERS-rated houses are detailed in 3.12.0(a)(i) and 3.12.5 of the NCC Volume Two. For apartments the requirements are detailed in J0.2 and J5 to J8 of the NCC Volume One.

In NCC 2019, these requirements include minimum star ratings and separate heating and cooling load limits that need to be met by buildings and apartments through the NatHERS assessment. Requirements additional to the NatHERS assessment that must also be satisfied include, but are not limited to: insulation installation methods, thermal breaks, building sealing, water heating and pumping, and artificial lighting requirements. The NCC and NatHERS Heating and Cooling Load Limits (Australian Building Codes Board Standard) are available at www.abcb.gov.au.

State and territory variations and additions to the NCC may also apply.



Certificate check

Ensure the dwelling is designed and then built as per the NatHERS Certificate. While you need to check the accuracy of the whole Certificate, the following spot check covers some important items impacting the dwelling's rating.

Genuine certificate

Does this Certificate match the one available at the web address or QR code in the verification box on the front page? Does the set of NatHERS-stamped plans for the dwelling have a Certificate number on the stamp that matches this Certificate?

Ceiling penetrations*

Does the 'number' and 'type' of ceiling penetrations (e.g. downlights, exhaust fans, etc) shown on the stamped plans or installed, match what is shown in this Certificate?

Windows

Does the installed window meet the substitution tolerances (SHGC and U-value) and window type, of the window shown on this Certificate?

Apartment entrance doors

Does the 'External Door Schedule' show apartment entrance doors? Please note that an "external door" between the modelled dwelling and a shared space, such as an enclosed corridor or foyer, should not be included in the assessment (because it overstates the possible ventilation) and would invalidate the Certificate.

Exposure*

Has the appropriate exposure level (terrain) been applied? For example, it is unlikely that a ground-floor apartment is "exposed" or a top floor high-rise apartment is "protected".

Provisional* values

Have provisional values been used in the assessment and, if so, noted in "additional notes" below?

Additional notes

Window and glazed door type and performance

Default* windows

Window ID	Window	Maximum SHGC*		Substitution tolerance ranges		
WITIGOW ID	Description	U-value*	31100	SHGC lower limit	SHGC upper limit	
TIM-001-01 W	TIM-001-01 W Timber A SG Clear	5.4	0.56	0.53	0.59	

Custom* windows

Window ID	Window	Maximum	SHGC*	Substitution tolerance ranges		
WITIGOW ID	Description	U-value*	энвс	SHGC lower limit	SHGC upper limit	
BRD-034-01 A	BRD-034-01 A SIG Sliding Door (100mm) SG 4Clr	6.1	0.74	0.70	0.78	
BRD-001-01 A	BRD-001-01 A ESS Sliding Window (52mm) SG 3Clr	6.4	0.76	0.72	0.80	
BRD-041-01 A	BRD-041-01 A SIG Fixed Lite Externally Glazed (125mm) SG 4CIr	6.2	0.74	0.70	0.78	
BRD-112-01 A	BRD-112-01 A ESS Awning 52 SG 4mmClr	6.5	0.67	0.64	0.70	



Window and glazed door schedule

Location	Window ID	Window no.	Height (mm)	Width (mm)	Window type	Opening %	Orientation	Window shading device*
Kitchen/Living	BRD-034-01 A	n/a	2100	3228	n/a	60	S	No
Kitchen/Living	BRD-001-01 A	n/a	2080	3010	n/a	30	E	No
Kitchen/Living	BRD-041-01 A	n/a	780	3010	n/a	00	E	No
Bedroom 4	BRD-001-01 A	n/a	1370	1810	n/a	45	S	No
Bedroom 3	BRD-001-01 A	n/a	1370	1810	n/a	45	S	No
WC	BRD-112-01 A	n/a	1030	610	n/a	90	W	No
Bath	BRD-001-01 A	n/a	1200	1570	n/a	45	W	No
Bedroom 5	BRD-001-01 A	n/a	1370	1810	n/a	45	W	No
Bedroom 2	BRD-112-01 A	n/a	1460	610	n/a	90	W	No
Bedroom 2	BRD-112-01 A	n/a	1460	610	n/a	90	W	No
WC2	BRD-112-01 A	n/a	2080	610	n/a	70	W	No
ENS	BRD-112-01 A	n/a	2080	850	n/a	70	W	No
Bedroom 1	BRD-112-01 A	n/a	1800	2650	n/a	60	N	No
Kitchen/Living	TIM-001-01 W	n/a	2100	1210	n/a	70	N	No
Ldry	BRD-034-01 A	n/a	2100	1470	n/a	45	E	No

Roof window type and performance

Default* roof windows

Window ID	Window	Maximum	SHGC*	Substitution tolerance ranges		
	Description	U-value*	31100	SHGC lower limit	SHGC upper limit	
No Data Availab	ple					

Custom* roof windows

Window ID	Window	Window Maximum SH		Substitution tolerance ranges		
	Description	U-value*	SHGC*	SHGC lower limit	SHGC upper limit	
No Data Availal	ole					

Roof window schedule

Location	Window ID	Window no.	Opening %	Height (mm)	Width (mm)	Orientation	Outdoor shade	Indoor shade
No Data Ava	nilable							

Skylight type and performance

Skylight ID	Skylight description	
No Data Available		



Skylight schedule

Skylight Skylight Skylight Skylight shaft **A**rea Outdoor Location shaft length Orientation Diffuser No. (m²) reflectance shade (mm)

No Data Available

External door schedule

Location	Height (mm)	Width (mm)	Opening %	Orientation
Garage 1	2100	4800	90	N

External wall type

Wall ID	Wall type	Solar absorptance	Wall shade (colour)	Bulk insulation (R-value)	Reflective wall wrap*
EW-1	AAC Cavity Panel Direct Fix	0.50	Medium	Anti-glare foil with bulk no gap R2.5	No
EW-2	AAC Cavity Panel Direct Fix	0.50	Medium	No insulation	No

External wall schedule

Location	Wall ID	Height (mm)	Width (mm)	Orientation	Horizontal shading feature* maximum projection (mm)	Vertical shading feature (yes/no)
Kitchen/Living	EW-1	2580	5095	S	3600	YES
Kitchen/Living	EW-1	2580	9445	E	450	NO
Bedroom 4	EW-1	2580	3100	E	5550	YES
Bedroom 4	EW-1	2580	3345	S	475	NO
Bedroom 3	EW-1	2580	3745	W	450	NO
Bedroom 3	EW-1	2580	3345	S	450	NO
WC	EW-1	2580	1090	W	450	NO
Bath	EW-1	2580	1940	W	450	NO
Bedroom 5	EW-1	2580	3840	W	450	NO
Bedroom 2	EW-1	2580	3040	W	450	NO
WC2	EW-1	2580	1590	W	450	NO
ENS	EW-1	2580	2040	W	450	NO
Bedroom 1	EW-1	2580	3795	W	450	NO
Bedroom 1	EW-1	2580	4150	N	450	NO
Bedroom 1	EW-1	2580	1600	E	8550	YES
Kitchen/Living	EW-1	2580	1890	N	2700	YES
Ldry	EW-1	2580	1790	E	450	YES
Garage 1	EW-2	2580	600	W	6500	YES
Garage 1	EW-2	2580	6200	N	450	NO
Garage 1	EW-2	2580	5800	E	450	NO
Garage 1	EW-2	2580	450	S	14850	YES



Internal wall type

Wall ID	Wall type	Area (m²)	Bulk insulation
IW-1 - Cavity wall, direct fix plasterboard, single gap		203.00	No insulation
IW-2 - Cavity wall, direct fix plasterboard, single gap		31.00	Bulk Insulation, No Air Gap R2.5

Floor type

Location	Construction	Area Suk (m²) ver	o-floor ntilation	Added insulation (R-value)	Covering
Kitchen/Living	Waffle pod slab 225 mm 85mm	60.60 Non	ne	Waffle Pod 225mm	Vinyl 3mm
Bedroom 4	Waffle pod slab 225 mm 85mm	11.60 Non	ne	Waffle Pod 225mm	Carpet+Rubber Underlay 18mm
Bedroom 3	Waffle pod slab 225 mm 85mm	12.20 Non	ne	Waffle Pod 225mm	Carpet+Rubber Underlay 18mm
WC	Waffle pod slab 225 mm 85mm	2.00 Non	ne	Waffle Pod 225mm	Ceramic Tiles 8mm
Bath	Waffle pod slab 225 mm 85mm	6.10 Non	ne	Waffle Pod 225mm	Ceramic Tiles 8mm
Bedroom 5	Waffle pod slab 225 mm 85mm	12.20 Non	ne	Waffle Pod 225mm	Carpet+Rubber Underlay 18mm
Bedroom 2	Waffle pod slab 225 mm 85mm	13.40 Non	ne	Waffle Pod 225mm	Carpet+Rubber Underlay 18mm
WIL	Waffle pod slab 225 mm 85mm	2.20 Non	ne	Waffle Pod 225mm	Vinyl 3mm
Corridor	Waffle pod slab 225 mm 85mm	12.30 Non	ne	Waffle Pod 225mm	Vinyl 3mm
WC2	Waffle pod slab 225 mm 85mm	1.50 Non	ne	Waffle Pod 225mm	Ceramic Tiles 8mm
ENS	Waffle pod slab 225 mm 85mm	7.10 Non	ne	Waffle Pod 225mm	Ceramic Tiles 8mm
WIR	Waffle pod slab 225 mm 85mm	5.30 Non	ne	Waffle Pod 225mm	Carpet+Rubber Underlay 18mm
Bedroom 1	Waffle pod slab 225 mm 85mm	17.40 Non	ne	Waffle Pod 225mm	Carpet+Rubber Underlay 18mm
Kitchen/Living	Waffle pod slab 225 mm 85mm	11.20 Non	ne	Waffle Pod 225mm	Vinyl 3mm
WIP	Waffle pod slab 225 mm 85mm	3.50 Non	ne	Waffle Pod 225mm	Vinyl 3mm
Ldry	Waffle pod slab 225 mm 85mm	4.50 Non	ne	Waffle Pod 225mm	Ceramic Tiles 8mm
Garage 1	Waffle pod slab 175 mm 90mm	36.40 Non	ne	Waffle Pod 175mm	Bare

Ceiling type

Location	Construction material/type	Bulk insulation R-value (may include edge batt values)	Reflective wrap*
Kitchen/Living	Plasterboard	Bulk Insulation R4.1	No
Bedroom 4	Plasterboard	Bulk Insulation R4.1	No
Bedroom 3	Plasterboard	Bulk Insulation R4.1	No
WC	Plasterboard	Bulk Insulation R4.1	No
Bath	Plasterboard	Bulk Insulation R4.1	No
Bedroom 5	Plasterboard	Bulk Insulation R4.1	No
Bedroom 2	Plasterboard	Bulk Insulation R4.1	No
WIL	Plasterboard	Bulk Insulation R4.1	No
Corridor	Plasterboard	Bulk Insulation R4.1	No
WC2	Plasterboard	Bulk Insulation R4.1	No



Location	Construction material/type	Bulk insulation R-value (may include edge batt values)	Reflective wrap*
ENS	Plasterboard	Bulk Insulation R4.1	No
WIR	Plasterboard	Bulk Insulation R4.1	No
Bedroom 1	Plasterboard	Bulk Insulation R4.1	No
Kitchen/Living	Plasterboard	Bulk Insulation R4.1	No
WIP	Plasterboard	Bulk Insulation R4.1	No
Ldry	Plasterboard	Bulk Insulation R4.1	No
Garage 1	Plasterboard	No insulation	No

Ceiling penetrations*

Location	Quantity	Туре	Diameter (mm²)	Sealed/unsealed
Kitchen/Living	1	Exhaust Fans	300	Sealed
Bath	1	Exhaust Fans	300	Sealed
ENS	1	Exhaust Fans	300	Sealed

Ceiling fans

Location	Quantity	Diameter (mm)
No Data Available		

Roof type

Construction	Added insulation (R-value)	Solar absorptance	Roof shade
Corrugated Iron	Bulk, Reflective Side Down, No Air Gap Above R1.3	0.70	Dark



Explanatory notes

About this report

A NatHERS rating is a comprehensive, dynamic computer modelling evaluation of a home, using the floorplans, elevations and specifications to estimate an energy load. It addresses the building layout, orientation and fabric (i.e. walls, windows, floors, roofs and ceilings), but does not cover the water or energy use of appliances or energy production of solar panels.

Ratings are based on a unique climate zone where the home is located and are generated using standard assumptions, including occupancy patterns and thermostat settings. The actual energy consumption of a home may vary significantly from the predicted energy load, as the assumptions used in the rating will not match actual usage patterns. For example, the number of occupants and personal heating or cooling preferences will vary.

While the figures are an indicative guide to energy use, they can be used as a reliable guide for comparing different dwelling designs and to demonstrate that the design meets the energy efficiency requirements in the National Construction Code. Homes that are energy efficient use less energy, are warmer on cool days, cooler on hot days and cost less to run. The higher the star rating the more thermally efficient the dwelling is.

Accredited assessors

To ensure the NatHERS Certificate is of a high quality, always use an accredited or licenced assessor. NatHERS accredited assessors are members of a professional body called an Assessor Accrediting Organisation (AAO).

Australian Capital Territory (ACT) licensed assessors may only produce assessments for regulatory purposes using software for which they have a licence endorsement. Licence endorsements can be confirmed on the ACT licensing register

AAOs have specific quality assurance processes in place, and continuing professional development requirements, to maintain a high and consistent standard of assessments across the country. Non-accredited assessors do not have this level of quality assurance or any ongoing training requirements.

Any questions or concerns about this report should be directed to the assessor in the first instance. If the assessor is unable to address these questions or concerns, the AAO specified on the front of this certificate should be contacted.

Disclaimer

The format of the Nathers Certificate was developed by the Nathers Administrator. However the content of each individual certificate is entered and created by the assessor to create a Nathers Certificate. It is the responsibility of the assessor who prepared this certificate to use Nathers accredited software correctly and follow the Nathers Technical Notes to produce a Nathers Certificate.

The predicted annual energy load in this NathERS Certificate is an estimate based on an assessment of the building by the assessor. It is not a prediction of actual energy use, but may be used to compare how other buildings are likely to perform when used in a similar way.

Information presented in this report relies on a range of standard assumptions (both embedded in NatHES accredited software and made by the assessor who prepared this report), including assumptions about occupancy, indoor air temperature and local climate

Not all assumptions that may have been made by the assessor while using the Nath—RS accredited software tool are presented in this report and further details or data files may be available from the assessor.

Glossary

Annual energy load	the predicted amount of energy required for heating and cooling, based on standard occupancy assumptions.
Assessed floor area	the floor area modelled in the software for the purpose of the NatHERS assessment. Note, this may not be consistent with the floor area in the design documents.
Ceiling penetrations	features that require a penetration to the ceiling, including downlights, vents, exhaust fans, rangehoods, chimneys and flues. Excludes
Cenning perietrations	fixtures attached to the ceiling with small holes through the ceiling for wiring, e.g. ceiling fans; pendant lights, and heating and cooling ducts.
Conditioned	a zone within a dwelling that is expected to require heating and cooling based on standard occupancy assumptions. In some circumstances it
Conditioned	will include garages.
Custom windows	windows listed in NatHERS software that are available on the market in Australia and have a WERS (Window Energy Rating Scheme) rating.
Default windows	windows that are representative of a specific type of window product and whose properties have been derived by statistical methods.
Entrance door	these signify ventilation benefits in the modelling software and must not be modelled as a door when opening to a minimally ventilated corridor in a Class 2 building.
Exposure category – exposed	terrain with no obstructions e.g. flat grazing land, ocean-frontage, desert, exposed high-rise unit (usually above 10 floors).
	terrain with few obstructions at a similar height e.g. grasslands with few well scattered obstructions below 10m, farmland with scattered
Exposure category – open	sheds, lightly vegetated bush blocks, elevated units (e.g. above 3 floors).
Exposure category – suburban	terrain with numerous, closely spaced obstructions below 10me.g. suburban housing, heavily vegetated bushland areas.
Exposure category – protected	terrain with numerous, closely spaced obstructions over 10 me.g. city and industrial areas.
Horizontal shading feature	provides shading to the building in the horizontal plane, e.g. eaves, verandahs, pergolas, carports, or overhangs or balconies from upper levels.
National Construction Code	the NCC groups buildings by their function and use, and assigns a classification code. NatHERS software models NCC Class 1, 2 or 4
(NOC) Class	buildings and attached Class 10a buildings. Definitions can be found at www.abcb.gov.au.
Opening percentage	the openability percentage or operable (moveable) area of doors or windows that is used in ventilation calculations.
	an assumed value that does not represent an actual value. For example, if the wall colour is unspecified in the documentation, a provisional
Provisional value	value of 'medium' must be modelled. Acceptable provisional values are outlined in the NatHERS Technical Note and can be found at
	www.nathers.gov.au
Reflective wrap (also known as foil)	can be applied to walls, roofs and ceilings. When combined with an appropriate airgap and emissivity value, it provides insulative properties.
Roof window	for Nathers this is typically an operable window (i.e. can be opened), will have a plaster or similar light well if there is an attic space, and
NOOI WIIIGOW	generally does not have a diffuser.
Shading device	a device fixed to windows that provides shading e.g. window awnings or screens but excludes eaves.
Shading features	includes neighbouring buildings, fences, and wing walls, but excludes eaves.
Solar heat gain coefficient (SHGC)	the fraction of incident solar radiation admitted through a window, both directly transmitted as well as absorbed and subsequently released
Solar fleat gain coefficient (Shoc)	inward. SHGC is expressed as a number between 0 and 1. The lower a window's SHGC, the less solar heat it transmits.
Skylight (also known as roof lights)	for Nathers this is typically a moulded unit with flexible reflective tubing (light well) and a diffuser at ceiling level.
U-value	the rate of heat transfer through a window. The lower the U-value, the better the insulating ability.
Unconditioned	a zone within a dwelling that is assumed to not require heating and cooling based on standard occupancy assumptions.
Vertical shading features	provides shading to the building in the vertical plane and can be parallel or perpendicular to the subject wall/window. Includes privacy screens, other walls in the building (wing walls), fences, other buildings, vegetation (protected or listed heritage trees).
	Colora, Caro, Walle in the Sellining (Willig Walley), Fortices, Other Sellinings, Vogetation (protected or linear hallenge trees).

COVER SHEET SITE ANALYSIS LOCALITY PLAN SITE PLAN WATER MANAGEMENT PLAN GROUND FLOOR PLAN WINDOW & DOOR SCHEDULES **ELEVATIONS / SECTION ELEVATIONS** HOUSE EXTERIOR 3D VIEWS KITCHEN DETAILS BATHROOM / WC DETAILS **ENSUITE / WC2 DETAILS** LAUNDRY DETAILS FLOOR COVERINGS SLAB PLAN

SHEET INDEX

DRAINAGE PLAN

BASIX AREAS

CONDITIONED UNCONDITIONED

Main Dwelling

Main Dwelling

GARAGE

OUTDOOR LIVING

LIVING

PORCH

PRELIMINARY SUSTAINABILITY COMPLIANCE FOR YOUR HOME REQUIRES FURTHER ASSESSMENT TO DETERMINE COMPLIANCE CRITERIA. THIS ASSESSMENT WILL BE FINALISED UPON APPROVAL OF YOUR EXTERNAL COLOUR SELECTIONS TO DETERMINE IF VARIATIONS ARE REQUIRED TO THE PROPOSED DWELLING E.G. ADDITIONAL INSULATION, CHANGES IN WINDOW GLAZING / SIZE / ORIENTATION ETC. YOU WILL BE ADVISED OF ANY REQUIREMENTS OR ALTERNATIVES ONCE THE ASSESSMENT HAS BEEN COMPLETED.

SUSTAINABILITY COMMITMENTS

WATER COMMITMENTS

3 STAR (> 7.5 BUT <= 9 L/MIN) SHOWER HEADS 4 STAR TOILET SUITES 4 STAR KITCHEN TAPS 5 STAR BATHROOM TAPS 291.21 m² TOTAL ROOF AREA 4500 L WATER TANK(S) MINIMUM CAPACITY

183.89 m² MINIMUM ROOF AREA TO TANK(S) RAINWATER TANK(S) TO BE CONNECTED TO:

- AT LEAST ONE OUTDOOR TAP
- ALL TOILETS

13

14

15

- WASHING MACHINE

NO RETICULATED RECYCLED WATER SUPPLY

500 m² GARDEN/LAWN AREA

ENERGY COMMITMENTS

HOT WATER SYSTEM

- GAS CONTINUOUS FLOW - 6 STAR

HEATING SYSTEM

- 3-PHASE REVERSE CYCLE AIR CONDITIONING EER 3.5 - 4.0

COOLING SYSTEM

- 3-PHASE REVERSE CYCLE AIR CONDITIONING EER 3.0 - 3.5

VENTILATION (EXHAUST FANS)

- AT LEAST ONE BATHROOM:
- DUCTED TO OUTSIDE AIR, INTERLOCKED TO
- KITCHEN RANGEHOOD:
- DUCTED TO OUTSIDE AIR, MANUAL SWITCH
- NO MECHANICAL VENTILATION TO LAUNDRY

PRIMARY FLUORESCENT/LED LIGHTING INCLUDING COVER

13.62

37.84

198.65

15.51

4.53

NATURAL LIGHTING TO

- KITCHEN
- 4 BATHROOM(S)/TOILET(S)

ALTERNATIVE ENERGY

OTHER

- GAS COOKTOP, ELECTRIC OVEN
- FIXED OUTDOOR CLOTHESLINE BY OWNER 256.53 m²
 - NO FIXED INDOOR CLOTHESLINE

BUILDING INFORMATION

GROUND FLOOR PITCHING HEIGHT(S): 2580mm FRAMES AND TRUSSES: STEEL ROOF PITCH (U.N.O.): 22.5° ELECTRICITY SUPPLY: 3-PHASE GAS SUPPLY: MAINS / RETICULATED

ROOF MATERIAL: SHEET METAL ROOF COLOUR: DARK

WIND DRIVEN ROOF VENTILATORS: HEBEL VENEER

WALL MATERIAL: WALL COLOUR: N/A

INSULATION

INSULATION TO BE INSTALLED IN ACCORDANCE WITH N.C.C. AND RELEVANT **AUSTRALIAN STANDARDS**

MIN. 60mm FOIL FACED BLANKET UNDER ROOFING CEILING: R4.1 BATTS (EXCL. OUTDOOR LIVING & PATIO)

EXTERIOR WALLS: R2.5 BATTS (EXCL. GARAGE) WALL WRAP TO ENTIRE HOUSE INTERIOR WALLS: R2.5 BATTS (AS PER PLAN)

SITE & ENGINEERING INFORMATION

DESIGN WIND CLASSIFICATION: SITE CLASSIFICATION: М SLAB CLASSIFICATION: M

SLAB TO BE 85mm THICK (U.N.O.) WITH REINFORCEMENT TO ENGINEERS SPECIFICATIONS & DETAILS OVER A 200 µm WATERPROOF MEMBRANE ON A BED OF FREE DRAINING COARSE SAND (WHERE SPECIFIED)

PROVIDE HEBEL CONTROL JOINTS IN ACCORDANCE WITH MANUFACTURER'S **SPECIFICATIONS**

ALL STEEL FRAMING TO BE DESIGNED TO AS 4100-2020 OR AS/NZS 4600-2018

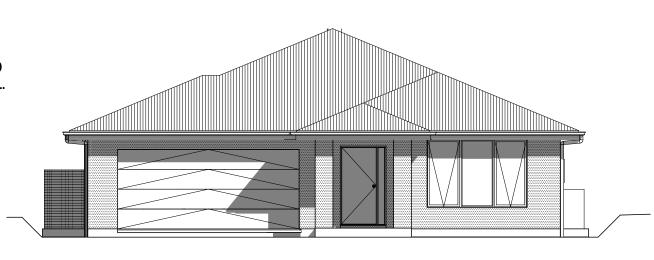
GENERAL INFORMATION

ALL CONSTRUCTION TO BE IN ACCORDANCE WITH NCC AND APPLICABLE AUSTRALIAN STANDARD AT TIME OF APPOVAL.

THESE PLANS FEATURE WORKS REQUIRED BY THE OWNER THAT MAY BE EXCLUDED FROM THE SCOPE OF THE CONTRACT WITH THE BUILDER, BUT HAVE BEEN INCLUDED IN THESE DRAWINGS TO ASSIST IN THE OVERALL PLANNING AND ASSESSMENT. SOME REGULARLY EXCLUDED WORKS INCLUDE DRIVEWAYS, RETAINING WALLS AND SITE DRAINAGE. PLEASE REFER TO YOUR CONTRACT TENDER AND COLOUR SELECTIONS DOCUMENTATION FOR DETAILS



LOT 12 #220 POWDERWORKS ROAD



0006770572 09 Nov 2021 7.5 Accreditation No. DMN/18/1861 220 Powderworks Road

THIS PLAN ACCEPTED BY:

PLEASE NOTE: NO VARIATIONS WILL BE ACCEPTED ON THIS PLAN AFTER SIGNING

DATE:

SIGNATURE:

COMPLIANCE AREAS

TOTAL FLOOR AREAS

LANDSCAPED AREA 19.955.47 SITE COVERAGE AREA 362.30

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	ANY WAY REPRODUCE, COPY, MODIFY, I	USE OR TAKE AD	DVANTAGE OF THE DRAWING TO BUILD A HOU	ISE BASED ON THIS PLAN (WHETHER IN WHOLE OR IN PART) WITHOUT THI	HE PRIOR WRITTEN	CONSENT OF MOJO HOMES PTY LTD.		
PECIFICATION:	REVISION		DRAWN CLIENT:		HOUSE DESIGN:		HOUSE CODE:	
MOJO MORE	1 DRAFT SALES PLAN	TNG	2021.05.07 MR. NIGEL BUBALO	0	RHAPSODY 28			
OPYRIGHT:	2 CT SKETCH	I	2021.06.18 ADDRESS:			FACADE DESIGN:	FACADE CODE:	
2021	3 WORKING DRAWINGS	QLE	2021.08.30 220 POWDERWORK	(S ROAD , INGLESIDE NSW 2101		MODERN		F-JMMRPY00MODNA
	4 WORKING DRAWING CHECK	GBO	2021.10.26 LOT / SECTION / DP:	COUNCIL:		SHEET TITLE:	SHEET No.	SCALES:
			12 / - / 25143	NORTHERN BEACHES COUNCIL		COVER SHEET	1 / 17	

DO NOT SCALE DRAWINGS, USE FIGURED DIMENSIONS ONLY, CHECK AND VERIFY DIMENSIONS AND I EVELS PRIOR TO THE TO THE DRAFTING OFFICE. 651945

TOPOGRAPHY - GENTLY SLOPED BLOCK AS INDICATED BY CONTOURS ON SITE PLAN. SINGLE STOREY DESIGN USED TO TAKE ADVANTAGE OF TOPOGRAPHY WITH MAX CUT OF 526mm AND MAX FILL 518mm.

STREETSCAPE - SETBACKS COMPLY WITH COUNCIL'S REQUIREMENTS, WITH MAIN DWELLING SET BACK 20.015m AND GARAGE SET BACK 21.015m.

CONTEXT - NO SPECIAL REQUIREMENTS.

VEGETATION - SITE IS CLEAR OF TREES AND VEGETATION.

PRIVACY - THE LIVING AREAS OF THE DWELLING ARE SET BACK FROM 32.573m TO OVER 61.615m FROM THE BOUNDARY TO PROVIDE BOTH VISUAL AND ACOUSTIC PRIVACY. IT IS PROPOSED THAT THERE WILL BE AMPLE PRIVACY AND SOLAR AMENITY TO PROPOSED RESIDENCES.

NOISE AND LIGHT - THE PROPOSED POSITION OF THE DWELLING COMPLIES WITH COUNCIL SETBACKS TO THE STREET FRONTAGE. THE SITE IS SITUATED IN A RESIDENTIAL LOCATION WITH THE POSTIONING OF TWO OF THE THREE BEDROOMS AWAY FROM THE MAIN NOISE SOURCE, THUS REDUCING POTENTIAL IMPACT OF STREET NOISE.

PREVAILING WINDS - THE LIVING AREAS OF THE DWELLING WILL BENEFIT FROM SOUTHERLY BREEZES DURING SUMMER.

DRAINAGE - THE SITE DRAINS NATURALLY TO THE FRONT AND REAR OF THE BLOCK. ROOF WATER COLLECTION WILL BE PARTIALLY DIVERTED TO RECYCLING TANKS FOR USE WITHIN THE DWELLING WITH THE TANK OVERFLOW AND THE REMAINING ROOF AREA DISCHARGING TO THE REAR INTERALLOTMENT DRAINAGE.

SERVICES - ELECTRICITY - UNDERGROUND TO HOUSE.

STORMWATER - TO STREET KERB AND TUNNEL CHENCHING

VEHICLE ACCESS - THE GARAGE HAS BEEN PLACED TO REQUIRE MINIMAL ALTERATION TO THE SITE, WITH THE FINISHED FLOOR LEVEL BEING APPROXIMATELY 234mm ABOVE THE KERB LEVEL. TWO UNDERCOVER SPACES WILL BE INCORPORATED WITH ADDITIONAL SPACE ON THE APRON FOR TEMPORARY PARKING - THE DRIVEWAY IS APPROXIMATELY 6m LONG WITHIN THE BOUNDARY.

SURVEY CONSTRAINTS - REFER TO SITE PLAN FOR MORE

SECURITY - THE SURROUNDING BLOCKS ARE CURRENTLY UNOCCUPIED HOWEVER THERE WILL BE RESIDENCES CONSTRUCTED IN THE VICINITY OF THE PROPOSED SITE IN THE NEAR FUTURE AND THEREFORE CASUAL SURVEILLANCE WILL BE REQUIRED.

SITE ANALYSIS LEGEND

(1)/(2)

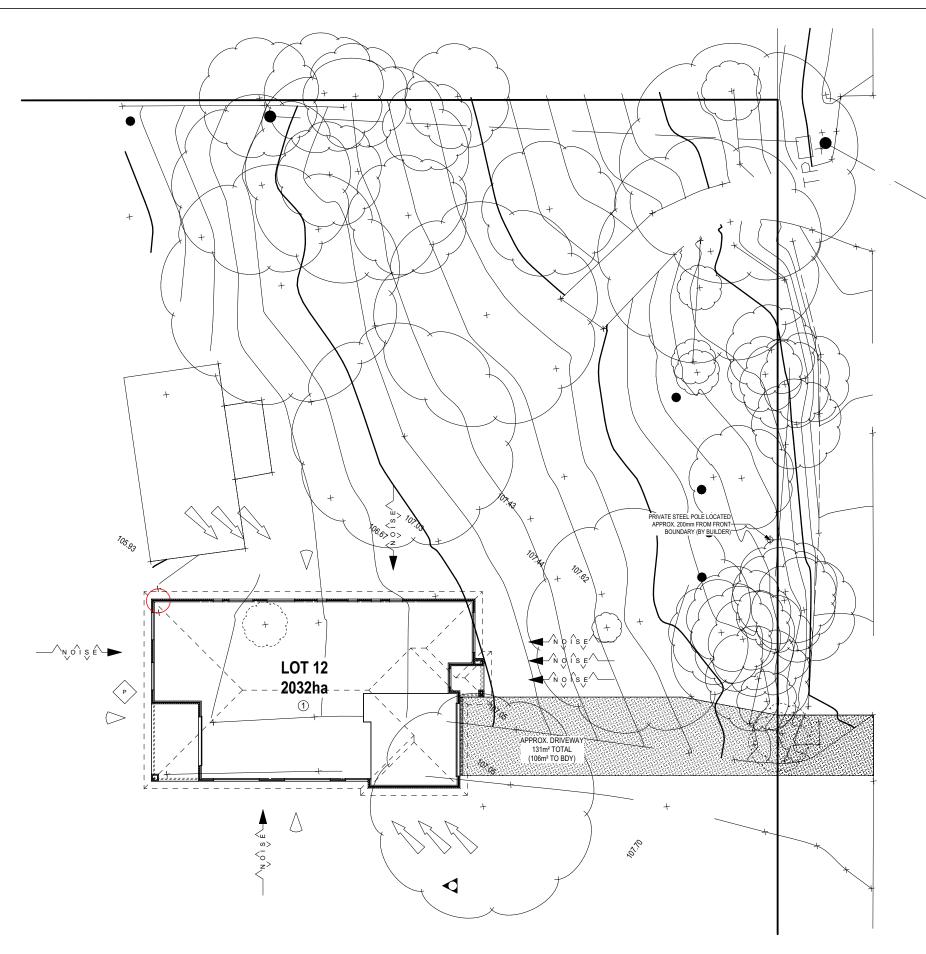
NUMBER OF STORIES

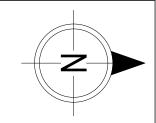
VIEWS

OVERLOOKING POSITION

PREVAILING WINDS

POSSIBLE NOISE SOURCE VEGETATION PRIVATE AREA





M.G.A DP 25143

0006770572 09 Nov 2021 7.5 Accreditation No. DMN/18/1861 Address HOUSE 220 Powderworks Road ngleside, NSW, 2101 31.7 hstar.com.au

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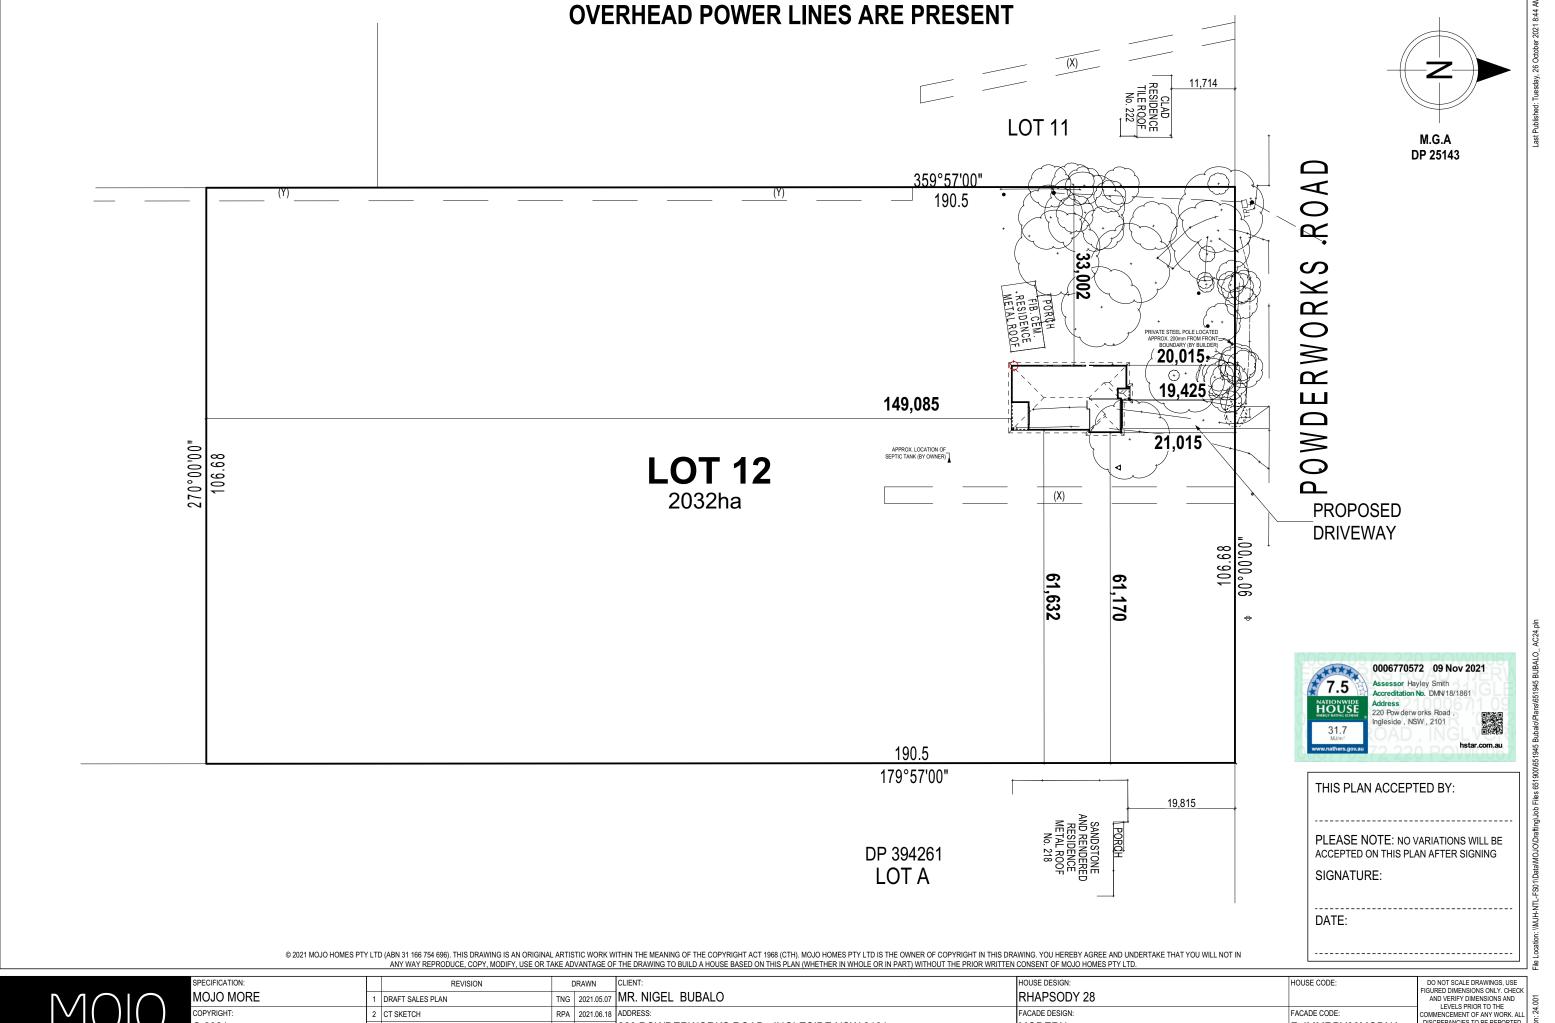
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MOJO MORE		1 DRAFT SALES PLAN	TNO	3 2021.05.07	MR. NIGEL BUBAL	0	RHAPSODY 28			AND VERIFY DIMENSIONS AND LEVELS PRIOR TO THE
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		4 WORKING DRAWING CHECK	GBC	2021.10.26	LOT / SECTION / DP:	COUNCIL:	SHEET TITLE:	SHEET No.	: SCALES:	CE101E
					12 / - / 25143	NORTHERN BEACHES COUNCIL	SITE ANALYSIS	2 / 17	1:250, 1:200	651945

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	4 WORKING DRAWING CHECK	GBO	2021.10.26	LOT / SECTION / DP:	COUNCIL:	I	SHEET TITLE:	SHEET No	:: SCALES:	651015	ate V
				12 / - / 25143	NORTHERN BEACHES COUNCIL	ļi	LOCALITY PLAN	3 / 17	1:700	651945	empl

+/- 100mm TOLERANCE TO NOMINATED FINISHED FLOOR LEVELS. ALL BUILDING INFORMATION REGARDING SUBJECT TO MAXIMUM DRIVEWAY PROFILE AND/OR ANY FLOOD RELATED LEVELS SUSTAINABILITY REQUIREMENTS SITE WORKS INDICATIVE ONLY. THE LOCATIONS AND HEIGHTS OF ANY PROPOSED SITE CLASSIFICATION RETAINING WALLS AND DROPPED EDGE BEAMS ARE SUBJECT TO SITE CONDITIONS REFER TO WATER MANAGEMENT PLAN **DRIVEWAY BY OWNER UNLESS NOTED** FOR ALL ROOF COLLECTION, SURFACE OTHERWISE IN THE TENDER DRAINAGE CONNECTIONS AND DISCHARGE SYSTEMS SUBJECT TO COUNCIL APPROVAL CHARGED STORMWATER SYSTEM CANNOT BE USED FOR DISPOSAL OF DA - NORTHERN BEACHES COUNCIL DRIVEWAY OR OTHER SURFACE STORMWATER. OWNER IS TO PROVIDE **PITTWATER LEP 2014** ALTERNATIVE DISCHARGE LINES IE DOWNPIPES ARE NOTED AS 'CDP' ON PLAN. THE BUILDER PROVIDES CAPACIT SITING SUBJECT TO RECEIPT OF ALL RELEVANT FOR DISPOSAL OF ROOF COLLECTED DOCUMENTATION PERTAINING TO RESTRICTIONS ON THE STORMWATER ONLY AND TAKES NO RESPONSIBILITY FOR OVERFLOW OR DAMAGE TO PROPERTY IF OWNER ADDS LAND IS SUBJECT TO: ADDITIONAL DISCHARGE LOADS TO EXISTING STANDARD PROVISIONS RU2 RURAL LANDSCAPE WIND CLASSIFICATION DRIVEWAY AND RETAINING WALLS BY < 1km TO BREAKING SAL 3.2km OWNER UNLESS NOTED OTHERWISE IN THE TENDER AND/OR COLOUR < 100m TO SALT WATER NO YES SELECTIONS DOCUMENTATION MINE SUBSIDENCE PROPOSED TREES BY OWNER AFTER ACID SULPHATE SOILS CLASS 5 FLOOD N/A WITHIN LOW-RISK IN THE TENDER DOCUMENTATION BUILDING ENVELOPE 45' ANGLE ABOVE 3.5m - SLAB CLASSIFICATION WIND CLASSIFICATION WITHIN 1 KM. OF DEVELOPER GUIDELINES BREAKING SALT WATER APPLICABLE 88B CLAUSES WITHIN 100 M. OF SALT ANY ADDITIONAL RESTRICTIONS TERRESTRIAL WATER **BIODIVERSITY** MINIMI IM AHD ELOOR NO BUILDING RESTRICTIONS: LEVEL APPLICABLE FRONT SETBACK (MIN) SURVEY AREA NEW *SUBJECT TO ESTABLISHED BUILDING LINE LATITUDE SIDE SETBACK (MIN): 33° 00' 00" S REAR SETBACK (MIN) 6.5m LONGITUDE 151° 00' 00" E SITE COVERAGE (MAX) N/A GROSS FLOOR AREA (MAX): N/A APPROX. IMPORT/EXPORT FILL BUILDING HEIGHT (MAX): 8.5m CUT VOLUME 40.03n 8.0m FRONT FACADE · WALL BREAKS (MAX): FILL VOLUME 37.67m LANDSCAPED AREA (MIN) 16,257m² (80%) CUT (MAX): DIFFERENCE 2.36m³ - FILL (MAX) 1 0m **EVEN CUT & FILL** ALL MASONRY CONSTRUCTION SUCH AS MORTAR STRENGTH, WALL TIES AND LINTEL PROTECTION FOR THE BRICKWORK SHALL BE CONSTRUCTED FOR SEVERE MARINE REQUIREMENTS.

ALL EXPOSED STRUCTURAL STEEL TO BE CONSTRUCTED FOR SEVERE MARINE REQUIREMENTS.

AGGRESSIVE SOIL REQUIREMENTS

50 x 25 x 1000 STAKE OR

STAR PICKET

NATURAL SURFACE DOWNHILL OF MEMBRANE NOT TO BE DISTURBED

PROVIDE ADDITIONAL STRUCTURAL REQUIREMENTS, DUE TO BUILDING IN AN 'AGGRESSIVE SOIL ENVIRONMENT'. THIS SHALL INCLUDE THE FOLLOWING: PROVIDE 32MPa CONCRETE TO THE PIERS AND FLOOR SLABS IN LIEU OF STANDARD.

- PROVIDE HIGH IMPACT MEMBRANE BELOW THE FLOOR SLAB.
- PROVIDE A MIN. 50mm BLINDING LAYER OF SAND UNDERNEATH THE FLOOR STRUCTURE. PROVIDE POLYETHYLENE DAMP PROOF COURSE TO THE EXTERNAL WALLS IN LIEU OF STANDARD.
- USE EXPOSURE GRADE MORTAR BELOW DAMP PROOF COURSE IN LIEU OF STANDARD.

MEMBRANE TO BE BIDIM U24

OR APPROVED EQUIVALENT

NATURAL SURFACE LEVEL

BURY APPROXIMATELY 150mm OF MEMBRANE AND TEMPORARILY

USE EXPOSURE GRADE BRICKWORK FROM OUR STANDARD RANGE BELOW THE DAMP PROOF COURSE

CLIENT TO CONNECT ELECTRICITY SUPPLY TO THE SEPTIC TANK

THE CLIENT IS TO ARRANGE FOR THE INSTALLATION OF AN APPROVED SEPTIC SYSTEM AND IF REQUIRED THE PUMP LINE FROM THE TANK TO THE SEWER MAIN. THE SEPTIC SYSTEM IS TO BE DESIGNED BY AN APPROVED INSTALLER AND DESIGN PLANS/SEPTIC APPLICATION FORMS ARE TO BE PROVIDED TO THE BUILDER PRIOR TO THE BUILDING APPLICATION BEING LODGED AT COUNCIL. THE SEPTIC TANK MUST BE SUPPLIED AND INSTALLED NO LATER THAN INTERNAL LININGS BEING COMPLETED. THIS WORK IS TO BE CO-ORDINATED WITH SITE SUPERVISOR. ADDITIONAL DRAINER COSTS COULD OCCUR IF THE INSTALLATION OF THE TANK IS DELAYED.

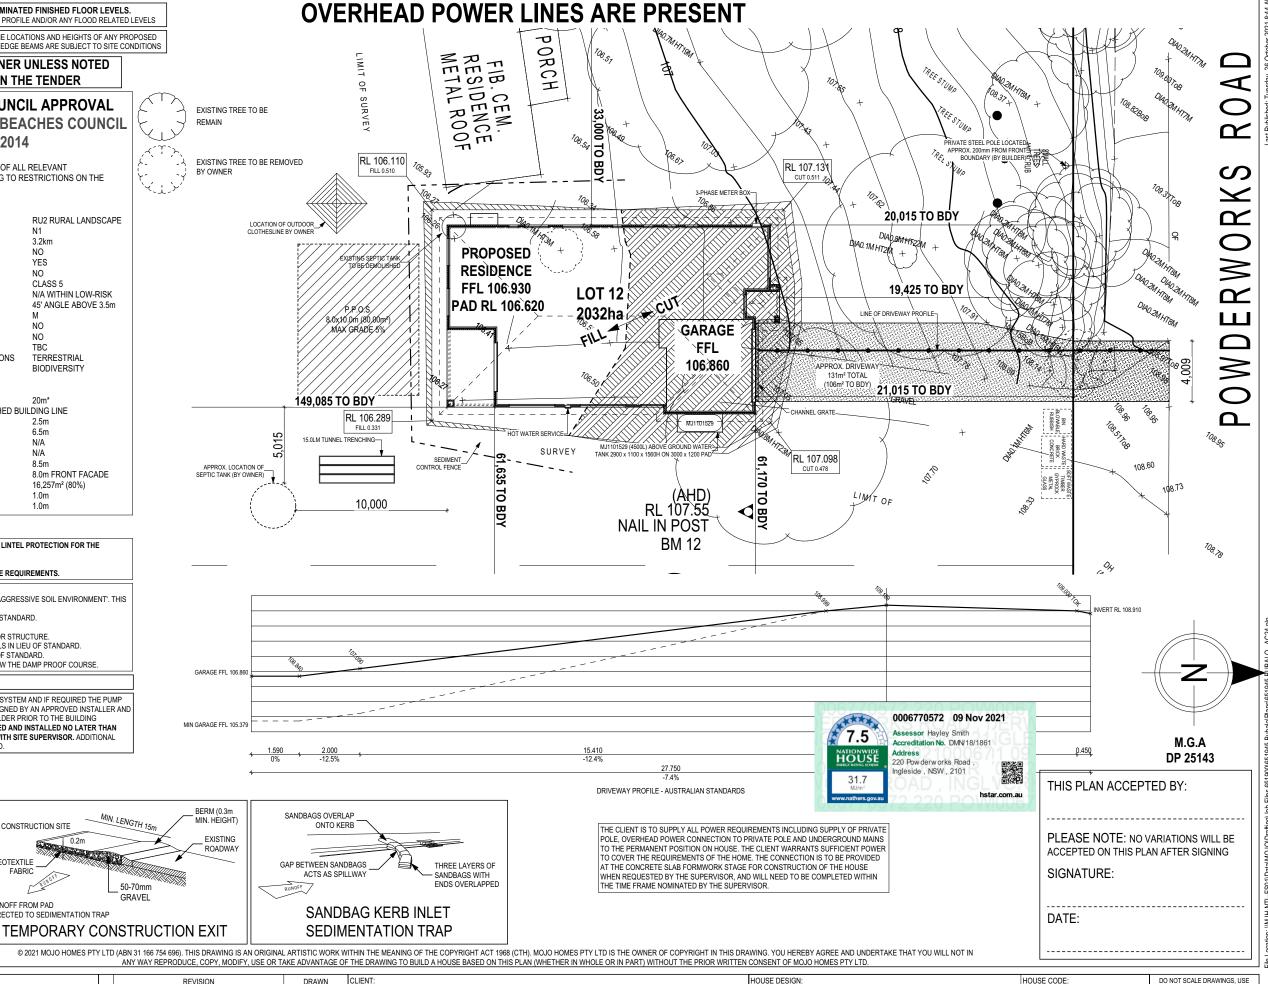
CONSTRUCTION SITE

GRAVEL

GEOTEXTILE

RUNOFF FROM PAD

DIRECTED TO SEDIMENTATION TRAF





SILT FENCING DETAIL

PECIFICATION: FIGURED DIMENSIONS ONLY, CHECK MOJO MORE TNG 2021.05.07 MR. NIGEL BUBALO RHAPSODY 28 DRAFT SALES PLAN AND VERIFY DIMENSIONS AND I EVELS PRIOR TO THE ACADE DESIGN FACADE CODE RPA | 2021.06.18 | ADDRESS: 2 CT SKETCH © 2021 F-JMMRPY00MODNA QLE 2021.08.30 220 POWDERWORKS ROAD, INGLESIDE NSW 2101 MODERN 3 WORKING DRAWINGS TO THE DRAFTING OFFICE. GBO 2021.10.26 LOT / SECTION / DP: SHEET TITLE SHEET No : SCALES: 4 WORKING DRAWING CHECK COUNCIL 651945 12 / - / 25143 NORTHERN BEACHES COUNCIL SITE PLAN 4 / 17 1:250, 1:125

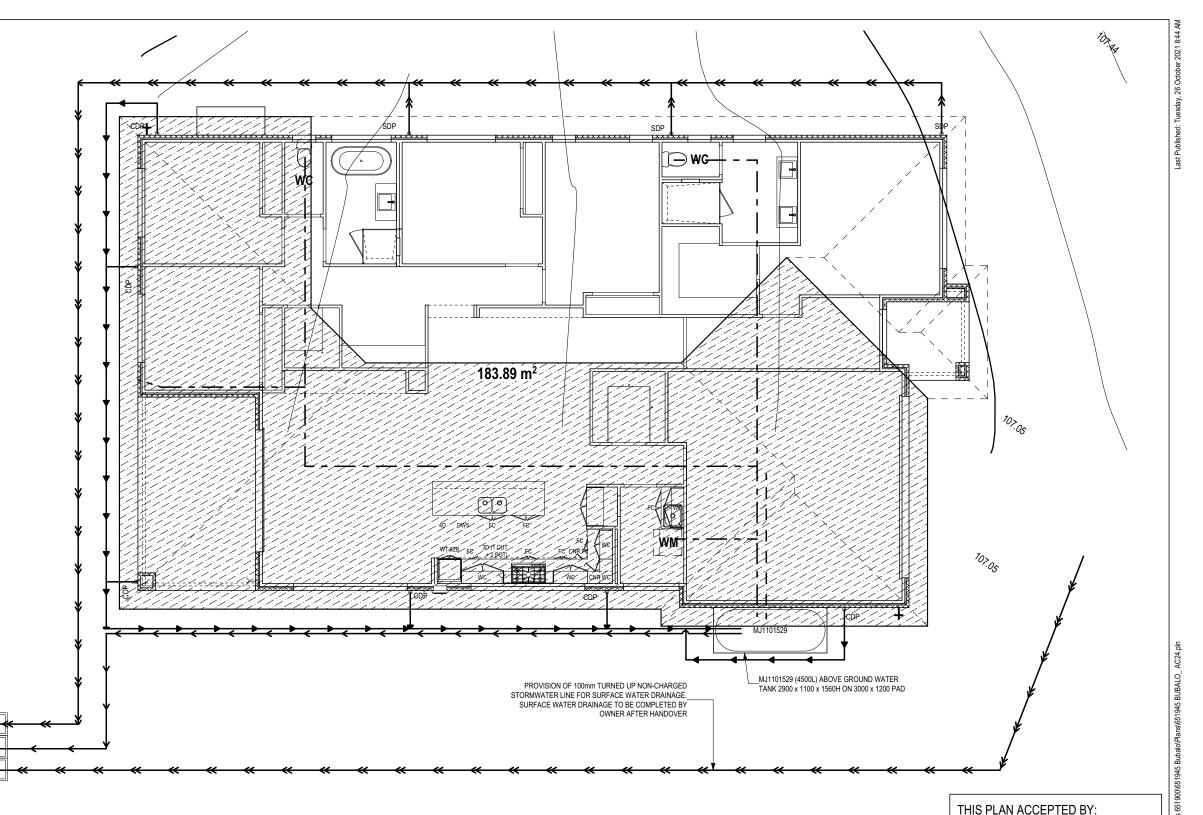
REFER TO SHEET 1 (COVER SHEET) FOR ALL BUILDING INFORMATION REGARDING: SUSTAINABILITY REQUIREMENTS SITE CLASSIFICATION GENERAL BUILDING INFORMATION CDP CHARGED DOWNPIPE DIRECTED TO TANK STANDARD DOWNPIPE DIRECTED TO STORMWATER DISCHARGE CHARGED STORMWATER SYSTEM
CANNOT BE USED FOR DISPOSAL OF
DRIVEWAY OR OTHER SURFACE
STORMWATER. OWNER IS TO PROVIDE ALTERNATIVE DISCHARGE LINES IF DOWNPIPES ARE NOTED AS 'CDP' ON DOWNFIFES ARE NOTED AS COP ON PLAN. THE BUILDER PROVIDES CAPACITY FOR DISPOSAL OF ROOF COLLECTED STORMWATER ONLY AND TAKES NO RESPONSIBILITY FOR OVERFLOW OR DAMAGE TO PROPERTY IF OWNER ADDS ADDITIONAL DISCHARGE LOADS TO EVICTING STANDARD BOOWISIONS EXISTING STANDARD PROVISIONS. NOTE TO PLUMBER: ROOF WATER FROM COLLECTION AREAS

TO BE DIVERTED TO WATER TANK. BALANCE TO STREET KERB VIA TUNNEL TRENCHING. COLLECTION AREA = 183.89m²

ALL STORMWATER OVERFLOW OTHER THAN THAT BEING DIRECTED TO WATER TANK(S) TO BE DIRECTED TO STREET KERB VIA TUNNEL TRENCHING.

SURFACE INLET PITS INCLUDED AND ARE TO BE INSTALLED BY BUILDER. LOCATIONS TO BE DETERMINED ON SITE.

15.0LM TUNNEL TRENCHING-



PLUMBING LEGEND

WATER PUMP IN ACC. WITH LOCAL WATER AUTHORITY REQUIREMENTS TANK CAPACITY TO BE MAINTAINED

ALL RECY. WATER TO BE IN APPROVED

AT MINIMUM 10% CAPACITY

COLOUR CODED PIPEWORK (PURPLE)

ALL DRAINAGE LINES ARE FOR ROOF WATER/WATER TANK DRAINAGE ONLY

RECYCLED COLD WATER LINE

TANK COLD WATER LINE

MAIN SUPPLY

CHARGED LINE TO WATER TANK WATER TANK OVERFLOW

STORMWATER OVERFLOW

WASHING MACHINE WC WATER CLOSET

YARD TAP

WATER MANAGEMENT Scale: 1:100



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MOJO MORE	1 DRAFT SALES PLAN	TNG 2021.05.07	MR. NIGEL BUBAL	.0	RHAPSODY 28			FIGURED DIMENSIONS ONLY. CHEC AND VERIFY DIMENSIONS AND
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	WORKING DRAWING CHECK	GBO 2021.10.26	LOT / SECTION / DP:	COUNCIL:	SHEET TITLE:	SHEET No.:	SCALES:	CEAOAE
			12 / - / 25143	NORTHERN BEACHES COUNCIL	WATER MANAGEMENT PLAN	5 / 17	1:100	651945

PROVIDE AND INSTALL 3 PHASE REVERSE CYCLE AIR CONDITIONING SYSTEM, NUMBER AND POSITIONING OF OUTLETS AND THE FINAL LOCATION OF THE RETURN AIR GRILLE WILL BE DETERMINED ON SITE BY THE AIR I AYOUT AND ANY OTHER CONSTRUCTION CONSTRAINTS

FRAME MANUFACTURER TO PROVIDE CLEARANCE FOR PASSAGE OF FAN COIL UNIT FROM RETURN AIR OPENING TO FINAL FAN COIL LOCATION.

HEBEL ARTICULATION JOINT LOCATION

TO MANUFACTURERS SPECIFICATIONS

4,770 BED 1

75,, 1,050 75,

5,110 ENTRY

, 590 _{*}

185, 605

185, , 605 ,

185, 590

590

2,180

1,590

ANY PART OF THE FASCIA, GUTTERING OR DOWNPIPE THAT IS WITHIN 450mm OF ANY BOUNDARY IS TO BE NON-COMBUSTIBLE IN ACCORDANCE WITH THE NCC.

ALL EXTERIOR SLABS TO BE GRADED BY CONCRETER TO

ACHIEVE APPROX. 1:100 FALL TO OUTSIDE EDGE WITH MAXIMUM CROSSFALL OF 30mm OVER ENTIRE SLAB.

ACCEPTED ON THIS PLAN AFTER SIGNING

SIGNATURE:

DATE:

1,560 1,800 * 891 * TANK WATER (W08) (W02) -3-PHASE METER BOX YARD TAP A1506 ____ AC PAD A1006 SF1216 SF1418 A/F2106 A/F2109 SDP SDP A1506 (W06) (W05) ZEARK ROUND 1600 wc SMALL SHAMPOO RECESS **ENS** (665mm RENDER 75mm EZI POST T 4,410 3,940 # 4,040 BED 1 BED 3 BATH S BED 5 (M) BED 2 BED 1 SMALL SHAMPOO RECESS (G-WETA-TILE01) SS 820 (MIRROR) WIR 2 x 2040H SLIDING 5 820 **S**, l G S/O 1615 1,880 ENTRY 47 ROBE FH BULKHEAD SF1418 STUDY NOOK BULKHEAD OVER PORCH BED 4 615 ₩IL **I** ENTRY 70mm DESK 500 R2.5 INSULATION BATTS PLINTE TO INTERNAL WALL BULKHEAD OVER MAN DINING 7,295 DINING / KITCHEN **WIP** MANUF, SPECS FRAMED BULKHEAD TO KITCHEN CUPBOARDS 2260 OFF FFL AND 680 FROM WALL PROVIDE CONDUIT R4.1 INSULATION BATTS TO CEILING TO ISLAND BENCH OUTDOOR 2 1,120 2,950 .GRILLE 6,430 6,015 **GARAGE** LIVING BREAKFAST BAR LIVING 82∰ 70mm SETDOWN DRY WM **₄** 600 LDRY LINE OF RAISED CEILING OVER (W11) -FOR WALL HUNG DRYER (D-FRAM-F780x3010 TOUNGHENED GLASS SF2100x1470 SFS/FFF2130_ HWS 1695HEAD OFF FFL CDP (D03) MAINS WATER MJ1101529 (4500L) ABOVE GROUND WATER TANK 2900 x 1100 x 1560H ON-3000 x 1200 PAD 3,000 THIS PLAN ACCEPTED BY: 185, 590, 75, 515, 75 1,440 75, 5,110 ENTRY 1,590 1,590 1,590 1,590 PLEASE NOTE: NO VARIATIONS WILL BE

3,110 1	185, ,	8,6	65 LIVING / DINING		1,910 WI برا	IP 75,,420,,75 STORE	5,700	185, 1,5	590
3,110 1	185,		11,14	5	111	STORE 75	5,700	185, 1,5	590
3,110 1	185,		9,390 LIVING / KITCHEN		75 _{kk} 1,6	580 LDRY 75	5,700	185, 1,5	590
3,110 OUTDOOR LIVING 1	185, ,	4,474	150	4,631	75,60,75	1,680 75	5,700	185, 1,5	590
3,110	1,005	3,010	1,687	3,010	1,023	1,485	6,070	1,000	, 590
3,110	1 1	17,290							590
21,990									

21,990

21,400

2.740

75₊₊ 1,935 ROBE

75₊₊ 510[']+ 1,015 WC ₊₊75 1,865 BATH

75, 515, 75 1,440 75,

7,405

75 1,440 WIL 2,200 STUDY NOOK 1,75 1,215 150

3,625 BED 3

3.035 BED 4

SF1478

470

470 x 470mm RENDERED HEBEL PIER WITH

HOUSE

31.7

75mm EZI POST TO CORE

0006770572 09 Nov 2021

220 Powderworks Road

eside NSW . 2101

ALL DIMENSIONS ARE FRAME DIMENSIONS

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4				12 / - / 25143	NORTHERN BEACHES COUNCIL	GROUND FLOOR PLAN	6 / 17	1:100	651945	ldwa

REFER TO SHEET 1 (COVER SHEET) FOR ALL BUILDING INFORMATION REGARDING SUSTAINABILITY REQUIREMENTS

ALL MECHANICAL VENTILATION TO BE

PROVIDE R3 RATING TO THE STEEL

AS PER NCC REQUIREMENTS.

SALTWATER

DISCHARGE DIRECTLY TO OUDOOR AIR

SUPPORT BEAMS DUE TO PROXIMITY TO

SITE CLASSIFICATION

CDP CHARGED DOWNPIPE DIRECTED TO TANK

STANDARD DOWNPIPE DIRECTED TO STORMWATER DISCHARGE

ALL MECHANICAL VENTILATION TO BE DISCHARGED TO OUTDOOR AIR AS PER NCC REQUIREMENTS

FIRE RESISTANT PLASTERBOARD TO BE INSTALLED BEHIND COOKTOP

ALL EXTERIOR STEPS AND LANDINGS BY BUILDER UNLESS NOTED OTHERWISE

ALL GROUND FLOOR BULKHEAD AND SQUARE SET OPENING FRAMES TO BE 2160 ABOVE FFL UNLESS NOTED OTHERWISE

REFER TO WINDOW & DOOR SCHEDULES FOR FULL DETAILS OF ALL WINDOWS AND DOORS

UNLESS NOTED OTHERWISE ALL ROOMS ARE REFERENCED AS FOLLOWS:

FLOOR PLAN LEGEND

HOB SPOUT / WALL SPOUT FACE BRICK / COMMON BRICK HEBEL

SOUND INSULATION BRICK ARTICULATION JOINT

DENOTES DRAWER SIDE **EXHAUST FAN**

L.B.W LOAD BEARING WALL

THIS DOOR OPENS FIRST SMOKE ALARM

LIFT OFF HINGE WATER POINT

FRIDGE WATER POINT

GAS BAYONET

" ASSUME LOOKING F	FROM INSIDE								
STOREY	ID CODE ¹	ROOM	HEIGHT WIDTH PERIMETER	AREA FRAME (m²) TYPE	BAL SILL TYPE RATING	ORIENT.	GLAZING GLAZING TYPE AREA (m²)	ADDITIONAL INFORMATION ²	
GROUND FLOOR	W01 AFA1827	BED 1	1,800 2,650 8,900	4.77 ALUMINIUM	N/A NONE	N	3.93 CLEAR	MP 883-883	
GROUND FLOOR	W02 A/F2109	ENS	2,080 850 5,860	1.77 ALUMINIUM	N/A NONE	W	1.37 SATINLITE, TOUGHENED	BP 600	
GROUND FLOOR	W03 A/F2106	WC 2	2,080 610 5,380	1.27 ALUMINIUM	N/A NONE	W	0.93 SATINLITE, TOUGHENED	BP 600	
GROUND FLOOR	W04 A1506	BED 2	1,460 610 4,140	0.89 ALUMINIUM	N/A NONE	W	0.64 CLEAR		
GROUND FLOOR	W05 A1506	BED 2	1,460 610 4,140	0.89 ALUMINIUM	N/A NONE	W	0.64 CLEAR		
GROUND FLOOR	W06 SF1418	BED 5	1,370 1,810 6,360	2.48 ALUMINIUM	N/A NONE	W	2.20 CLEAR		
GROUND FLOOR	W07 SF1216	BATH	1,200 1,570 5,540	1.88 ALUMINIUM	N/A NONE	W	1.64 SATINLITE, TOUGHENED		
GROUND FLOOR	W08 A1006	WC	1,030 610 3,280	0.63 ALUMINIUM	N/A NONE	W	0.44 SATINLITE, TOUGHENED		
GROUND FLOOR	W09 SF1418	BED 3	1,370 1,810 6,360	2.48 ALUMINIUM	N/A NONE	S	2.20 CLEAR		
GROUND FLOOR	W10 SF1418	BED 4	1,370 1,810 6,360	2.48 ALUMINIUM	N/A NONE	S	2.20 CLEAR		
GROUND FLOOR	W11 SFS/FFF2130	LIVING	2,080 3,010 10,180	6.26 ALUMINIUM	N/A NONE	E	5.44 CLEAR	BP 600, MP 753-1505/0	
GROUND FLOOR	W12 F780x3010	KITCHEN	780 3,010 7,580	2.35 ALUMINIUM	N/A NONE	E	2.08 CLEAR, TOUGHENED		
				28.15			23.71		

EXTERIOR DOOR SCHEDULE

, 2 ASSUME LOOKING FROM OUTSIDE

STOREY	ID CODE ¹	ROOM	HEIGHT WIDTH	AREA FRAME (m²) TYPE	BAL RATING	SILL TYPE	ORIENT.	GLAZING TYPE	DOOR TYPE ADDITIONAL INFORMATION ²
GROUND FLOOR	D01 920 (2100x1210)	ENTRY	2,100 1,210	2.54 TIMBER	N/A	SNAP HEADER	N	DOOR(S): CLEAR, TOUGHENED - SIDELIGHT(S): CLEAR, TOUGHENED	SWINGING
GROUND FLOOR	D02 SSF2132	LIVING	2,100 3,228	6.78 ALUMINIUM	N/A	SNAP HEADER	S	CLEAR, TOUGHENED	STACKER
GROUND FLOOR	D03 SF2100x1470	LDRY	2,100 1,470	3.09 ALUMINIUM	N/A	NONE	Е	CLEAR, TOUGHENED	SLIDING

12.41 m²

INTERIOR DOOR SCHEDULE

STOREY	QTY	CODE	TYPE	HEIGHT	WIDTH	GLAZING TYPE	ADDITIONAL INFORMATION
GROUND FLOOR	1	1360 SS	SQUARE SET OPENING	2,160	1,360	N/A	
GROUND FLOOR	3	2 x 2040H SLIDING	SLIDING	2,040	1,600	N/A	SELECT, MIRROR
GROUND FLOOR	1	2 x 2040H SLIDING	SLIDING	2,040	1,800	N/A	SELECT, MIRROR
GROUND FLOOR	1	720	SWINGING	2,040	720	N/A	LIFT-OFF HINGES
GROUND FLOOR	1	770	SWINGING	2,040	770	N/A	
GROUND FLOOR	8	820	SWINGING	2,040	820	N/A	
GROUND FLOOR	1	820	SWINGING	2,040	820	N/A	LIFT-OFF HINGES
GROUND FLOOR	2	900 SS	SQUARE SET OPENING	2,160	900	N/A	
GROUND FLOOR	1	915 SS	SQUARE SET OPENING	2,160	915	N/A	

PICTURE / TV RECESS & SQUARE SET WINDOW SCHEDULE

QTY TYPE HEIGHT WIDTH AREA (m²)

> 7.5 gleside, NSW, 2101

REFER TO SHEET 1 (COVER SHEET) FOR
ALL BUILDING INFORMATION REGARDING:
SUSTAINABILITY REQUIREMENTS
SITE CLASSIFICATION
CENEDAL BLILLDING INFORMATION

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PLEASE NOTE: NO VARIATIONS WILL BE ACCEPTED ON THIS PLAN AFTER SIGNING SIGNATURE:

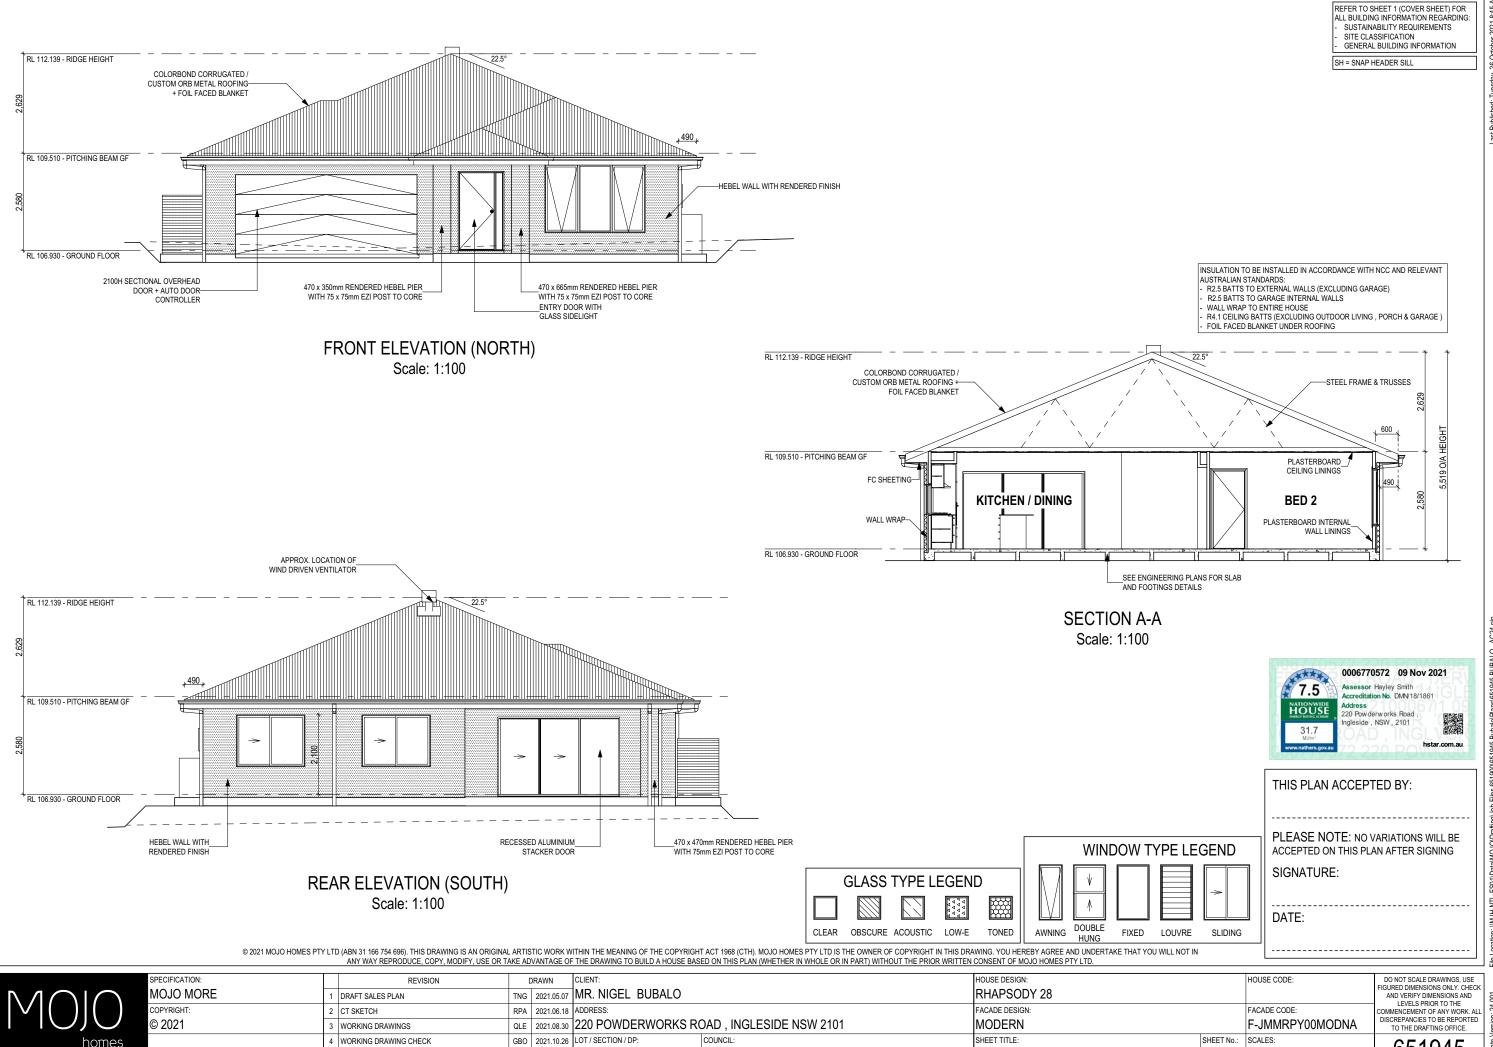
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651945



NORTHERN BEACHES COUNCIL

12 / - / 25143

ELEVATIONS / SECTION

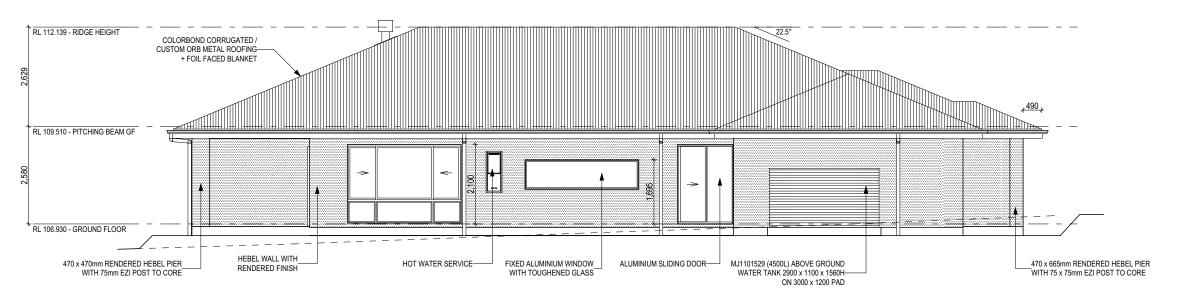
8 / 17

1:100

4 WORKING DRAWING CHECK

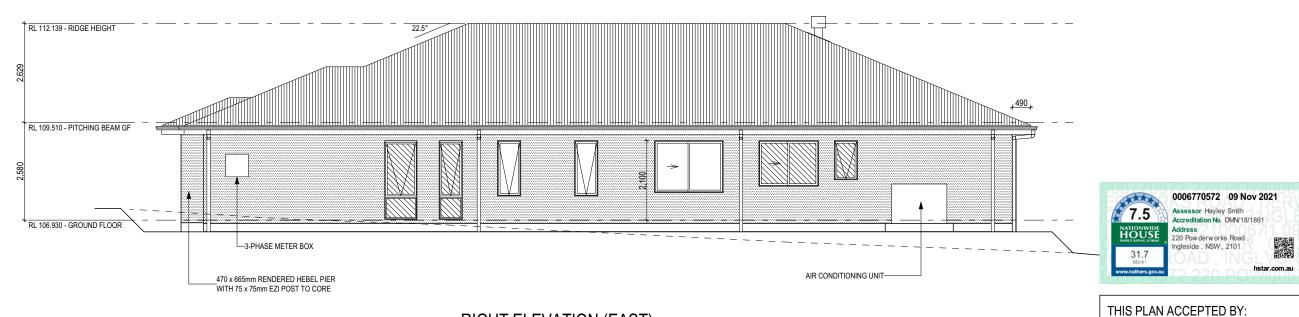
651945

SH = SNAP HEADER SILL



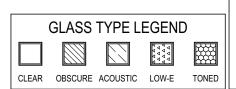
LEFT ELEVATION (WEST)

Scale: 1:100



RIGHT ELEVATION (EAST)

Scale: 1:100



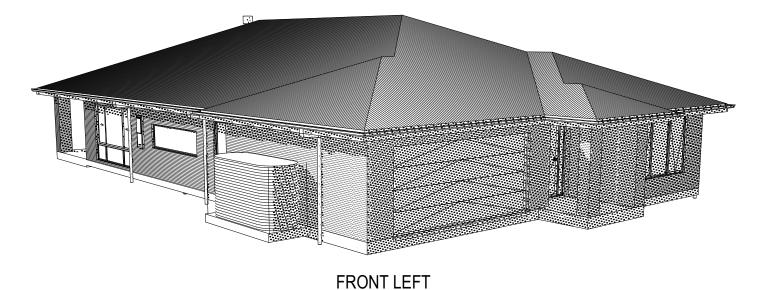
WINDOW TYPE LEGEND AWNING DOUBLE FIXED LOUVRE SLIDING HUNG

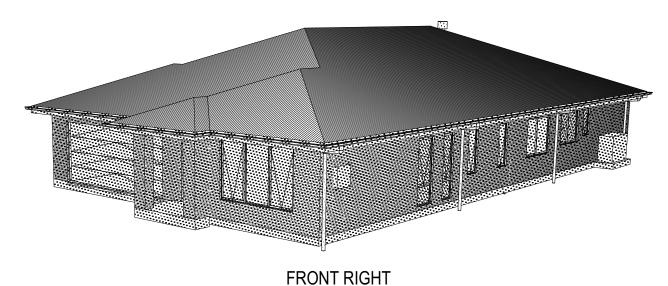
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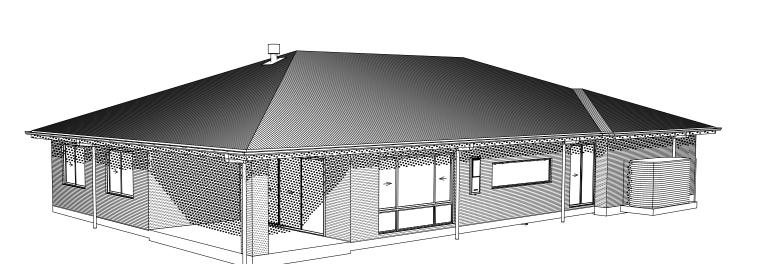
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MOJO MORE	1 DRAFT SALES PLAN	TNG	2021.05.07	MR. NIGEL BUBAI	LO	RHAPSODY 28			FIGURED DIMENSIONS ONLY. CHEC AND VERIFY DIMENSIONS AND
COPYRIGHT:	2 CT SKETCH	RPA	2021.06.18	ADDRESS:		FACADE DESIGN:		FACADE CODE:	LEVELS PRIOR TO THE COMMENCEMENT OF ANY WORK. AL
© 2021	3 WORKING DRAWINGS	QLE	2021.08.30	220 POWDERWOR	RKS ROAD , INGLESIDE NSW 2101	MODERN	MODERN		DISCREPANCIES TO BE REPORTE TO THE DRAFTING OFFICE.
	4 WORKING DRAWING CHECK	GBO	2021.10.26	LOT / SECTION / DP:	COUNCIL:	SHEET TITLE:	SHEET No.:	SCALES:	CEAOAE
				12 / - / 25143	NORTHERN BEACHES COUNCIL	ELEVATIONS	9 / 17	1:100	651945







REAR LEFT

REAR RIGHT

7.5

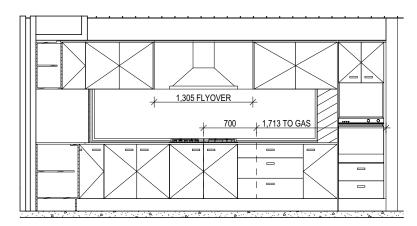
0006770572 09 Nov 2021 Accreditation No. DMN/18/1861 Address 220 Powderworks Road ngleside, NSW, 2101

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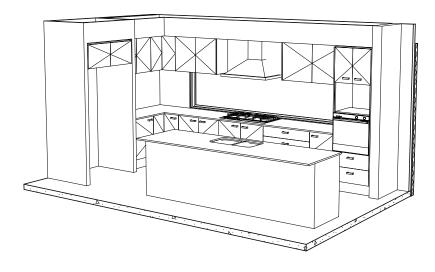
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MOJO MORE HOUSE DESIGN: HOUSE CODE: DRAWN REVISION TNG 2021.05.07 MR. NIGEL BUBALO RHAPSODY 28 1 DRAFT SALES PLAN COPYRIGHT: RPA 2021.06.18 ADDRESS: FACADE DESIGN: FACADE CODE: 2 CT SKETCH © 2021 F-JMMRPY00MODNA QLE 2021.08.30 220 POWDERWORKS ROAD, INGLESIDE NSW 2101 MODERN 3 WORKING DRAWINGS GBO 2021.10.26 LOT/SECTION/DP: SHEET TITLE: SHEET No.: SCALES: 4 WORKING DRAWING CHECK 651945 12 / - / 25143 NORTHERN BEACHES COUNCIL HOUSE EXTERIOR 3D VIEWS 10 / 17

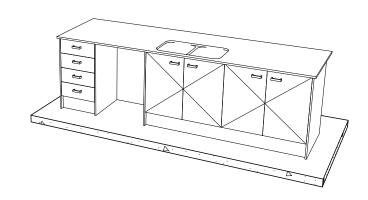
GAS CONNECTION FOR COOKTOP TO BE LOCATED 700mm TO RIGHT HAND SIDE OF CENTRE OF COOKTOP

ELEVATION A Scale: 1:50



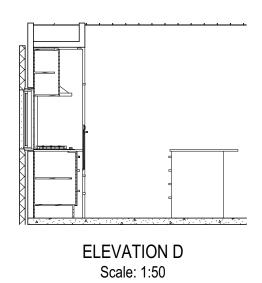
ELEVATION C Scale: 1:50





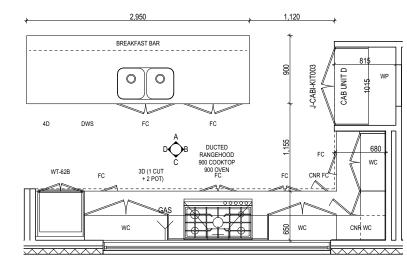
1,035

ELEVATION B Scale: 1:50



FRAMED BULKHEAD TO KITCHEN CUPBOARDS 2260 OFF FFL AND 680 FROM WALL

PROVIDE CONDUIT TO ISLAND BENCH



KITCHEN PLAN Scale: 1:50

0006770572	09 Nov 2021
Assessor Hayley Accreditation No.	
Address	0000

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SPECIFICATION: MOJO MORE	REVISION 1 DRAFT SALES PLAN	DRAWN CLIENT: TNG 2021.05.07 MR. NIGEL BUBALO		HOUSE DESIGN: RHAPSODY 28		HOUSE CODE:	DO NOT SCALE DRAWINGS, USE FIGURED DIMENSIONS ONLY. CHECK AND VERIFY DIMENSIONS AND
COPYRIGHT: © 2021	-	RPA 2021.06.18 ADDRESS: QLE 2021.08.30 220 POWDERWORKS F	, ROAD , INGLESIDE NSW 2101	FACADE DESIGN: MODERN		FACADE CODE: F-JMMRPY00MODNA	LEVELS PRIOR TO THE COMMENCEMENT OF ANY WORK. ALL DISCREPANCIES TO BE REPORTED TO THE DRAFTING OFFICE.
	4 WORKING DRAWING CHECK	GBO 2021.10.26 LOT/SECTION/DP: 12 / - / 25143	COUNCIL: NORTHERN BEACHES COUNCIL	SHEET TITLE: KITCHEN DETAILS	SHEET No.: 11 / 17		651945

THIS PLAN ACCEPTED BY:

SIGNATURE:

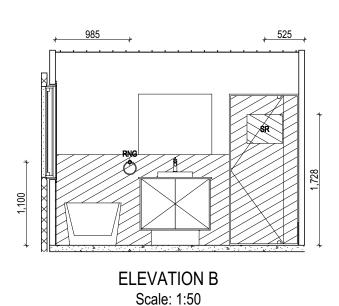
DATE:

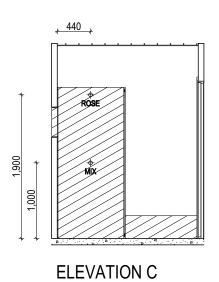
PLEASE NOTE: NO VARIATIONS WILL BE ACCEPTED ON THIS PLAN AFTER SIGNING

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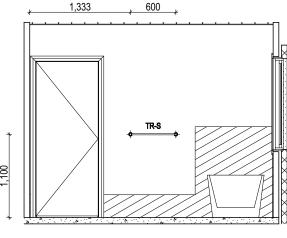
940 200, **ELEVATION A**

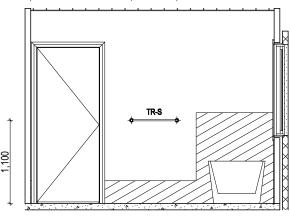
Scale: 1:50





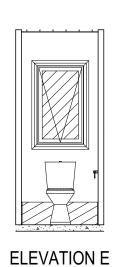
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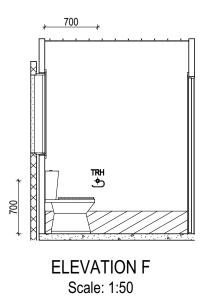


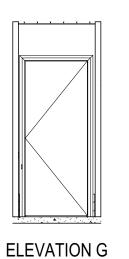
ELEVATION D

Scale: 1:50

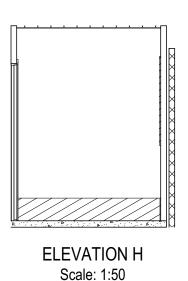


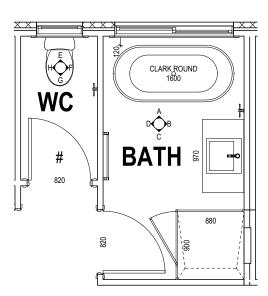
Scale: 1:50





Scale: 1:50





BATHROOM / WC PLANS

Scale: 1:50

HS HOB SPOUT WS WALL SPOUT SC STOP COCK TRH TOILET ROLL HOLDER TR-S TOWEL RAIL - SINGLE TR-D TOWEL RAIL - DOUBLE TL TOWEL LADDER TH TOWEL HOLDER TR TOWEL RACK TMB TUMBLER HOLDER RNG TOWEL RING ROBE HOOK SHLF SHELF

SR SHAMPOO RECESS

SOAP SOAP HOLDER

LEGEND

RSHR RAIL SHOWER ROSE SHOWER ROSE ELBW SHOWER ELBOW CONNECTION MIX MIXER TAP HT HOT TAP CT COLD TAP



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SPECIFICATION:			REVISION		5.0		HOUSE DESIGN:	HOUSE CODE:	DO NOT SCALE DRAWINGS, USE FIGURED DIMENSIONS ONLY, CHECK
MOJO MORE		1	DRAFT SALES PLAN	TNG	2021.05.07	MR. NIGEL BUBALO	RHAPSODY 28		AND VERIFY DIMENSIONS AND
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© 2021		3	WORKING DRAWINGS	QLE	2021.08.30	220 POWDERWORKS ROAD , INGLESIDE NSW 2101	MODERN	F-JMMRPY00MODNA	DISCREPANCIES TO BE REPORTED TO THE DRAFTING OFFICE.
		4	WORKING DRAWING CHECK	GBO	2021.10.26		SHEET TITLE: SHEET No.:	SCALES:	651945
						12 / - / 25143 NORTHERN BEACHES COUNCIL	BATHROOM / WC DETAILS 12 / 17	1:50	001940

LEGEND

RSHR RAIL SHOWER ROSE SHOWER ROSE ELBW SHOWER ELBOW CONNECTION MIX MIXER TAP HT HOT TAP CT COLD TAP HS HOB SPOUT WS WALL SPOUT

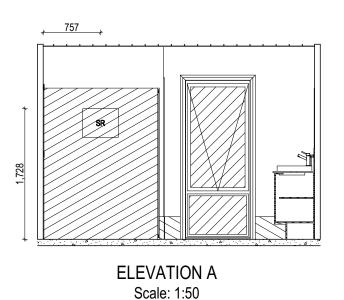
SC STOP COCK TRH TOILET ROLL HOLDER TR-S TOWEL RAIL - SINGLE TR-D TOWEL RAIL - DOUBLE TL TOWEL LADDER TH TOWEL HOLDER

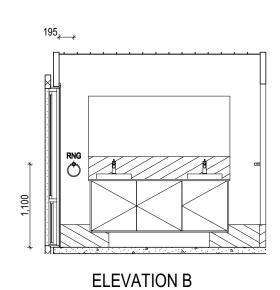
TR TOWEL RACK TMB TUMBLER HOLDER RNG TOWEL RING ROBE HOOK

SHLF SHELF

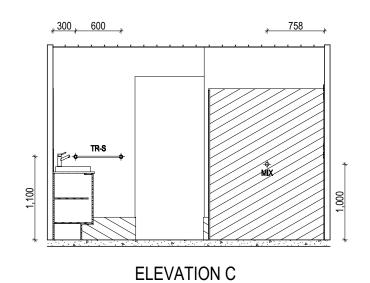
SR SHAMPOO RECESS SOAP SOAP HOLDER

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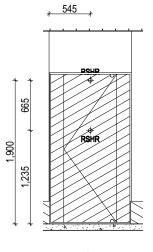




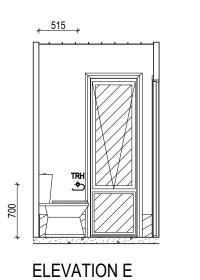
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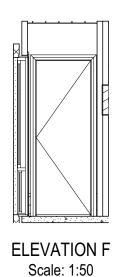


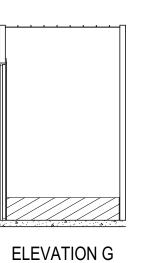
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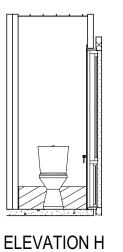
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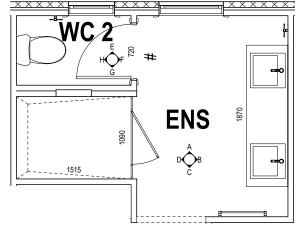




Scale: 1:50



Scale: 1:50



ENSUITE / WC2 PLANS Scale: 1:50



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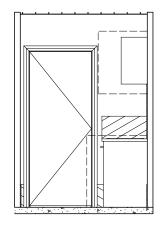
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Scale: 1:50

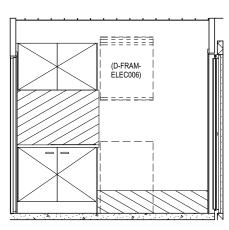


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SPECIFICATION: MOJO MORE	1	REVISION DRAFT SALES PLAN		5.0	CLIENT: MR. NIGEL BUBALO		HOUSE DESIGN: RHAPSODY 28		HOUSE CODE:	DO NOT SCALE DRAWINGS, USE FIGURED DIMENSIONS ONLY. CHECK AND VERIFY DIMENSIONS AND	
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	4	WORKING DRAWING CHECK	GBO		LOT / SECTION / DP:	COUNCIL:	SHEET TITLE:	SHEET No.:		651945	ate V
1					12 / - / 25143	NORTHERN BEACHES COUNCIL	ENSUITE / WC2 DETAILS	13 / 17	1:50	001940	dme

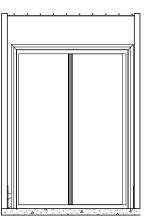
SH = SNAP HEADER SILL



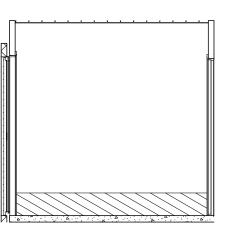
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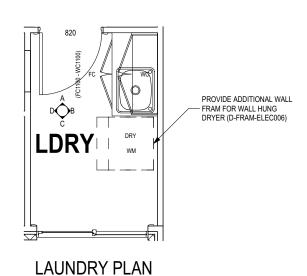
ELEVATION B Scale: 1:50



ELEVATION C Scale: 1:50



ELEVATION D Scale: 1:50

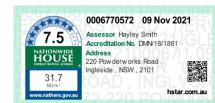


Scale: 1:50

ELBW SHOWER ELBOW CONNECTION MIX MIXER TAP HT HOT TAP CT COLD TAP HS HOB SPOUT WS WALL SPOUT SC STOP COCK TRH TOILET ROLL HOLDER TR-S TOWEL RAIL - SINGLE TR-D TOWEL RAIL - DOUBLE TL TOWEL LADDER TH TOWEL HOLDER TR TOWEL RACK TMB TUMBLER HOLDER RNG TOWEL RING ROBE HOOK SHLF SHELF SR SHAMPOO RECESS SOAP SOAP HOLDER

LEGEND

RSHR RAIL SHOWER ROSE SHOWER ROSE



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OJO MORE	1 DRAFT SALES PLAN	TNG	2021.05.07	MR. NIGEL BUBALO			RHAPSODY 28				FIGURED DIMENSIONS ONLY. CHECK AND VERIFY DIMENSIONS AND	001	
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2021	3 WORKING DRAWINGS	QLE	2021.08.30	220 POWDERWORKS RO	OAD , INGLESIDE NSW 2101		MODERN			F-JMMRPY00MODNA	DISCREPANCIES TO BE REPORTED TO THE DRAFTING OFFICE.	ersio	
	4 WORKING DRAWING CHECK	GBO	2021.10.26	LOT / SECTION / DP:	COUNCIL:		SHEET TITLE:		SHEET No.:	SCALES:	651045	ate V	
				12 / - / 25143	NORTHERN BEACHES COUNCIL		LAUNDRY DETAILS		14 / 17	1:50	651945	_ E	

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FLOOR TILES SHOWN ON PLAN DO NOT INDICATE THE SIZE OR JOINT LOCATIONS OF THE ACTUAL FLOOR TILES.
TIMBER FLOORING SHOWN ON PLAN DOES NOT INDICATE THE BOARD SIZE OR DIRECTION OF THE ACTUAL FLOORING.

COVERINGS LEGEND

NO COVERING

COVER GRADE CONCRETE

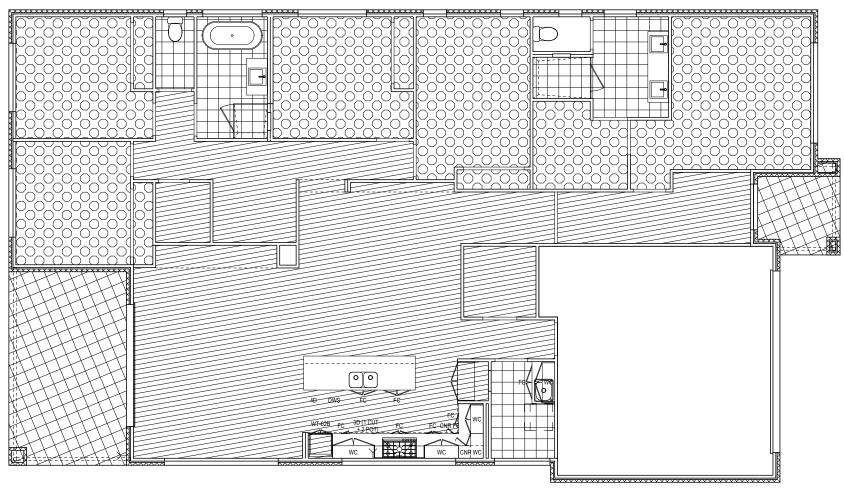
CARPET

TIMBER/LAMINATE (BY BUILDER)

TILE (STANDARD WET AREAS)

TILE (UPGRADED AREAS)

VINYL



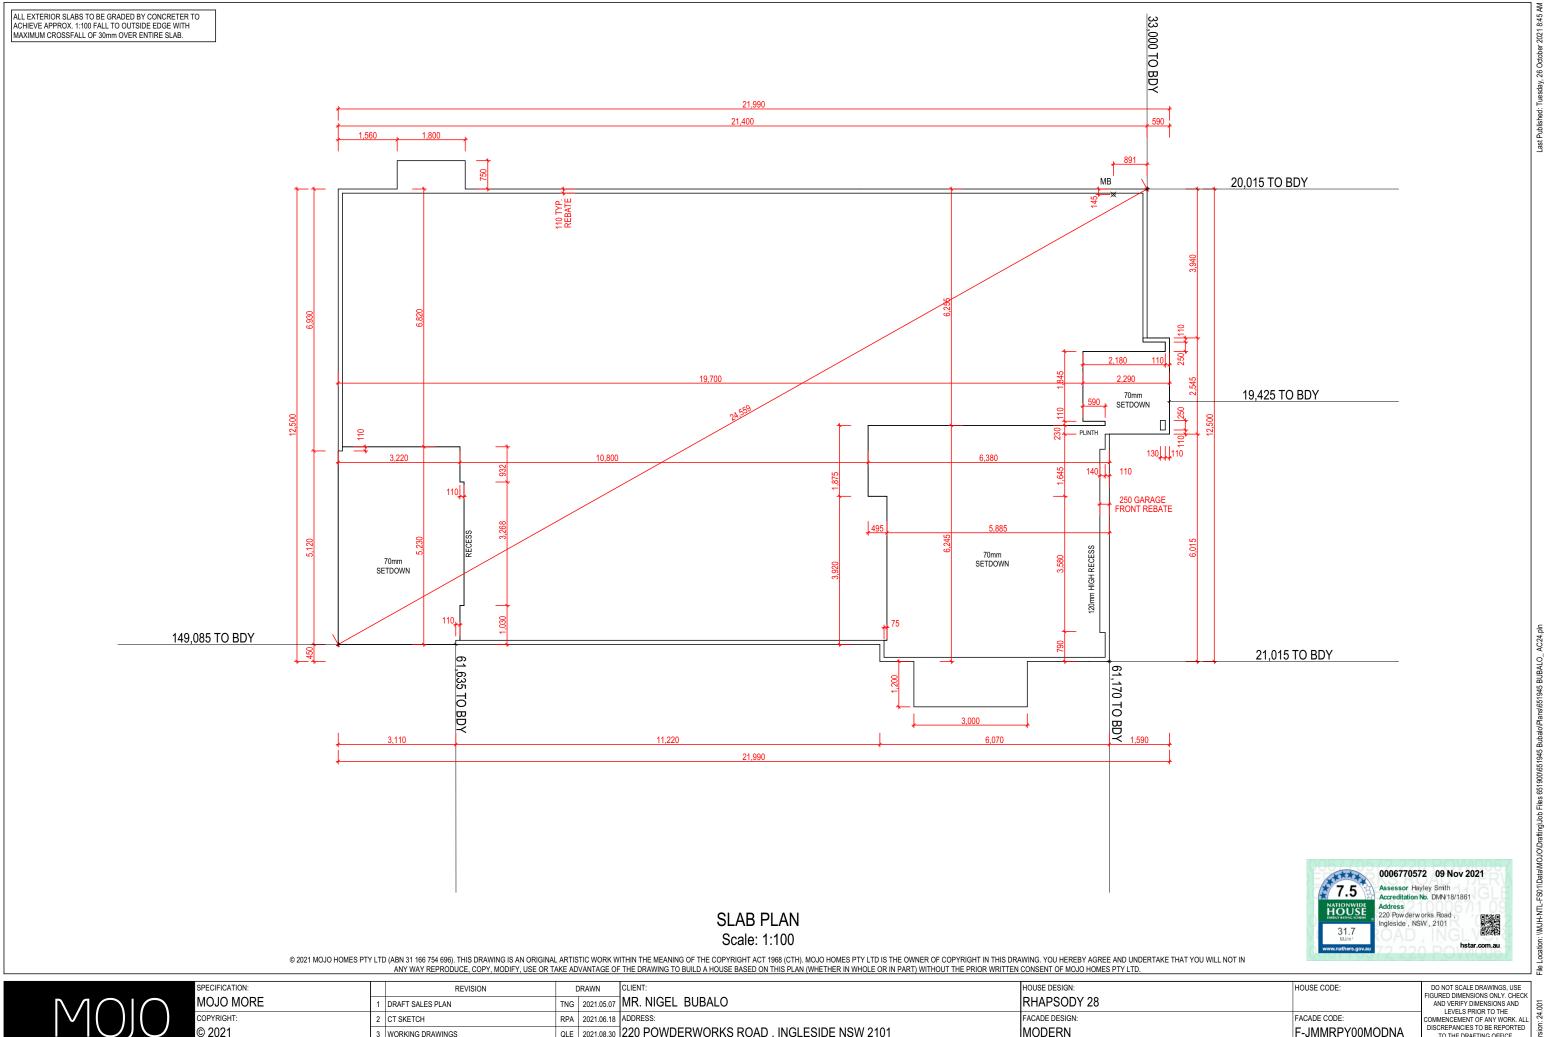
FLOOR COVERINGS Scale: 1:100



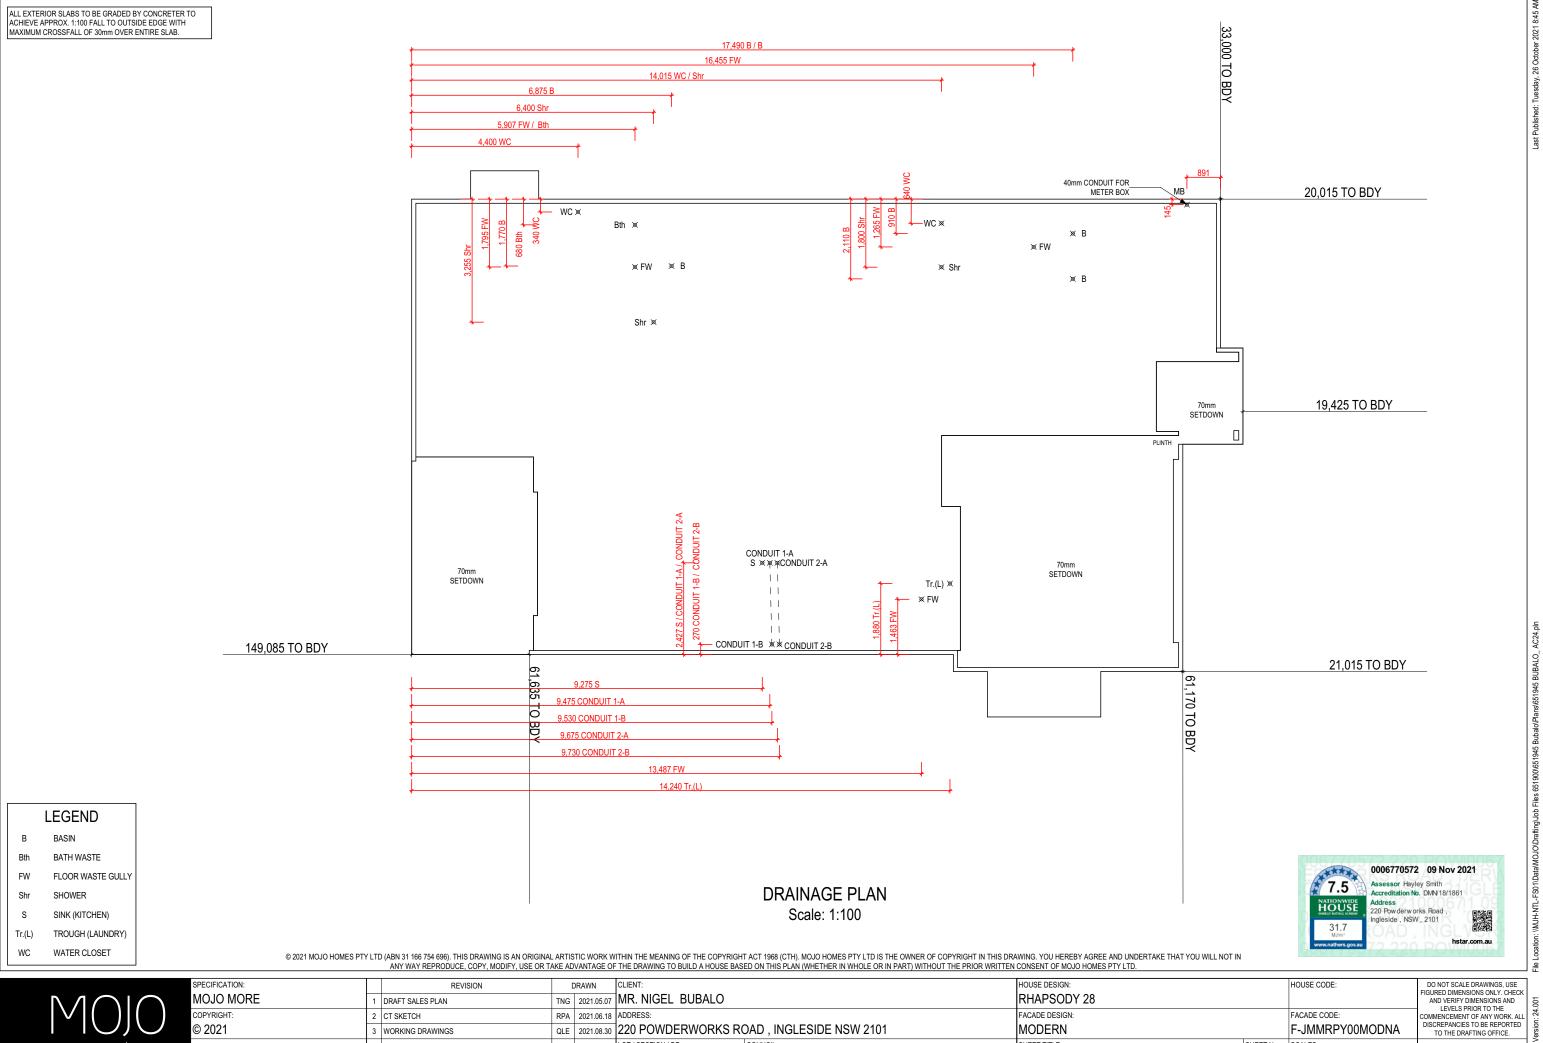
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SPECIFICATION: MOJO MORE	REVISION 1 DRAFT SALES PLAN		DRAWN CLIENT: 6 2021.05.07 MR. NIGEL BUBAL	0	HOUSE DESIGN: RHAPSODY 28		HOUSE CODE:	DO NOT SCALE DRAWINGS, USE FIGURED DIMENSIONS ONLY. CHECK AND VERIFY DIMENSIONS AND
COPYRIGHT:	2 CT SKETCH 3 WORKING DRAWINGS		A 2021.06.18 ADDRESS: E 2021.08.30 220 POWDERWOR	KS ROAD , INGLESIDE NSW 2101	FACADE DESIGN: MODERN		FACADE CODE: F-JMMRPY00MODNA	LEVELS PRIOR TO THE COMMENCEMENT OF ANY WORK. AL DISCREPANCIES TO BE REPORTED TO THE DRAFTING OFFICE.
	4 WORKING DRAWING CHECK	GBC	D 2021.10.26 LOT / SECTION / DP: 12 / - / 25143	COUNCIL: NORTHERN BEACHES COUNCIL	SHEET TITLE: FLOOR COVERINGS	SHEET No.: 15 / 17	SCALES: 1:100	651945



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