

ACTION PLANS

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DEVELOPMENT APPLICATION

THESE PLANS ARE FOR DEVELOPMENT APPROVAL ONLY.

ITEM DETAILS	DEVELOPMENT APPLICATION							
ADDRESS	63B NORFOLK AVENUE, COLLAROY, NSW 2	BB NORFOLK AVENUE, COLLAROY, NSW 2097						
LOT & DP/SP	LOT 1 SP 47589	OT 1 SP 47589						
COUNCIL	NORTHERN BEACHS COUNCIL (WARRINGA	H)						
SITE AREA	348.79m²							
FRONTAGE	9.19m							
CONTROLS	PERMISSIBLE / REQUIRED	EXISTING	PROPOSED	COMPLIANCE				
CONTROLS	m / m² / %	m / m² / %	m / m² / %					
<u>LEP</u>								
LAND ZONING	R2 – LOW DENSITY RESIDENTIAL	R2	R2	YES				
MINIMUM LOT SIZE	600m ²	348.79m²	UNCHANGED	YES				
FLOOR SPACE RATIO	NOT IDENTIFIED	N/A	N/A	N/A				
MAXIMUM BUILDING HEIGHT	8.5m	9.5m	UNCHANGED	YES				
<u>HAZARDS</u>								
DEVELOPMENT ON SLOPING LAND	IDENTIFIED – AREA D	N/A	N/A	N/A				
DCP								
WALL HEIGHT	7.2m	8.1m	UNCHANGED	NO				
NUMBER OF STOREYS	2	2	UNCHANGED	YES				
SIDE BOUNDARY ENVELOPE	4m	N/A	UNCHANGED	YES				
SIDE BOUNDARY SETBACKS	0.9m	N: 1.2m S: N/A	UNCHANGED UNCHANGED	YES YES				
FRONT BOUNDARY SETBACK	6.5m	10.1m	UNCHANGED	YES				
REAR BOUNDARY SETBACK	6.0m	8.9m	5.3m	NO				
LANDSCAPE OPEN SPACE	40% (139.516m²)	22% (78.43m²)	36% (124.78m²)	NO				
PRIVATE OPEN SPACE	60m²	113.86m²	UNCHANGED	YES				

SHEET NUMBER	SHEET NAME	DATE PUBLISHED
DA00	COVER	12/03/2020
DA01	NOTATION	12/03/2020
DA02	SITE ANALYSIS	12/03/2020
DA03	SITE / ROOF / SEDIMENT EROSION / WASTE MANAGEMENT / STORMWATER CONCEPT PLAN	12/03/2020
DA04	EXISTING GROUND FLOOR PLAN	12/03/2020
DA05	PROPOSED GROUND FLOOR PLAN	12/03/2020
DA06	EXISTING FIRST FLOOR PLAN	12/03/2020
DA07	PROPOSED FIRST FLOOR PLAN	12/03/2020
DA08	NORTH / EAST ELEVATION	12/03/2020
DA09	SOUTH / WEST ELEVATION	12/03/2020
DA10	LONG / CROSS SECTION	12/03/2020
DA11	AREA CALCULATIONS / SAMPLE BOARD	12/03/2020
DA12	WINTER SOLSTICE 9 AM	12/03/2020
DA13	WINTER SOLSTICE 12 PM	12/03/2020
DA14	WINTER SOLSTICE 3 PM	12/03/2020
DA15	POOL LONG / CROSS SECTION	12/03/2020
DA16	BASIX COMMITMENTS	12/03/2020

63B NORFOLK AVENUE, COLLAROY NSW 2097





NCC & AS COMPLIANCES SPECIFICATIONS

- EARTHWORKS PART 3.1.1 OF NCC
- EARTH RETAINING STRUCTURES PART 3.1.2 OF NCC
- DRAINAGE PART 3.1.3 OF NCC
- TERMITE-RISK MANAGEMENT PART 3.1.4 OF NCC
- FOOTINGS & SLAB PART 3.2 OF NCC INCLUDING AS2870
- MASONRY PART 3.3 OF NCC INCLUDING AS3700
- FRAMING PART 3.4 OF NCC
- SUB FLOOR VENTILATION PART 3.4.1 OF NCC
- ROOF CLADDING AND WALL-CLADDING PART 3.5 OF NCC
- GLAZING PART 3.6 OF NCC INCLUDING AS1288
- FIRE SAFETY PART 3.7 OF NCC
- FIRE SEPERATION PART 3.7.2 OF NCC
- FIRE PROTECTION OF SEPERATING WALLS AND FLOORS- PART 3.7.3 OF NCC
- SMOKE ALARMS PART 3.7.5 OF NCC
- WET AREAS AND EXTERNAL WATERPROOFING PART 3.8.1 OF NCC
- ROOM HEIGHTS PART 3.8.2 OF NCC
- FACILITIES PART 3.8.3 OF NCC
- LIGHT PART 3.8.4 OF NCC
- VENTILATION PART 3.8.5 OF NCC
- SOUND INSULATION PART 3.8.6 OF NCC
- STAIRWAYAND RAMP CONSTRUCTION PART 3.9.1 OF NCC
- BARRIERS AND HANDRAILS PART 3.9.2 OF NCC
- SWIMMING POOLS PART 3.10.1 OF NCC
- CONSTRUCTION IN BUSHFIRE PRONE AREAS PART 3.10.5 OF NCC
- FENCING & OTHER PROVISIONS REGS & AS1926
- DEMOLITION WORKS AS2601-1991 THE DEMOLITION OF STRUCTURES.
- ALL WATERPROOF MEMBRANES TO COMPLY WITH WITH AS 3740-2010
- ALL PLUMBING & DRAINAGE WORK TO COMPLY WITH AS 3500
- SITE CLASSIFICATION AS TO AS 2870
- ALL PLASTERBOARD WORK TO COMPLY WITH AS 2588-1998
- ALL STRUCTURAL STEEL WORK TO COMPLY WITH AS 4100 & AS 1554
- ALL CONCRETE WORK TO COMPLY WITH AS 3600
- ALL ROOF SHEETING WORK TO COMPLY WITH AS 1562-1992
- ALL SKYLIGHTS TO COMPLY WITH WITH AS 4285-2007
- ALL CERAMIC TILING TO COMPLY WITH AS 3958.1-2007 & 3958.2-1992
- ALL GLAZING ASSEMBLIES TO COMPLY WITH AS2047 & 1288
- ALL TIMBER RETAINING WALLS ARE TO COMPLY WITH AS 1720.1-2010,
- AS 1720.2-2006, AS 1720.4-2006, AS 1170.1-1989 & AS 1170.4-2007
 ALL RETAINING WALLS ARE TO COMPLY WITH 3700 2011 & AS 3600 -2009
- ALL CONSTRUCTION TO COMPLY TO AS3959- 2009

NOTES

- APPROVED MEANS BY THE 'RELEVANT LOCAL AUTHORITY' OR COUNCIL
- THE OWNER WILL DIRECTLY PAYTHE FEES ASSOCIATED WITH THE FOLLOWING:
- BUILDING APPROVAL FROM COUNCIL, FOOTPATH AND KERB DEPOSITS WITH THE LOCAL COUNCIL, INSURANCE FEE TO BUILDING SERVICES CORPORATION, LONG SERVICE LEAVE SERVICE LEVY FEE AND APPROVAL FEE BY WATER AND SEWERAGE AUTHORITY. ALL OTHER FEES ARE TO BE PAID BY THE BUILDER. THE AMOUNT OF ANY LOCAL AUTHORITY DEPOSITS WHICH ARE FORFEITED DUE TO DAMAGE OR OTHER CAUSE WILL BE DEDUCTED FROM THE PAYMENTS DUE TO THE BUILDER.
- THE BUILDER IS TO PROVIDE AT HIS/HER OWN EXPENSE ADEQUATE PUBLIC RISK INSURANCE AND ARRANGE INDEMNIFICATION UNDER THE WORKERS COMPENSATION ACT. WORKS INSURANCE TO BE STATED IN THE CONTRACT CONDITIONS.
- ALL WORK TO BE CARRIED OUT IN A TRADESMEN LIKE MANNER AND IN ACCORDANCE WITH THE STANDARDS CODES AND REGULATIONS OF THE STANDARDS ASSOCIATION OF AUSTRALIA, BUILDING CODE OF AUSTRALIA AND ANY STATUTORY AUTHORITY HAVING JURISDICTION OVER THE WORK.
- ALL TENDERERS ARE TO VISIT THE SITE TO SATISFY THEMSELVES AS TO THE NATURE AND EXTENT OF THE WORKS, FACILITIES AVAILABLE AND DIFFICULTIES ENTAILED IN THE WORKS AS VARIATIONS WILL NOT BE ALLOWED DUE TO WORK ARISING OWING TO NEGLECT OF THIS CLAUSE.
- ALL WORK AND MATERIALS TO COMPLY WITH THE CURRENT AUSTRALIAN STANDARDS AT THE TIME OF COMMENCEMENT WERE APPLICABLE.
- THESE DRAWINGS SHALL BE READ IN CONJUNCTION WITH ALL STRUCTURAL AND OTHER CONSULTANTS DRAWINGS AND SPECIFICATIONS AND WITH ANY SUCH WRITTEN INSTRUCTIONS AS MAY BE ISSUED DURING THE COURSE OF THE CONTRACT.
- SET OUT DIMENSIONS SHOWN ON THIS DRAWING SHALL BE VARIFIED BY THE BUILDER ON SITE BEFORE COMMENCEMENT OF ANY WORK. DIMENSIONS SHOULD NOT BE OBTAINED BY SCALING THE DRAWINGS. USE ONLY FIGURED DIMENSIONS. ALL DIMENSIONS ARE IN MILLIMETRES.
- THE BUILDER IS TO ENSURE ALL CONSTRUCTION. LEVELS AND OTHER ITEMS COMPLY WITH THE CONDITIONS OF THE BUILDING APPROVAL.
- THE BUILDER IS TO COMPLY WITH ALL ORDINANCES, LOCAL AUTHORITY REGULATIONS AND THE REQUIREMENTS OF ALL SERVICES SUPPLY AUTHORITIES HAVING JURISDICTION OVER THE WORKS.
- ALL PLUMBING AND DRAINAGE WORK TO BE INSTALLED AND COMPLETED BY A LICENCED TRADESMAN AND IN ACCORDANCE WITH THE STATUTORY BODY HAVING AUTHORITY OVER THE WORKS. CONNECT ALL WASTE TO SYDNEY WATER SEWER LINE
- ALL NEW DOWNPIPES ARE TO BE CONNECTED TO THE EXISTING STORM WATER SYSTEM.
- ALL POWER AND STORMWATER OUTLET LOCATIONS SHALL BE DETERMINED ONSITE BY THE OWNER.
- SMOKE DETECTOR ALARM TO BE INSTALLED IN ACCORDANCE WITH AS3786 AND THE BUILDING CODE OF AUSTRALIA.
- ELECTRICAL WORK TO BE IN ACCORDANCE WITH SAA WIRING RULES AND BE DONE BY A LICENCED TRADESMAN
- ANY DETAILING IN ADDITION TO WHAT IS SUPPLIED SHALL BE RESOLVED BETWEEN THE OWNER AND THE BUILDER TO THE OWNERS APPROVAL, EXCEPT FOR ANY STRUCTURAL DETAILS OR DESIGN WHICH IS SUPPLIED BY THE ENGINEER.
- ALL TIMBER SIZES AND CONCRETE DETAILS TO BE CONFIRMED BY THE BUILDER PRIOR TO COMMENCEMENT OF ANY WORK.
- ALL STRUCTURAL WORK IS TO BE IN ACCORDANCE WITH THE STRUCTURAL DETAILS PREPARED BY A STRUCTURAL ENGINEER (i.e.) PIERS, FOOTINGS, CONCRETE SLABS, RETAINING WALLS, STEELWORK, FORMWORK, UNDERPINNING, ADDITIONAL STRUCTURAL LOADS, TIMBER FRAMING, WIND BRACING AND ASSOCIATED CONNECTIONS. BUILDER TO OBTAIN PRIOR TO FINALISING TENDER.
- ANY WORK INDICATED ON THE PLANS BUT NOT SPECIFIED, AND ANY ITEM NOT SHOWN ON THE PLAN WHICH IS OBVIOUSLY NECESSARY AS A PART OF CONSTRUCTION AND/OR FINISH IS TO BE CONSIDERED AS SHOWN AND SPECIFIED, AND IS TO BE DONE AS PART OF THE CONTRACT. VARIATIONS WILL NOT BE PERMITTED WITHOUT THE WRITTEN CONSENT OF THE OWNER.
- THE BUILDER SHALL PROVIDE SEDIMENT AND SILTRATION CONTROL MEASURES AS REQUIRED BY COUNCIL AND MAINTAIN THEM THROUGH THE DURATION OF THE WORKS.
- A LEGIBLE COPY OF THE PLANS BEARING APPROVAL STAMPS MUST BE MAINTAINED ON THE JOB AT ALL TIMES. HOURS OF CONSTRUCTION WILL BE RESTRICTED TO THE TIMES AS REQUIRED BY THE BUILDING APPROVAL.
- THE BUILDER IS TO ARRANGE FOR ALL INSPECTIONS REQUIRED BY THE AUTHORITIES AND LENDING INSTITUTIONS TO THEIR REQUIREMENTS.
- THE BUILDER IS TO OBTAIN APPROVAL FOR INTERUPTIONS TO EXISTING SERVICES AND MINIMISE THE DURATION AND NUMBER OF INTERUPTIONS. ANY INTERRUPTIONS WITH EXISTING SERVICES AND EQUIPMENT TO BE ATTENDED TO BY THE APPROPRIATELY SKILLED TRADESMEN.
- THE BUILDER SHALL RESTORE, REINSTATE OR REPLACE ANY DAMAGE CAUSED TO EXISTING STRUCTURES OR LANDSCAPING BY CONSTRUCTION WORK OR WORKMEN. PROVIDE PROTECTION TO EXISTING TREES TO REMAIN AS REQUIRED BY APPROVAL CONDITIONS.
- ALL BRICKWORK IS TO BE SELECTED BY OWNER AND IS TO COMPLY WITH AS1640
- ALL MASONRY TO COMPLY WITH AS3700
- ALL METALWORK AND FLASHING ITEMS NECESSARY TO SATISFACTORY COMLPETE WORK SHALL BE PROVIDED.
- ALL GUTTERS, DOWNPIPES TO BE COLORBOND.
- ALL TIMBER CONSTRUCTION TO BE IN ACCORDANCE WITH THE AUSTRALIAN STANDARD 1684 "TIMBER FRAMING CODE"
- ALL GLAZING INSTALLED TO COMPLY WITH AS1288, 2047 AND IN ACCORDANCE WITH MANUFACTURERS RECOMMENDATION
- ALL WALL AND CEILING LININGS TO BE PLASTERBOARD OR CEMENT RENDER AS SELECTED AND VILLA BOARD IN WET AREAS, TO COMPLY WITH THE RELEVANT AUSTRALIAN STANDARDS OR INSTALLED IN ACCORDANCE WITH MANUFACTURERS SPECIFICATION.
- ALL BATHROOMS AND WET AREAS TO BE ADEQUATELY WATERPROOFED TO MANUFACTURERS SPECIFATION AND AS3740 AND PART 3.8.1 OF THE BUILDING CODE OF AUSTRALIA HOUSING PROVISIONS
- STAIRS AND BALUSTRADES TO COMPLYWITH PART 3.9.1 & 3.9.2 OF THE BUILDING CODE OF AUSTRALIA HOUSING PROVISION.
- TERMITE PROTECTION MEASURES TO COMPLY WITH AS 3660 AND BE INSTALLED TO MANUFACTURERS SPECIFICATION.
- ANY DETAILING ADDITIONAL TO THAT SUPPLIED, SHALL BE RESOLVED BETWEEN THE OWNER AND THE BUILDER TO THE OWNERS APPROVAL. EXCEPT FOR ANY STRUCTURAL DETAILS OR DESIGN WHICH IS TO BE SUPPLIED BY THE STRUCTURAL ENGINEER.

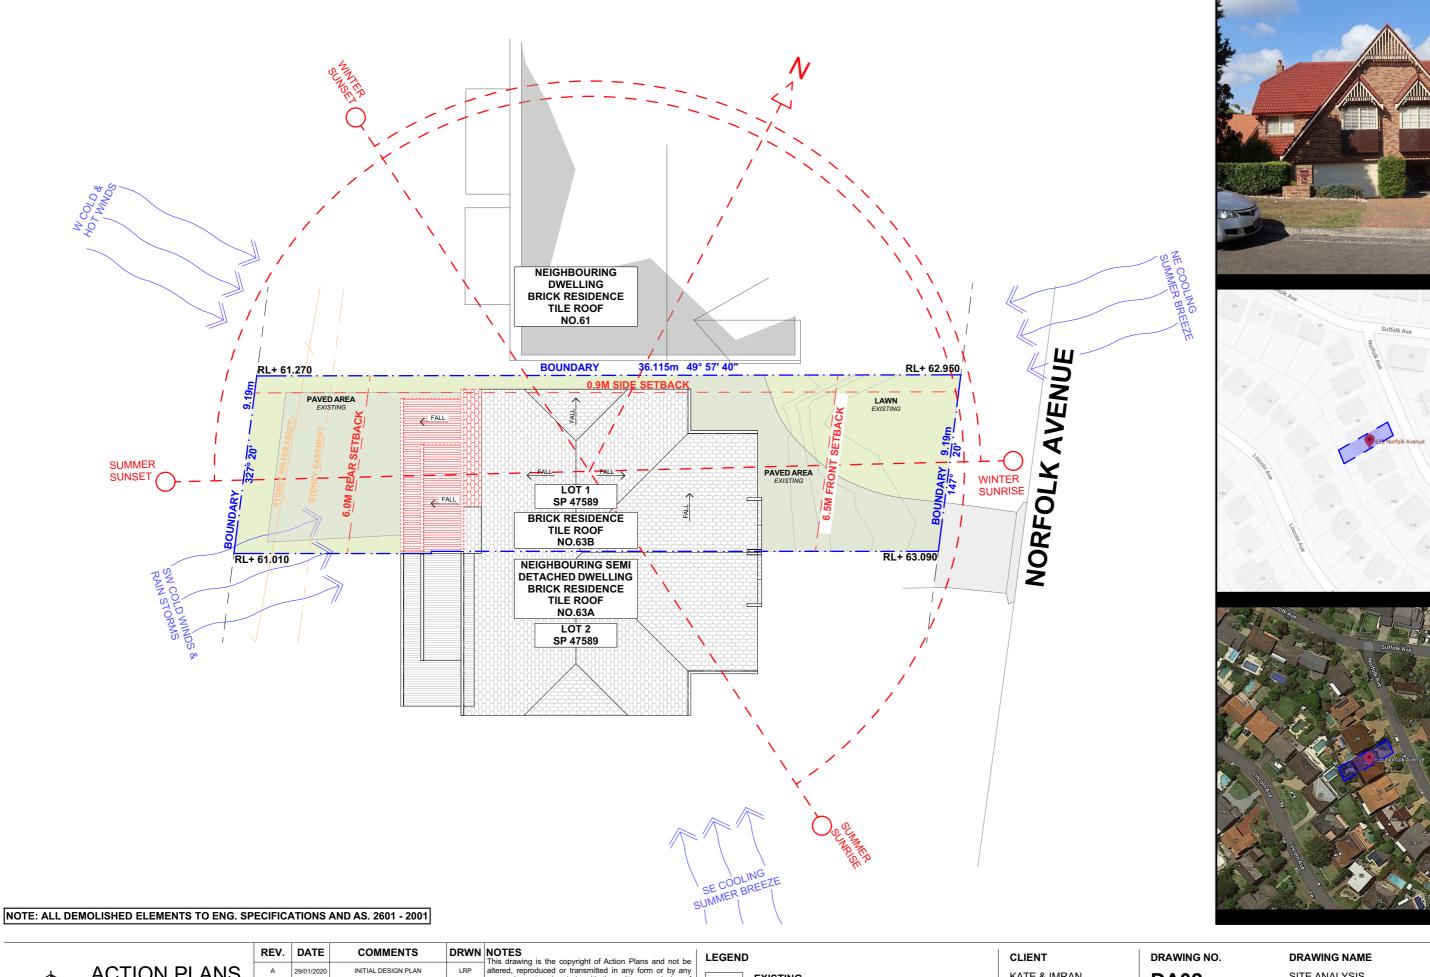

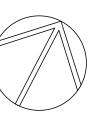

AERIAL MAP

STREET VIEW

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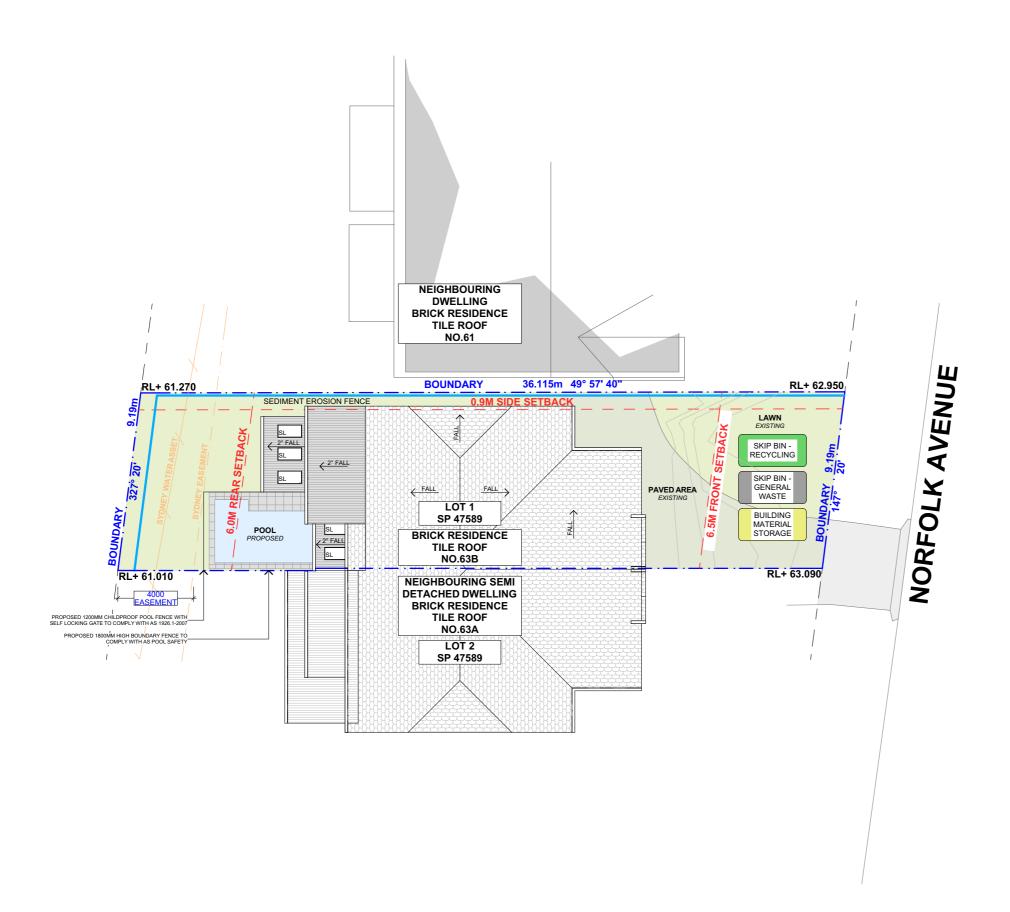
KATE & IMRAN MASOOD

PROJECT ADDRESS 63B NORFOLK AVENUE, COLLAROY NSW 2097 **DA02**

DATE

SITE ANALYSIS

Thursday, 12 March 2020




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63B NORFOLK AVENUE, COLLAROY NSW 2097

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DA03

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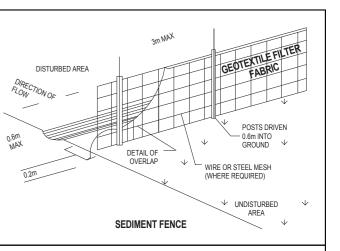
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DRAWING NAME

SITE / ROOF / SEDIMENT EROSION / WASTE MANAGEMENT / STORMWATER CONCEPT PLAN

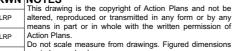SCALE

1:200 @A3



DUST CONTROL:

TO REDUCE DUST GENERATED BY WIND ACTION, THE REMOVAL OF THE TOP SOIL IS TO BE MINIMISED. TO PREVENT DUST GENERATION, WATERING DOWN OF THE SITE, ESPECIALLY DURING THE MOVEMENT OF MACHINERY IS REQUIRED. WHERE EXCAVATING INTO ROCK, KEEP THE SURFACE MOIST TO MINIMISE DUST. CONSTRUCT A GRAVEL ENTRY/EXIT POINT USING BLUE METAL AND RESTRICT ALL VEHICLE MOVEMENTS WITHIN THE SITE TO A MINIMUM. ENSURE WIND BREAKS, SUCH AS EXISTING FENCES ARE MAINTAINED DURING THE CONSTRUCTION PHASE UNTIL NEW LANDSCAPING IS PROVIDED OR REINSTATED. PREVENT DUST BY COVERING STOCKPILES

SEDIMENT NOTE:

- 1. ALL EROSION AND SEDIMENT CONTROL MEASURES
 TO BE INSPECTED AND MAINTAINED DAILY BY THE SITE
 MANAGER.
- 2. MINIMISE DISTURBED AREAS, REMOVE EXCESS SOIL FROM EXCAVATEDAREA AS SOON AS POSSIBLE.
 3. ALL MATERIAL STOCKPILE TO BE CLEAR FROM DRAINS, GUTTERS AND FOOTPATHS, OR WITHIN SEDIMENT FENCE AREA.
- 4. DRAINAGE TO BE CONNECTED TO STORMWATER AS SOON AS POSSIBLE. IF STORED ON SITE, IT MUST BE FILTERED BEFORE RELEASING INTO STORMWATER SYSTEM OR WATERWAYS.
- 5. ROADS AND FOOTPATHS TO BE SWEPT DAILY.

STOCKPILES:

ALL STOCKPILES ARE TO BE KEPT ON-SITE WHERE POSSIBLE. ANY MATERIALS PLACED ON THE FOOTPATHS OR NATURE STRIPS REQUIRE COUNCIL'S PERMISSION.

ALL STOCKPILES ARE TO BE PLACED AWAY FROM THE DRAINAGE LINES AND STREET GUTTERS. IT IS BEST TO LOCATE THESE ON THE HIGHEST PART OF THE SITE IF POSSIBLE. PLACE WATERPROOF COVERING OVER STOCKPILES.


IF REQUIRED PROVIDE DIVERSION DRAIN & BANK AROUND STOCKPILES.

GUTTER PROTECTION:

PROVIDE PROTECTION TO DOWNHILL GRATE IN GUTTER BY MEANS OF SAND BAGS OR BLUE METAL WRAPPED IN GEOTEXTILE FABRIC. WHEN SOIL OR SAND BUILDS UP AROUND THIS SEDIMENT BARRIER, THE MATERIAL SHOULD BE RELOCATED BACK TO THE SITE FOR DISPOSAL.

NOTE: ALL PROPOSED STORMWATER TO CONNECT WITH EXISTING



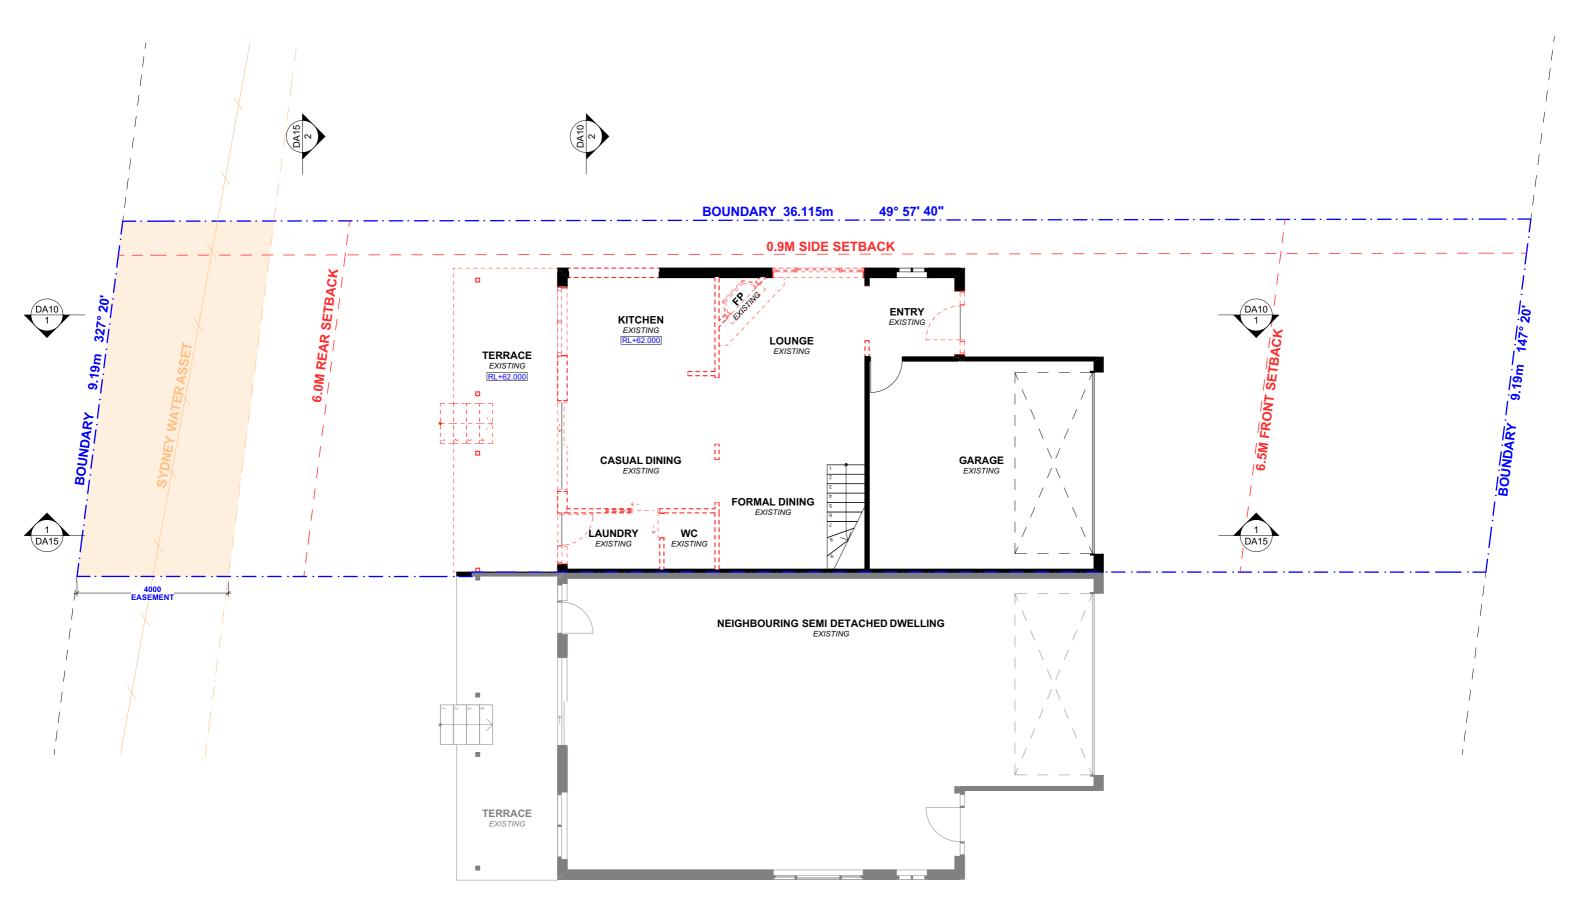

NOTE: ALL DEMOLISHED ELEMENTS TO ENG. SPECIFICATIONS AND AS. 2601 - 2001



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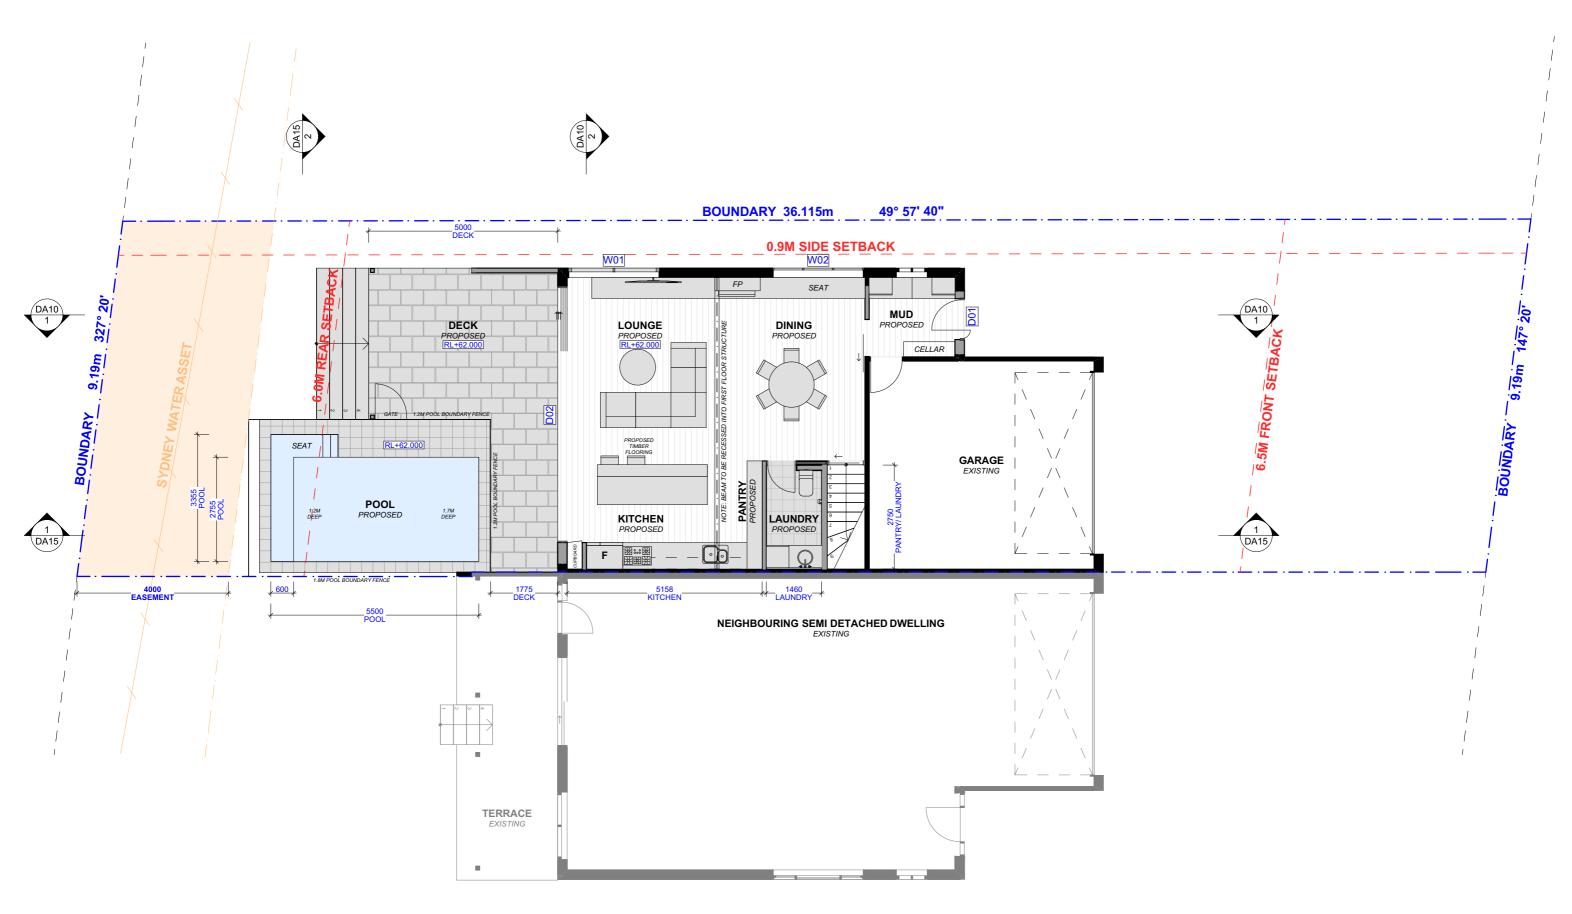
CLIENT KATE & IMRAN MASOOD

PROJECT ADDRESS 63B NORFOLK AVENUE, COLLAROY NSW 2097 DA04

DATE

DATE Thursday, 12 March 2020 DRAWING NAME
EXISTING GROUND FLOOR
PLAN






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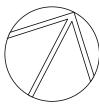
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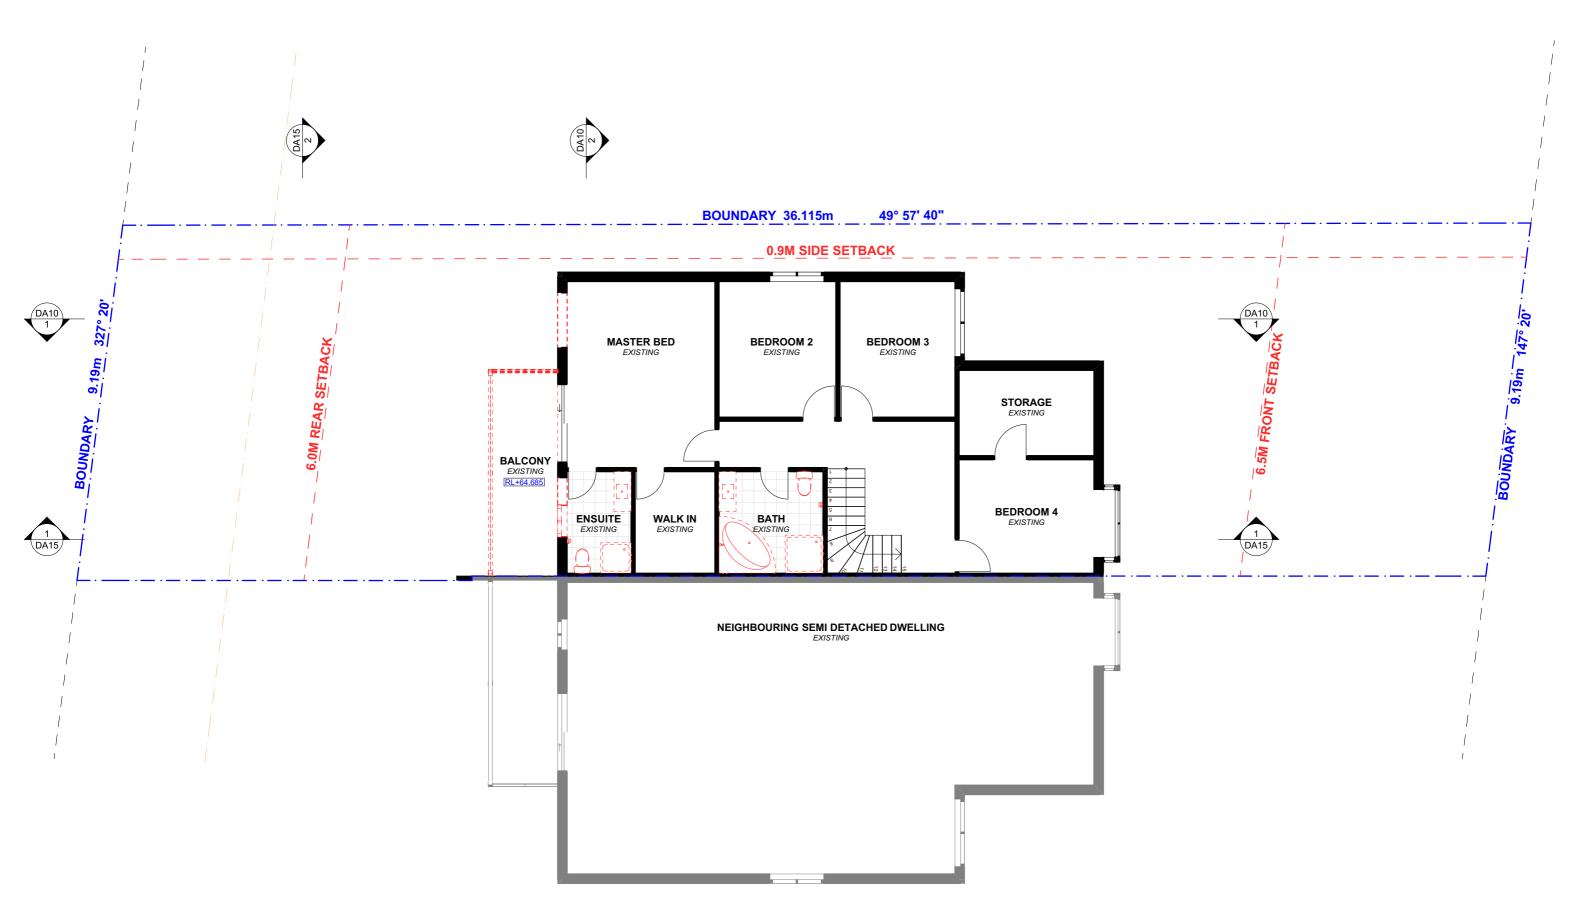
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PROPOSED GROUND FLOOR PLAN





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63B NORFOLK

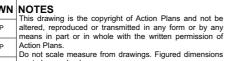PROJECT ADDRESS AVENUE, COLLAROY NSW 2097

DRAWING NO.

DA06

DATE

Thursday, 12 March 2020


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EXISTING FIRST FLOOR PLAN

SCALE

1:100 @A3





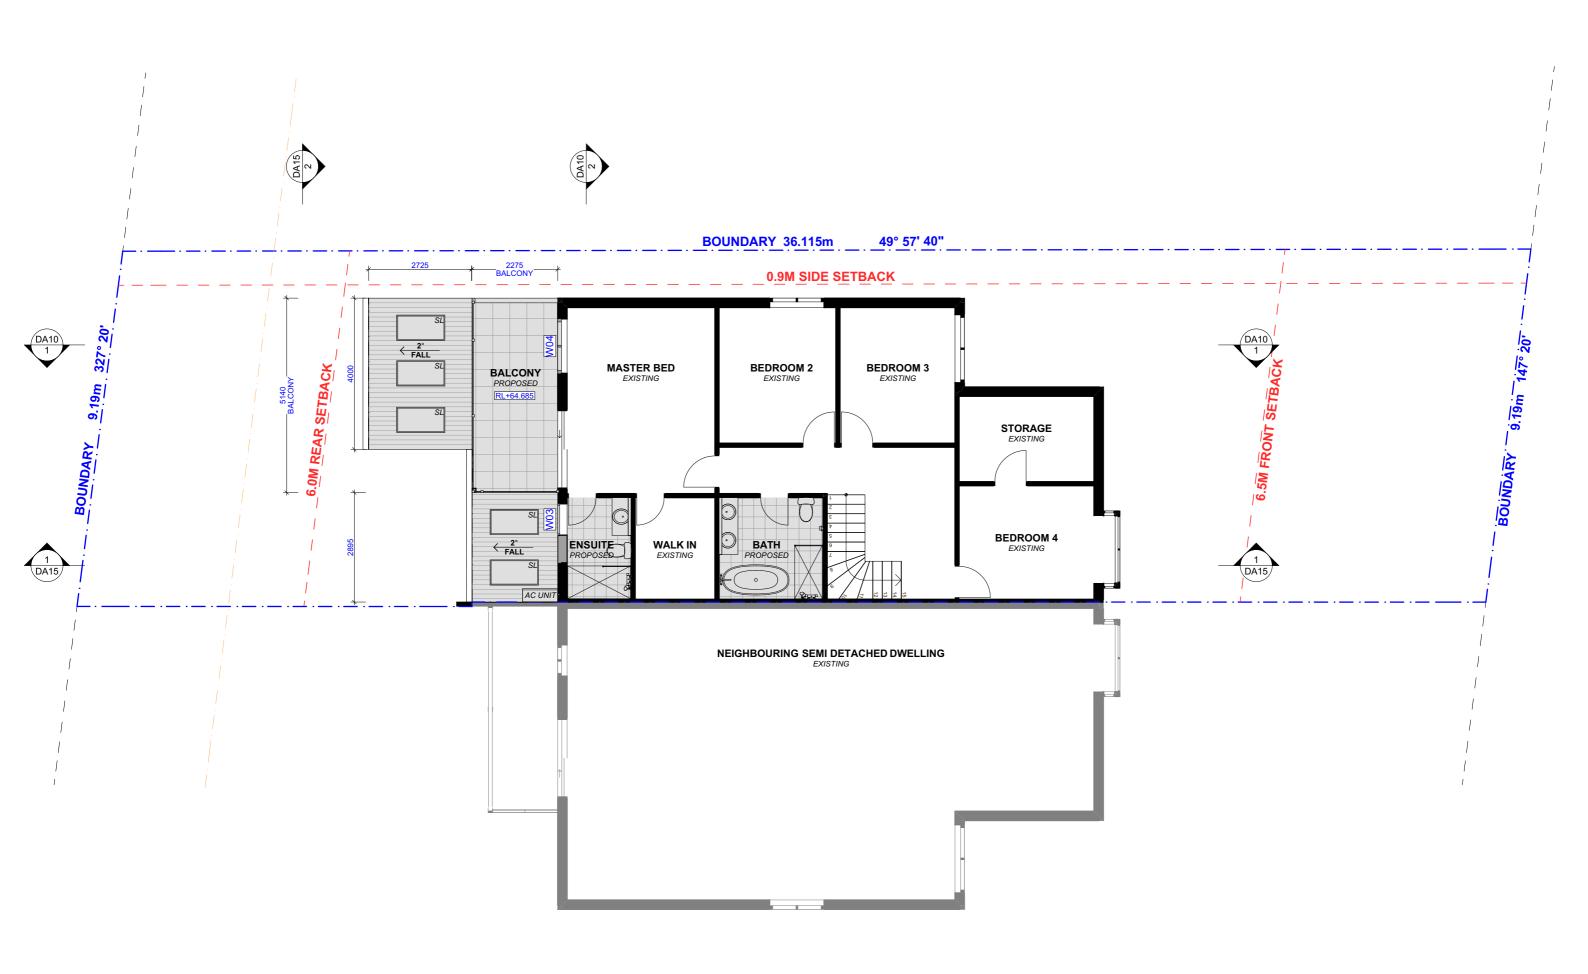

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NSW 2097

PROJECT ADDRESS 63B NORFOLK AVENUE, COLLAROY

2020

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DA07 PLAN

DATE

Thursday, 12 March


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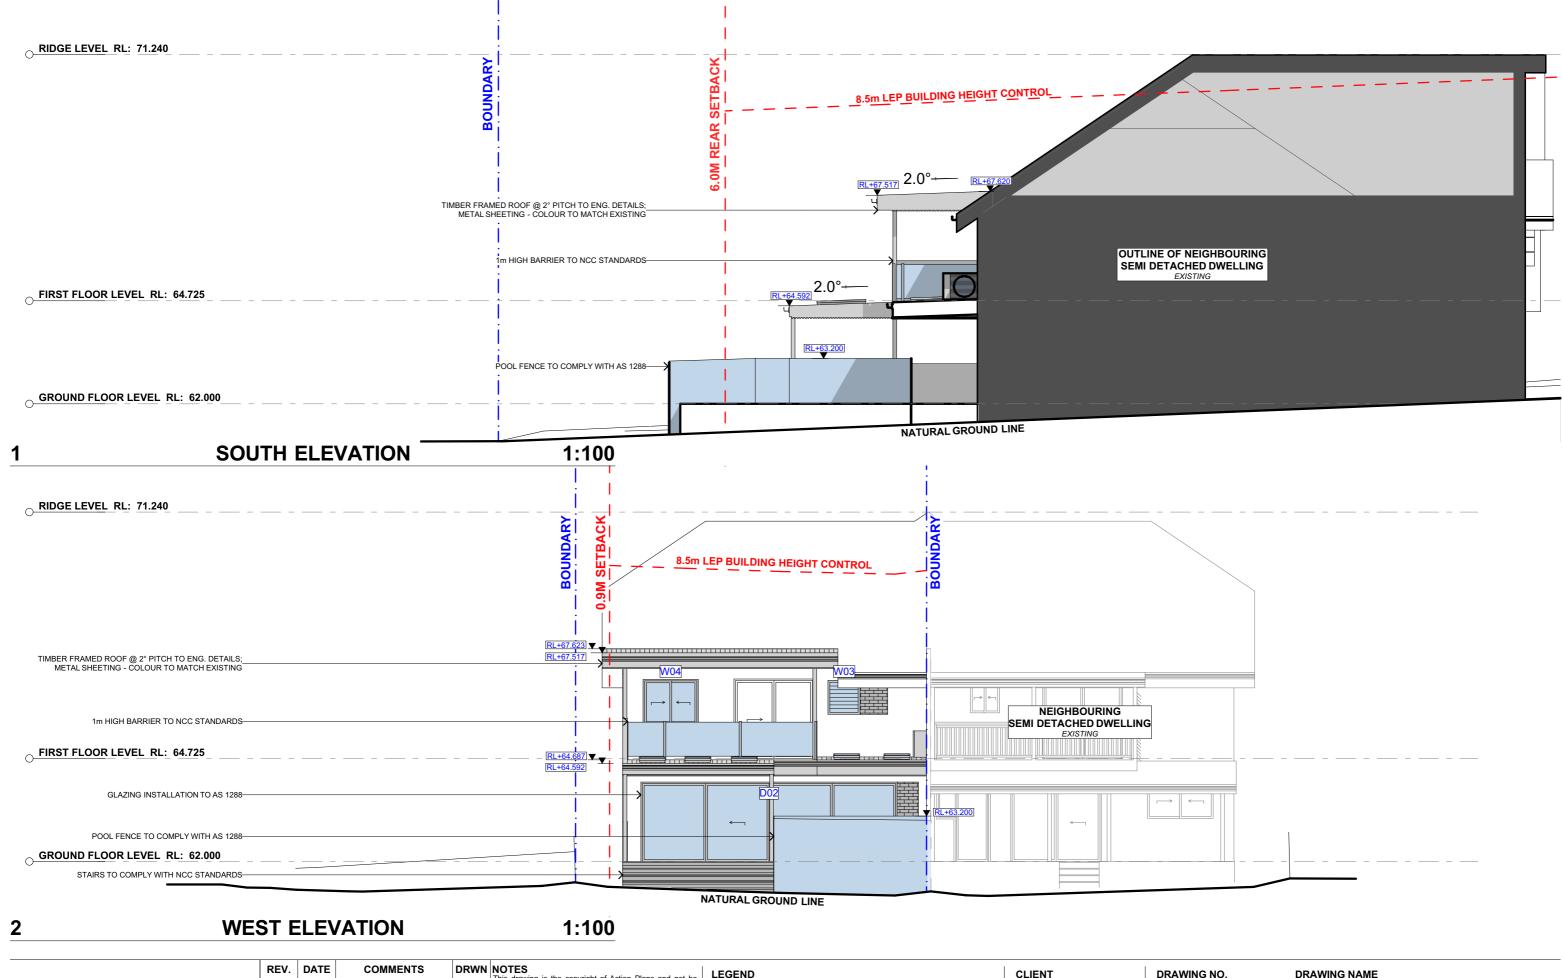
PROPOSED FIRST FLOOR

SCALE

1:100 @A3







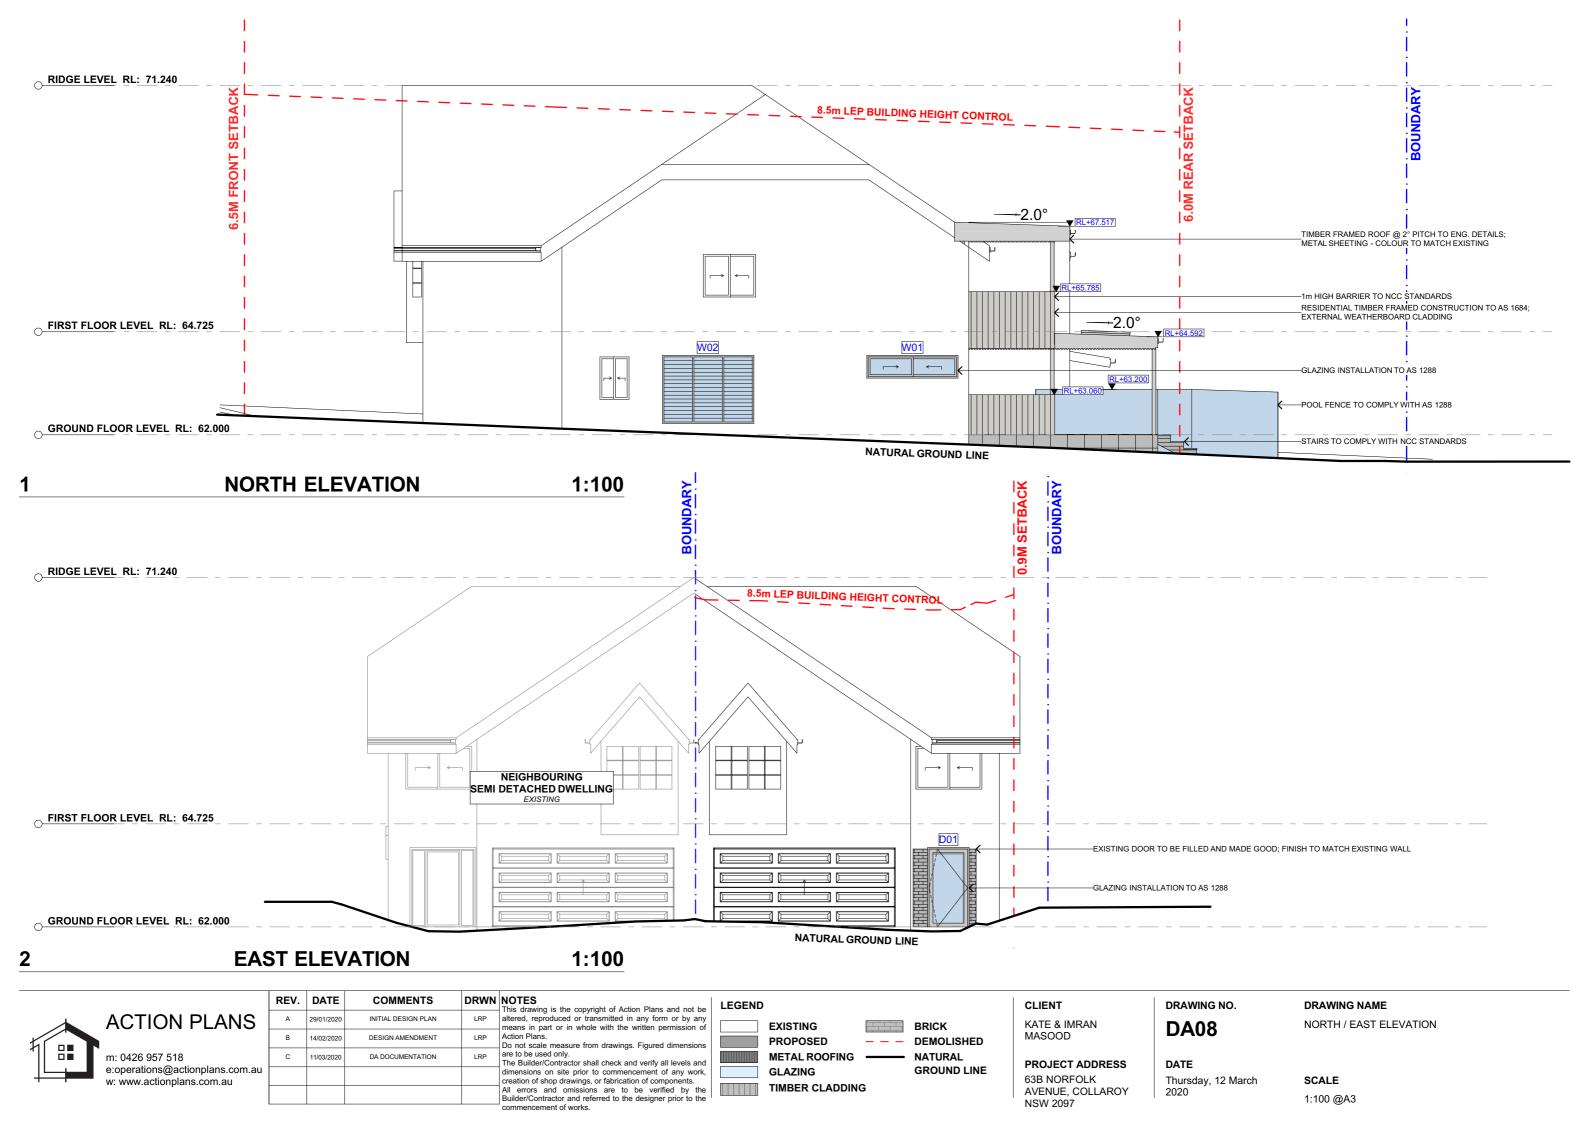

CLIENT DRAWING NO. LEGEND DRAWING NAME This drawing is the copyright of Action Plans and not be altered, reproduced or transmitted in any form or by any **ACTION PLANS** INITIAL DESIGN PLAN 29/01/2020 KATE & IMRAN SOUTH / WEST ELEVATION **EXISTING** BRICK **DA09** means in part or in whole with the written permission of Action Plans. MASOOD DESIGN AMENDMENT 14/02/2020 PROPOSED DEMOLISHED Do not scale measure from drawings. Figured dimension are to be used only.
The Builder/Contractor shall check and verify all levels and METAL ROOFING -NATURAL m: 0426 957 518 DA DOCUMENTATION 11/03/2020 PROJECT ADDRESS DATE e:operations@actionplans.com.au GLAZING **GROUND LINE** dimensions on site prior to commencement of any work, 63B NORFOLK creation of shop drawings, or fabrication of components.

All errors and omissions are to be verified by the Builder/Contractor and referred to the designer prior to the Thursday, 12 March **SCALE** w: www.actionplans.com.au TIMBER CLADDING AVENUE, COLLAROY 2020 1:100 @A3 NSW 2097 commencement of works.

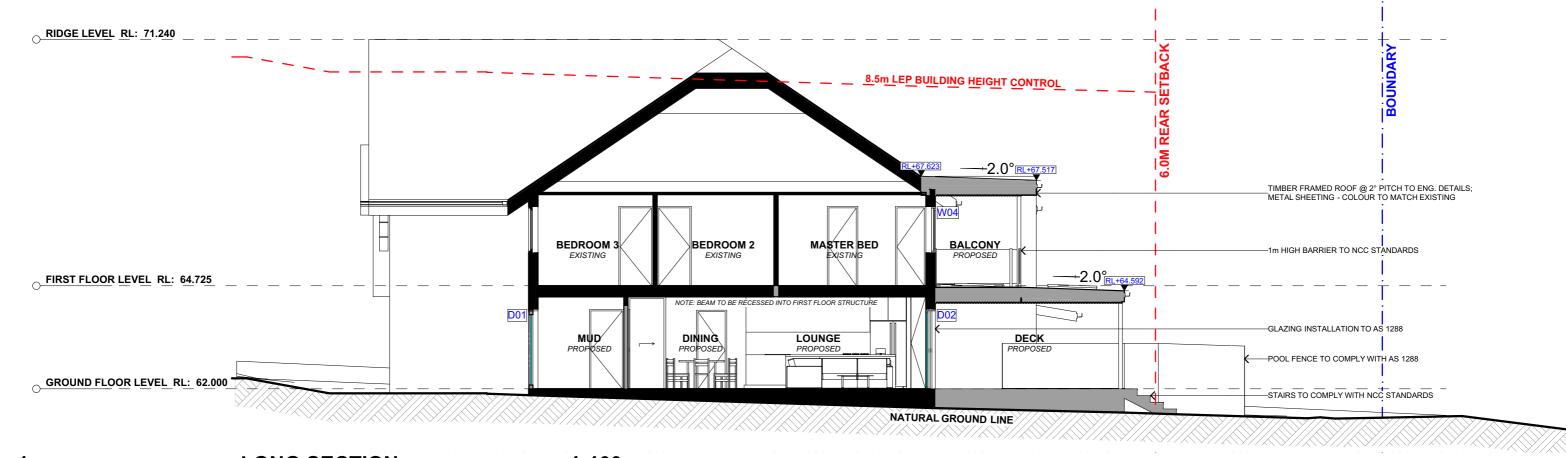

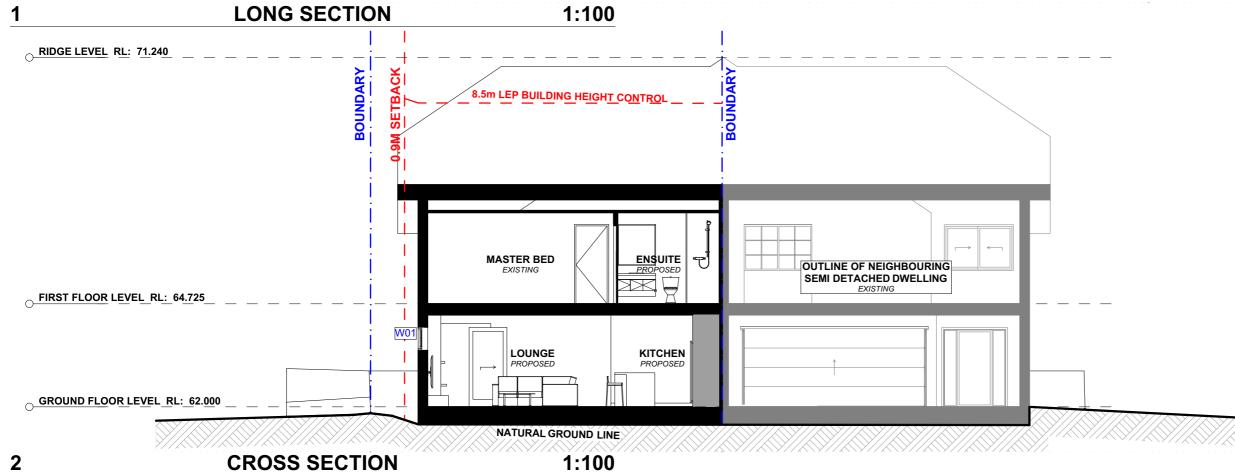

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					All errors and omissions are to be verified by the Builder/Contractor and referred to the designer prior to the



CLIENT
KATE & IMRAN MASOOD

PROJECT ADDRESS	
33B NORFOLK	
AVENUE, COLLAROY	

DRAWING NO.	
DA10	


LONG / CROSS SECTION

DRAWING NAME

DATE	
Thursday,	12

2020

arch SC

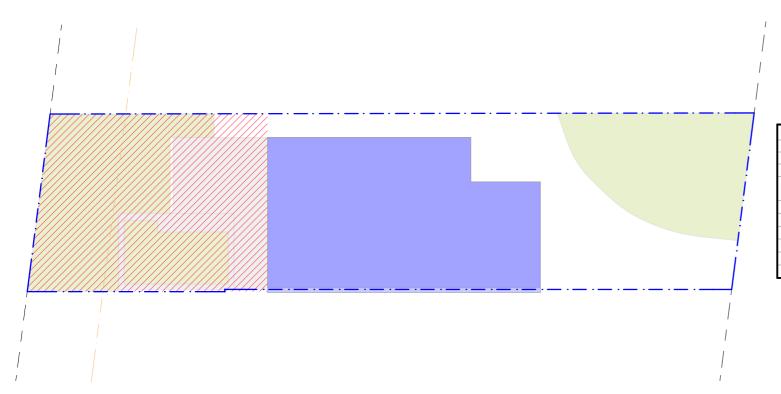

ITEM DETAILS	DEVELOPMENT APPLICATION					
ADDRESS	63B NORFOLK AVENUE, COLLAROY, NSW	3B NORFOLK AVENUE, COLLAROY, NSW 2097				
LOT & DP/SP	LOT 1 SP 47589					
COUNCIL	NORTHERN BEACHS COUNCIL (WARRING	AH)				
CONTROLS	PERMISSIBLE / REQUIRED	EXISTING	PROPOSED	COMPLIANCE		
CONTROLS	m / m² / %	m / m² / %	m / m² / %			
LEP						
LAND ZONING	R2 – LOW DENSITY RESIDENTIAL	R2	R2	YES		
MINIMUM LOT SIZE	600m²	348.79m²	UNCHANGED	YES		
FLOOR SPACE RATIO	NOT IDENTIFIED	N/A	N/A	N/A		
LANDSCAPE OPEN SPACE	40% (139.516m²)	22% (78.43m²)	36% (124.78m²)	NO		
PRIVATE OPEN SPACE	60m²	113.86m²	UNCHANGED	YES		

PROPOSED AREA CALCULATIONS 1:200





PAINTED COLOURBOND METAL ROOF SHEETING.
IRONSTONE' OR SIMILAR
WHERE MARKED ON ELEVATION.





VERTICAL TIMBER PANEL WITH PLASTER. POWDER COATED FINISH. WHERE MARKED ON ELEVATION.



ALUMINIUM SLIDING DOOR.
POWDER COATED FINISH. 'CHARCOAL' OR SIMILAR
WHERE MARKED ON ELEVATION.

SAMPLE BOARD

ACTION PLANS

2

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	С	11/03/2020	DA DOCUMENTATION	LRP	are to be used only. The Builder/Contractor shall check and verify all levels and
au					dimensions on site prior to commencement of any work, creation of shop drawings, or fabrication of components.
					All errors and omissions are to be verified by the Builder/Contractor and referred to the designer prior to the commencement of works.

LEGEND



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KATE & IMRAN MASOOD

PROJECT ADDRESS

63B NORFOLK AVENUE, COLLAROY NSW 2097

DRAWING NO.

DA11

AREA CALCULATIONS / SAMPLE BOARD


1:200 @A3


DATE

Thursday, 12 March 2020

DRAWING NAME

SCALE

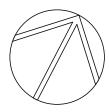

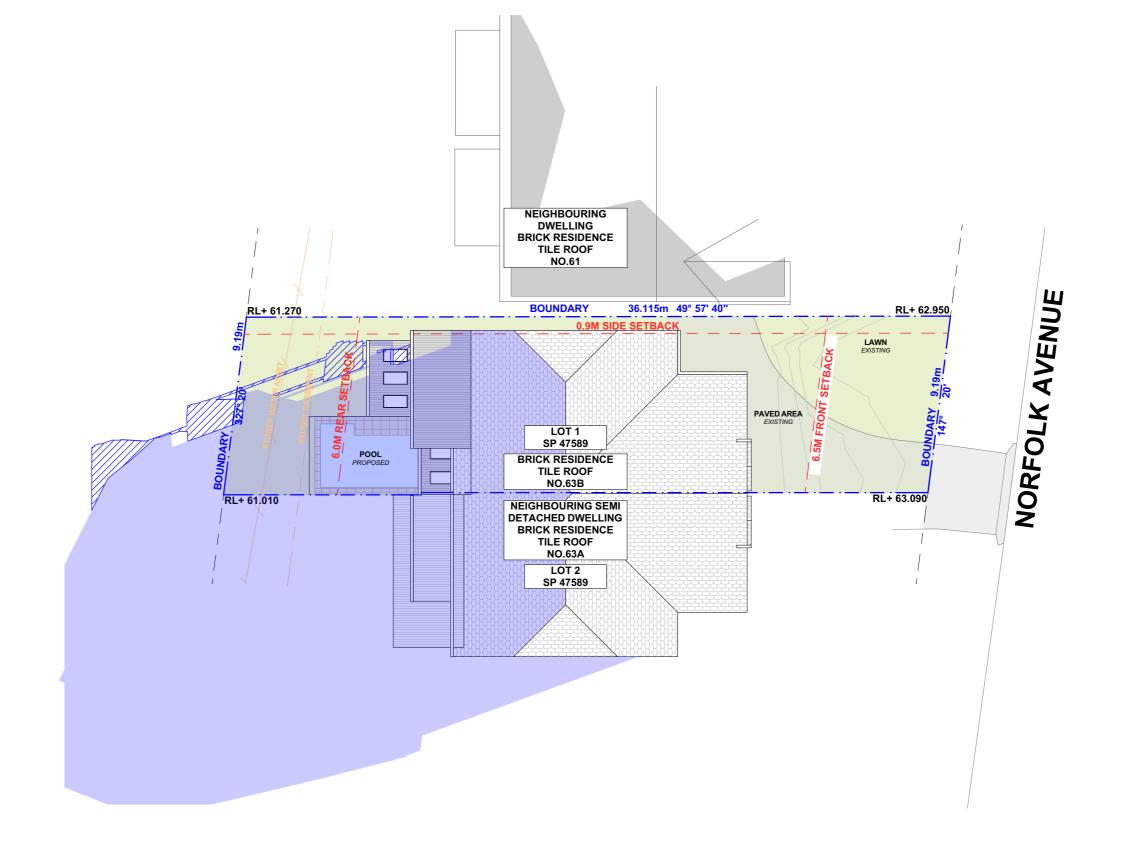



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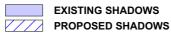


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ntractor shall check and verify all levels and site prior to commencement of any work, p drawings, or fabrication of components.

d omissions are to be verified by the stor and referred to the designer prior to the stof works.

LEGEND



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KATE & IMRAN MASOOD

PROJECT ADDRESS 63B NORFOLK AVENUE, COLLAROY NSW 2097 DRAWING NO.


DA12


DATE

Thursday, 12 March 2020

DRAWING NAME

WINTER SOLSTICE 9 AM

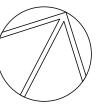

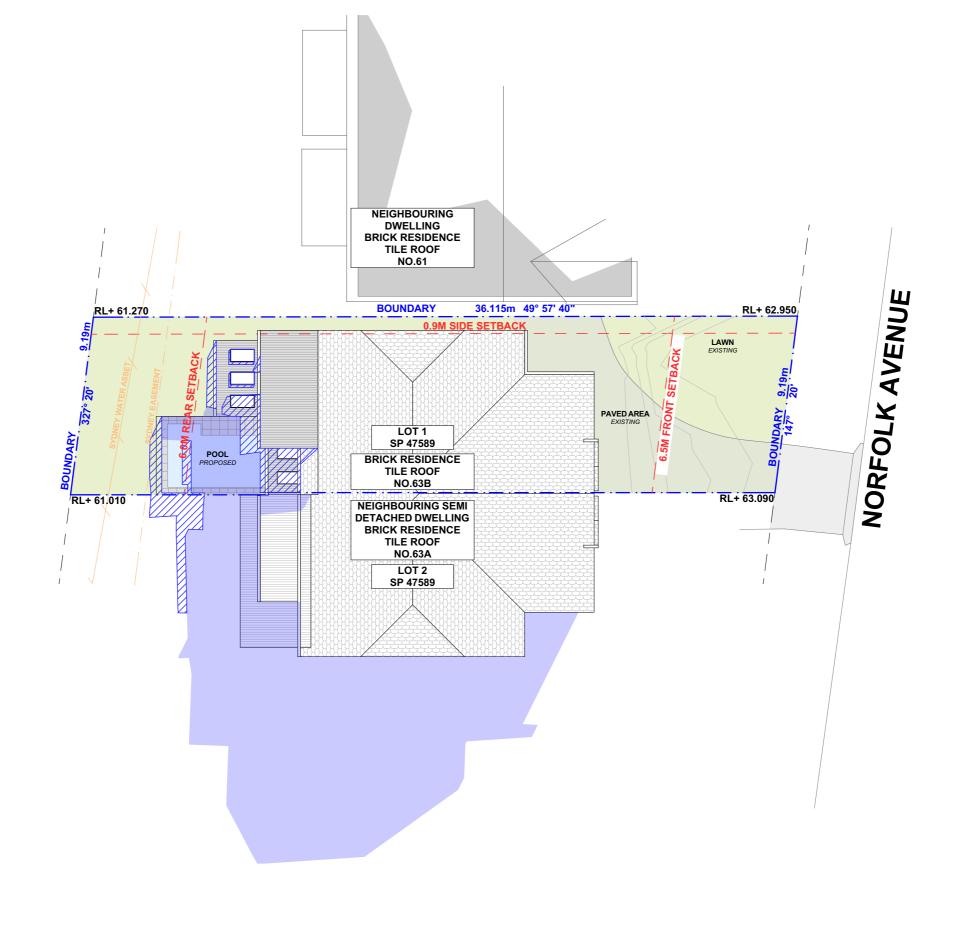




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				commencement of works.



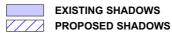

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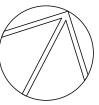
KATE & IMRAN MASOOD


PROJECT ADDRESS 63B NORFOLK AVENUE, COLLAROY NSW 2097 DRAWING NO.

DA13

DATE Thursday, 12 March 2020 WINTER SOLSTICE 12 PM

DRAWING NAME




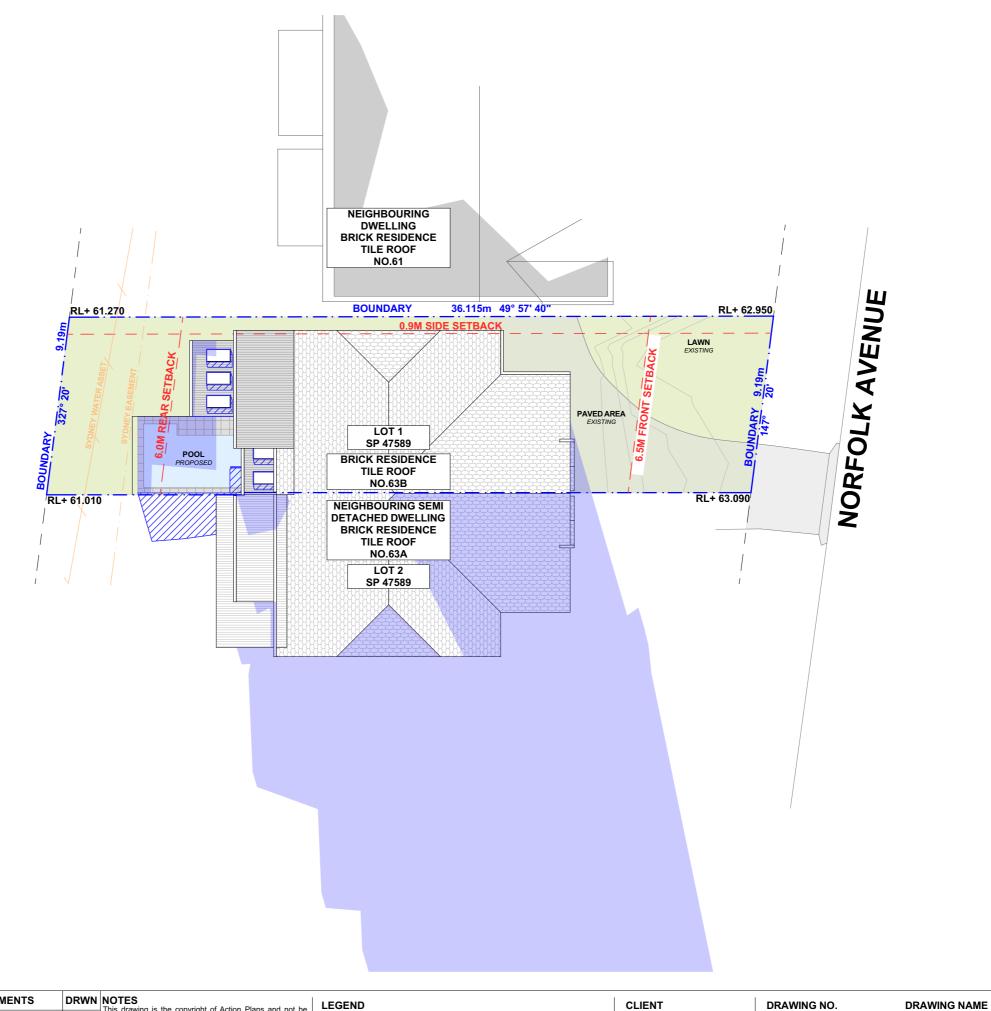



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В	14/02/2020	DESIGN AMENDMENT	LRP	Action Plans. Do not scale measure from drawings. Figured dimensions
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KATE & IMRAN MASOOD

PROJECT ADDRESS 63B NORFOLK AVENUE, COLLAROY NSW 2097 DRAWING NO.

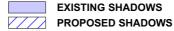Thursday, 12 March 2020


DA14


DATE

SCALE 1:200 @A3

WINTER SOLSTICE 3 PM



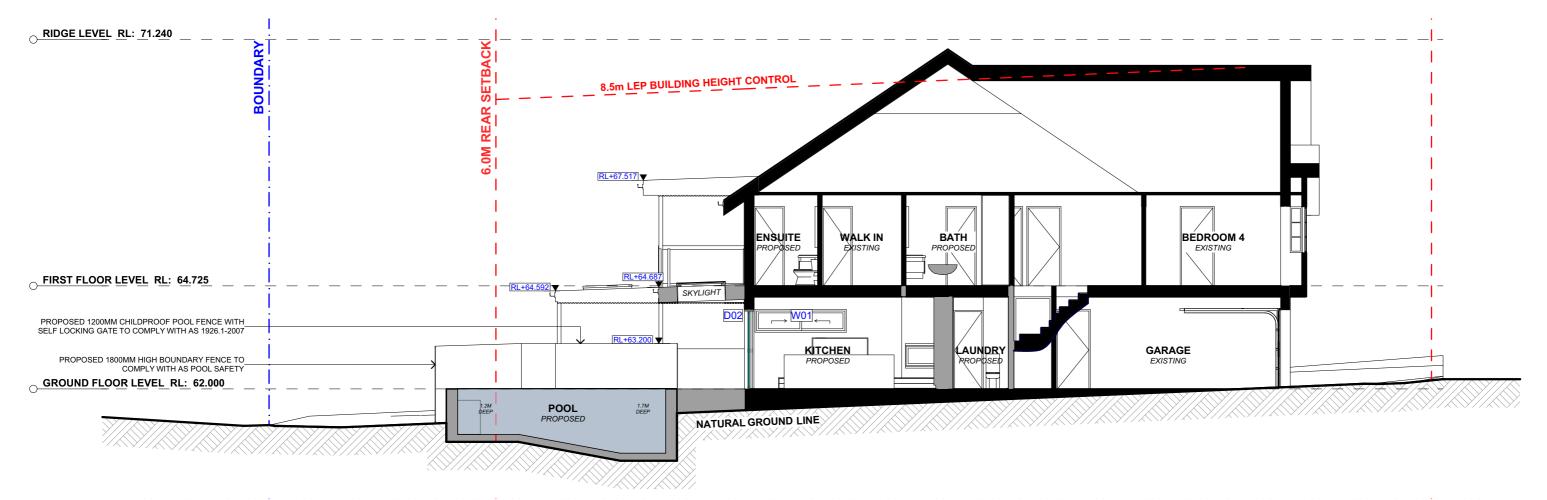


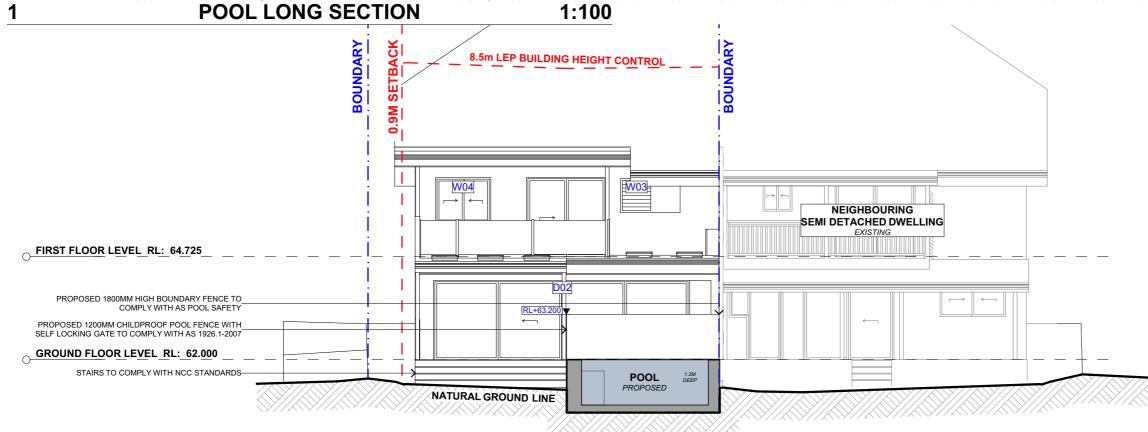

POOL CROSS SECTION 2 1:100



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CLIENT	DRAWING NO.	
KATE & IMRAN MASOOD	DA15	

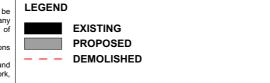MASOOD

NSW 2097

PROJECT ADDRESS

AVENUE, COLLAROY

63B NORFOLK

DATE
Thursday, 12 March

DRAWING NAME POOL LONG / CROSS SECTION



Building Sustainability Index www.basix.nsw.gov.au

Alterations and Additions

Certificate number: A371123

This certificate confirms that the proposed development will meet the NSW government's requirements for sustainability, if it is built in accordance with the commitments set out below. Terms used in this certificate, or in the commitments, have the meaning given by the document entitled "BASIX Alterations and Additions Definitions" dated 06/10/2017 published by the Department. This document is available at www.basix.nsw.gov.au

Secretary
Date of issue: Tuesday, 25, February 2020
To be valid, this certificate must be lodged within 3 months of the date of issue.

Planning, Industry & Environment

Project address	
Project name	63B NORFOLK AVENUE, COLLAROY PLATEAU
Street address	63B NORFOLK Avenue COLLAROY PLATEAU 2097
Local Government Area	Northern Beaches Council
Plan type and number	Strata Plan 47589
Lot number	1
Section number	
Project type	
Dwelling type	Attached dwelling house
Type of alteration and addition	My renovation work is valued at \$50,000 or more and includes a pool (and/or spa).

page 1 / 7

Certificate Prepared by (please complete before submitting to Council or PCA)
Name / Company Name: Action Plans
ABN (if applicable): 17118297587

BASIX Certificate number: A371123 page 2 / 7

Pool and Spa	Show on DA Plans	Show on CC/CDC Plans & specs	Certifier Check
Outdoor swimming pool			
The swimming pool must be outdoors.	✓	✓	✓
The swimming pool must not have a capacity greater than 26 kilolitres.	✓	✓	✓
The swimming pool must have a pool cover.		✓	✓
The applicant must install a pool pump timer for the swimming pool.		✓	✓
The applicant must not incorporate any heating system for the swimming pool that is part of this development.		✓	✓

BASIX Certificate number: A371123 page 3 / 7

Fixtures and systems	Show on DA Plans	Show on CC/CDC Plans & specs	Certifier Check
Lighting			
The applicant must ensure a minimum of 40% of new or altered light fixtures are fitted with fluorescent, compact fluorescent, or light-emitting-diode (LED) lamps.		~	~
Fixtures	'		
The applicant must ensure new or altered showerheads have a flow rate no greater than 9 litres per minute or a 3 star water rating.		✓	✓
The applicant must ensure new or altered toilets have a flow rate no greater than 4 litres per average flush or a minimum 3 star water rating.		✓	✓
The applicant must ensure new or altered taps have a flow rate no greater than 9 litres per minute or minimum 3 star water rating.		✓	

BASIX Certificate number: A371123 page 4 / 7

Construction	Show on DA Plans	Show on CC/CDC Plans & specs	Certifier Check		
Insulation requirements					
The applicant must construct the new or altered construction (floor(s), walls, and ceilings/roofs) in accordance with the specifications listed in the table below, except that a) additional insulation is not required where the area of new construction is less than 2m2, b) insulation specified is not required for parts of altered construction where insulation already exists.				√	√
Construction	Additional insulation required (R-value)	Other specifications			
concrete slab on ground floor.	nil				
external wall: brick veneer	R1.16 (or R1.70 including construction)				
external wall: framed (weatherboard, fibro, metal clad)	R1.30 (or R1.70 including construction)				
flat ceiling, pitched roof	ceiling: R1.75 (up), roof: foil/sarking	light (solar absorptance < 0.475)			

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	REV.	DATE	COMMENTS	DRWN	NOTES This drawing is the co
5	Α	29/01/2020	INITIAL DESIGN PLAN	LRP	whole with the written Do not scale measure to
	В	14/02/2020	DESIGN AMENDMENT	LRP	The Builder/Contractor drawings, or fabricatio
	С	11/03/2020	DA DOCUMENTATION	LRP	All errors and omission All window & door dim
au					person prior to the ord U value takes preceder
					all new glazing must m
					•

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e from drawings. Figured dimensions are to be used only.

tor shall check and verify all levels and dimensions on site prior to commencement of any work, creation of shop in or from persons.

tion of components.

ions are to be verified by the Builder/Contractor and referred to the designer prior to the commencement of works.
imensions, orientation, glazing materials, opening types, frame types are to be confirmed by a suitably qualified
ordering of any such materials are to take place.
Jence over glazing type/colour in all cases.
t meet the BASIX specified frame and glass type, <u>OR</u> meet the ecified U value and SHGC value.

BASIX Certificate number: A371123 page 5 / 7

Glazing req	uirements						Show on DA Plans	Show on CC/CDC Plans & specs	Certifier Check
Windows an	d glazed do	ors							
The applicant must install the windows, glazed doors and shading devices, in accordance with the specifications listed in the table below. Relevant overshadowing specifications must be satisfied for each window and glazed door.									✓
The following	requirements	must also	be satisfi	ed in relation	n to each window and glazed door:			✓	~
have a U-value	ar glazing, or toned/air gap/clear glazing must le below. Total system U-values and SHGCs s. The description is provided for information		✓	✓					
					f each eave, pergola, verandah, bal than 2400 mm above the sill.	cony or awning must be no more than 500 mm	✓	✓	✓
Pergolas with	polycarbonate	roof or s	similar tran	slucent mat	erial must have a shading coefficien	t of less than 0.35.		✓	~
Pergolas with fixed battens must have battens parallel to the window or glazed door above which they are situated, unless the pergola also shades a perpendicular window. The spacing between battens must not be more than 50 mm.							✓	✓	
Windows a									
Window / doo no.	r Orientation	Area of glass inc. frame (m2)	Oversha Height (m)	Distance (m)	Shading device	Frame and glass type			
W01	N	1.45	0	0	eave/verandah/pergola/balcony >=450 mm	standard aluminium, single pyrolytic low-e, (U-value: 5.7, SHGC: 0.47)			
W02	N	4.35	0	0	eave/verandah/pergola/balcony >=450 mm	standard aluminium, single pyrolytic low-e, (U-value: 5.7, SHGC: 0.47)			
W03	W	0.77	0	0	eave/verandah/pergola/balcony >=900 mm	standard aluminium, single pyrolytic low-e, (U-value: 5.7, SHGC: 0.47)			
W04	W	1.77	0	0	eave/verandah/pergola/balcony >=900 mm	standard aluminium, single pyrolytic low-e, (U-value: 5.7, SHGC: 0.47)			
D01	E	2.31	0	0	eave/verandah/pergola/balcony >=900 mm	standard aluminium, single pyrolytic low-e, (U-value: 5.7, SHGC: 0.47)			

Planning, Industry & Environment Building Sustainability Index www.basix.nsw.gov.au

BASIX Certificate number: A371123

Glazing requirements									Certifier Check
Window / door no.	Orientation	Area of glass inc. frame (m2)	Oversha Height (m)	dowing Distance (m)	Shading device	Frame and glass type			
D02	W	14.23	0	0	eave/verandah/pergola/balcony >=900 mm	standard aluminium, single pyrolytic low-e, (U-value: 5.7, SHGC: 0.47)			

Legend
In these commitments, "applicant" means the person carrying out the development.
Commitments identified with a "\sqrt{"}" in the "Show on DA plans" column must be shown on the plans accompanying the development application for the proposed development (if a development application is to be lodged for the proposed development).
Commitments identified with a "v/" in the "Show on CC/CDC plans & specs" column must be shown in the plans and specifications accompanying the application for a construction certificate / complying development certificate for the proposed development.

Commitments identified with a "v" in the "Certifier check" column must be certified by a certifying authority as having been fulfilled, before a final occupation certificate for the

DRAWING NO.

KATE & IMRAN MASOOD

CLIENT

PROJECT ADDRESS 63B NORFOLK AVENUE, COLLAROY NSW 2097

DA16

DRAWING NAME BASIX COMMITMENTS

DATE Thursday, 12 March 2020





PLANTING SCHEDULE


Latin Name	Common Name	Quantity	Scheduled Size	Spread	Height
Buckinghamia celsissima	Ivory Curl Tree	1	45lt	5000	8000
Grevillea 'Poorinda Royal Mantle'	Grevillea	3	200mm	1500	2000
Howea forsteriana	Kentia Palm	2	25lt	3000	15000
Pratia purpurascens	White Root	99	150mm	600	150
Tristianiopsis laurina 'Luscious'	Water Gum	1	45lt	4000	7000





DATE		REVISION										
DRAWING	PROPOSED LANDSCAPE PLAN											
ADDRESS	63B NORFO	PROJECT # ACTION PLA	.NS									
CLIENT	KΔTE & IMPA	AN MASOOD		DATE#	03/03/20	DWG#						
	KATE & IMINA	RIV MASOOD		SCALE @ A3	1:200	L/01						
A To	A Total Concept Landscape Architects & DRAWN JC											
Swimming Pool Designers SW					REVISION							
65 W Tel: (0	55 West Street, North Sydney NSW 2060 Tel: (02) 9957 5122 Fx: (02) 9957 5922											

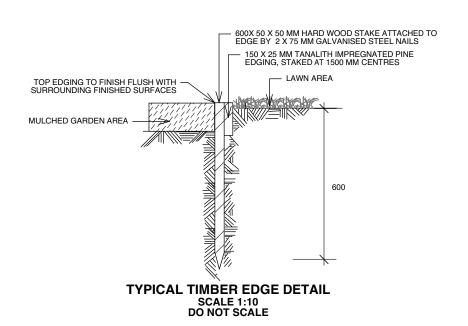

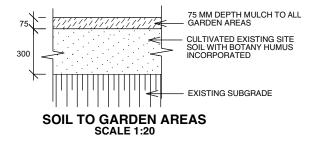

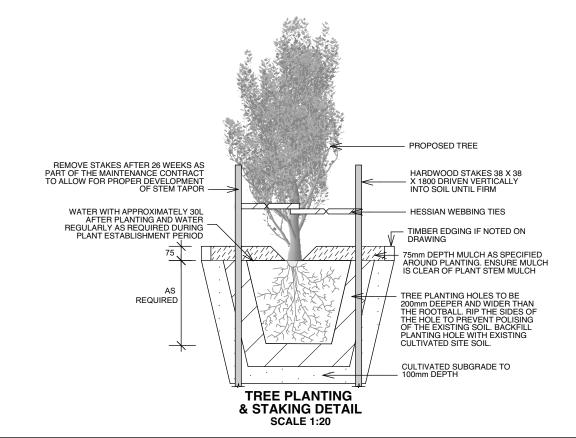

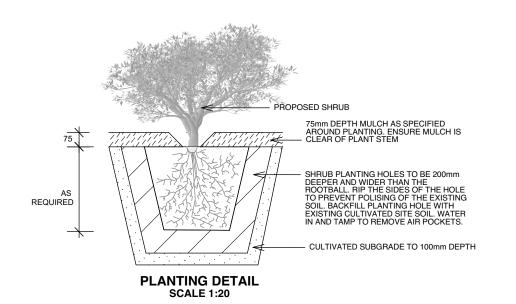

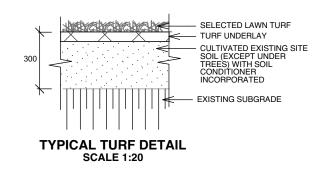





All dimensions and levels shall be verified by Contractor on site prior to commencement of work.
 All detailing of drainage to paved areas shall be by others.
 All levels shall be determined by others and approved on

site by client.

Extent, height and position of all retaining walls shall be

determined by others and approved on site by client.

5. Do not scale from drawings.

6. If in doubt contact the Landscape Architect.

All boundaries shall be surveyed prior to commencement

3. This plan is for DA purposes only. It has not been detailed

 All dimensions, levels and boundaries are nominal only. 6. All of the state of the s

OUTLINE LANDSCAPE SPECIFICATION

Preparation by Builder: Builder shall remove all existing concrete pathways, fences, footings, walls etc. not notated to be retained and complete all necessary excavation work prior to commencement on site by Landscape Contractor (Contractor). Builder shall also install new retaining walls, kerbs, layback kerb, crossover, pathways etc. and make good all existing kerbs, gutters etc. as necessary and to approval of Council. Builder shall ensure that a minimum 450mm of topsoil in garden areas and a minimum 150mm of topsoil in lawn areas exists. Should required depths not exist Builder shall contact Landscape Architect and ask for instructions prior to completion of excavation works. Excavate as necessary, then fill with approved site topsoil to allow for minimum 500mm soil depth in garden areas and 150mm soil depth in lawn areas and to gain required shapes & levels. Ensure all garden and lawn areas drain satisfactorily. All

levels & surface drainage shall be determined by others & approved on site by Head Contractor. Note: Approved imported topsoil mix may be utilised if there is insufficient site topsoil available. State in Tender a m3 rate for additional imported topsoil and the quantities of both site topsoil and imported topsoil allowed for in Tender.

Initial Preparation: Verify all dimensions & levels on site prior to commencement. Do not scale from drawings. Locate all underground services & ensure no damage occurs to them throughout contract. Spray approved weedicide to all proposed lawn & garden areas to manufacturer's directions. Remove existing concrete pathways, footings, walls etc. not notated to be retained & weeds from site. Levels indicated on Plan are nominal only and are derived from Architectural Plans & Drawings by others. Final structural integrity of all items shall be the sole responsibility of Landscape Contractor.

Tree Protection: Trees to be retained shall be protected during site works and construction by the erection of solid barricades to the specification of Council. Storage of machinery or materials beneath canopy of trees to be retained shall not be permitted. Changes to soil level and cultivation of soil beneath canopy of trees to be retained shall not be permitted unless under direct supervision of Landscape Architect. Existing trees shall be pruned to Landscape Architects onsite instructions. Soil Preparation: Cultivate to depth of 300mm all proposed lawn & garden areas incorporating minimum 100mm depth of organic clay breaker into existing site soil. Do not cultivate beneath existing trees to be retained. In areas where fill is required gain required shapes & levels using a premium grade soil mix. In areas where excavation is required (if in clay) over excavate as required to to allow for installation of 500mm depth of premium grade topsoil mix to lawn areas. Undertake all required action to ensure that no rootballs of proposed plants sit in clay wells and that all garden areas and lawn areas drain satisfactorily. Note it is intended that wherever possible existing levels shall not be altered through garden and lawn areas. It is the Contractors responsibility to ensure that the end result of the project is that all lawn and garden areas drain sufficiently (both surface & subsurface), are at required finished levels and have sufficient soil depths to enable lawn and plants to thrive and grow. Should alternative works to those specified be required to achieve the above result, Contractor shall inform Builder at time of Tender and request instructions.

Lawn Edging and Stepping Stones:(i) 125 x 25mm approved tanalith impregnated pine edging shall be installed, to lines as indicated on plan and staked with approved stakes at maximum 1500mm centres at ends and changes of direction; stakes

shall be nailed to edging with approved galvanised steel nails. Top of edging shall finish flush with surrounding surfaces. Top of stakes shall finish 25mm below top of edging. (ii) Contractor shall install approved bricks on edge on a minimum 100mm deep x 90mm wide concrete footing with brick tor set in, to lines nominated on plan as brick edging. Bricks shall be laid with a nominal 10mm wide approved coloured mortar joint. Bricks needing to be cut shall be done so with clean sharp cuts. Top of edging shall finish flush with surrounding finished surfaces. Approved sandstone stepping stones shall be positioned as indicated on plan on a 25mm river sand bed. Approved sandstone stepping stones shall be positioned as indicated on plan on a

Retaining Walls: Positions, detail and heights of retaining walls shall be by others.

Planting: Purchase plants from an approved nursery. Plants to be healthy & true to type & species. Set out plants to positions indicated on plan. Following approval, plant holes shall be dug approximately twice width and to 100mm deeper than plant rootballs that they are to receive. Base and sides of hole shall be further loosened. Fertiliser, followed by 100mm depth of topsoil mix shall then be placed into base of hole and lightly consolidated. Base of hole shall then be watered. Remove plant container and install plant into hole. Rootball shall be backfilled with surrounding topsoil and topsoil firmed into place. An approved shallow dish shall be formed to contain water around base of stem. Base of stem of plant shall finish flush with finished soil level. Once installed plant shall be thoroughly watered and maintained for the duration of the Contract.

Staking: All trees shall be staked using 2 x 38mm x 38mm x 2000mm long hardwood stakes per plant and with hessian webbing ties installed to Landscape Architect's on site instructions.

Mulching: Install 75mm depth of 25mm diameter hardwood mulch to all garden areas, coving mulch down around all plant stems & to finish flush with adjacent surfaces.

Turfing: Prepare for, level & lay cultivated Palmetto Buffulo turves to all areas nominated on plan as being lawn. Roll, water, fertilise, mow & maintain lawns as necessary until completion of maintenance period. At same time make good all existing lawn areas using same lawn type. Lawns in shade shall be over sown with an approved seed mix. Allow to retrim and returf councils nature strip as required.

Fencing: Retain all existing fences unless advised otherwise by builder. Install timber paling fences to heights indicated on Plan.

Paving: Areas to be paved shall be excavated or filled to allow for installation of bedding materials. Levels and falls shall be as per Plan. Surface drainage on paving shall be towards grated drains with all drains connected to stormwater system and installed by Builder.

Irrigation: Contractor shall supply and install an approved fully automatic, vandal resistant, computerised irrigation system to all garden and lawn areas, excluding council nature strip. Entire system shall be to approval of Water Board and shall utilise pop-up sprinklers and electronic controllers. Contractor shall be responsible to ensure that system is able to satisfactorily operate on available water pressure. Power supply for use by irrigation system shall be provided to an approved location near southwest corner of residence by others and shall consist of an approved weatherproof G.P.O. The irrigation system controller shall be housed in an approved waterproof cabinet mounted to external wall of residence.

Clotheslines: Contractor shall allow for all necessary labour and materials and shall install clotheslines to positions as indicated on plan to manufacturer's instructions to approval of Landscape Architect. Clothesline type shall be equal to 'Hills

Completion: Prior to practical completion remove from site all unwanted debris occurring from work. Satisfy Council that all landscaping work has been undertaken in strict accordance with Councils landscape codes & guidelines.

Maintenance Period: A twelve month maintenance period shall be undertaken by owner or owners representative as set out herein. Owner shall have care and maintenance of all work specified under this Contract and shall rectify any defective work for a period of 52 weeks following Practical Completion of Landscape Works. This period shall be herein known as the Maintenance Period. Work shall also include for the care and maintenance of all existing vegetation to be retained and proposed vegetation. Site shall be attended at least weekly and as otherwise required. The following works shall be undertaken during the Maintenance Period.

(a) Recurrent works Undertake recurrent works throughout the Maintenance Period. These works shall include but are not limited to watering, weeding, fertilising, pest and disease control, returfing, staking and tying, replanting, cultivation, pruning, aerating, renovating, top dressing and the like.

(b) Watering Regularly water all plants and lawn areas to maintain optimal growing conditions. Contractor shall adjust the water quantity utilised with regard to climatic conditions prevalent at the time.

- (c) Replacements Immediately replace plants which die or fail to thrive (at discretion of Landscape Architect) with plants of same species or variety and of same size and quality unless otherwise specified. Plant replacement shall be at Contractors expense, unless replacement is required due to vandalism or theft, which shall be determined by Landscape Architect. Required replacement of plants due to vandalism or theft shall be undertaken by Contractor and shall be paid for by Client at an agreed predetermined rate.
- (d) Mulched surfaces Maintain mulched surfaces in clean, tidy, weed-free condition and shall reinstate mulch as necessary to maintain specified depths.

- (e) Stakes & ties Adjust and/or replace stakes and ties as required. Remove stakes and ties at end of Maintenance Period if directed by Landscape Architect.

 (f) Lawn areas Lawn areas shall be mown at regular intervals to ensure non heading of lawn by others shall be determined on site taking into consideration season, watering and growth rate of lawn. Following the primary cut all lawns shall be regularly mown as required to ensure a healthy lawn and a neat appearance. Care shall always be taken to ensure that no clippings are left on surrounding roads or garden areas after mowing. Replace lawn areas that fail to thrive at discretion of Landscape Architect. All new and made good lawn areas shall be barricaded off from pedestrian traffic by use of star pickets and brightly coloured plastic safety mesh until establishment of lawn. Barricades shall be removed upon establishment of lawn area.
- (g) Weeding Remove by hand, or by carefully supervised use of weedicide, any weed growth that may occur throughout Maintenance Period. This work shall be executed at weekly intervals so that all lawn and garden areas may be observed in a weed-free condition.
- (h) Pruning Prune new and existing plants (excluding existing trees) as necessary to maintain dense foliage conditions. Any rogue branches, or branches overhanging or obstructing pathways, roads, doorways, etc., shall be removed by approved horticultural methods.
- (i) Spraying Spraying for insect, fungal and disease attack shall be undertaken as required and in accordance with spray manufacturers recommendations at intervals taking into account the season of year during which landscape works are to be
- (j) Tree Care Should any existing trees be damaged during construction works immediately engage an experienced arboriculturist and then undertake any rectification work recommended by arboriculturist.

- 1. All dimensions and levels shall be verified by Contractor

- 1. All dimensions and levels shall be verified by Contractor on site prior to commencement of work.
 2. All detailing of drainage to paved areas shall be by others.
 3. All levels shall be determined by others and approved on site by client.
 4. Extent, height and position of all retaining walls shall be determined by others and approved on site by client.
 5. Do not scale from drawings.
 6. If in doubt contact the Landscape Architect.
 7. All boundaries shall be surveyed prior to commencement of construction works.
- of construction works. B. This plan is for DA purposes only. It has not been detailed
- for construction.

 On the memory of the memo

