Free space Approx. = 18989.13m<sup>2</sup> (94.0%)

and overtopping, and repair immediately. Sediment

collected should be removed from site.

Supplied By:



Minkara Road





<u>Fernleigh</u>

COUNCIL SERVICES


NTS

hello@fernleighdrafting.com.au

Jon Douglas

Address: 17 Minkara Road Bayview 2104

Site Plan

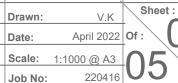

plans. All dimensions to be checked and verified on site.

DRAFTING I


fernleighdrafting.com.au

Proposed: Detached Steel Frame Shed Client:

Lot 2/DP618622

Council: Northern Beaches Council

Note: Plans to be printed on A3 to be too scale. Do not scale off

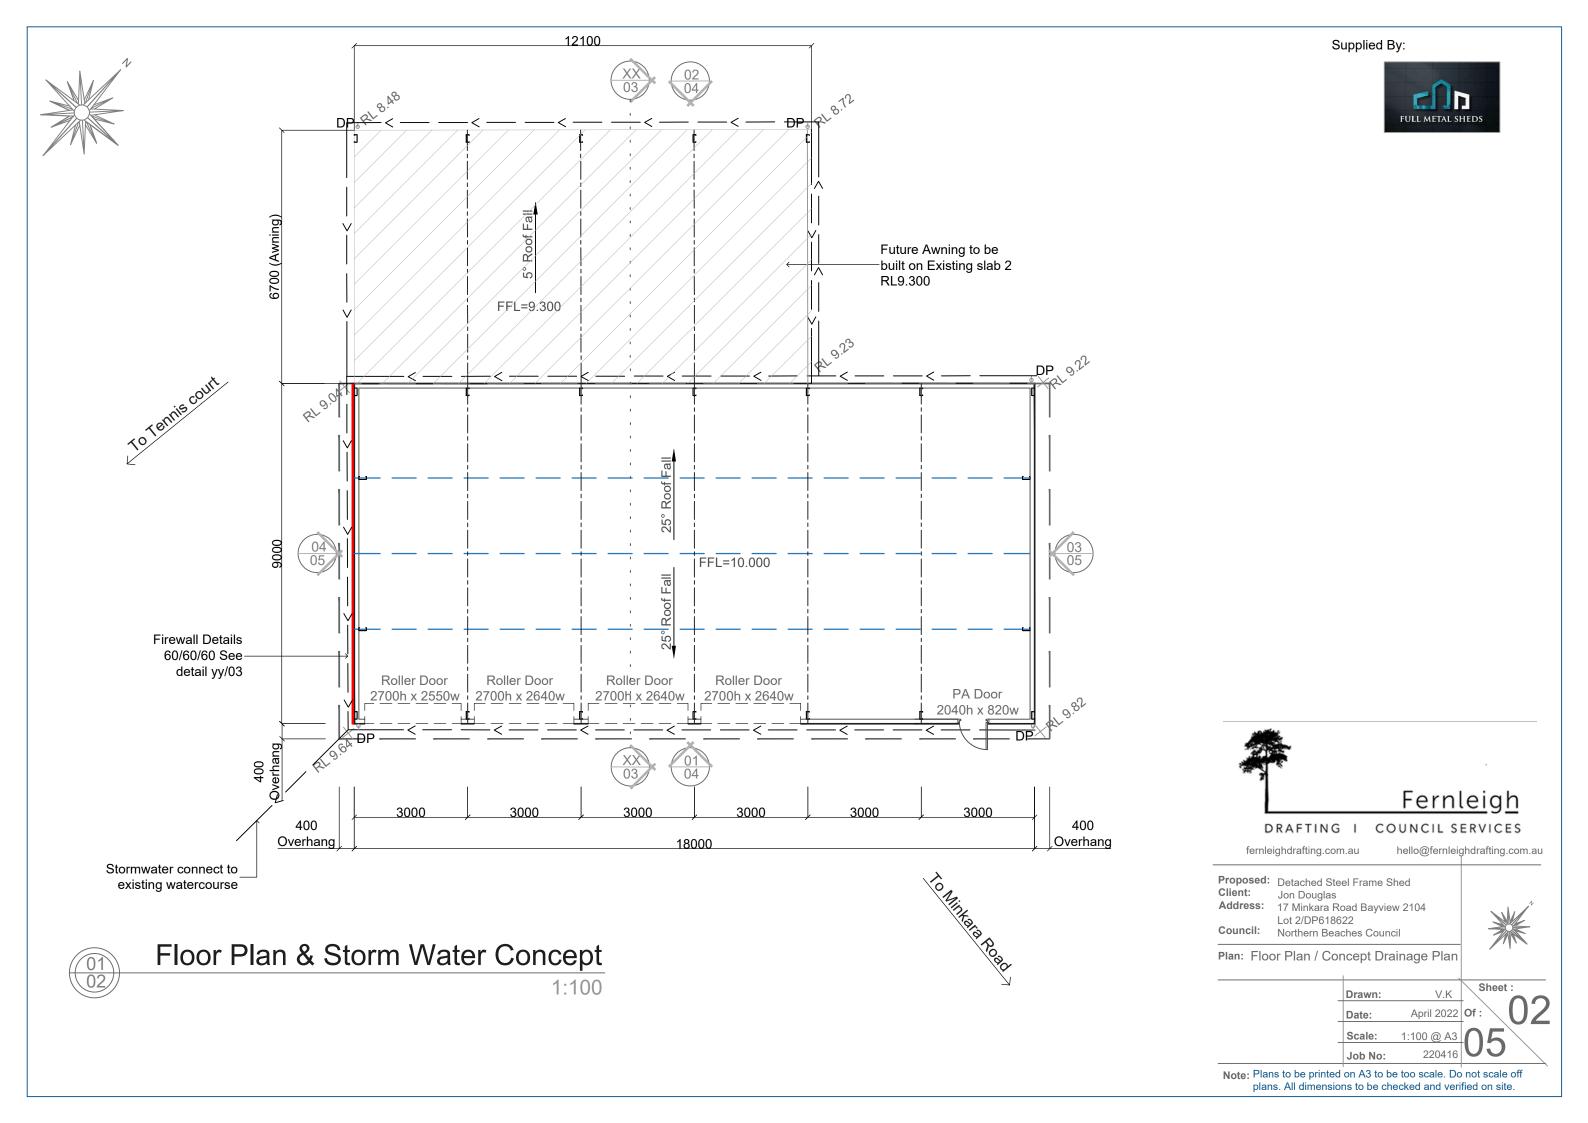

### Supplied By:




Portal frame design and Custom ORB 0.42 connection details as BMT roof Cladding per Engineering RL 15.545 specifications. Custom ORB 0.42 BMT roof Cladding RL 13.200 RL 12.614 400 Overhang 3314 FFL 10.000 FFL 9.300 Existing slab Existing slab and

footing

# Typical Section Thru - X 1:100

and footing

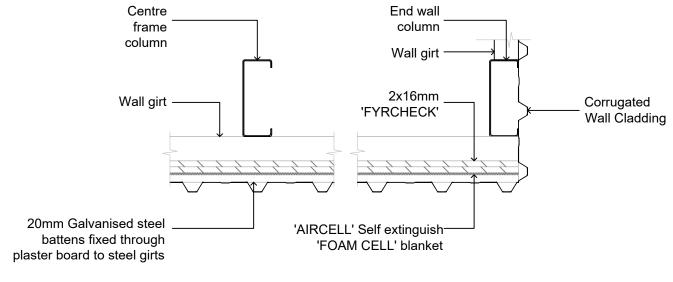

SYSTEM SPECIFICATION FRL SYSTEM **WALL LININGS** Report/Opinion **CSR 5380** 60/60/60 EXTERNAL WALL SIDE (from outside only 2 x 16mm Gyprock Fyrchek MR Plasterboard. FC 12946

System specification - Metal cladding - Steel girt

By 'THE RED BOOK - CSR'

Firewall Details 60/60/60 (Plan view)

All works to be completed in accordance with the performance requirements of the National Construction Code (NCC) 2019 Volume 2 Amendment 1

#### **Detached Portal Frame Sheds**

| Detached Portal Frame Sheds              |  |  |  |  |
|--|--|--|--|--|
| Part 3.1                                 | Site preparation (dealt with in Engineering)             |  |  |  |
| Part 3.1.1                               | Earthworks   |  |  |  |
| Part 3.1.2                               | Earth retaining structures                               |  |  |  |
| Part 3.1.3                               | Drainage   |  |  |  |
| Part 3.2                                 | Footings and slabs (dealt with in Engineering)           |  |  |  |
| Part 3.2.2                               | Preparation  |  |  |  |
| Part 3.2.3                               | Concrete and reinforcing                                 |  |  |  |
| Part 3.2.4                               | Site classification                                      |  |  |  |
| Part 3.2.5                               | Footing and slab construction                            |  |  |  |
| Part 3.4                                 | Framing (dealt with in Engineering)                      |  |  |  |
| Part 3.4.2                               | Steel framing  |  |  |  |
| Part 3.4.4                               | Structural steel members                                 |  |  |  |
| Part 3.5                                 | Roof cladding, gutters and downpipes and wall cladding   |  |  |  |
| Part 3.5.1                               | Sheet roofing  |  |  |  |
| Part 3.5.3                               | Gutters and downpipes                                    |  |  |  |
| Part 3.5.5                               | Metal wall cladding                                      |  |  |  |
| Part 3.9                                 | Safe Movement and Access                                 |  |  |  |
| Part 3.9.1.6                             | Thresholds   |  |  |  |
| Part 3.10                                | Ancillary Provisions and Additional Construction         |  |  |  |
| Requirements (dealt with in Engineering) |  |  |  |  |
| Part 3.10.2                              | Earthquake areas   |  |  |  |
| Part 3.10.5                              | Construction in bushfire prone areas                     |  |  |  |
| Part 3.6                                 | Glazing  |  |  |  |
| Part 3.6.1                               | Application  |  |  |  |
| Part 3.6.2                               | Glazing sizes and installation                           |  |  |  |
| Part 3.6.3                               | Fully framed glazing installed in perimeter of buildings |  |  |  |
| Part 3.6.4                               | Human impact safety requirements                         |  |  |  |
| Part 3.8                                 | Health and Amenity                                       |  |  |  |
| Part 3.8.1                               | Wet areas and external waterproofing                     |  |  |  |
| Part 3.8.2                               | Room heights   |  |  |  |
|  |  |  |  |  |



# Fernleigh

DRAFTING I fernleighdrafting.com.au

COUNCIL SERVICES

hello@fernleighdrafting.com.au

Proposed: Detached Steel Frame Shed Client: Jon Douglas

Address: 17 Minkara Road Bayview 2104

Lot 2/DP618622

Council: Northern Beaches Council

Section


| Drawn:  | V.K        | Sheet : |
|---------|------------|---------|
| Date:   | April 2022 | Of: 3   |
| Scale:  | 1:100 @ A3 | 05      |
| Job No: | 220416     | 05      |
|         |            |         |

Note: Plans to be printed on A3 to be too scale. Do not scale off plans. All dimensions to be checked and verified on site.


1:5

## Supplied By:



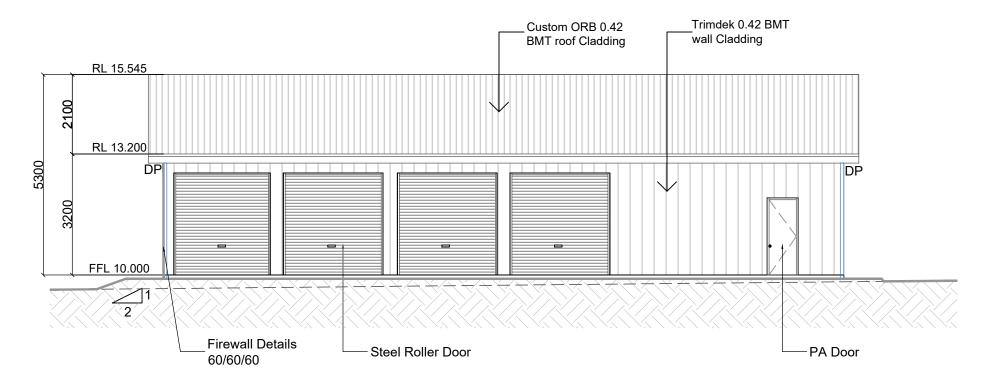

Western Elevation

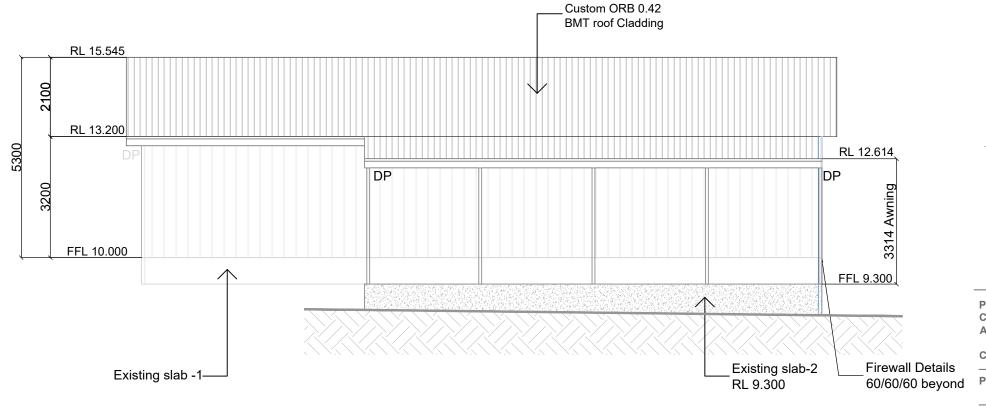

Proposed: Detached Steel Frame Shed Client: Jon Douglas Address: 17 Minkara Road Bayview 2104 Lot 2/DP618622 Council: Northern Beaches Council

DRAFTING I

fernleighdrafting.com.au

Elevations Sheet: V.K Drawn: April 2022 Of Date: Scale: 1:100 @ A3

<u>Fernleigh</u>

hello@fernleighdrafting.com.au

COUNCIL SERVICES

Roof Cladding / Night Sky

- Wall Cladding / Night Sky

- Roller Doors / Night Sky

- Flashings / Night Sky

- PA Door / Night Sky


Note: Plans to be printed on A3 to be too scale. Do not scale off plans. All dimensions to be checked and verified on site.

Northern Elevation


220416 Job No:

### Supplied By:



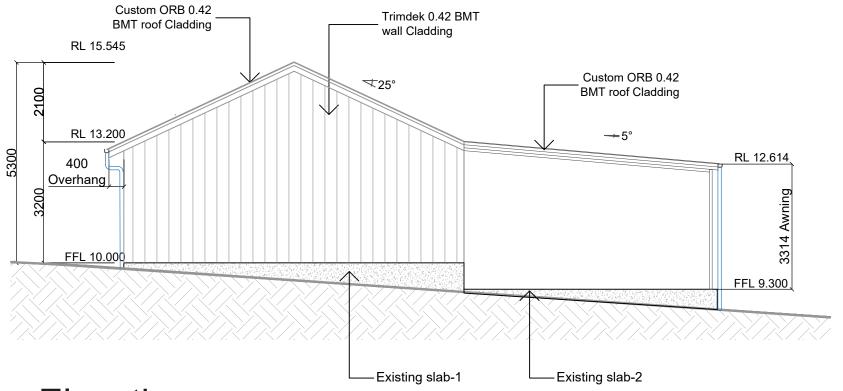

Eastern Elevation

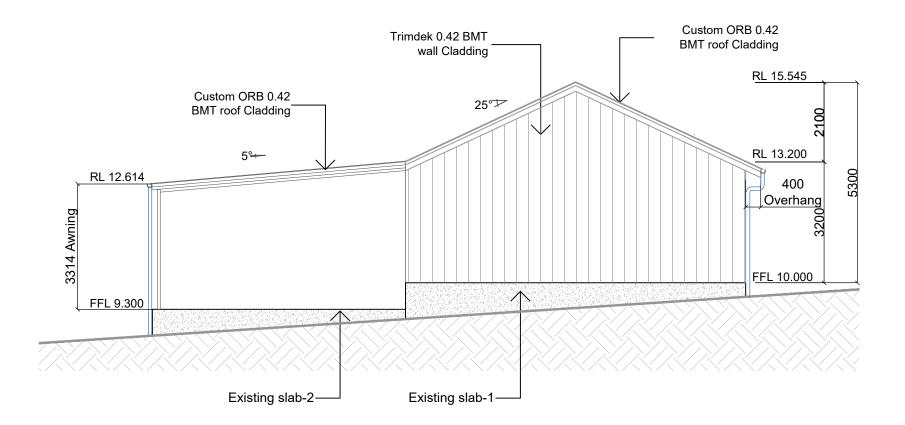

Southern Elevation

1:100

- R

Roof Cladding / Night Sky

- Wall Cladding / Night Sky



Roller Doors / Night SkyFlashings / Night Sky



- PA Door / Night Sky



<u>Fernleigh</u>

COUNCIL SERVICES

**DRAFTING I** fernleighdrafting.com.au

hello@fernleighdrafting.com.au

Proposed: Detached Steel Frame Shed Client: Jon Douglas

Client: Jon Douglas

Address: 17 Minkara Road Bavview 2

: 17 Minkara Road Bayview 2104 Lot 2/DP618622

Council: Northern Beaches Council

Plan:

Elevations

 Drawn:
 V.K
 Sheet:

 Date:
 April 2022
 Of:
 05

 Scale:
 1:100 @ A3
 05

 Job No:
 220416
 05

Note: Plans to be printed on A3 to be too scale. Do not scale off plans. All dimensions to be checked and verified on site.