


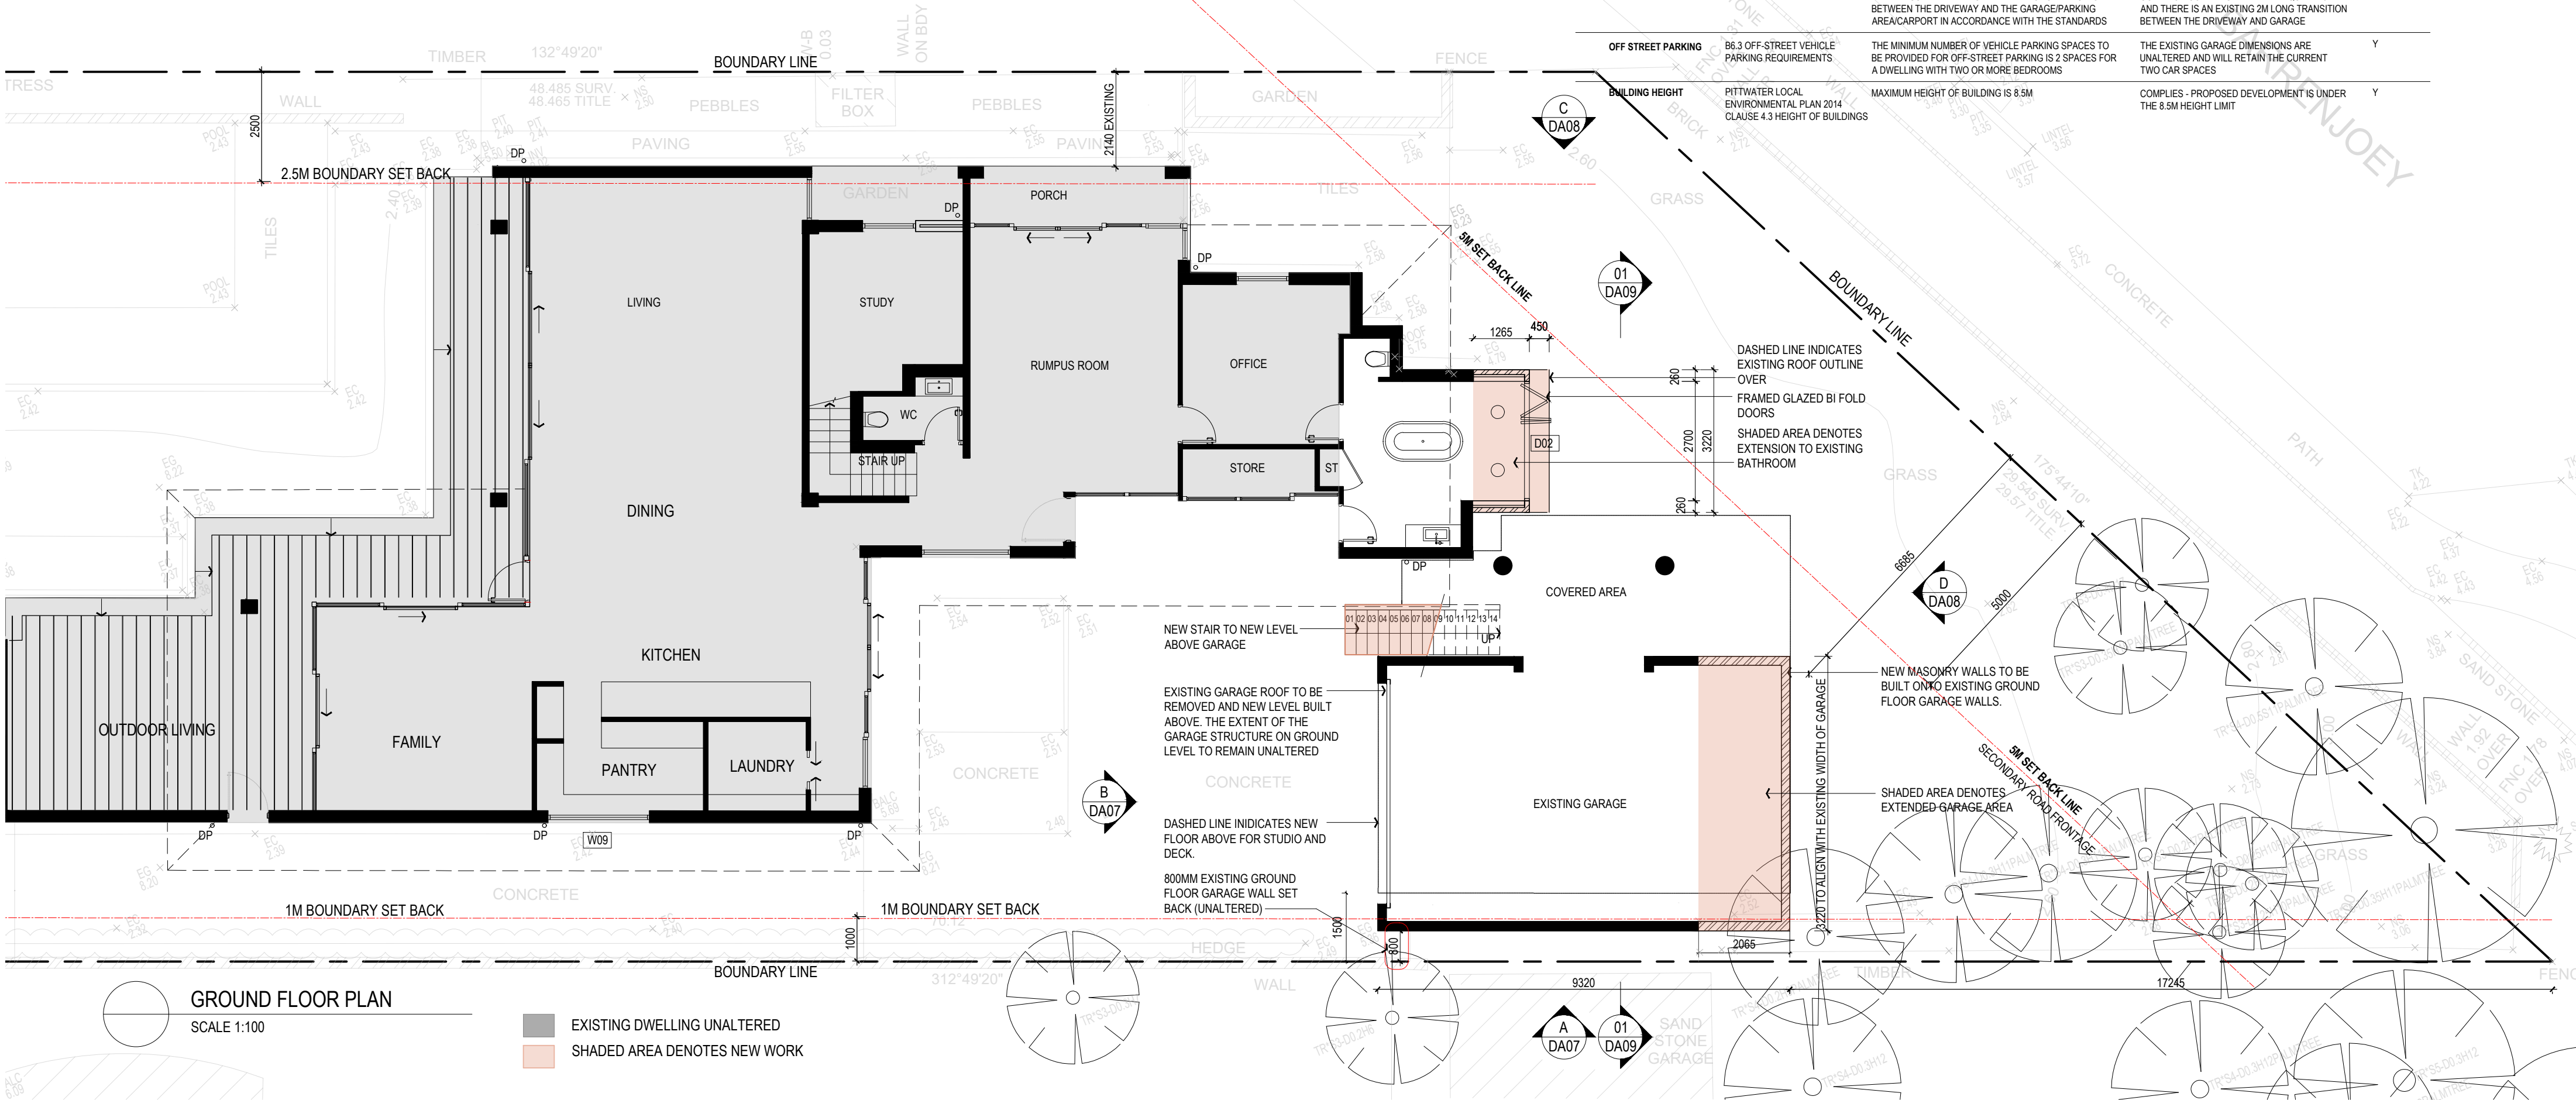



Fixtures and systems						Show on DA Plans	Show on CC/CDC Plans & specs	Certifier Check	Glazing requirements						Show on DA Plans	Show on CC/CDC Plans & specs	Certifier Check	Glazing requirements						Show on DA Plans	Show on CC/CDC Plans & specs	Certifier Check																														
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REV.	DATE	DESCRIPTION
A	16.08.2023	ISSUED TO PLANNER FOR REVIEW
B	20.09.2023	ISSUED FOR DEVELOPMENT APPLICATION

CHECKED
KM
KM

LEGEND	
ABBREVIATIONS	
AC	AIR CONDITIONING
AHD	AUSTRALIAN HEIGHT DATUM
AS	AUSTRALIAN STANDARD
AW	AWNING WINDOW
BF	BIFOLD
CB	CASEMENT WINDOW
DB	DOUBLE
DP	DOWNPIPE
EX	EXISTING
EQ	EQUAL
F	FIXED
FCL	FINISHED CEILING LEVEL
FF	FIRST FLOOR
FRL	FINISHED FLOOR LEVEL
FRL	FINISHED REDUCED LEVEL
JN	JOINERY
LFW	LINEAR FLOOR WASTE
LGF	LOWER GROUND FLOOR
N	NEW
NC	NATIONAL CONSTRUCTION CODE (BCA)
NGL	NATURAL GROUND LEVEL
NTS	NOT TO SCALE
PV	PHOTO VOLTAGE
RT	ROOF TILE
SKL	SKYLIGHT
SL	SLIDING DOOR
SKM	SMOKE ALARM
TD	TOP OF GUTTER
V	VENT
AD	ALUMINIUM DOOR
AL	ALUMINIUM
AW	ALUMINIUM WINDOW
BB	BARGE BOARD
BK	BITUMINOUS MEMBRANE
BRICK	BRICK
CA	CARPET
CE	CLEAR FINISH
CR	CEMENT RENDER
FB	FASCIA BOARD
FC	FIBRE CEMENT
G	GLAZED
GD	GLAZED TIMBER DOOR
MRS	METAL ROOF SHEETING
PB	PLASTERBOARD
RE	RENDERED
RC	REINFORCED CONCRETE
SL	SLATE
ST	STONE
TB	TIMBER BATTEN
TD	TIMBER DOOR
TK	TIMBER KICKING
T & G	TIMBER TONGUE AND GROOVE
T/LT	TILE - TERRACOTTA
TW	TIMBER WINDOW
TUF	TILE-FLOOR
WB	WEATHERBOARD

two form Pty Ltd  
Nominated Architect Kristina Mitkovski NSW Reg No. 7998

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**two form**  
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Check and verify all dimensions on site and refer any errors and/or omissions to the Architect before proceeding further. Do not scale off the drawings. Drawings shall not be used for construction purposes until issued by the Architect for such purpose. For explanation of abbreviations and symbols refer to appropriate legends. © Copyright TWO FORM PTY LTD

CLIENT  
STEPHEN AND SUSAN JONES

PROJECT  
ALTERATIONS AND ADDITION TO EXISTING DWELLING  
3 WARATAH ROAD, PALM BEACH LOT 15 DP 651513

DRAWING NAME

GROUND FLOOR PLAN

DRAWING STAGE  
DEVELOPMENT APPLICATION

DRAWING NUMBER  
22 026 AR DA 05

DRAWING NUMBER

22 026 AR DA 05

DATE  
AUG 2023

SCALE  
1:100 AT A2

REVISION


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Certificate number: A505295

Roofing and systems				Glazing requirements				Glazing requirements				Glazing requirements			
	Show on DA Plans	Show on COCCO Plans & specs	Certifier Check	Show on DA Plans	Show on COCCO Plans & specs	Certifier Check	Show on DA Plans	Show on COCCO Plans & specs	Certifier Check	Show on DA Plans	Show on COCCO Plans & specs	Certifier Check			
<b>Lighting</b>				<b>Windows and glazed doors</b>				<b>Skylights</b>							
The applicant must ensure a minimum of 40% of new or altered light fixtures are fitted with fluorescent, compact fluorescent, or light-emitting diode (LED) lamps.				✓ ✓ ✓ The applicant must install the windows, glazed doors and shading devices, in accordance with the specifications listed in the table below. Relevant overglazing specifications must be satisfied for each window and glazed door. The following requirements must also be satisfied in relation to each window and glazed door: Each window or glazed door with standard aluminium or timber frames and single clear or bronze glass may either match the description, or have a U-value and a Solar Heat Gain Coefficient (SHGC) no greater than that listed in the table below. Total system U-values and SHGCs must be calculated in accordance with National Forestry Planning Rating Council (NPRC) requirements. For projections determined in millimetres, the leading edge of each eave, pergola, verandah, balcony or awning must be no more than 500 mm above the head of the window or glazed door and no more than 2400 mm above the sill. Pergolas with polycarbonate roof or similar translucent material must have a shading coefficient of less than 0.35. Pergolas with fixed louvers parallel to the window or glazed door above which they are situated, unless the pergola also shades a perpendicular window. The spacing between louvers must not be more than 50 mm.				✓ ✓							

DEVELOPMENT	DCP CLAUSE	DEVELOPMENT CONTROL	DEVELOPMENT PROPOSAL	COMPLIES Y/N
LANDSCAPED AREA	D12.10 - LANDSCAPED AREA - ENVIRONMENTALLY SENSITIVE LAND	THE TOTAL LANDSCAPED AREA ON LAND ZONED E4 ENVIRONMENTAL LIVING SHALL BE 60% OF THE SITE AREA	REFER ALSO TO LANDSCAPE ARCHITECT DRAWINGS PREPARED BY SITE DESIGN + STUDIO SITE AREA = 1192M2 TOTAL EXISTING LANDSCAPED AREA = 430M2 = 36.07% OF SITE AREA TOTAL PROPOSED LANDSCAPE AREA = 446M2 = 37.42% OF SITE AREA	Y
BOUNDARY SET BACK	D12.5 FRONT BUILDING LINE	6.5M OR ESTABLISHED BUILDING LINE, WHICHEVER IS THE GREATEST	WARATAH ROAD AS THE PRIMARY FRONTAGE HAS AN EXISTING 6.5M SET BACK WHICH IS MAINTAINED	Y
BOUNDARY SET BACK	D12.6 SIDE AND REAR BUILDING LINE	2.5M TO AT LEAST ONE SIDE AND 1.0M FOR THE OTHER SIDE REAR SET BACK TO USE VARIATION CLAUSE - BARRENJOEY ROAD IS THE SECONDARY ROAD FRONTAGE SO HALF OF 10M BUILDING LINE SET BACK WILL BE USED	NORTHERN BOUNDARY - 2.5M SET BACK NO NEW DEVELOPMENT PROPOSED TO THE NORTHERN BOUNDARY SOUTHERN BOUNDARY - 1M SET BACK EXISTING GARAGE REDEVELOPMENT COMPLIES WITH THE 1M SET BACK SECONDARY ROAD, BARRENJOEY ROAD SET BACK - 0.4M2 OF NEW DECK ENROACHES INTO THE 5M SET BACK ZONE	Y    Y  MINOR ENROACHMENT OF 0.4M2
BUILDING ENVELOPE	D12.8 BUILDING ENVELOPE	PLANES ARE TO BE PROJECTED AT 45 DEGREES FROM A HEIGHT OF 3.5M ABOVE EXISTING GROUND LEVEL AT THE SIDE BOUNDARIES TO THE MAXIMUM BUILDING HEIGHT	REFER TO ELEVATION AND SECTION DRAWING FOR GRAPHIC DEMONSTRATION OF COMPLIANCE WITH THE BUILDING ENVELOPE CONTROL	Y
INTERNAL DRIVEWAYS	B6.2 INTERNAL DRIVEWAYS	THE INTERNAL DRIVEWAY SHALL BE CONTAINED WITHIN THE DRIVEWAY CORRIDOR. THE MINIMUM WIDTH OF THE DRIVEWAY CORRIDOR FOR A SINGLE DWELLING IS 3M THERE MUST BE A MINIMUM 2 METRE LONG TRANSITION BETWEEN THE DRIVEWAY AND THE GARAGE/PARKING AREA/CARPORT IN ACCORDANCE WITH THE STANDARDS	THE EXISTING INTERNAL DRIVEWAY IS UNALTERED AS A RESULT OF THIS APPLICATION AND THE MINIMUM WIDTH OF THE DRIVEWAY CORRIDOR COMPLIES WITH THE REQUIRED 3M AND THERE IS AN EXISTING 2M LONG TRANSITION BETWEEN THE DRIVEWAY AND GARAGE	Y
OFF STREET PARKING	B6.3 OFF-STREET VEHICLE PARKING REQUIREMENTS	THE MINIMUM NUMBER OF VEHICLE PARKING SPACES TO BE PROVIDED FOR OFF-STREET PARKING IS 2 SPACES FOR A DWELLING WITH TWO OR MORE BEDROOMS	THE EXISTING GARAGE DIMENSIONS ARE UNALTERED AND WILL RETAIN THE CURRENT TWO CAR SPACES	Y
BUILDING HEIGHT	PITTSWATER LOCAL ENVIRONMENTAL PLAN 2014 CLAUSE 4.3 HEIGHT OF BUILDINGS	MAXIMUM HEIGHT OF BUILDING IS 8.5M	COMPLIES - PROPOSED DEVELOPMENT IS UNDER THE 8.5M HEIGHT LIMIT	Y



REV.	DATE	DESCRIPTION
A	16.08.2023	ISSUED TO PLANNER FOR REVIEW
B	20.09.2023	ISSUED FOR DEVELOPMENT APPLICATION

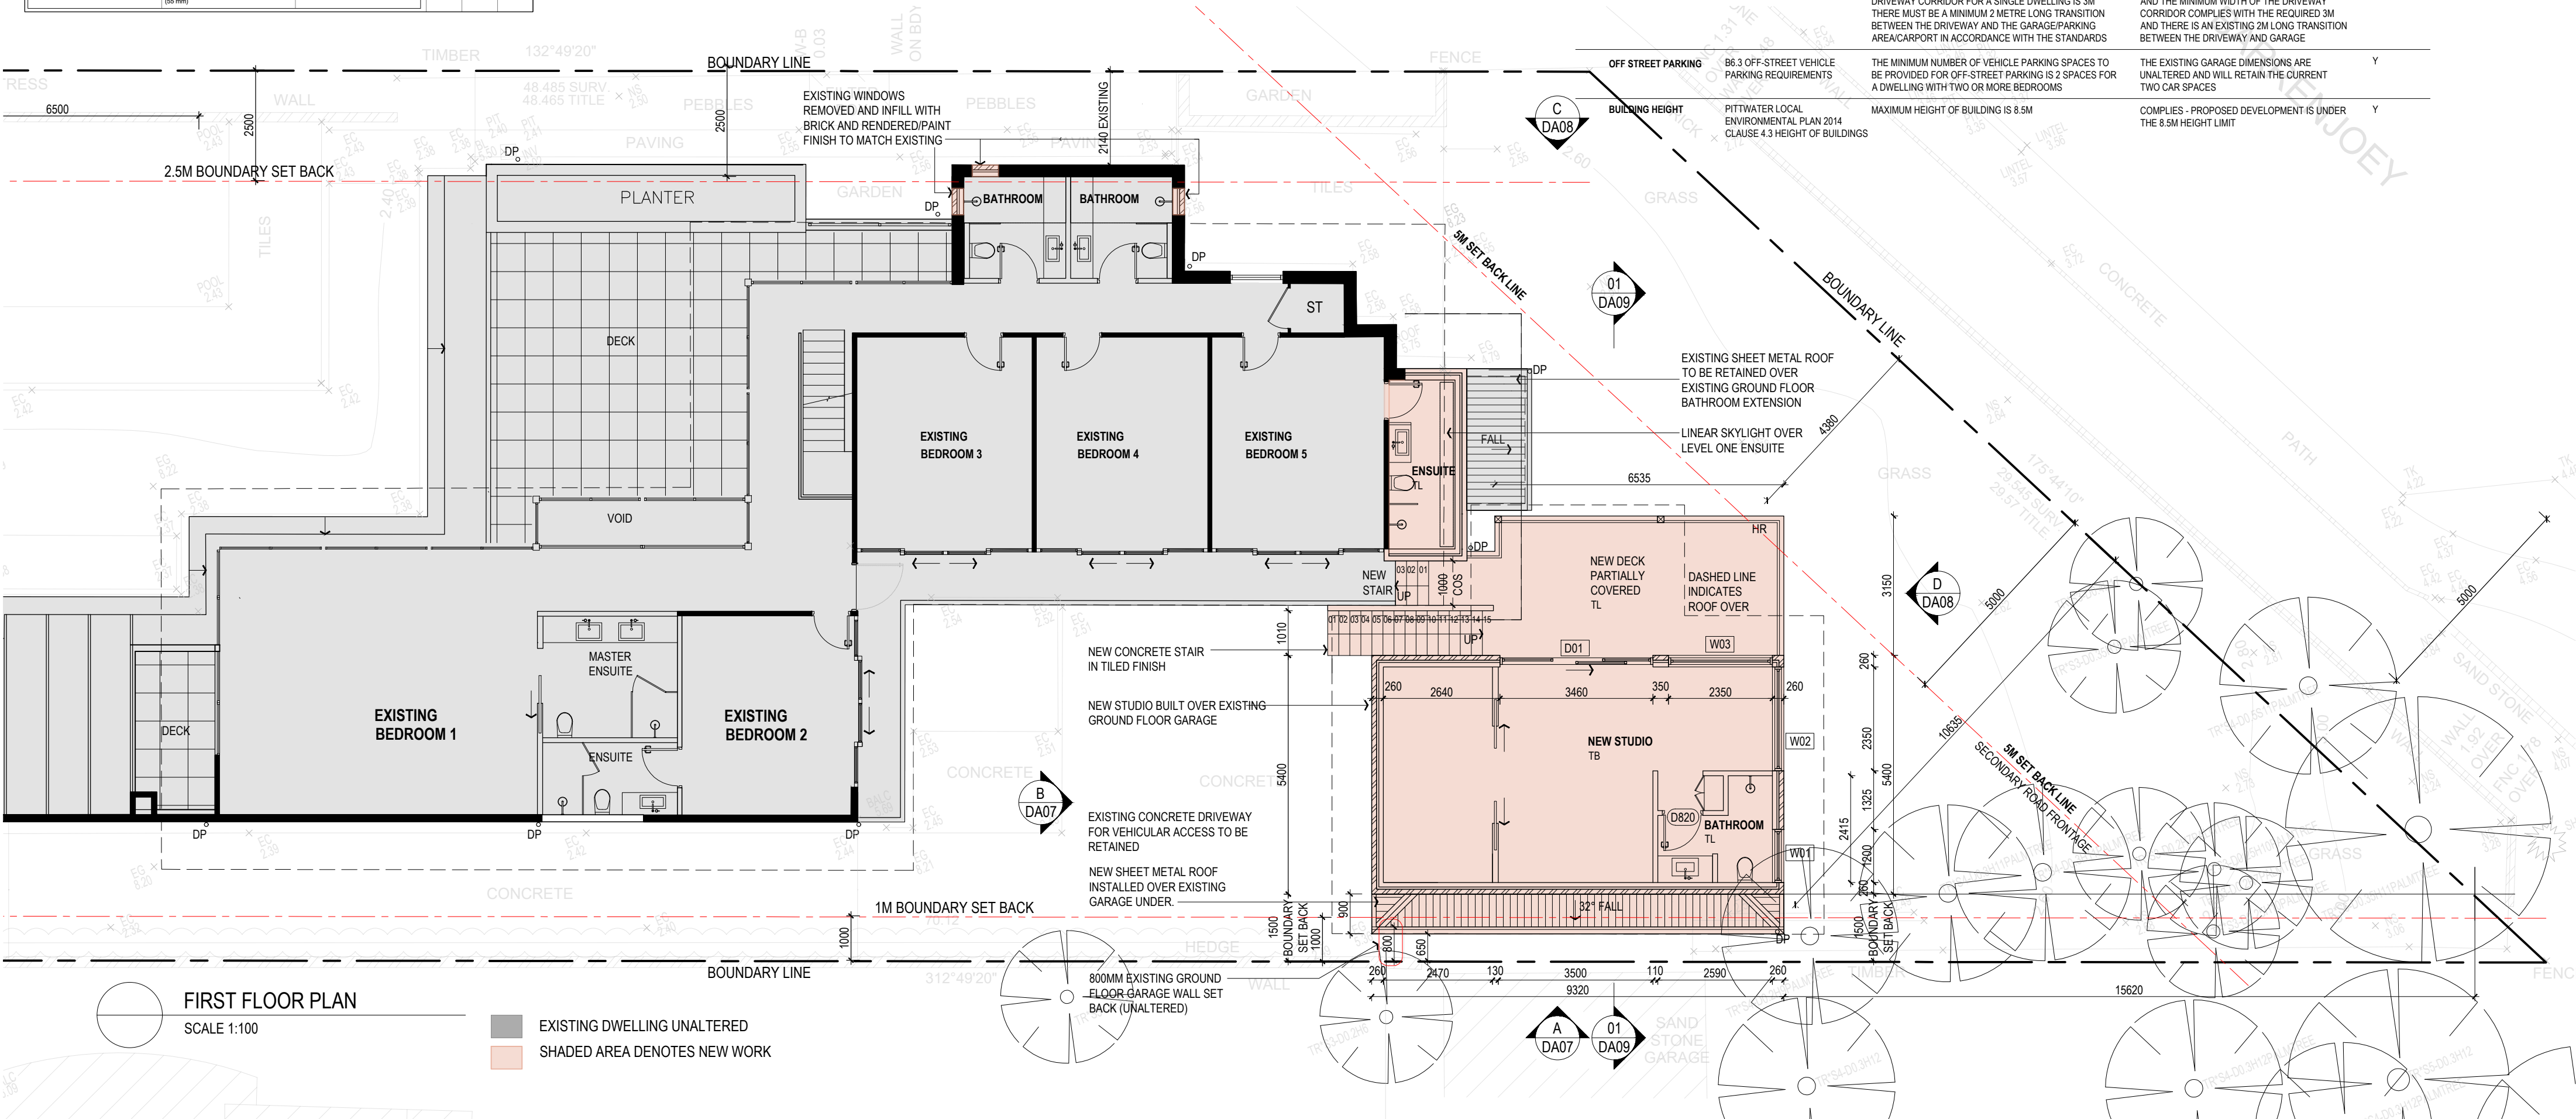CHECKED  
KM  
KM

ABBREVIATIONS			MATERIALS AND FINISHES				
AC	AIR CONDITIONING	JN	JONERY	AD	ALUMINUM DOOR	PB	PLASTERBOARD
AHD	AUTOMATIC HEIGHT ADJUSTMENT	LFW	LIQUOR WARE FLOOR	AL	ALUMINUM	R	RATED
AW	AUSTRALIAN WINDOW	N	NEW	ALW	ALUMINUM WINDOW	S	SELF-SUPPORTING CONCRETE
AWW	AWNING WINDOW	(N)	NEW	B	BARGE BOARD	SL	SLENDER
C	CASEMENT WINDOW	NCC	NATIONAL CONSTRUCTION CODE (BCA)	B	BATT	ST	STEEL
CS	CASEMENT WINDOW			BM	BITUMINOUS MEMBRANE	T	TIMBER
DB	DOUBLE DOWNPINE	NGL	NATIONAL GROUND LEVEL		ROOFING	TB	TIMBER BATTEN
(E)	EXISTING	NOT	NOT TO SCALE	CB	CARPET	TM	TIMBER DOOR
F	FIXED	PTV	POINT VOLTAGE	CL	CLEAR FINISH	TDK	TIMBER DECKING
F	EQUAL	RF	ROOF FLOOR	FR	FRONT FENDER	T & G	TONGUE & GROOVE
F	FIXED	SKL	SKYLIGHT	FB	FACE BOARD		
F	FINISHED CEILING LEVEL	SM	SMOKE ALARM	F	FLOOR	T & F	TERRAZZO & FLOOR
F	FINISHED FLOOR	SMK	SMOKE ALARM	G	GLAZED	TW	TIMBER WINDOW
FF	FINISHED RESTRAINED LEVEL	TG	TOP OF GUTTER	GLZ	GLAZED TIMBER DOOR	TLF	FLAT - FLOOR
				MS	MID ROOF SHEETING		

**two form pty ltd**  
Nominated Architect Kristina Mitkovski NSW Reg No. 7998

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CLIENT  
STEPHEN AND SUSAN JONES

**PROJECT**  
ALTERATIONS AND ADDITION TO EXISTING DWELLING  
3 WARATAH ROAD, PALM BEACH LOT 15 DP 651513

DRAWING NAME

## FIRST FLOOR PLAN

DRAWING STAGE  
DEVELOPMENT APPLICATION

DRAWING NUMBER

22 026 AR DA 06

DATE  
AUG 2023

SCALE  
1:100 AT A2

## REVISION


**B**



Lighting			show on DA Plans	Center Check	show on CCDDC Plans & space	show on CCDDC Plans & space	show on CCDDC Plans & space	show on CCDDC Plans & space
The applicant must ensure a minimum of 40% of new or altered light fixtures are fitted with fluorescent, compact fluorescent, or light-emitting-diode (LED) lamps.			✓	✓				
Fixtures								
The applicant must ensure new or altered showerheads have a flow rate no greater than 9 litres per minute or a 3 star water rating.			✓	✓				
The applicant must ensure new or altered toilets have a flow rate no greater than 4 litres per average flush or a minimum 3 star water rating.			✓	✓				
The applicant must ensure new or altered taps have a flow rate no greater than 9 litres per minute or minimum 3 star water rating.			✓	✓				
Construction								
Insulation requirements								
The applicant must construct the new or altered construction (floor(s), walls, and ceilings/roofs) in accordance with the specifications listed in the table below, except that if additional insulation is not required where the area of new construction is less than 2m <sup>2</sup> , if insulation specified is not required for parts of altered construction where insulation already exists.			✓	✓				
Construction	Additional insulation required (R-value)	Other specifications						
concrete slab on ground floor.	nil							
suspended floor above garage: framed (R0.7)	nil							
floor above existing dwelling or building.	nil							
external wall: brick veneer	R1.16 (or R1.70 including construction)							
external wall: framed (weatherboard, fibro, metal clad)	R1.30 (or R1.70 including construction)							
flat ceiling, pitched roof	ceiling: R1.45 (up), roof: foil backed blanket (55 mm)	medium (solar absorptance 0.475 - 0.70)						


Windows and glazed doors					show on DA Plans	Center Check	show on CCDDC Plans & space	show on CCDDC Plans & space	show on CCDDC Plans & space
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The following requirements must also be satisfied in relation to each window and glazed door:					✓	✓			
Each window or glazed door with standard aluminium or timber frames and single clear or toned glass may either match the description, or have a U-value and a Solar Heat Gain Coefficient (SHGC) no greater than that listed in the table below. Total system U-values and SHGCs must be calculated in accordance with National Performance Rating Council (NPRC) conditions.					✓	✓			
For projections described in millimetres, the leading edge of each eave, pergola, verandah, balcony or awning must be no more than 500 mm above the head of the window or glazed door and no more than 2400 mm above the sill.					✓	✓			
Pergolas with polycarbonate roof or similar translucent material must have a shading coefficient of less than 0.35.					✓	✓			
Pergolas with fixed battens must have battens parallel to the window or glazed door above which they are situated, unless the pergola also shades a perpendicular window. The spacing between battens must not be more than 50 mm.					✓	✓			
Window / door	Orientation	Area of glass (m <sup>2</sup> )	Overhead shading (m)	Shading device	Frame and glass type				
D01	NE	8.65	0	0	none	standard aluminium, single clear, (or U-value: 7.63, SHGC: 0.75)			
D02	SE	5.94	0	0	awn/verandah/pergola/balcony >=450 mm	standard aluminium, single clear, (or U-value: 7.63, SHGC: 0.75)			
W01	SE	0.84	0	0	none	standard aluminium, single clear, (or U-value: 7.63, SHGC: 0.75)			
W02	SE	2.11	0	0	none	standard aluminium, single clear, (or U-value: 7.63, SHGC: 0.75)			
W03	NE	2.11	0	0	none	standard aluminium, single clear, (or U-value: 7.63, SHGC: 0.75)			

Skylights				show on DA Plans	Center Check	show on CCDDC Plans & space	show on CCDDC Plans & space	show on CCDDC Plans & space
The applicant must install the skylights in accordance with the specifications listed in the table below.				✓	✓			
The following requirements must also be satisfied in relation to each skylight:				✓	✓			
Each skylight may either match the description, or have a U-value and a Solar Heat Gain Coefficient (SHGC) no greater than that listed in the table below.				✓	✓			
Skylights glazing requirements								
Skylight number	Awning glazing (m <sup>2</sup> )	Shading device	Frame and glass type					
SK01_Ens	1.5	no shading	timber, double clear/air fill (or U-value: 4.3, SHGC: 0.9)					
Legend								
In these commitments, "applicant" means the person carrying out the development.								
Commitments identified with a "✓" in the "Show on DA plans" column must be shown on the plans accompanying the development application for the proposed development (if a development application is to be lodged for the proposed development).								
Commitments identified with a "✓" in the "Show on CCDDC plans & space" column must be shown in the plans and specifications accompanying the application for a construction certificate - complying development certificate for the proposed development.								
Commitments identified with a "✓" in the "Center check" column must be certified by a certifying authority as having been fulfilled, before a final occupation certificate for the development may be issued.								

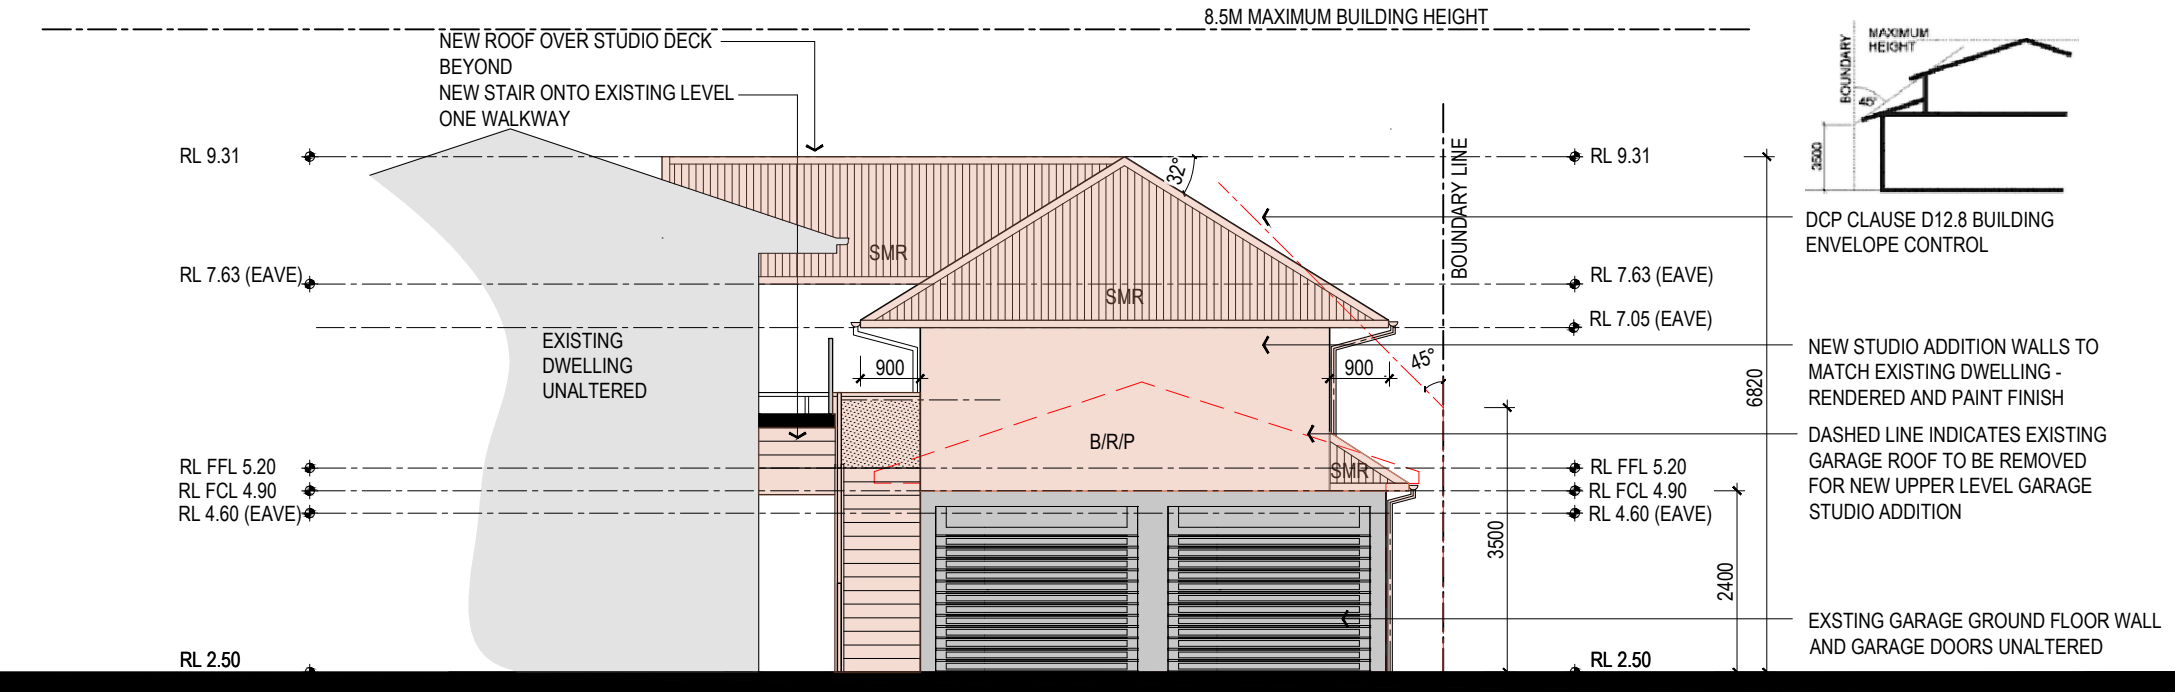


B NORTH - WEST ELEVATION  
SCALE 1:100

EXISTING DWELLING UNALTERED  
SHADED AREA DENOTES NEW WORK

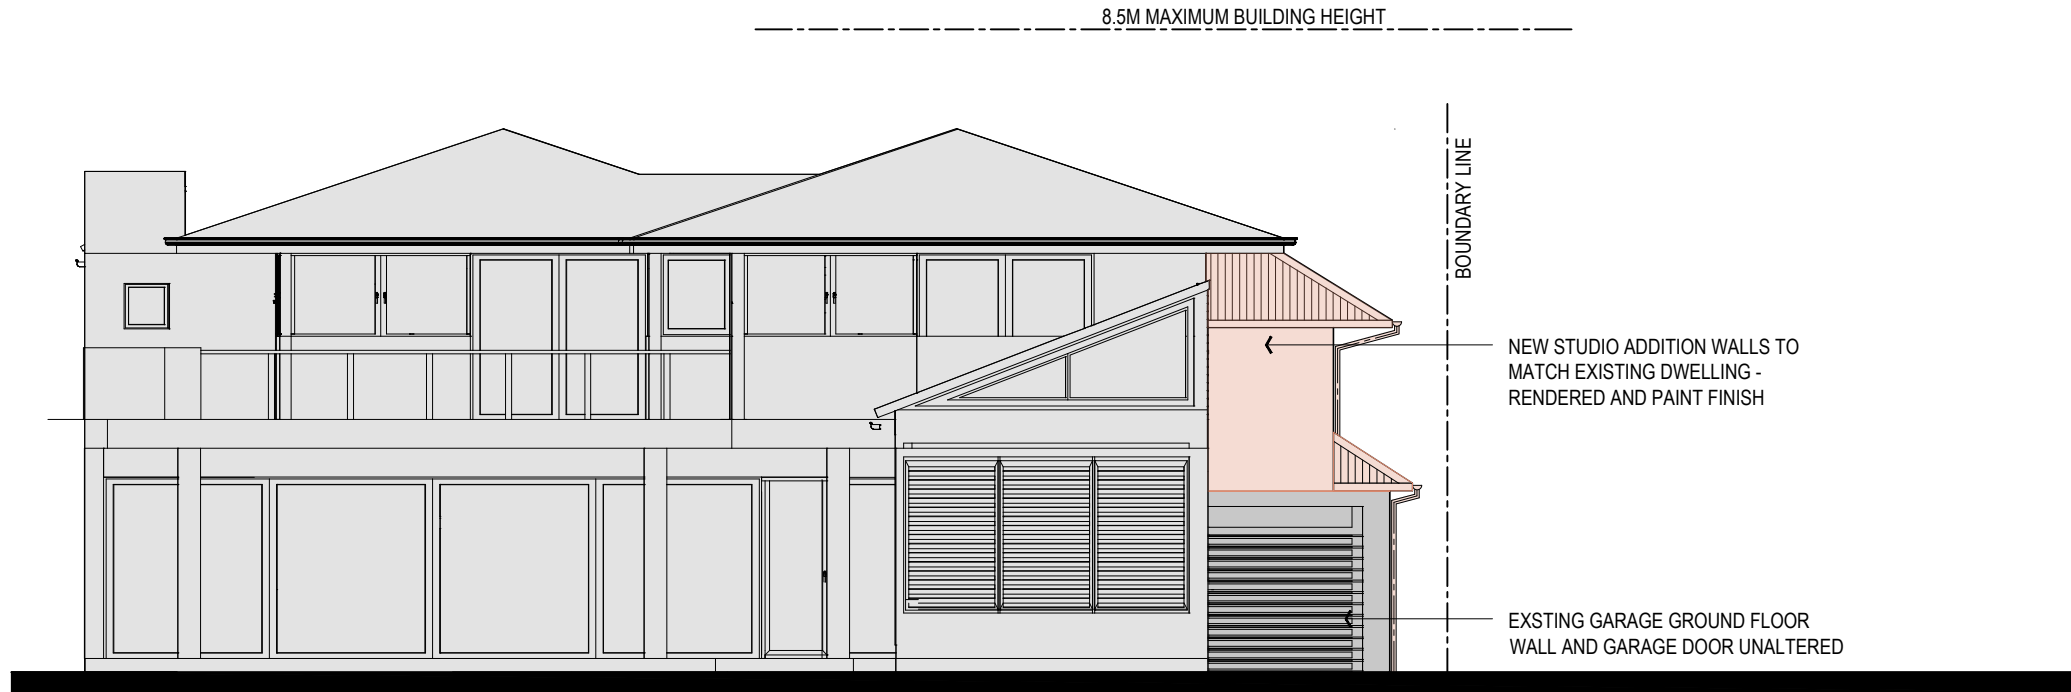

E WARATAH STREET ELEVATION  
SCALE 1:100

EXISTING DWELLING UNALTERED  
SHADED AREA DENOTES NEW WORK

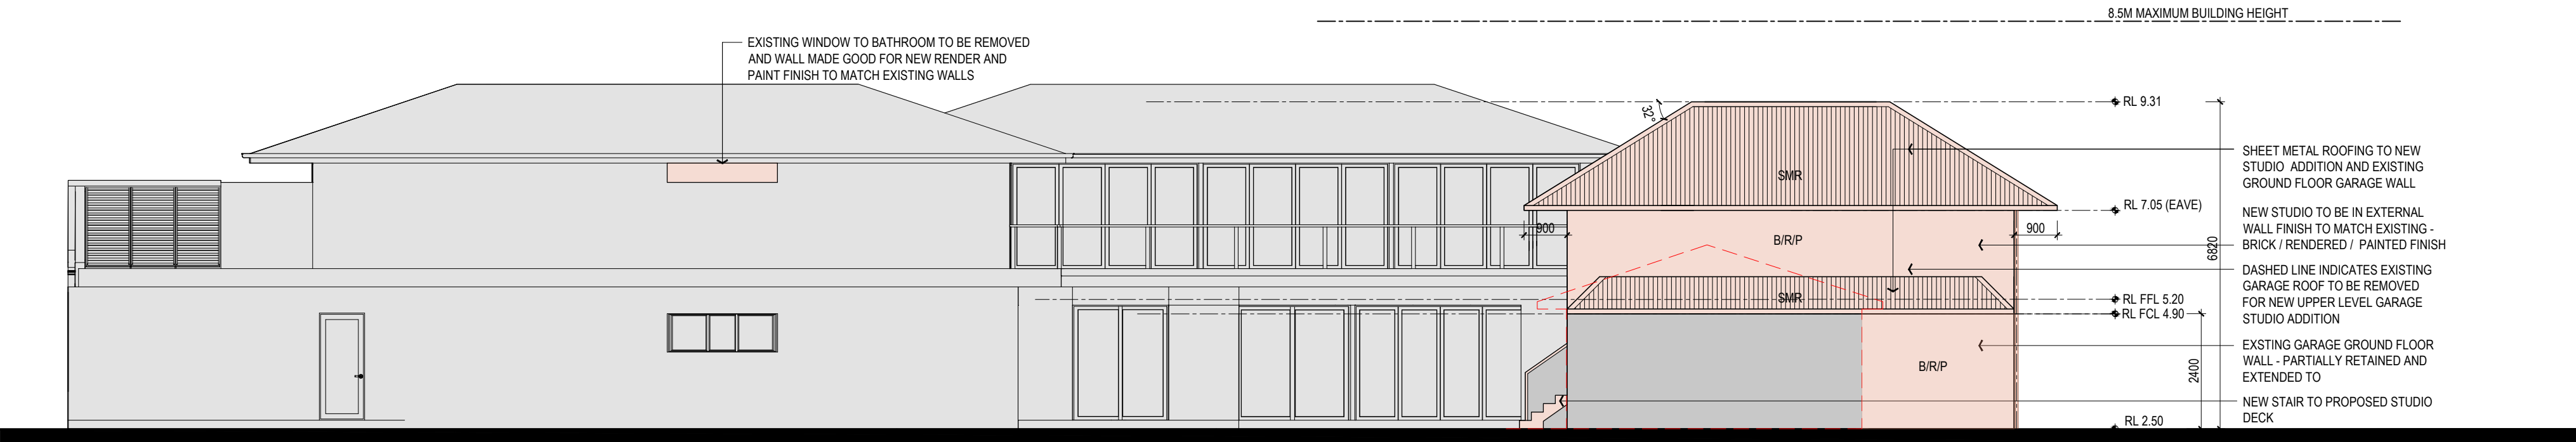

A SOUTH- WEST ELEVATION  
SCALE 1:100

EXISTING DWELLING UNALTERED  
SHADED AREA DENOTES NEW WORK

REV.	DATE	DESCRIPTION
A	16.08.2023	ISSUED TO PLANNER FOR REVIEW
B	20.09.2023	ISSUED FOR DEVELOPMENT APPLICATION

CHECKED
KM
KM

LEGEND	MATERIALS AND FINISHES
ABBREVIATIONS	
AC	AIR CONDITIONING
AHD	AUSTRALIAN HEIGHT DATUM
AS	AUSTRALIAN STANDARD
AW	AWNING WINDOW
BF	BIFOLD
CS	CASSETT WINDOW
DB	DOUBLE
DP	DOWNPIPE
(E)	EXISTING
EQ	EQUAL
F	FIXED
FCL	FINISHED CEILING LEVEL
FF	FIRST FLOOR
FFL	FINISHED FLOOR LEVEL
FRL	FINISHED REDUCED LEVEL
GF	GROUND FLOOR
JN	JOINERY
LFW	LINEAR FLOOR WASTE
LGP	LOWER GROUND FLOOR
NCC	NATIONAL CONSTRUCTION CODE (BCA)
NGL	NATURAL GROUND LEVEL
NTS	NOT TO SCALE
PV	PHOTO VOLTAICS
RT	ROOF TILE
SKL	SKYLIGHT
SLM	SLIDING DOOR
TOG	TOP OF GUTTER
V	VENT
VOS	VERIFY ON SITE
AD	ALUMINIUM DOOR
AL	ALUMINIUM
AW	ALUMINIUM WINDOW
BB	BRICK
BM	BUTYLINOUS MEMBRANE
CA	CLEAR FINISH
CE	CEMENT RENDER
FB	FASCIA BOARD
FC	FIBRE CEMENT
G	GLAZED
GD	GLAZED TIMBER DOOR
MRS	METAL ROOF SHEETING
P	PAINTED
PAV	PAVING
PB	PLASTERBOARD
R	RENDERED
RC	REINFORCED CONCRETE
S	SLATE
ST	STONE
T	TIMBER
TB	TIMBER BATTEN
TD	TIMBER DOOR
TK	TIMBER BECKING
TDK	TIMBER DOOR & GROOVE
TLC	TILE - TERRACOTTA
TW	TIMBER WINDOW
TLF	TILE - FLOOR
WB	WEATHERBOARD
VT	VITRIFIED TILE
ZRS	ZINC ROOF SHEETING

two form Pty Ltd  
Nominated Architect Kristina Mitkovski NSW Reg No. 7998

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The Contractor shall confirm on site existing dimensions and conditions before commencement of works. All discrepancies should be reported to the Architect for instructions. Two Form does not accept responsibility for the dimensional accuracy of any data contained in CAD or other attachments as it may be based on third party origin information. All information should be verified in writing

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Check and verify all dimensions on site and refer any errors and/or omissions to the Architect before proceeding further. Do not scale off the drawings. Drawings shall not be used for construction purposes until issued by the Architect for such purpose. For explanation of abbreviations and symbols refer to appropriate legends. © Copyright TWO FORM PTY LTD

CLIENT  
STEPHEN AND SUSAN JONES

PROJECT  
ALTERATIONS AND ADDITION TO EXISTING DWELLING  
3 WARATAH ROAD, PALM BEACH LOT 15 DP 651513

DRAWING NAME  
NORTH WEST AND  
SOUTH WEST ELEVATION

DRAWING STAGE  
DEVELOPMENT APPLICATION

DRAWING NUMBER  
22 026 AR DA 07

DATE  
AUG 2023

SCALE  
1:100 AT A2

REVISION  
B

Alterations and Additions

Certificate number: AS05299

spec				spec				spec			
<b>Lighting</b>				<b>Windows and glazed doors</b>				<b>Skylights</b>			
The applicant must ensure a minimum of 40% of new or altered light fixtures are fitted with fluorescent, compact fluorescent, or light-emitting diode (LED) lamps.				The applicant must install the windows, glazed doors and shading devices, in accordance with the specifications listed in the table below. Relevant overshadowing specifications must be satisfied for each window and glazed door.				The applicant must install the skylights in accordance with the specifications listed in the table below.			
<b>Fixtures</b>				The following requirements must also be satisfied in relation to each window and glazed door:				The following requirements must also be satisfied in relation to each skylight:			
The applicant must ensure new or altered showerheads have a flow rate no greater than 9 litres per minute or a 3 star water rating.				Each window or glazed door with standard aluminium or timber frames and single clear or tinted glass may either match the description, or, have a U-value and a Solar Heat Gain Coefficient (SHGC) no greater than that listed in the table below. Total system U-values and SHGCs must be calculated in accordance with National Fenestration Rating Council (NFRC) conditions.				Each skylight may either match the description, or, have a U-value and a Solar Heat Gain Coefficient (SHGC) no greater than that listed in the table below.			
The applicant must ensure new or altered toilets have a flow rate no greater than 4 litres per average flush or a minimum 3 star water rating.				For projections described in millimetres, the leading edge of each awning, pergola, verandah, balcony or awning must be no more than 500 mm above the head of the window or glazed door and no more than 2400 mm above the sill.				<b>Skylights glazing requirements</b>			
The applicant must ensure new or altered taps have a flow rate no greater than 9 litres per minute or minimum 3 star water rating.				Pergolas with polycarbonate roof or similar translucent material must have a shading coefficient of less than 0.35.				Legend			
<b>Construction</b>				Pergolas with fixed battens must have battens parallel to the window or glazed door above which they are situated, unless the pergola also shades a perpendicular window. The spacing between battens must not be more than 60 mm.				In these commitments, "applicant" means the person carrying out the development.			
The applicant must construct the new or altered construction (floor(s), walls, and ceilings/roofs) in accordance with the specifications listed in the table below, except that a) additional insulation is not required where the area of new construction is less than 2m <sup>2</sup> , b) insulation specified is not required for parts of altered construction where insulation already exists.				Commitments identified with a "u" in the "Show on DA plans" column must be shown on the plans accompanying the development application for the proposed development (if a development application is to be lodged for the proposed development).				Commitments identified with a "u" in the "Show on CCDC plans & specs" column must be shown in the plans and specifications accompanying the application for a construction certificate / complying development certificate for the proposed development.			
<b>Commitments</b>				Commitments identified with a "u" in the "Certifier check" column must be certified by a certifying authority as having been fulfilled, before a final occupation certificate for the development may be issued.				Commitments identified with a "u" in the "Certifier check" column must be certified by a certifying authority as having been fulfilled, before a final occupation certificate for the development may be issued.			