


Brookvale NSW 2100

SITE ADDRESS:

Rev: B

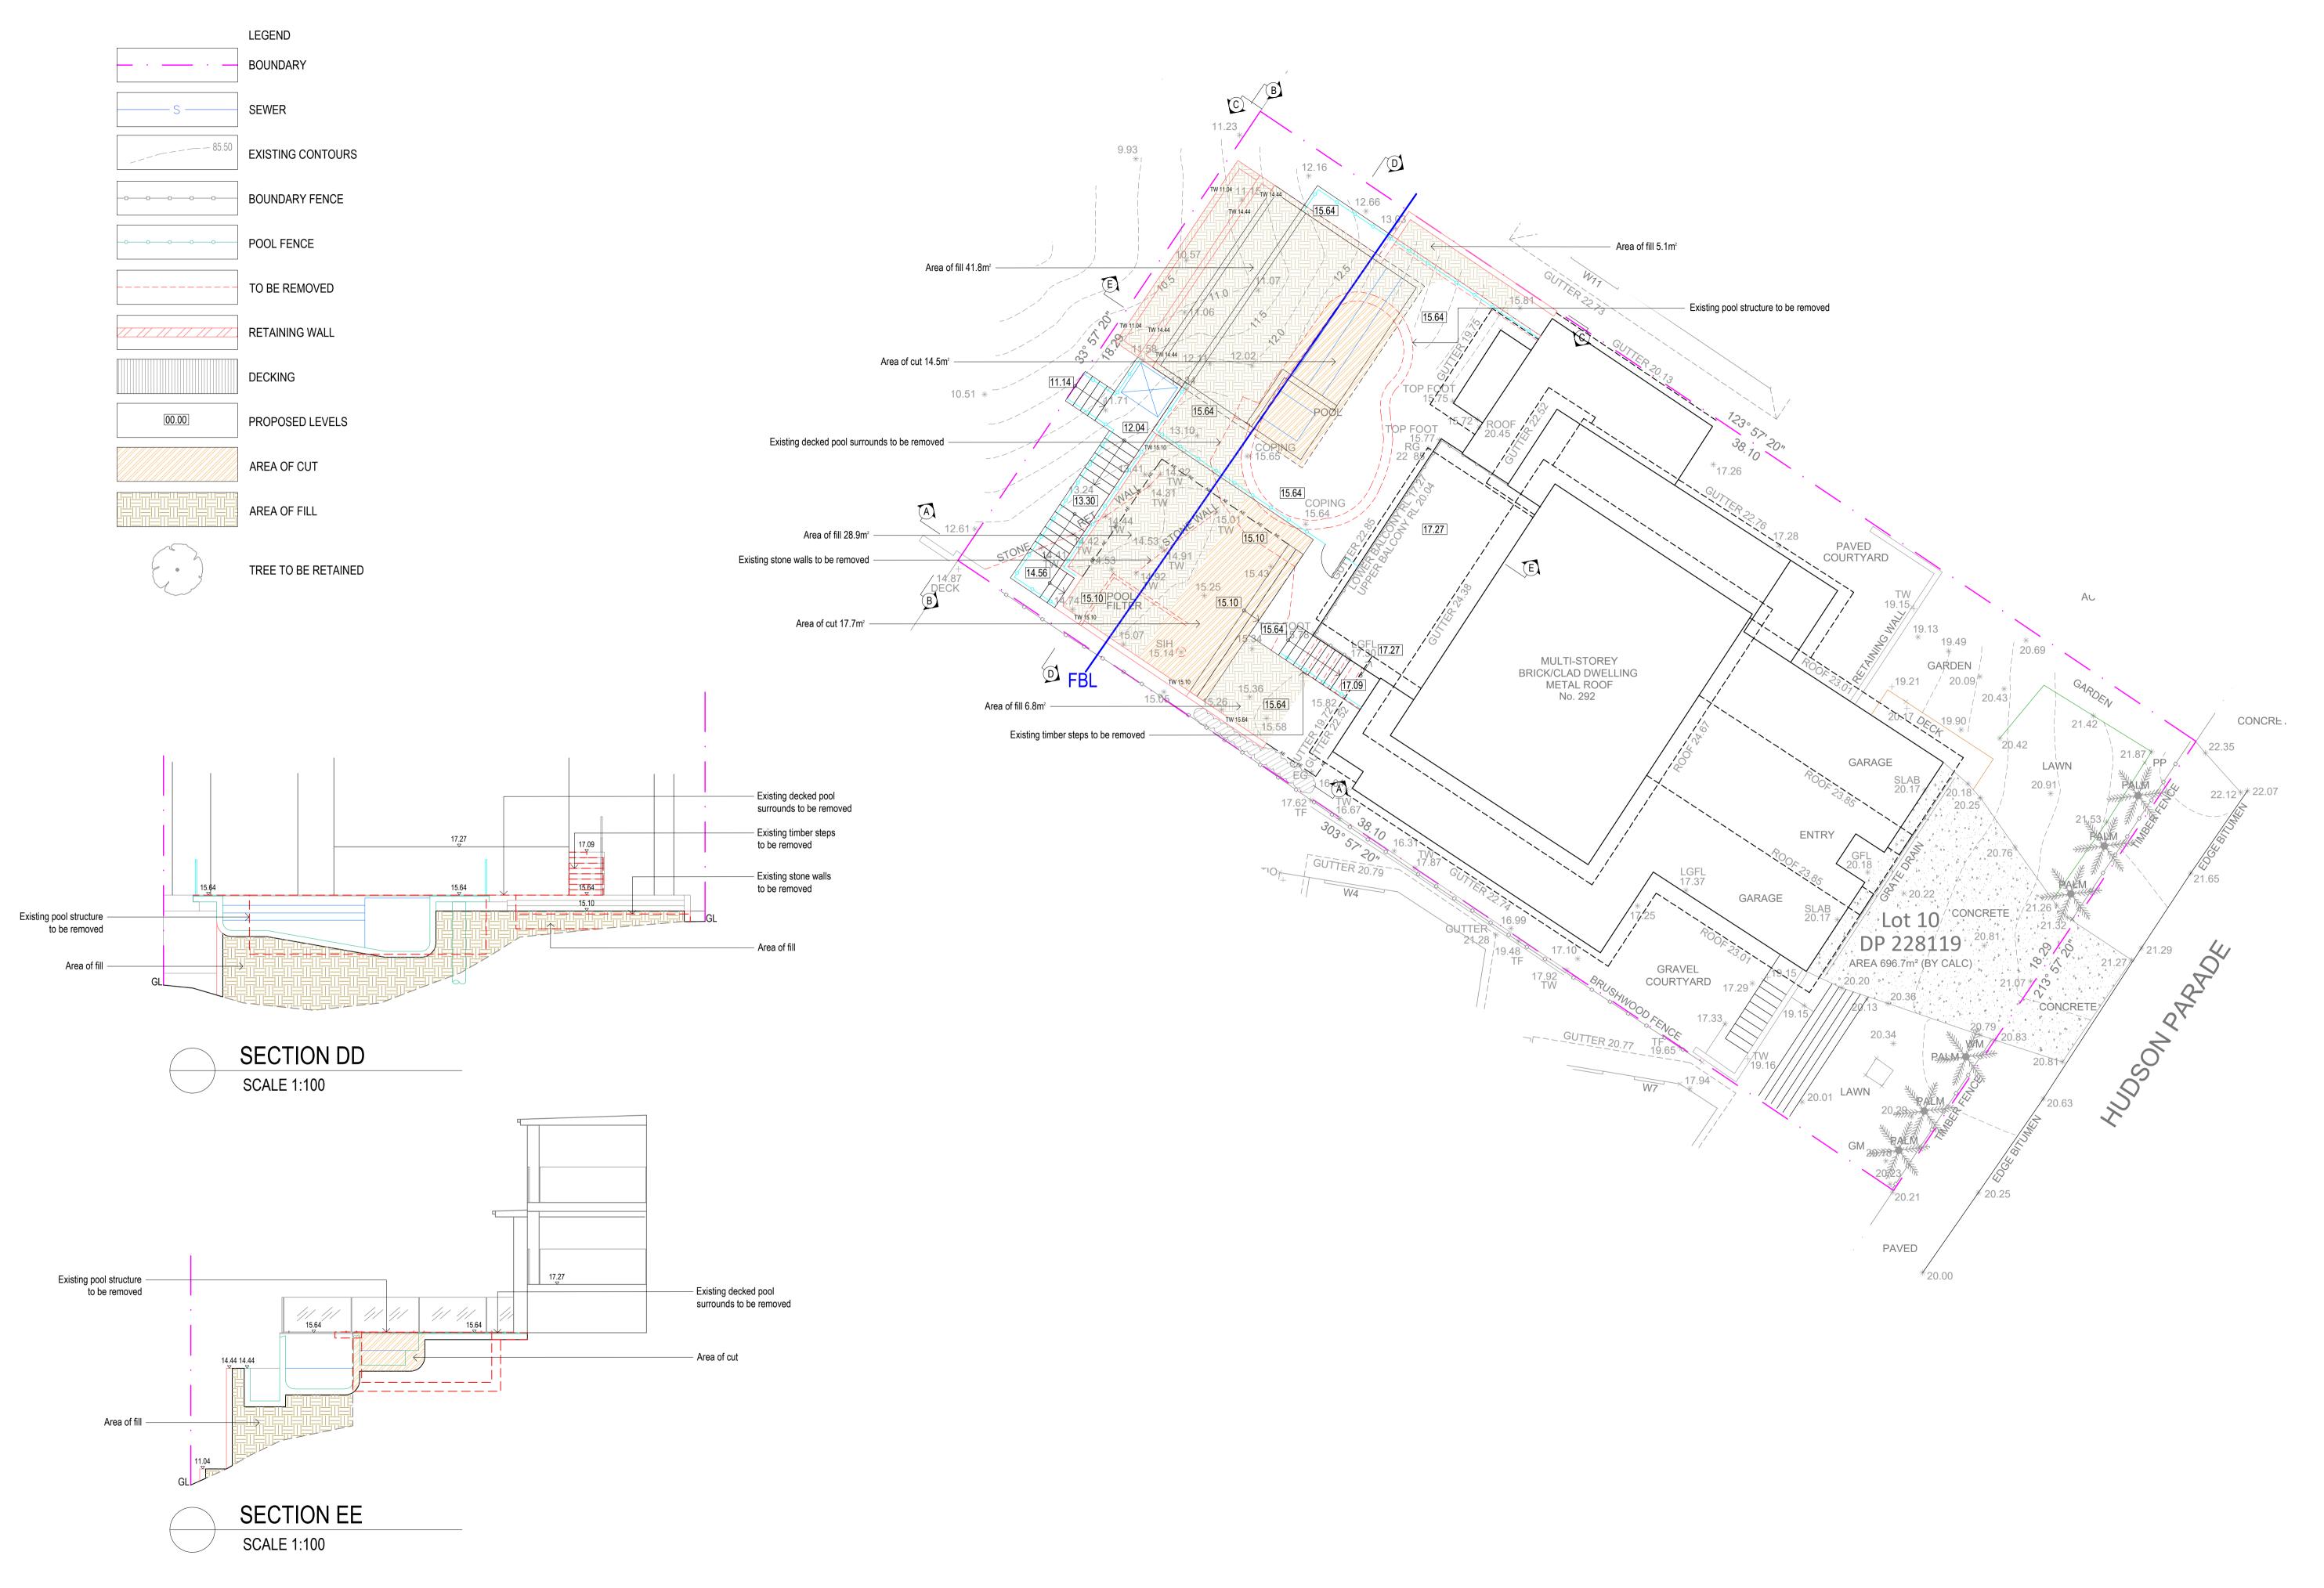

| Rev. | Date | Issue | A | 30/10/24 | Preliminary Issue | DA Issue | - Contractors to check and verify all dimensions and all levels on site prior to any works.

- Any discrepancies should be immediately referred to Space Landscape Designs.

- All work to comply with B.C.A. Statutory Authorities and relevant Australian Standards.


- Dimensions recognised over scaling. All measurements are in millimetres.

S P A C E
LANDSCAPE DESIGNS


Space Landscape Designs Pty Ltd ABN 60 799 663 674 ACN 139 316 251 info@spacedesigns.com.au **P** 02 9905 7870 **F** 02 9905 7657


CLIENT: Justin Gittoes Landscape & Swimming Pool DRN: T.Browne (B.L.Arch) SCALE: 1:100@A1


DRAWING TITLE: DEMOLITION PLAN
EXCAVATION & FILL PLAN
DRAWING No: DA-02

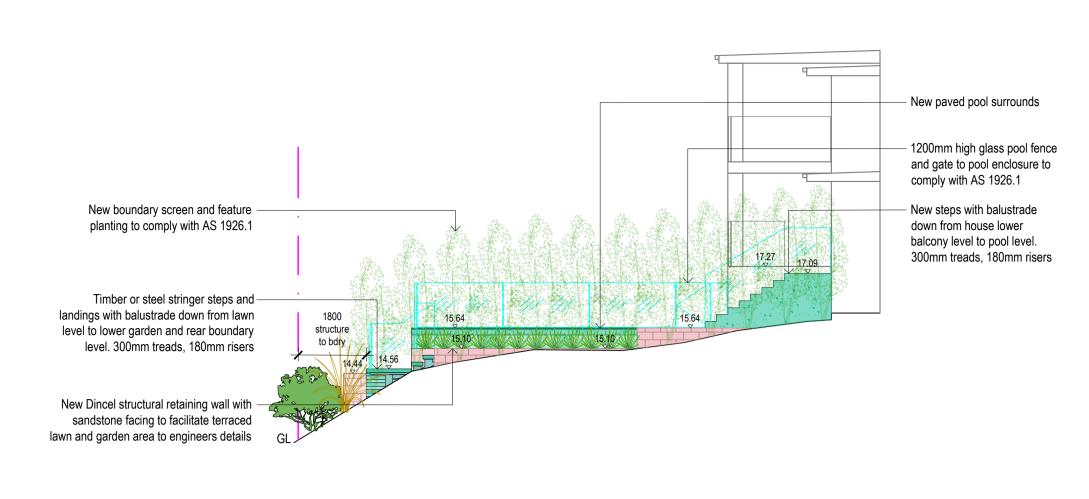




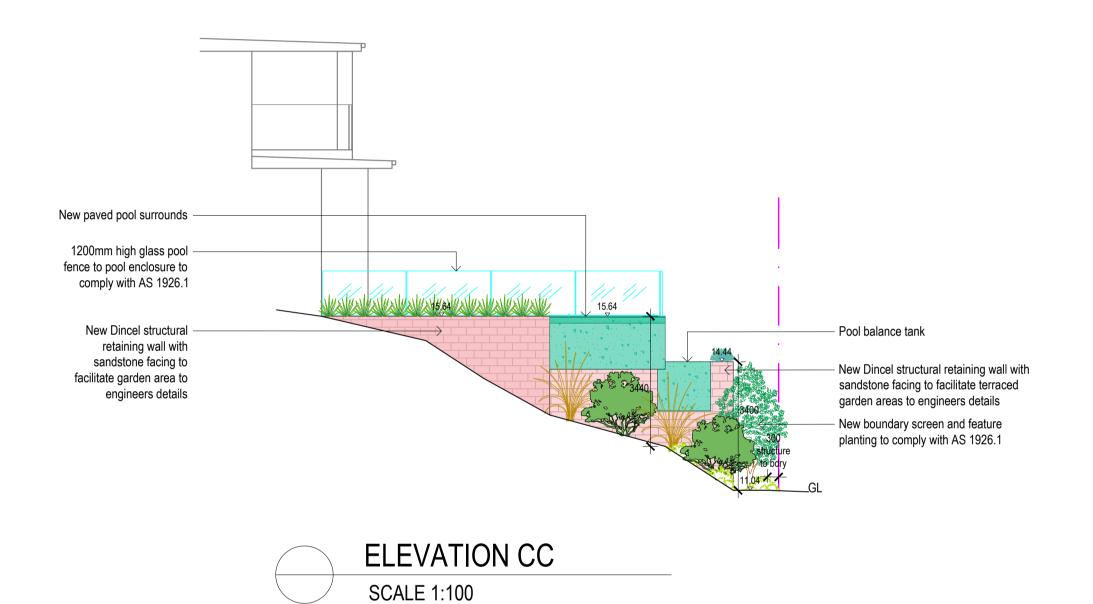

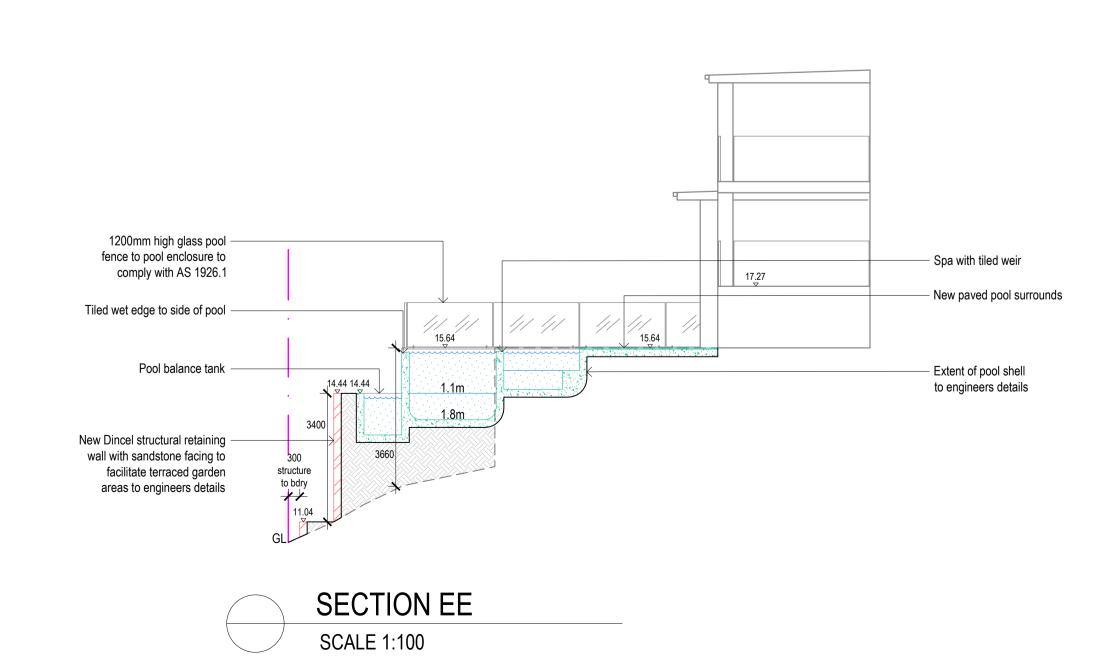

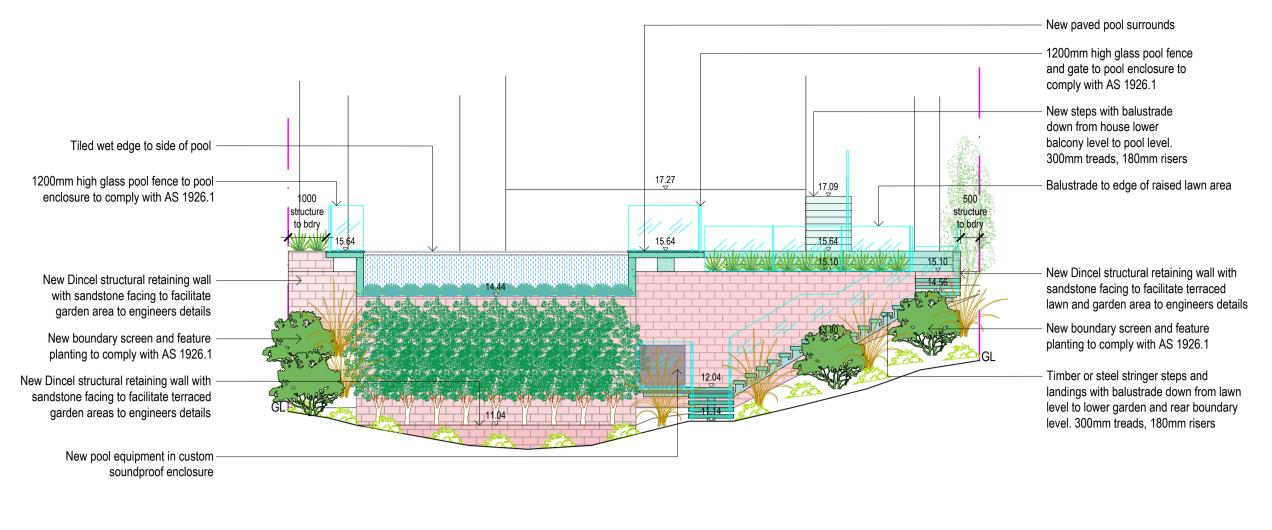



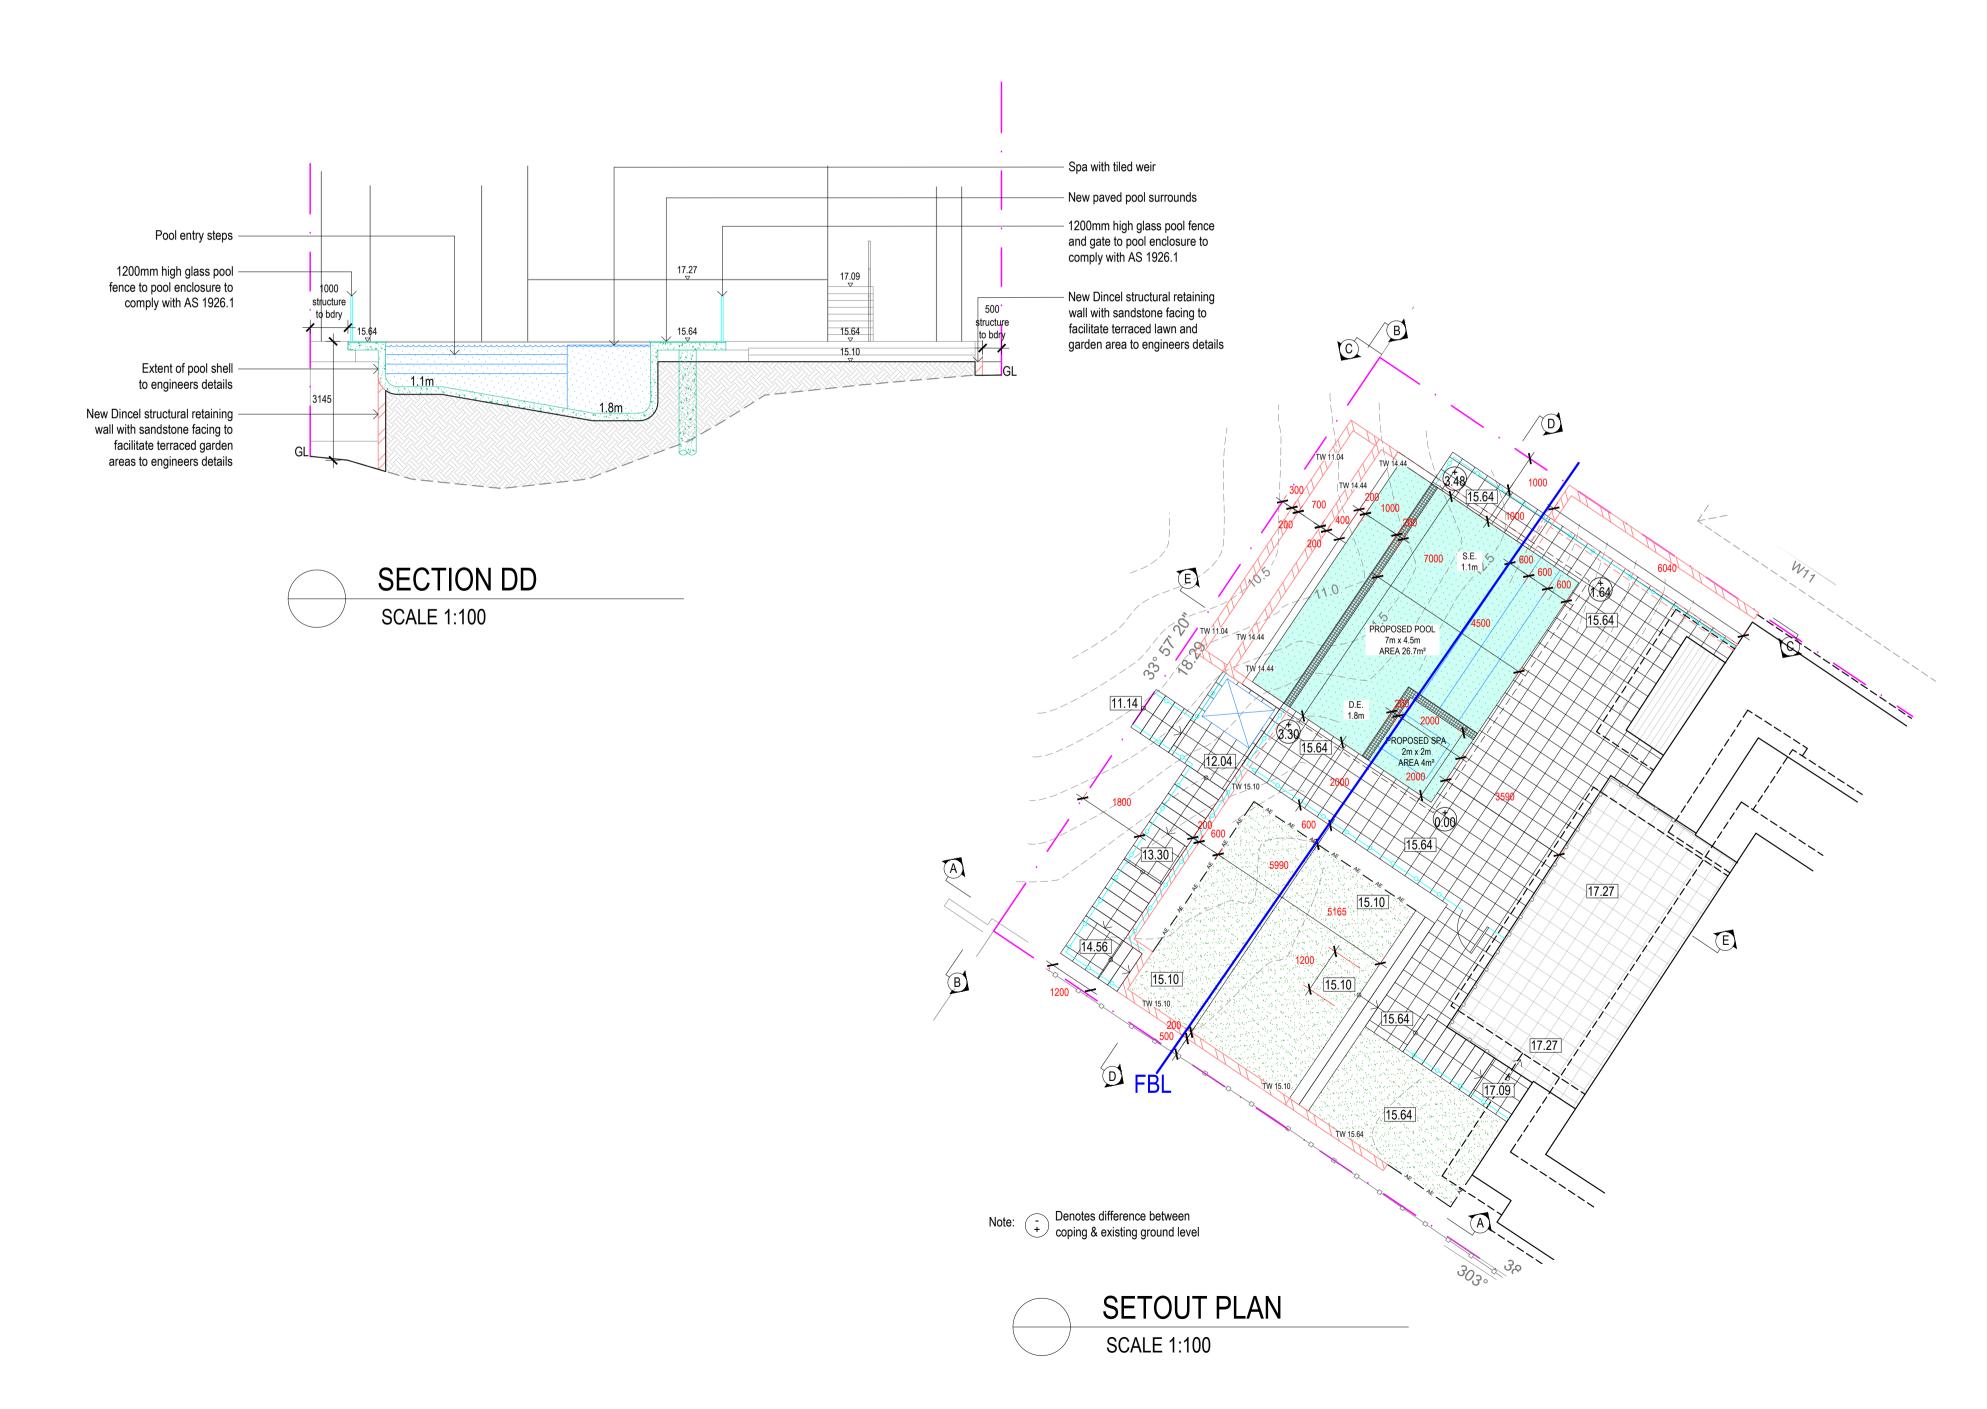

NEW WORKS COLOURS

TIMBER

GLASS

BRICK

METAL

CONCRETE



LANDSCAPE SITE CALCULATIONS

Site Area 696.7m²
Required Landscape Area 418.02m² (60%)

Approved Landscape Area 241.70m² (34.7%)
Approved Impervious Areas <1m wide
Approved Impervious area allowance
Total Landscape Areas: 241.70m² (34.7%)
8.3m² (1.2%)
41.80m² (6%)
291.80m² (41.9%)

 Proposed Landscape Area
 212.5m² (30.5%)

 Impervious Areas <1m wide</td>
 8.2m² (1.2%)

 Impervious area allowance
 41.80m² (6%)

 Total Landscape Areas:
 262.50m² (37.7%)

SITE CALCULATIONS KEY





IMPERVIOUS LANDSCAPE AREA <1m

NOTES:

Contractors to check and verify all dimensions and all levels on site prior to any works.

Any discrepancies should be immediately referred to Space Landscape Designs.

All work to comply with B.C.A. Statutory Authorities and relevant Australian Standards.

Dimensions recognised over scaling. All measurements are in millimetres.

Rev.DateIssueA30/10/24Preliminary IssueB04/12/24DA Issue

AE AE

S P A C E

Space Landscape Designs Pty Ltd
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info@spacedesigns.com.au spacedesigns.com.au P 02 9905 7870 F 02 9905 7657 Suite 138, 117 Old Pittwater Rd, Brookvale NSW 2100 Landscape & Swimming Pool

site address: 292 Hudson Parade, CLAREVILLE NSW 2107 CLIENT: Justin Gittoes

DRN: T.Browne (B.L.Arch)

SCALE: 1:200@A3

PROJECT NO: 242217



SITE CALCULATIONS

DRAWING No:

Rev: B




FORESHORE BUILDING MAP

EXTRACT FROM PLEP

Foreshore Building Line Calculations


Approved structures within the FBL 28.5m² Proposed structures within the FBL 64.3m²

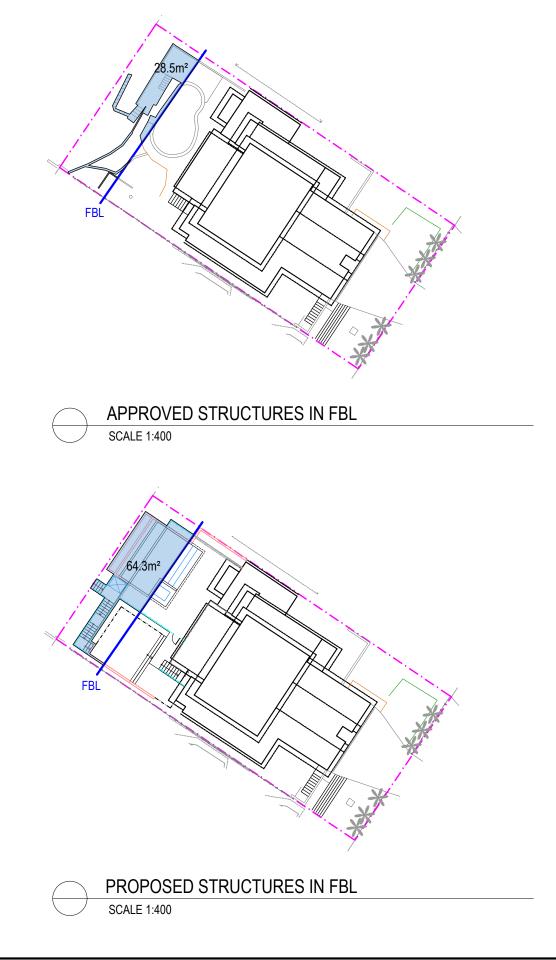

DRN:	T.Browne (B.L.Arch)	
SCALE:	1·400@A3	

PROJECT NO: 242217

Rev: B

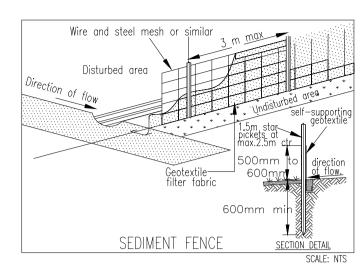

SEDIMENT & EROSION CONTROL NOTES

During earthworks the following procedures shall be followed: 1. Install silt barriers where shown on plan prior to commencement of works. 2. Silt barriers to be maintained regularly & after heavy rain by removal of built up silt & spreading silt on existing site when 50% capacity. 3. Repair any damages to fence immediately.

4. Clean up spillages outside silt fence immediately.

5. Sediment control measures to be left in place until works completed.

6. Topsoil from the work's area will be stockpiled for later use in landscaping if necessary.

7. Approved bins for building waste, concrete and mortar slurries, paints and acid washings will be provided by contractor.

Installation and Maintenance of Sediment and Erosion Controls

Prior to any works commencing on site, including demolition, sediment and erosion controls must be installed in accordance with Landcom's 'Managing Stormwater: Soils and Construction' (2004). Techniques used for erosion and sediment control on site are to be adequately maintained and monitored at all times, particularly after periods of heavy rain, and shall remain in proper operation until all development activities have been completed and the site is sufficiently stabilised with vegetation across 70 percent of the site, and the remaining areas have been stabilised with ongoing measures such as jute meshing or matting.

Tree Protection

Unless identified by the development consent, existing trees shall be protected in accordance with AS4970-2009 Protection of Trees on Development Sites, with particular reference to Section 4, with no ground intrusion into the tree protection zone and no trunk, branch nor canopy disturbance.

Should any problems arise with regard to the existing trees on public land during the construction period, immediately contact Council's Tree Services section.

Maintenance of Road Reserve

The public footways and roadways adjacent to the site shall be maintained in a safe condition at all times during the course of the works.

Hazardous Materials Management Plan


- Should any hazardous materials be identified by the contractor, contact SafeWork NSW to find a licensed
- Notify SafeWork NSW five calendar days before undertaking any licenced asbestos removal work.
- The site must be fenced prior to demolition and must comply with Safework NSW requirements. Demolition to be carried out in accordance with AS 2601-2001, The Demolition of Structures.

Work Plan

The person responsible for the development site is to erect or install on or around the development area such temporary structures or appliances (wholly within the development site) as are necessary to protect persons or property and to prevent unauthorised access to the


site in order for the land or premises to be maintained in a safe or healthy condition.

- No demolition material shall be placed on Council's footpath, road or grass verges without Council
- Upon completion of the development, such temporary structures or appliances are to be removed within 7
- Demolition works are restricted to 8am to 5pm Monday to Friday only
- Where demolition works have been completed and new construction works have not commenced within 4 weeks of completion of the demolition works that area affected by the demolition works shall be maintained in a safe and clean state until such time new construction works commence.

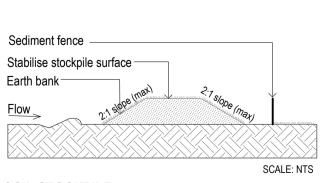

SOIL STOCKPILE

Diversion drain and bank Waterproof -Sediment fence— (where possible) SCALE: NTS **BUILDING MATERIAL STOCKPILES**

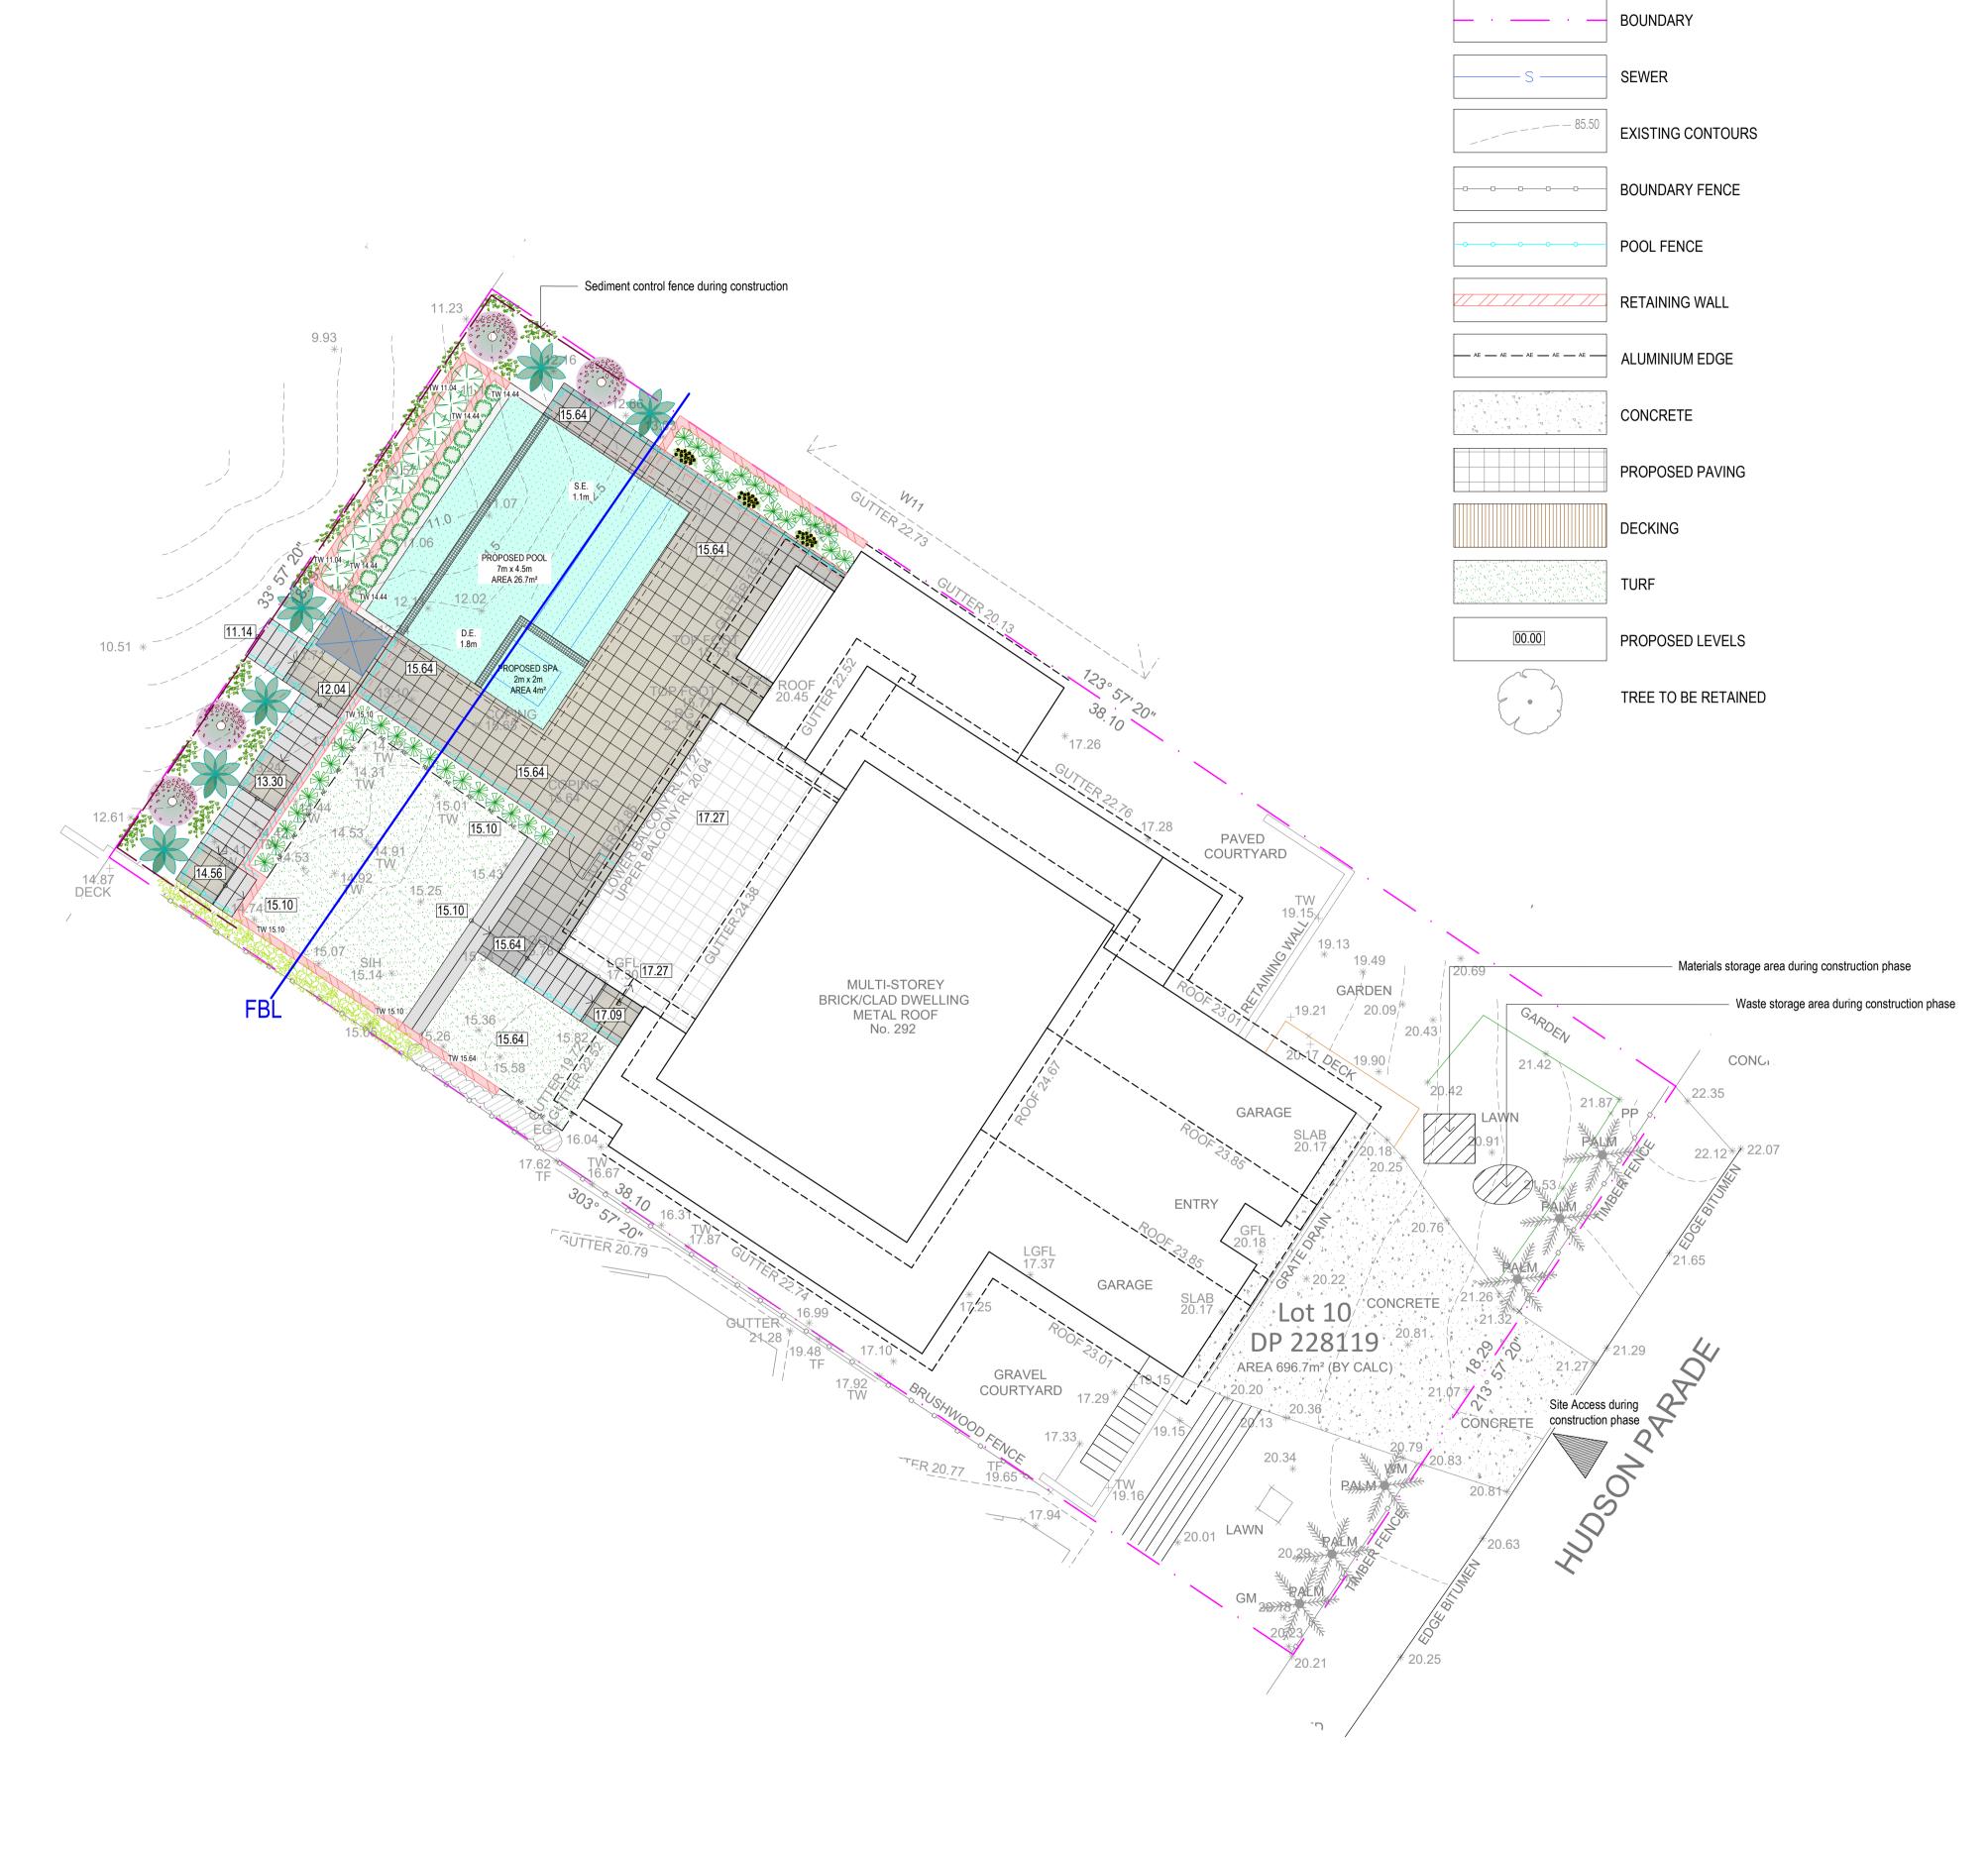

P 02 9905 7870 **F** 02 9905 7657

Suite 138, 117 Old Pittwater Rd,

ITE ADDRESS:

CLAREVILLE NSW 2107

LEGEND