

ID	Latin Name	Common Name	Quantity	Spread	Height
ACS	Acmena smithii 'Minor'	Lillypilly	9	2000	2500
ACH	Actinotus helianthi	Flannel Flower	7	1000	1000
BSP	Banksia spinulosa	Hairpin Banksia	2	3000	3500



LAWN AREA

Date	Rev	Amendment	PROPOSED SINGLE HOUSE
			DA 28 Stuart St, Collaroy NSW 2097



Drawn by: RT
Checked by: MW
Title: LANDSCAPE PLAN



LANDSCAPE

PRIVATE OPEN SPACE

SITE PLAN: 738.3 m²

LANDSCAPE: 370.43 m² = 50.17% IMPERVIOUS AREA: 367.87 m² = 49.83%

PRIVATE OPEN SPACE: 60 m²

Project:
PROPOSED SINGLE HOUSE
DA
28 Stuart St, Collaroy NSW 2097



Vigor Master Pty Ltd Ti

Chatswood NSW 2067


Tel. 02 9411 3998


Fax. 02 9413 3983

Email. info@vigormaster.com.au

Drawn by: RT
Checked by: MW
Title: LANDSCAPE & OPEN SPACE CALCULATION



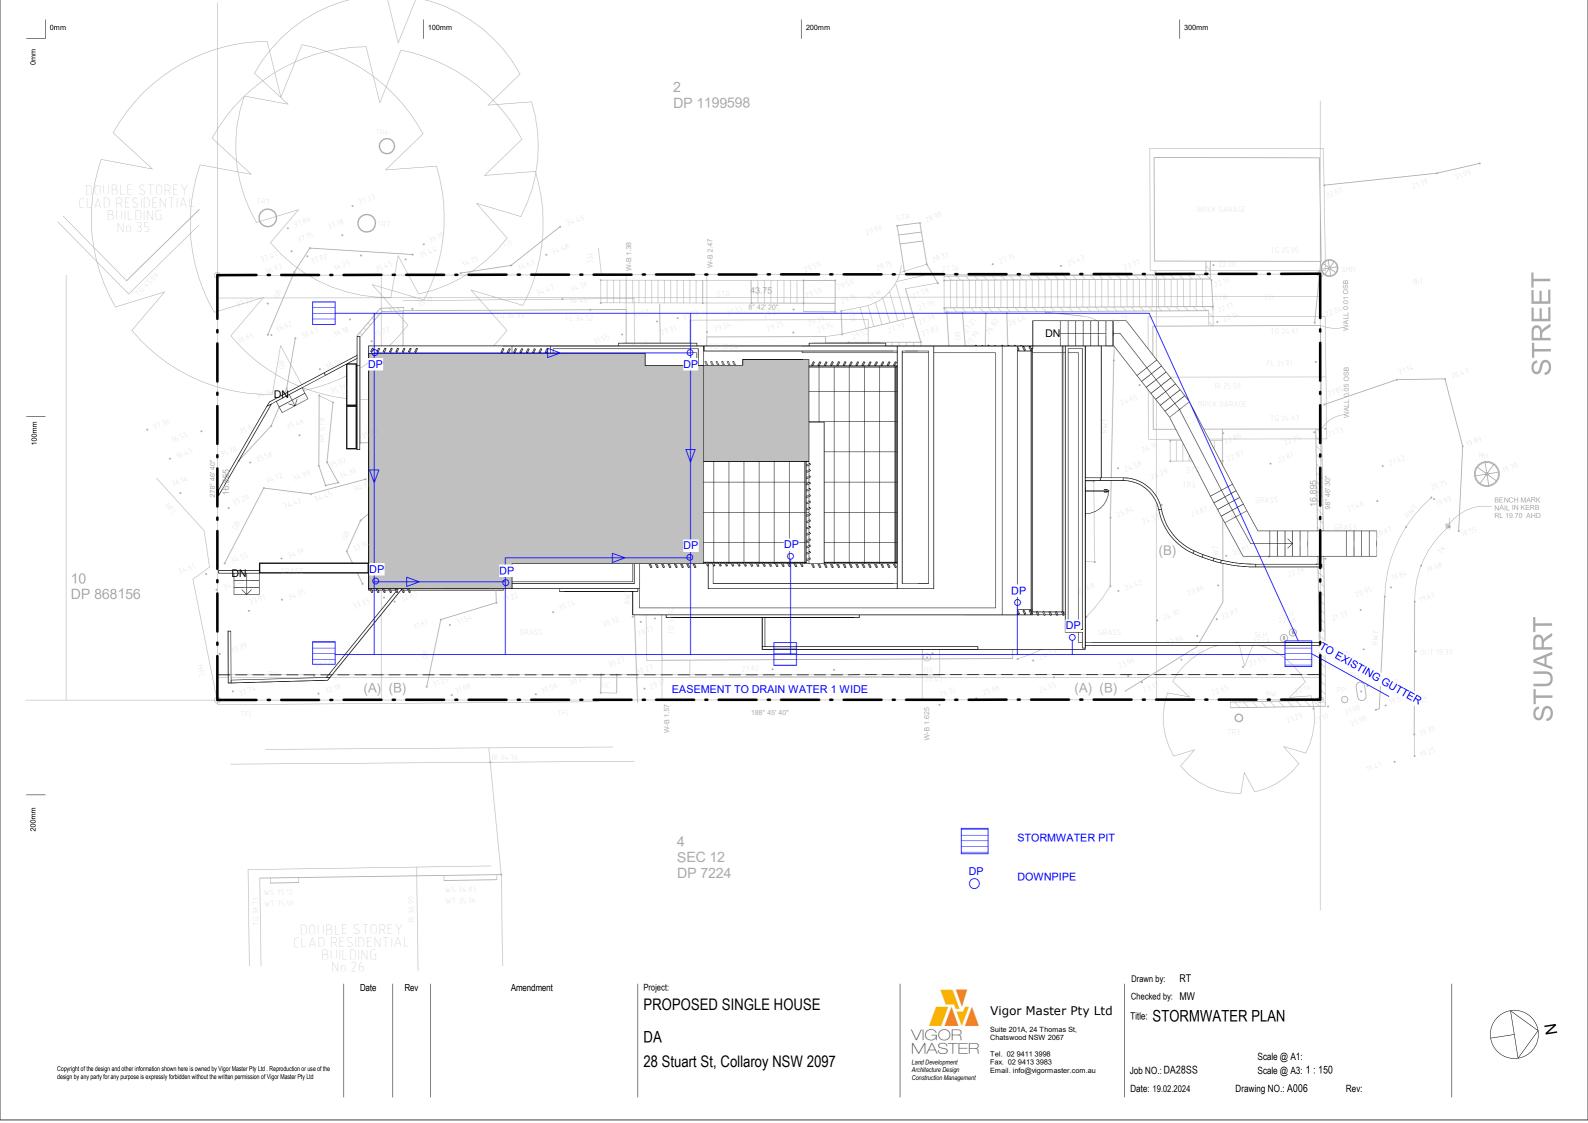

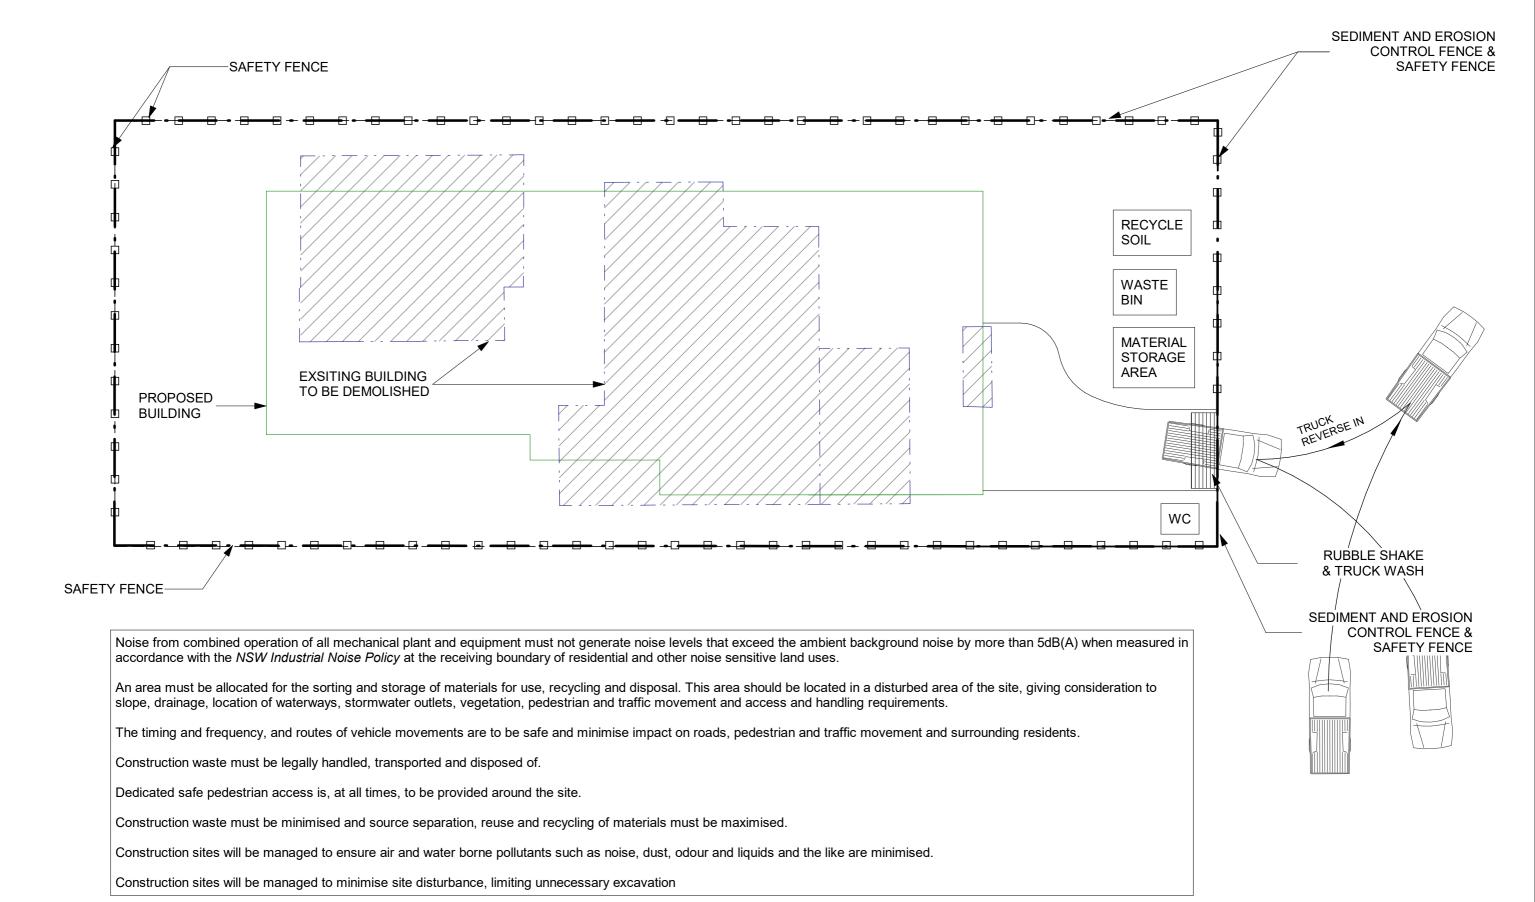



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PROPOSED SINGLE HOUSE

DA

28 Stuart St, Collaroy NSW 2097



Vigor Master Pty Ltd Suite 201A, 24 Thomas St, Chatswood NSW 2067

Tel. 02 9411 3998 Fax. 02 9413 3983 Email. info@vigormaster.com.au Drawn by: RT
Checked by: MW
Title: CONSTRUCTION SITE MANAGEMENT PLAN



CUT AREA



FILL AREA

Date	Rev	An

Amendment

PROPOSED SINGLE HOUSE

DA


28 Stuart St, Collaroy NSW 2097




Vigor Master Pty Ltd

Tel. 02 9411 3998 Fax. 02 9413 3983 Email. info@vigormaster.com.au Drawn by: RT
Checked by: MW
Title: CUT & FILL PLAN



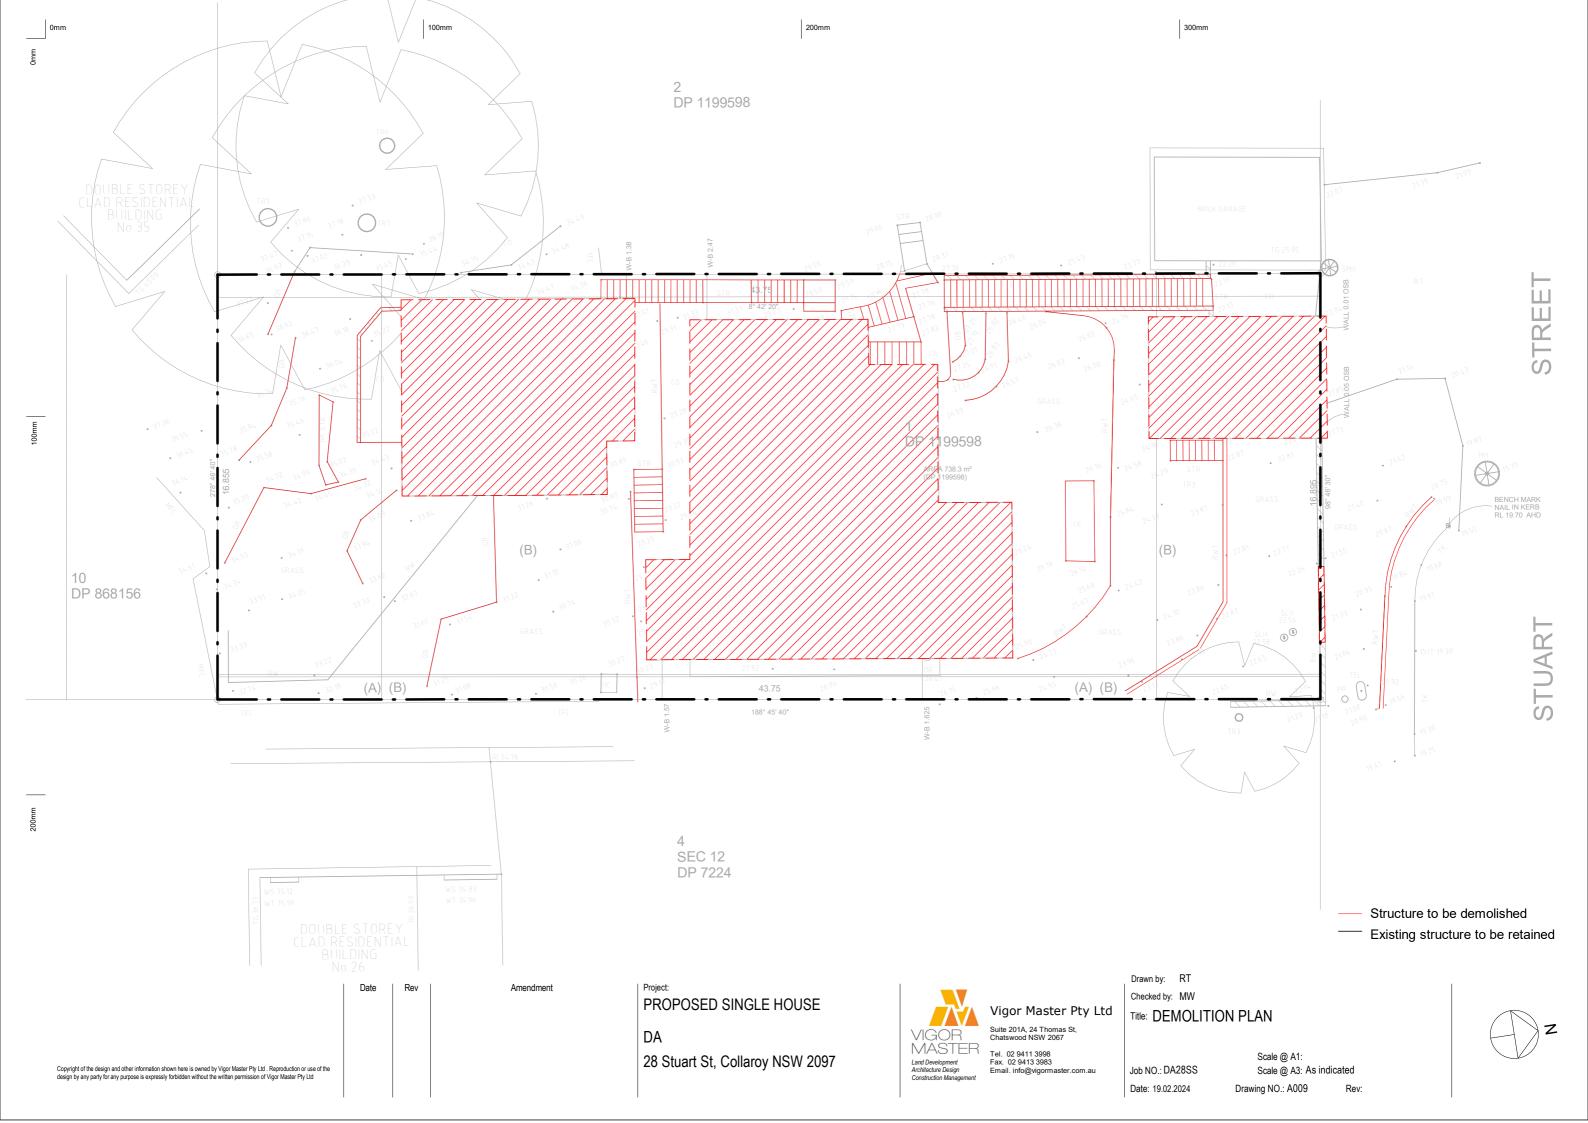

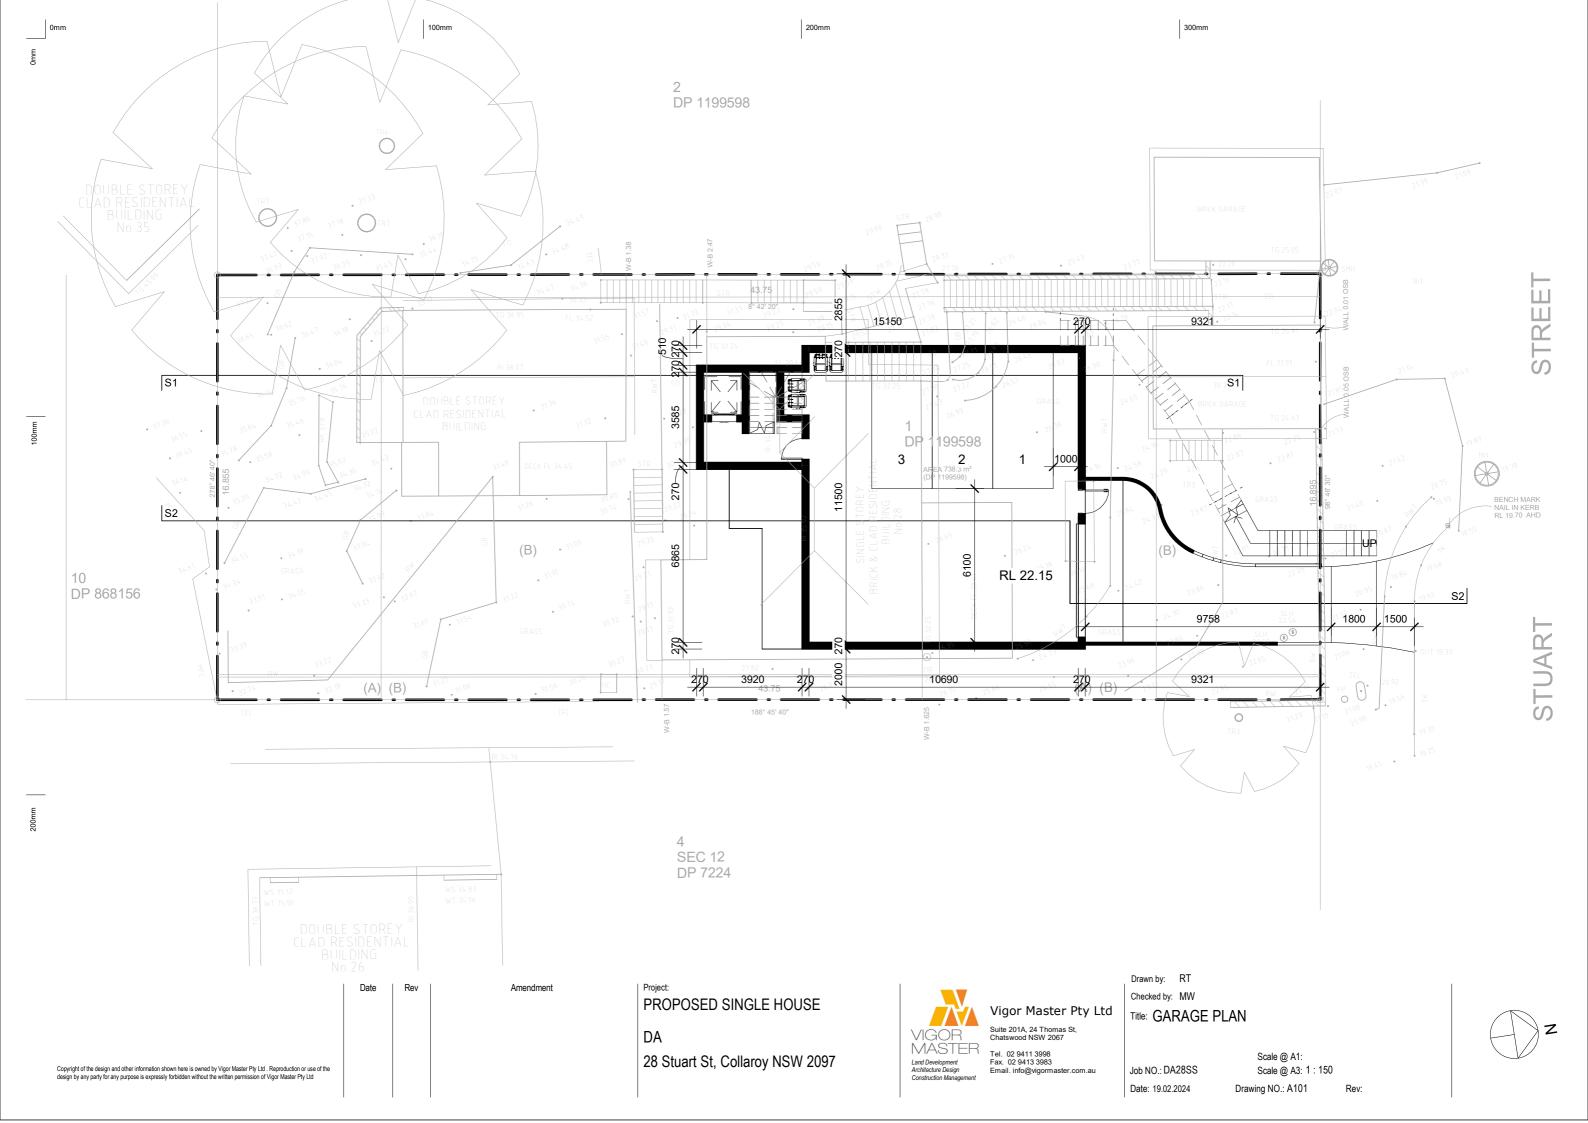


Amendment Project:
PROPOSED SINGLE HOUSE


DA
28 Stuart St, Collaroy NSW 2097



Drawn by: RT
Checked by: MW
Title: LOWER GROUND FLOOR PLAN



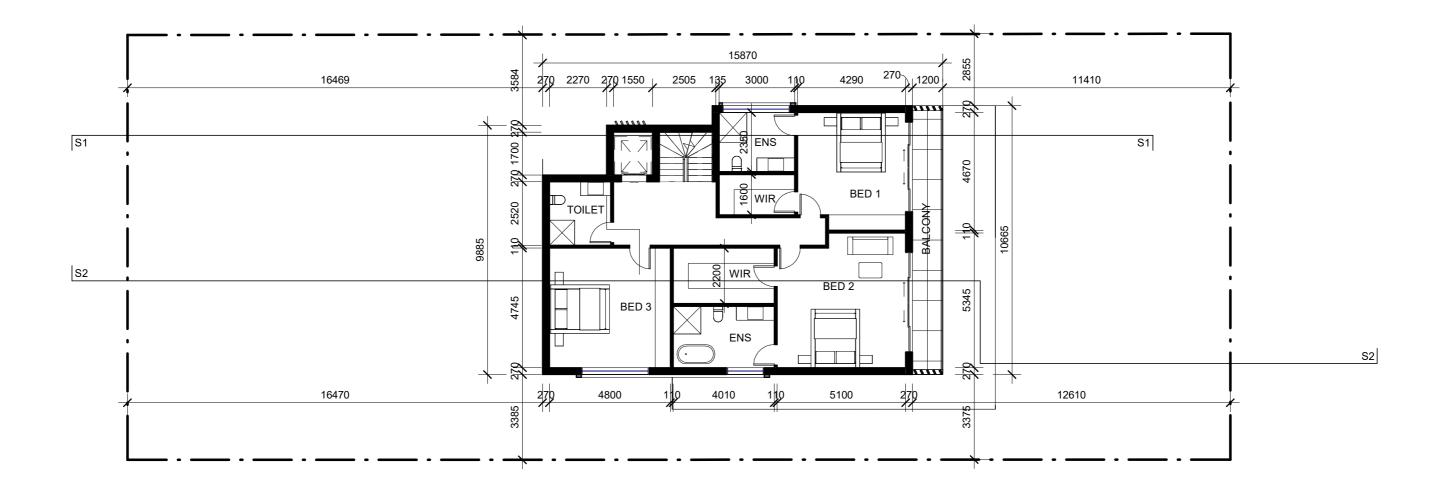


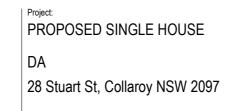



Drawn by: RT
Checked by: MW
Title: GROUND FLOOR PLAN



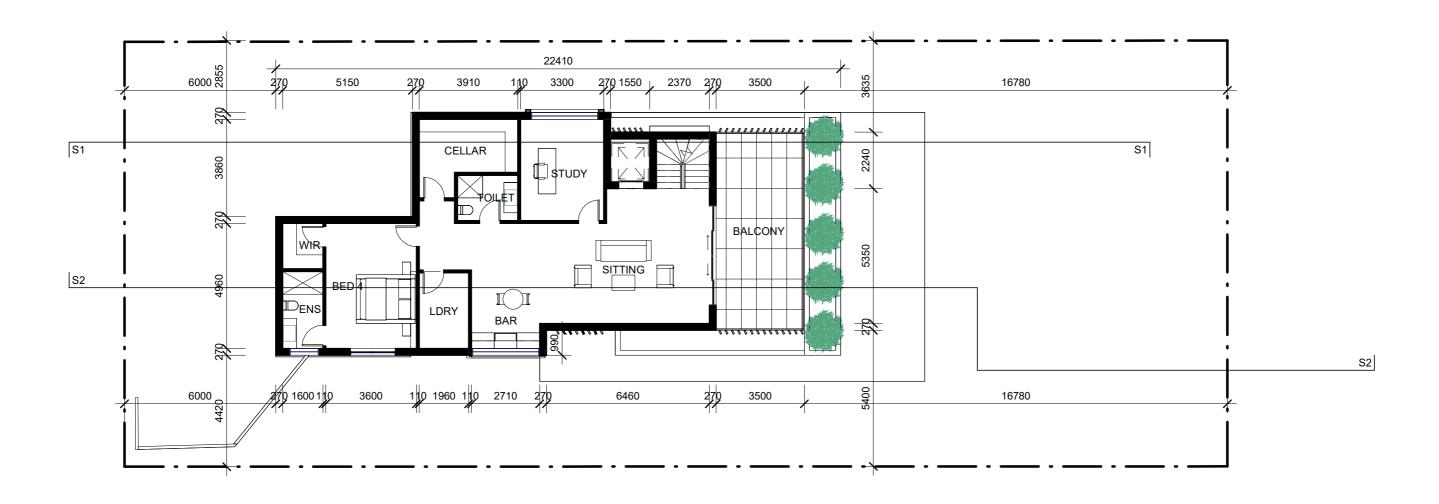

Rev Amendment Project:
PROPOSED SINGLE HOUSE

DA

28 Stuart St, Collaroy NSW 2097



Drawn by: RT
Checked by: MW
Title: FIRST FLOOR PLAN



PROPOSED SINGLE HOUSE 28 Stuart St, Collaroy NSW 2097



Drawn by: RT Checked by: MW Vigor Master Pty Ltd Title: SECOND FLOOR PLAN

Scale @ A1: Job NO.: DA28SS Scale @ A3: 1 : 150 Drawing NO.: A105 Date: 19.02.2024



Project:
PROPOSED SINGLE HOUSE

DA

28 Stuart St, Collaroy NSW 2097



Vigor Master Pty Ltd Checked by: MW

Title: ROOF PLAN

Job NO.: DA28SS Date: 19.02.2024 Scale @ A1: Scale @ A3: 1 : 150 Drawing NO.: A106



200mm

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te Rev Amendment

PROPOSED SINGLE HOUSE

28 Stuart St, Collaroy NSW 2097



Drawn by: RT
Checked by: MW
Title: EAST ELEVATION


Rev	Amendment	PROPOSED SINGLE HOUSE
		DA 28 Stuart St, Collaroy NSW 2097

Date

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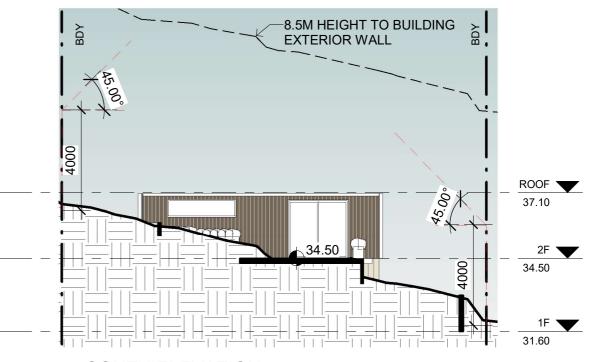


Drawn by: RT
Checked by: MW
Title: WEST ELEVATION



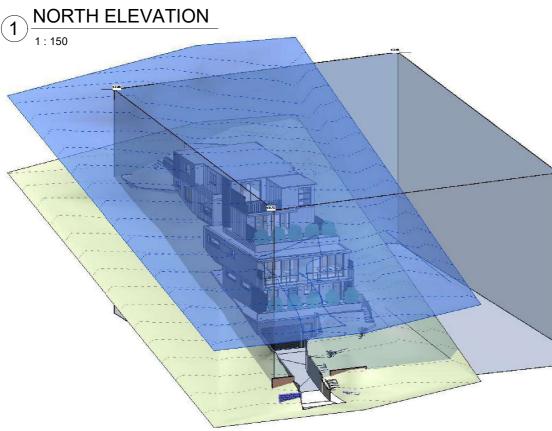

Date Rev Amendment Project:
PROPOSED SINGLE HOUSE
DA
28 Stuart St, Collaroy NSW 2097



2 SOUTH ELEVATION
1:150




3 VIEW FROM STUART STREET





200mm

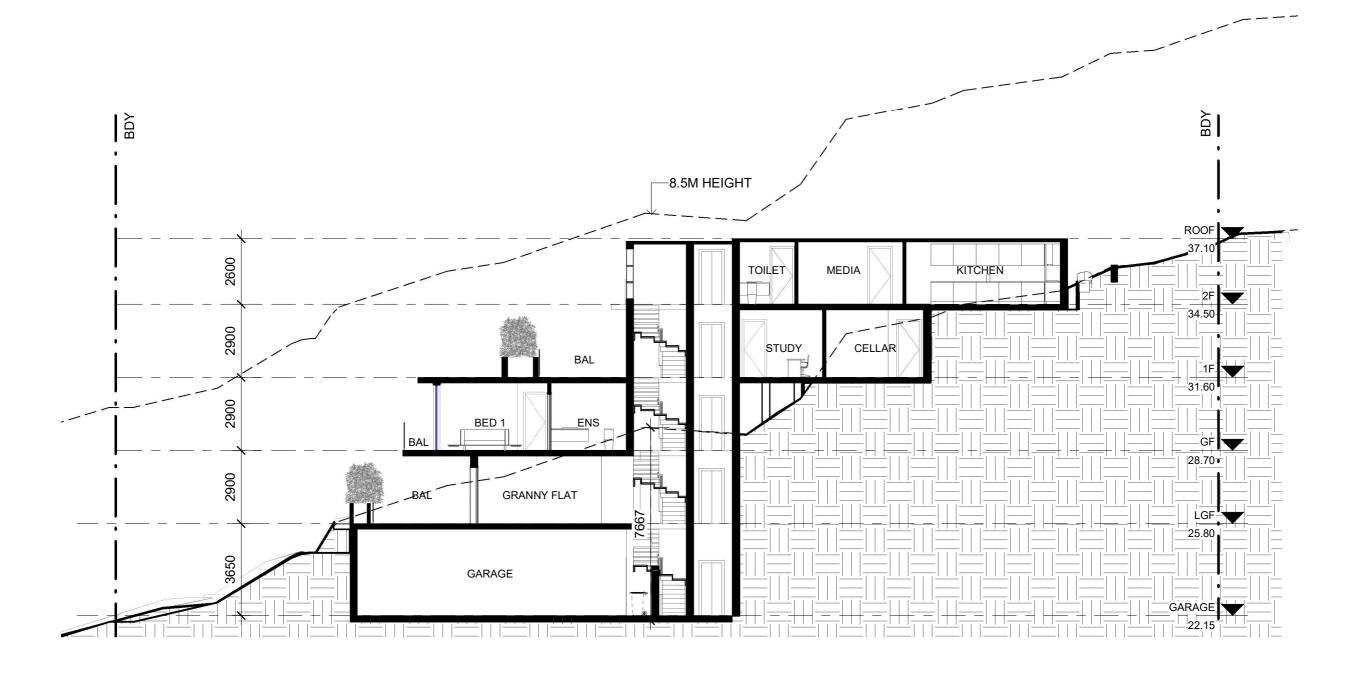

PROPOSED SINGLE HOUSE

28 Stuart St, Collaroy NSW 2097




Drawn by: RT Checked by: MW Vigor Master Pty Ltd Title: SECTION 1

> Job NO.: DA28SS Date: 19.02.2024

Scale @ A1: Scale @ A3: 1 : 150 Drawing NO.: A204

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Rev Amendment Project
PROPOSED SINGLE HOUSE
DA
28 Stuart St, Collaroy NSW 2097

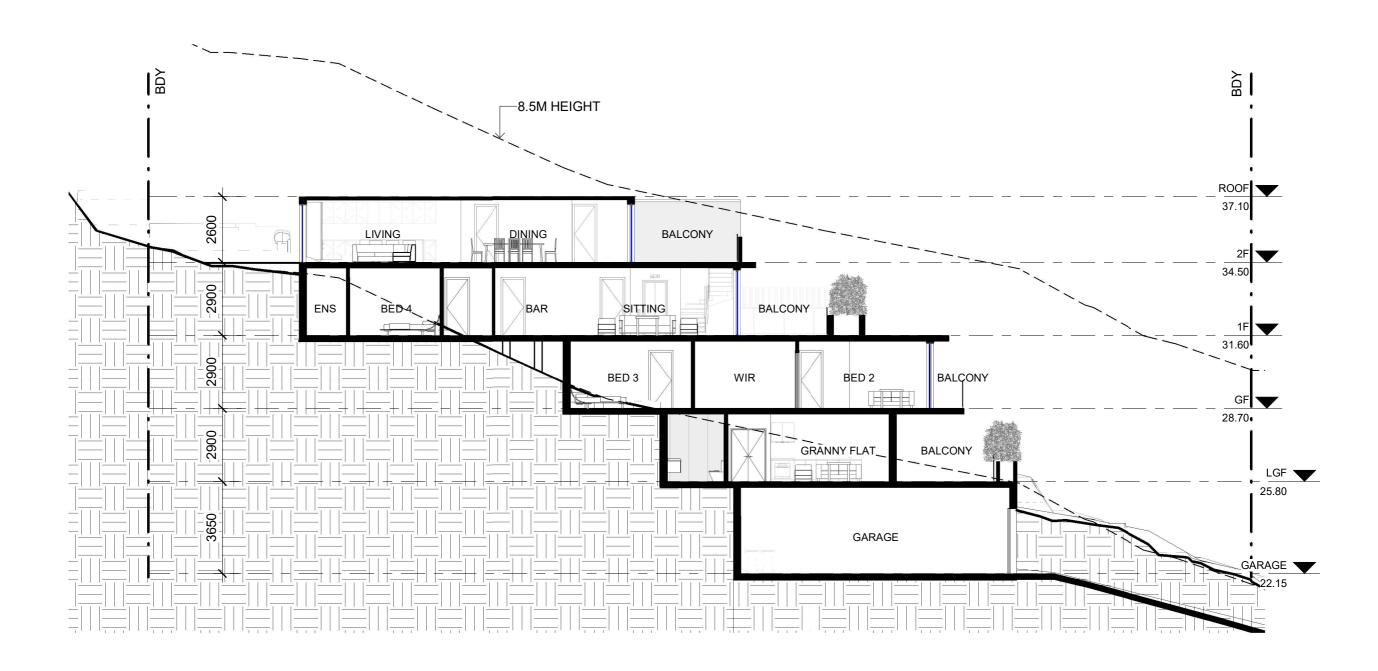

Drawn by: RT

Checked by: MW

Title: SECTION 2

Scale @ A1:

Job NO.: DA28SS
Scale @ A3: 1:150

Date: 19.02.2024
Drawing NO.: A205
Rev:

SCHEDULE OF EXTERNAL FINISHES – PROPOSED NEW DWELLING AT 28 STUART ST COLLAROY

ELEMENT	MATERIAL	SAMPLE	ELEMENT	MATERIAL	SAMPLE
ROOF	COLORBOND - MONUMENT	Monument	RAILING	GLASS BALUSTRADE	
EXTERNAL WALLS	RENDERED BRICKWORK WITH PAINT FINISH PAINT FINISH – P1 – DULUX – <i>GRAND PIANO</i>	Dutux A204 Grand Piano	COLUMNS	DARK WOOD	
EXTERNAL WALLS	RENDERED BRICKWORK WITH PAINT FINISH PAINT FINISH – P2 – DULUX – KADE'S CABIN	Dutux 509A9 Kade's Cabin	FASCIA/GUTTER & DOWNPIPES	COLORBOND -WALLABY	Wallaby

Da

Rev

Amendment

PROPOSED SINGLE HOUSE

DA


28 Stuart St, Collaroy NSW 2097





Drawn by: RT
Checked by: MW
Title: FINISH SCHEDULE

Scale @ A1:

Job NO.: DA28SS Scale @ A3:
Date: 19.02.2024 Drawing NO.: A301

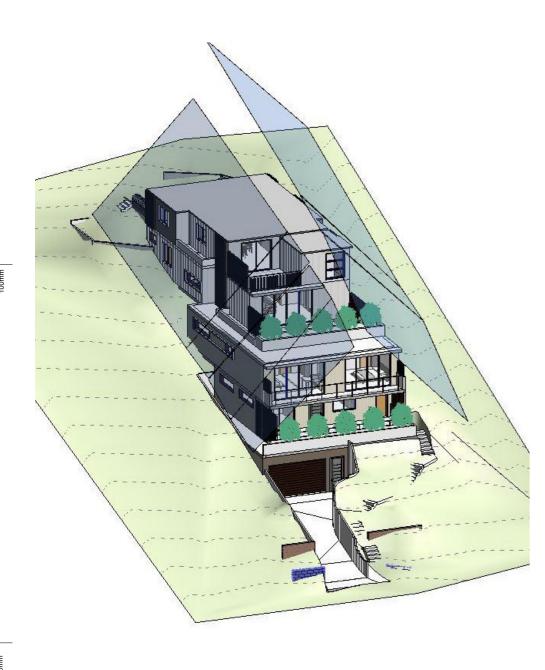

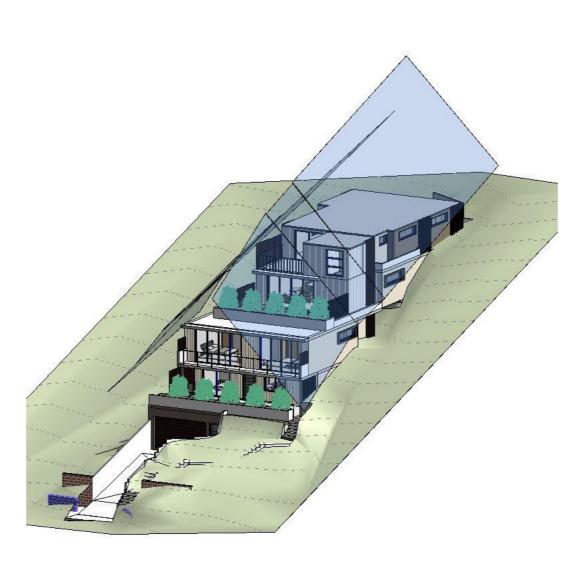

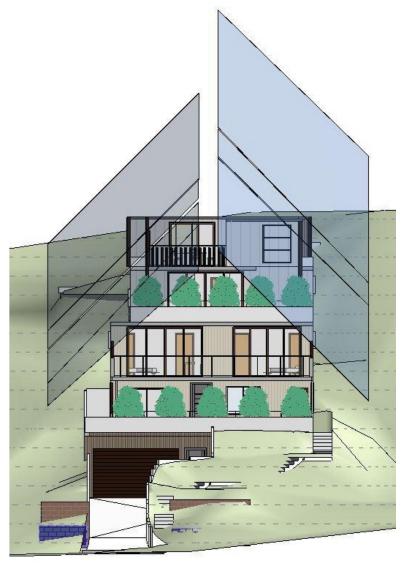

PROPOSED SINGLE HOUSE

28 Stuart St, Collaroy NSW 2097

MASTER

Vigor Master Pty Ltd


Tel. 02 9411 3998 Fax. 02 9413 3983 Email. info@vigormaster.com.au

Drawn by: RT Checked by: MW Title: BUILDING ENVELOPE

Scale @ A1: Scale @ A3: Drawing NO.: A302

Job NO.: DA28SS Date: 19.02.2024


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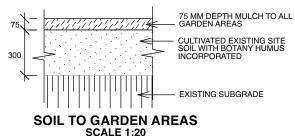


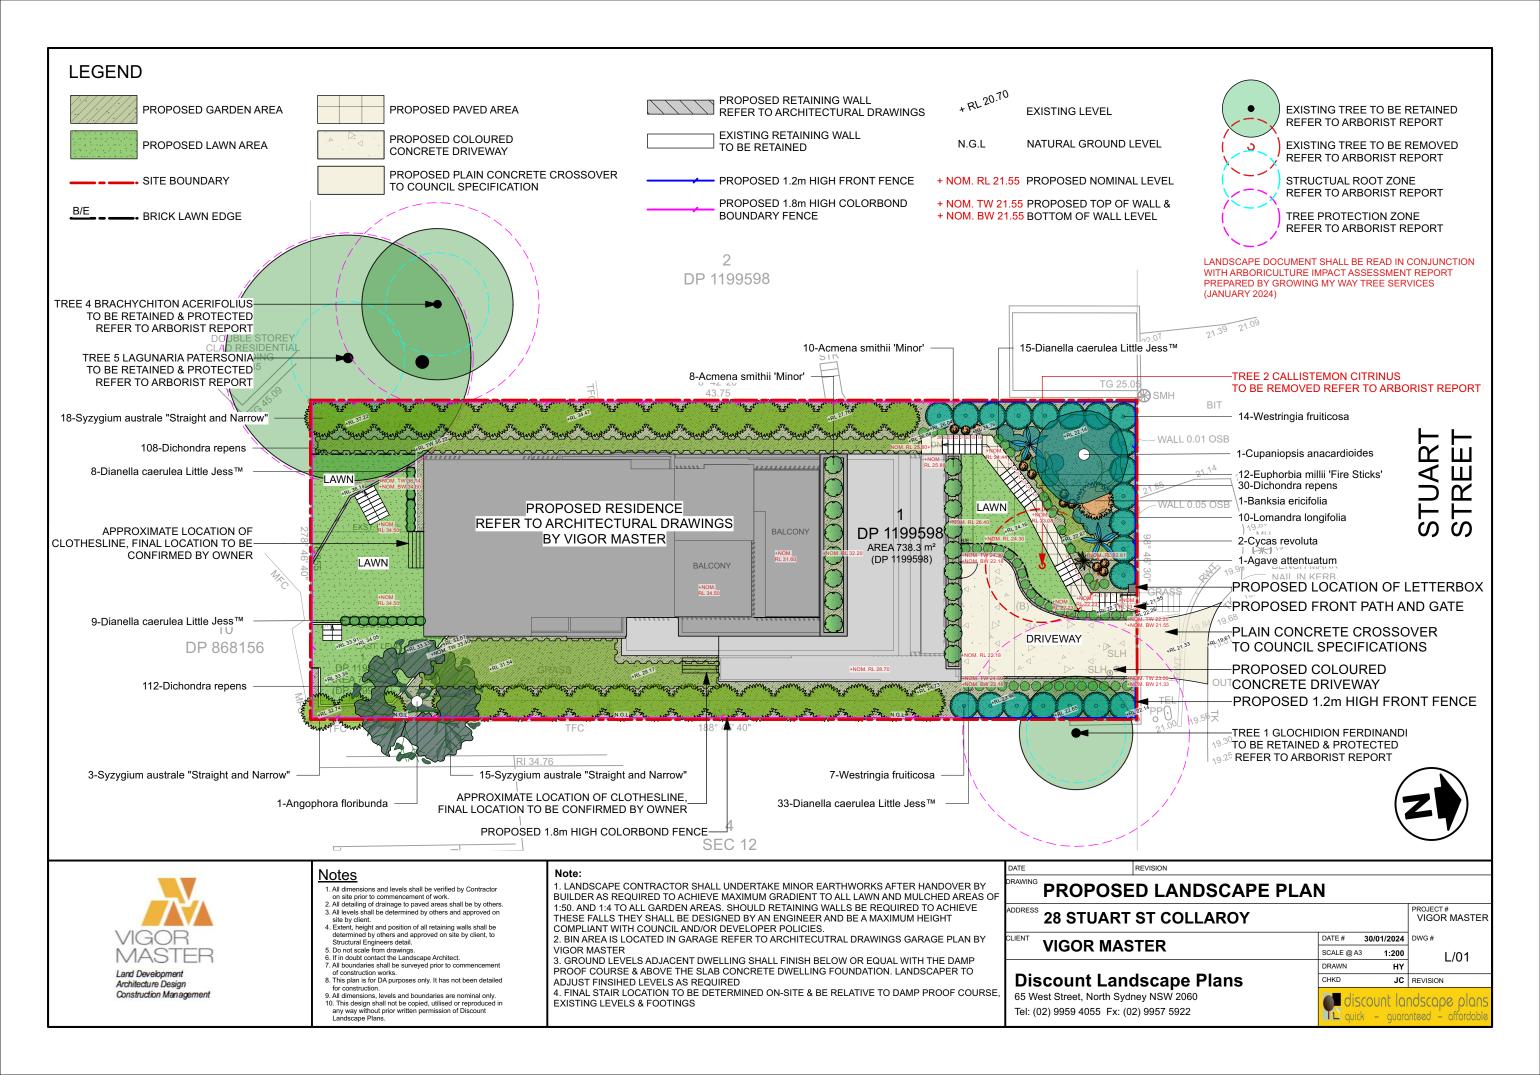
PLANTING SCHEDULE


NOTES: 90% PLANT SPECIES ARE CONSIDERED LOW WATER-USE SPECIES AND ARE AUSTRALIAN NATIVE PLANT SPECIES ENDEMIC TO THE LOCAL NORTHERN BEACHES COUNCIL AREA

Latin Name	Common Name	Quantity	Scheduled Size	Spread	Height
Acmena smithii 'Minor'	Lillypilly	18	200mm	1000	1000
Agave attentuatum	Agave	1	150mm	1000	1000
Angophora floribunda	Rough Barked Apple	1	75lt	7000	15000
Banksia ericifolia	Heath Banksia	1	300mm	2000	3000
Cupaniopsis anacardioides	Tuckeroo	1	25lt	5000	10000
Cycas revoluta	Sago Palm	2	200mm	2000	2000
Dianella caerulea Little Jess™	Mauve Flax Lily	65	tube	500	500
Euphorbia millii 'Fire Sticks'	Euphorbia	12	tube	500	700
Lomandra longifolia	Native Grass	10	tube	900	900
Syzygium australe "Straight and Narrow"	Lillypilly "Straight and Narrow"	36	200mm	2000	3000
Westringia fruiticosa	Coastal Rosemary	21	200mm	1500	1500



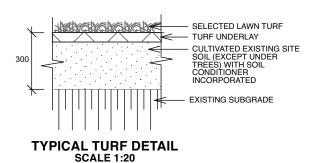

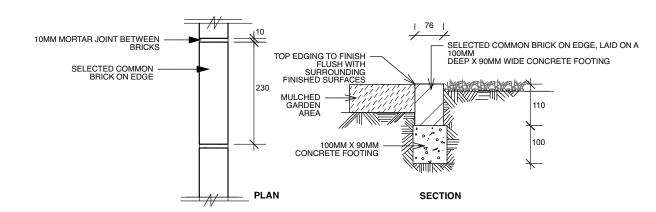

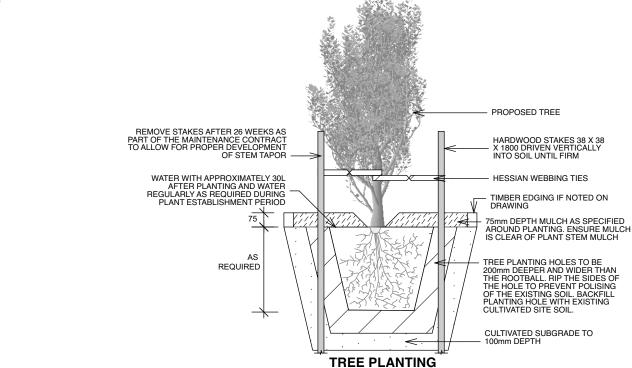

PLANTING DETAIL SCALE 1:20

> **& STAKING DETAIL SCALE 1:20**

REQUIRED




- All dimensions and levels shall be verified by Contractor on site prior to commencement of work.
 All detailing of drainage to paved areas shall be by others.
- 3. All levels shall be determined by others and approved on
- 3. All levels shall be determined by others and approved on site by client.
 4. Extent, height and position of all retaining walls shall be determined by others and approved on site by client, to Structural Engineers detail.
 5. Do not scale from drawings.
 6. If in doubt contact the Landscape Architect.

- 7. All boundaries shall be surveyed prior to commencement of construction works.
- 8. This plan is for DA purposes only. It has not been detailed
- Inis pian is for UA purposes only, it has not been detailed for construction.
 All dimensions, levels and boundaries are nominal only.
 This design shall not be copied, utilised or reproduced in any way without prior written permission of Discount Landscape Plans.

Note:

TYPICAL BRICK EDGE DETAIL

- 1. LANDSCAPE CONTRACTOR SHALL UNDERTAKE MINOR EARTHWORKS AFTER HANDOVER BY BUILDER AS REQUIRED TO ACHIEVE MAXIMUM GRADIENT TO ALL LAWN AND MULCHED AREAS OF 1:50. AND 1:4 TO ALL GARDEN AREAS. SHOULD RETAINING WALLS BE REQUIRED TO ACHIEVE THESE FALLS THEY SHALL BE DESIGNED BY AN ENGINEER AND BE A MAXIMUM HEIGHT COMPLIANT WITH COUNCIL AND/OR DEVELOPER POLICIES
- 2. BIN AREA IS LOCATED IN GARAGE REFER TO ARCHITECUTRAL DRAWINGS GARAGE PLAN BY
- 3. GROUND LEVELS ADJACENT DWELLING SHALL FINISH BELOW OR EQUAL WITH THE DAMP PROOF COURSE & ABOVE THE SLAB CONCRETE DWELLING FOUNDATION. LANDSCAPER TO ADJUST FINSIHED LEVELS AS REQUIRED
- 4. FINAL STAIR LOCATION TO BE DETERMINED ON-SITE & BE RELATIVE TO DAMP PROOF COURSE **EXISTING LEVELS & FOOTINGS**

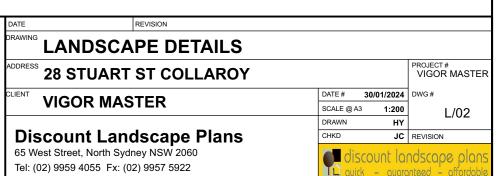

75mm DEPTH MULCH AS SPECIFIED AROUND PLANTING. ENSURE MULCH IS CLEAR OF PLANT STEM

SHRUB PLANTING HOLES TO BE 200mm DEEPER AND WIDER THAN THE ROOTBALL. RIP THE SIDES OF THE HOLE TO PREVENT POLISING OF THE EXISTING SOIL. BACKFILL PLANTING HOLE WITH EXISTING CULTIVATED SITE SOIL. WATER IN AND TAMP TO REMOVE AIR POCKETS.

CULTIVATED SUBGRADE TO 100mm DEPTH

OUTLINE LANDSCAPE SPECIFICATION

Preparation by Builder: Builder shall remove all existing concrete pathways, fences, footings, walls etc. not notated to be retained and complete all necessary excavation work prior to commencement on site by Landscape Contractor (Contractor). Builder shall also install new retaining walls, kerbs, layback kerb, crossover, pathways etc. and make good all existing kerbs, gutters etc. as necessary and to approval of Council. Builder shall ensure that a minimum 450mm of topsoil in garden areas and a minimum 150mm of topsoil in lawn areas exists. Should required depths not exist Builder shall contact Landscape Architect and ask for instructions prior to completion of excavation works.

Excavate as necessary, then fill with approved site topsoil to allow for minimum 500mm soil depth in garden areas and 150mm soil depth in lawn areas and to gain required shapes & levels. Ensure all garden and lawn areas drain satisfactorily. All levels & surface drainage shall be determined by others & approved on site by Head Contractor. Note: Approved imported topsoil mix may be utilised if there is insufficient site topsoil available. State in Tender a m3 rate for additional imported topsoil and the quantities of both site topsoil and imported topsoil allowed for in Tender.

Initial Preparation: Verify all dimensions & levels on site prior to commencement. Do not scale from drawings. Locate all underground services & ensure no damage occurs to them throughout contract. Spray approved weedicide to all proposed lawn & garden areas to manufacturer's directions. Remove existing concrete pathways, footings, walls etc. not notated to be retained & weeds from site. Levels indicated on Plan are nominal only and are derived from Architectural Plans & Drawings by others. Final structural integrity of all items shall be the sole responsibility of Landscape Contractor.

Tree Protection: Trees to be retained shall be protected during site works and construction by the erection of Solid barricades to the specification of Council. Storage of machinery or materials beneath canopy of trees to be retained shall not be permitted. Changes to soil level and cultivation of soil beneath canopy of trees to be retained shall not be permitted unless under direct supervision of Landscape Architect. Existing trees shall be pruned to Landscape Architects onsite instructions. Soil Preparation: Cultivate to depth of 300mm all proposed lawn & garden areas incorporating minimum 100mm depth of organic clay breaker into existing site soil. Do not cultivate beneath existing trees to be retained. In areas where fill is required gain required shapes & levels using a premium grade soil mix. In areas where excavation is required to to allow for installation of 500mm depth of premium grade topsoil mix to garden areas and 300mm depth of premium grade topsoil mix to lawn areas. Undertake all required action to ensure that no rootballs of proposed plants sit in clay wells and that all garden areas and lawn areas drain satisfactorily. Note it is intended that wherever possible existing levels shall not be altered through garden and lawn areas. It is the Contractors responsibility to ensure that the end result of the project is that all lawn and garden areas drain sufficiently (both surface & subsurface), are at required finished levels and have sufficient soil depths to enable lawn and plants to thrive and grow. Should alternative works to those specified be required to achieve the above result, Contractor shall inform Builder at time of Tender and request instructions.

Lawn Edging and Stepping Stones: (i) 125 x 25mm approved tanalith impregnated pine edging shall be installed, to lines as indicated on plan and staked with approved stakes at maximum 1500mm centres at ends and changes of direction; stakes shall be nailed to edging with approved galvanised steel nails. Top of edging shall finish flush with surrounding surfaces. Top of stakes shall finish 25mm below top of edging. (ii) Contractor shall install approved bricks on edge on a minimum 100mm deep x 90mm wide concrete footing with brick tor set in, to lines nominated on plan as brick edging. Bricks shall be laid with a nominal 10mm wide approved coloured mortar joint. Bricks needing to be cut shall be done so with clean sharp cuts. Top of edging shall finish flush with surrounding finished surfaces. Approved sandstone stepping stones shall be positioned as indicated on plan on a 25mm river sand bed. Approved sandstone stepping stones shall be positioned as indicated on plan on a 25mm river sand bed.

Retaining Walls: Positions, detail and heights of retaining walls shall be by others.

Planting: Purchase plants from an approved nursery. Plants to be healthy & true to type & species. Set out plants to positions indicated on plan. Following approval, plant holes shall be dug approximately twice width and to 100mm deeper than plant rootballs that they are to receive. Base and sides of hole shall be further loosened. Fertiliser, followed by 100mm depth of topsoil mix shall then be placed into base of hole and lightly consolidated. Base of hole shall then be watered. Remove plant container and install plant into hole. Rootball shall be backfilled with surrounding topsoil and topsoil firmed into place. An approved shallow dish shall be formed to contain water around base of stem. Base of stem of plant shall finish flush with finished soil level. Once installed plant shall be thoroughly watered and maintained for the duration of the Contract.

Staking: All trees shall be staked using 2 x 38mm x 2000mm long hardwood stakes per plant and with hessian webbing ties installed to Landscape Architect's on site instructions.

Mulching: Install 75mm depth of 25mm diameter hardwood mulch to all garden areas, coving mulch down around all plant stems & to finish flush with adjacent surfaces.

Turfing: Prepare for, level & lay cultivated Palmetto Buffulo turves to all areas nominated on plan as being lawn. Roll, water, fertilise, mow & maintain lawns as necessary until completion of maintenance period. At same time make good all existing lawn areas using same lawn type. Lawns in shade shall be over sown with an approved seed mix. Allow to retrim and returf councils nature strip as required.

Fencing: Retain all existing fences unless advised otherwise by builder. Install timber paling fences to heights indicated on Plan.

Paving: Areas to be paved shall be excavated or filled to allow for installation of bedding materials. Levels and falls shall be as per Plan. Surface drainage on paving shall be towards grated drains with all drains connected to stormwater system and installed by Builder. Irrigation: Contractor shall supply and install an approved fully automatic, vandal resistant, computerised irrigation system to all garden and lawn areas, excluding council nature strip. Entire system shall be to approval of Water Board and shall utilise

pop-up sprinklers and electronic controllers. Contractor shall be responsible to ensure that system is able to satisfactorily operate on available water pressure. Power supply for use by irrigation system shall be provided to an approved location near southwest corner of residence by others and shall consist of an approved weatherproof G.P.O. The irrigation system controller shall be housed in an approved waterproof cabinet mounted to external wall of residence.

Clotheslines: Contractor shall allow for all necessary labour and materials and shall install clotheslines to positions as indicated on plan to manufacturer's instructions to approval of Landscape Architect. Clothesline type shall be equal to 'Hills

Completion: Prior to practical completion remove from site all unwanted debris occurring from work. Satisfy Council that all landscaping work has been undertaken in strict accordance with Councils landscape codes & guidelines. Maintenance Period: A twelve month maintenance period shall be undertaken by owner or owners representative as set out herein. Owner shall have care and maintenance of all work specified under this Contract and shall rectify any defective work for a period of 52 weeks following Practical Completion of Landscape Works. This period shall be herein known as the Maintenance Period. Work shall also include for the care and maintenance of all existing vegetation to be retained and proposed vegetation. Site shall be attended at least weekly and as otherwise required. The following works shall be undertaken during the Maintenance Period.

(a) Recurrent works Undertake recurrent works throughout the Maintenance Period. These works shall include but are not limited to watering, weeding, fertilising, pest and disease control, returfing, staking and tying, replanting, cultivation, pruning, aerating, renovating, top dressing and the like.

(b) Watering Regularly water all plants and lawn areas to maintain optimal growing conditions. Contractor shall adjust the water quantity utilised with regard to climatic conditions prevalent at the time.

- (c) Replacements Immediately replace plants which die or fail to thrive (at discretion of Landscape Architect) with plants of same species or variety and of same size and quality unless otherwise specified. Plant replacement shall be at Contractors expense, unless replacement is required due to vandalism or theft, which shall be determined by Landscape Architect. Required replacement of plants due to vandalism or theft shall be undertaken by Contractor and shall be paid for by Client at an
- (d) Mulched surfaces Maintain mulched surfaces in clean, tidy, weed-free condition and shall reinstate mulch as necessary to maintain specified depths.
- (e) Stakes & ties Adjust and/or replace stakes and ties as required. Remove stakes and ties at end of Maintenance Period if directed by Landscape Architect.
- (f) Lawn areas Lawn areas shall be mown at regular intervals to ensure non heading of lawn with a fine-cutting mulching mower and clippings left on lawn to mulch and self-fertilise lawn areas. Primary cut after laying of lawn by others shall be determined on site taking into consideration season, watering and growth rate of lawn. Following the primary cut all lawns shall be regularly mown as required to ensure a healthy lawn and a neat appearance. Care shall always be taken to ensure that no clippings are left on surrounding roads or garden areas after mowing. Replace lawn areas that fail to thrive at discretion of Landscape Architect. All new and made good lawn areas shall be barricaded off from pedestrian traffic by use of star pickets and brightly coloured plastic safety mesh until establishment of lawn. Barricades shall be removed upon establishment of lawn area.
- (g) Weeding Remove by hand, or by carefully supervised use of weedicide, any weed growth that may occur throughout Maintenance Period. This work shall be executed at weekly intervals so that all lawn and garden areas may be observed in a weed-free condition.
- (h) Pruning Prune new and existing plants (excluding existing trees) as necessary to maintain dense foliage conditions. Any rogue branches, or branches overhanging or obstructing pathways, roads, doorways, etc., shall be removed by approved horticultural methods.
- (i) Spraying Spraying for insect, fungal and disease attack shall be undertaken as required and in accordance with spray manufacturers recommendations at intervals taking into account the season of year during which landscape works are to be implemented.
- (j) Tree Care Should any existing trees be damaged during construction works immediately engage an experienced arboriculturist and then undertake any rectification work recommended by arboriculturist.



<u>Notes</u>

- 1. All dimensions and levels shall be verified by Contractor
- on site prior to commencement of work.


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 5. Do not scale from drawings.
 6. If in doubt contact the Landscape Architect.

- 7. All boundaries shall be surveyed prior to commencement
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Note:

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- COMPLIANT WITH COUNCIL AND/OR DEVELOPER POLICIES 2. BIN AREA IS LOCATED IN GARAGE REFER TO ARCHITECUTRAL DRAWINGS GARAGE PLAN BY
- 3. GROUND LEVELS ADJACENT DWELLING SHALL FINISH BELOW OR EQUAL WITH THE DAMP PROOF COURSE & ABOVE THE SLAB CONCRETE DWELLING FOUNDATION. LANDSCAPER TO ADJUST FINSIHED LEVELS AS REQUIRED
- 4. FINAL STAIR LOCATION TO BE DETERMINED ON-SITE & BE RELATIVE TO DAMP PROOF COURSE, EXISTING LEVELS & FOOTINGS

	,		
DATE	REVISION		
DRAWING LANI	OSCAPE SPECIFICA	TION	
ADDRESS 28 ST	UART ST COLLAROY	F	PROJECT# VIGOR MASTER
CLIENT VICO	DMACTED	DATE# 30/01/2024	OWG#
l Algoi	R MASTER	SCALE @ A3 1:200	L/03
		DRAWN HY	2/00
Discoun	t Landscape Plans	CHKD JC F	REVISION
65 West Street, North Sydney NSW 2060			dscape plans teed - affordable

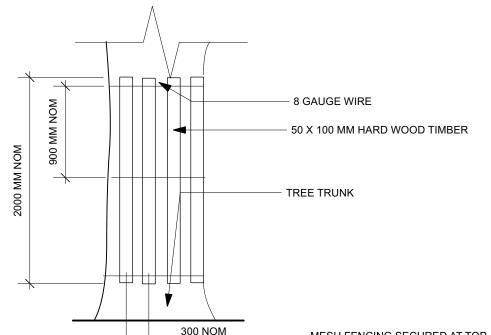

TREE MANAGEMENT ACTION

Builder shall protect trees to be retained by the following methods prior to commencement of other work on site.

The tree protection shall be maintained intact until the completion of all work on site and then removed.


Storage or disposal of materials beneath canopy of trees to be retained and protected shall not be permitted.

Changes to soil level and cultivation of soil beneath canopy of trees to be retained shall not be permitted unless under direct supervision of Consulting Arborist.

Any excavation work required beneath canopy of tree to be retained shall be undertaken by hand under direct supervision of Arborist. Roots in excess of 50mm diameter shall not be cut. All damage to tree roots shall be treated by arborist at time of immediately.

METHOD ONE

Two metre lengths of 50 x 100mm hardwood timbers shall be installed around trunks of trees to be retained at 300mm centres and secured in position by 8 gauge wires at 900mm spacings.

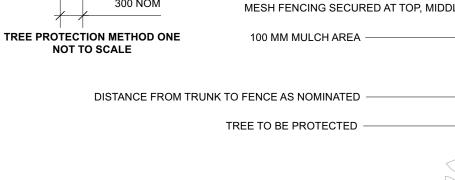

TREE MANAGEMENT ACTION

Builder shall protect trees to be retained by the following methods prior to commencement of other work on site.

The tree protection shall be maintained intact until the completion of all work on site and then removed.


Storage or disposal of materials beneath canopy of trees to be retained and protected shall not be permitted.


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Any excavation work required beneath canopy of tree to be retained shall be undertaken by hand under direct supervision of Arborist. Roots in excess of 50mm diameter shall not be cut. All damage to tree roots shall be treated by arborist at time of immediately.

METHOD TWO

A protective fence shall be installed at a maximum workable distance away from trunk of tree (or distances as nominated on plan). Fence shall comprise of 1800mm high star pickets installed at 1000mm centres with an approved mesh (chain mesh, roadside barrier webbing or similar) secured to pickets by 8 gauge wire top, middle and bottom to form a protective fence totally surrounding tree. Area within protective fence shall be mulched to a depth using native woodchip mulch to a depth of 100mm.



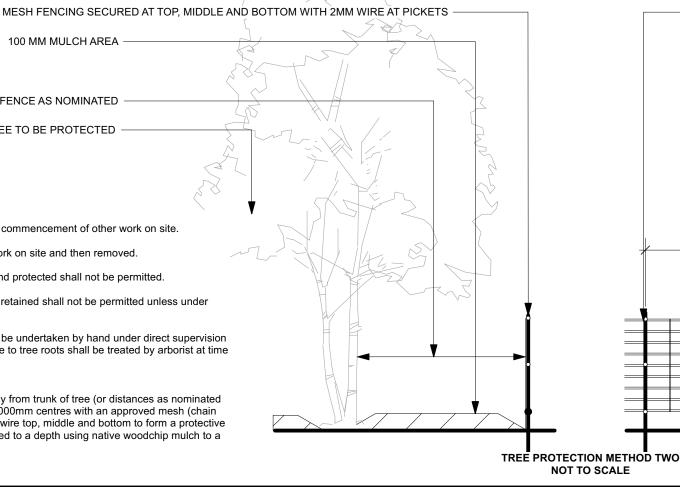

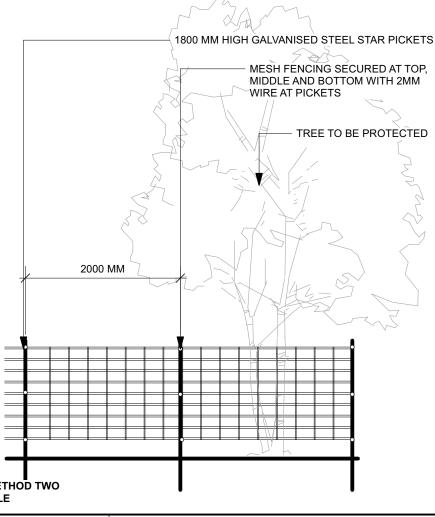

- All dimensions and levels shall be verified by Contractor on site prior to commencement of work.
 All detailing of drainage to paved areas shall be by others.
- 3. All levels shall be determined by others and approved on
- 3. All levels shall be determined by others and approved on site by client.
 4. Extent, height and position of all retaining walls shall be determined by others and approved on site by client, to Structural Engineers detail.
 5. Do not scale from drawings.
 6. If in doubt contact the Landscape Architect.
- 7. All boundaries shall be surveyed prior to commencement
- 8. This plan is for DA purposes only. It has not been detailed
- 8. In its pian is for DA purposes only, it has not been detailed for construction.

 9. All dimensions, levels and boundaries are nominal only.

 10. This design shall not be copied, utilised or reproduced in any way without prior written permission of Discount Landscape Plans.

Note:

- 1. LANDSCAPE CONTRACTOR SHALL UNDERTAKE MINOR EARTHWORKS AFTER HANDOVER BY BUILDER AS REQUIRED TO ACHIEVE MAXIMUM GRADIENT TO ALL LAWN AND MULCHED AREAS OF 1:50. AND 1:4 TO ALL GARDEN AREAS. SHOULD RETAINING WALLS BE REQUIRED TO ACHIEVE THESE FALLS THEY SHALL BE DESIGNED BY AN ENGINEER AND BE A MAXIMUM HEIGHT COMPLIANT WITH COUNCIL AND/OR DEVELOPER POLICIES
- 2. BIN AREA IS LOCATED IN GARAGE REFER TO ARCHITECUTRAL DRAWINGS GARAGE PLAN BY
- 3. GROUND LEVELS ADJACENT DWELLING SHALL FINISH BELOW OR EQUAL WITH THE DAMP PROOF COURSE & ABOVE THE SLAB CONCRETE DWELLING FOUNDATION. LANDSCAPER TO ADJUST FINSIHED LEVELS AS REQUIRED
- 4. FINAL STAIR LOCATION TO BE DETERMINED ON-SITE & BE RELATIVE TO DAMP PROOF COURSE **EXISTING LEVELS & FOOTINGS**

DATE	REVISION			
DRAWING TRE	E PROTECTION DET	ΓAILS		
ADDRESS 28 ST	TUART ST COLLAROY			PROJECT# VIGOR MASTER
CLIENT VICO	R MASTER	DATE # 30	/01/2024	DWG#
VIGO	RIVIASIER	SCALE @ A3	1:200	L/04
		DRAWN	HY	L/04
Discoun	it Landscape Plans	CHKD	JC	REVISION
65 West Street,	North Sydney NSW 2060 1055 Fx: (02) 9957 5922			ndscape plans

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