# 8 GROSVENOR PLACE BROOKVALE

### DRAWING REGISTER

Dwg No.	Drawing Title	Scale		
General				
L-DA-00	Cover Page & Drawing Schedule	N/A	A1	
L-DA-01	Landscape Schedules & Notes	N/A	A1	
L-DA-02	Landscape Diagrams	1:200	A1	
Plans				
L-DA-03	Keyplan	1:100	A1	
L-DA-04	Tree Removal Plan	1:100	A1	
L-DA-05	Front Entrance Landscape Plan	1:50	A1	
L-DA-06	Interior Garden Landscape Plan	1:50	A1	
Sections				
L-DA-07	Landscape Sections	1:100	A1	
Palettes				
L-DA-08	Planting Palette	N/A	A1	

## SITE




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# LANDSCAPE DOCUMENTATION

DEVELOPMENT APPLICATION

	By	IMPORTANT NOTES: Do not scale from drawings	CLIENT		CHECKED	DWG. TITLE	
2/21	BH	All discrepancies to be brought to the attention of the Project Landscape Architect Larger scale drawings and written dimensions take preference. All dimensions in mm unless otherwise stated. All tree dimensions and RLs in metres.	Swell Trading Pty Ltd		СВ	Cover Page & Drawing Schedule	
		Use figured dimensions only. Verify all dimensions on site before the commencement of any works. Contractors shall locate and protect all services prior to construction. All work shall be carried out in accordance with ASA, BCA and Local Government Regulations. Structural Details shall be subject to Engineer's Specifications. Drainage & Water Feature Details shall be subject to Hydraulic Engineer's Specifications.	ARCHITECT Chenchow Little Architects		DRAWN BHC	PROJECT	
		All work shall be carried out in a professional manner by Qualified Tradesman according to Landscape Drawings and Engineer's Specifications. No responsibility will be taken by <i>360 Degrees Landscape Architects Pty Ltd</i> for any variations in design, construction method, materials specifications and specifications without permission from the Project Engineer or Landscape Architect. This Drawing is copyright to <i>360 Degrees Landscape Architects Pty Ltd</i> .		SIZE A1	STAGE DA	8 Grosvenor Place, Brookvale	



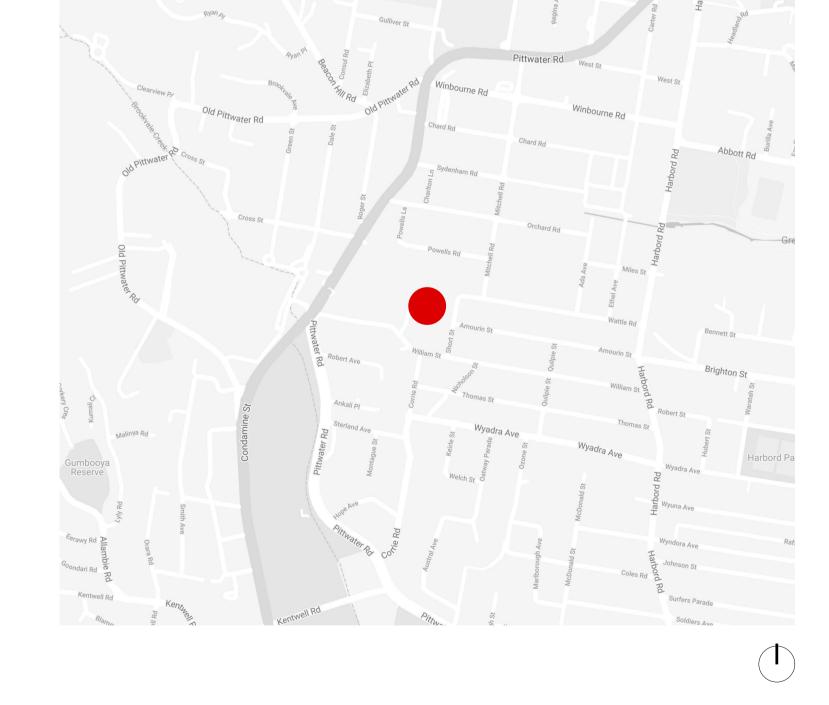

## LOCATION PLAN

### GENERAL NOTES

\* FOR DEVELOPMENT APPLICATION ONLY

\* All tree dimensions and RLs in metres. All other dimensions in mm unless stated otherwise.

\* Do not scale from drawings. Use figured dimensions only. Larger scale drawings and written dimensions take preference.

\* All work shall be carried out in accordance with current versions of Australian Standards, BCA and Local Government Regulations.

\* Structural Details are indicative only and are subject to Structural Engineer's Details and Specifications.

\* Drainage details are subject to Hydraulic / Civil Engineer's Detail and Specification.

\* Subbase details including compaction are to Civil and Structural Engineer's Specification.

\* Lighting Plans are subject to detailed design by a qualified Lighting Consultant or Electrical Contractor.

\* Water Feature Details are indicative only and are subject to detailed design by a specialist Water Feature designer.

\* Service location on plans are indicative only. 360 Degrees Landscape Architects Pty Ltd accepts no responsibility for the accuracy of service locations shown or for services not shown. It is the responsibility of the contractor to determine service locations prior to the commencement of work, including contacting *Dial Before You Dig* and performing on site service locations. Locate and protect all services on site and in adjacent public domain. Any damages to services and associated damages remains the responsibility of the contractor and shall be rectified at no cost to the client or any other party.

\*All adjoining property elements including but not limited to buildings, walls, trees and paving to be protected. Damaged elements remain the responsibility of the contractor and shall be rectified at no cost to the client or any other party.

\* No responsibility will be taken by 360 Degrees Landscape Architects Pty Ltd for any variations in design, construction method, materials specified and general specifications without permission from the Project Landscape Architect.

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### IRRIGATION NOTES

\* Irrigation by specialist D&C Irrigation Consultant in accordance with the Performance Specification in the Landscape Technical Specification. Refer to Irrigation Consultant documentation for details and requirements of landscape irrigation system.

\* Irrigation is to comply with Council Conditions of Consent and Water Authorities.

\* All turf and garden beds within the site boundary are to be irrigated unless stated otherwise.

\* Irrigation must be spaced at min. 200 centres and adjusted according to plant setout to provide adequate irrigation to all plants.

\* Drip irrigation is to be fully concealed by 75mm minimum of mulch.

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### Bota Tree Cyatl Mela Trista

# Shru

Care Bank Dian Isole Loma Poa s

# Lilie

Ligula Neon Philo

# Epip

Beau Hibb Hoya Platy Thun Viola

### PLANT SCHEDULE

tanical Name	Common Name	Size	Quantity	Mature Height	Native
ees					
athea cooperi	Australian Tree Fern	VAR	8	5m - 8m	Ν
laleuca linariifolia	Snow-in-summer	100L	2	8m - 10m	Ν
staniopsis laurina 'Luscious'	Water Gum	100L	5	7m - 12m	Ν
rubs & Grasses					
rex appressa	Tall Sedge	150mm	110	0.95m	Ν
nksia robur	Swamp Banksia	300mm	7	2m	Ν
nella caerulea 'Little Jess'	Little Jess Dianella	150mm	100	0.3m - 0.4m	Ν
lepis nodosa	Knobby Club-rush	150mm	200	0.90m	Ν
mandra hystrix	Creek Mat-Rush	150mm	255	0.95m	Ν
a sieberiana	Blue Tussock Grass	150mm	120	1m	Ν
es					
ularia tussilaginea	Leopard Plant	200mm	35	0.65m - 0.75m	-
omarica gracilis	Walking Iris	200mm	55	0.5m - 0.6m	-
ilodendron xanadu	Xanadu	200mm	13	0.70m - 0.80m	-
iphytic, Groundcovers & Climbo	ers				
aumontia grandiflora	Beaumontia	200mm	5	-	-
bertia scandens	Climbing Guinea Flower	200mm	5	-	Ν
ya australis	Waxvine	200mm	7	-	Ν
tycerium superbum	Staghorn Fern	200mm	8	-	Ν
unbergia grandiflora	Blue Thunbergia	200mm	5	-	-
la hederaceae	Native Violet	200mm	90	0.20m	Ν

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/21	BH	All discrepancies to be brought to the attention of the Project Landscape Architect Larger scale drawings and written dimensions take preference. All dimensions in mm unless otherwise stated. All tree dimensions and RLs in metres.	Swell Trading Pty Ltd		СВ	Landscape Schedules
		Use figured dimensions only. Verify all dimensions on sibe before the commencement of any works. Contractors shall locate and protect all services prior to construction. All work shall be carted out in accordance with ASA, BCA and Local Government Regulations. Structural Details shall be subject to Engineer's Specifications. Drainage & Water Feature Details shall be subject to Hydraulic Engineer's Specifications.		ARCHITECT DRAWN Chenchow Little Architects BHC		
		All work shall be carried out in a professional manner by Qualified Tradesman according to Landscape Drawings and Engineer's Specifications. No responsibility will be taken by 360 Degrees Landscape Architects Py Ltd for any variations in design, construction method, materials specified, and general specifications without permission from the Project Engineer or Landscape Architect. This Drawing is copyright to 360 Degrees Landscape Architects Pty Ltd.	scale N/A	size A1	STAGE DA	8 Grosvenor Place, B

es & Notes





### LANDSCAPE STATEMENT & DIAGRAMS

The proposed DA Landscape Drawings for 8 GROSVENOR PLACE, BROOKVALE have been designed and set out in accordance with;

- The Client's Brief
- The NORTHERN BEACHES COUNCIL DCP Documents
- The WARRINGAH LEP2011
- The TREEiQ Preliminary Arboricultural Report (Revision B 6/6/2021)
- The Stormwater Management Plan by Taylor Consulting (29/10/21)
- Architectural plans by CHENCHOW LITTLE ARCHITECTS


Located on former marshlands and market gardens the overall landscape approach reflects the management and expression of the site's former water history and is composed of;

- A front detention-basin garden. This garden softens the overall visual amenity of the proposed new warehouse development whilst contributing to the overall aesthetic appeal of Grosvenor Place. The garden also reintroduces a small portion of native habitat and will contribute to an improvement of broader catchment water quality. The garden will also contribute to a cooling effect of surrounding areas in summer.

- An interior water garden


- An interior rooftop garden

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SOFTSCAPE DIAGRAM

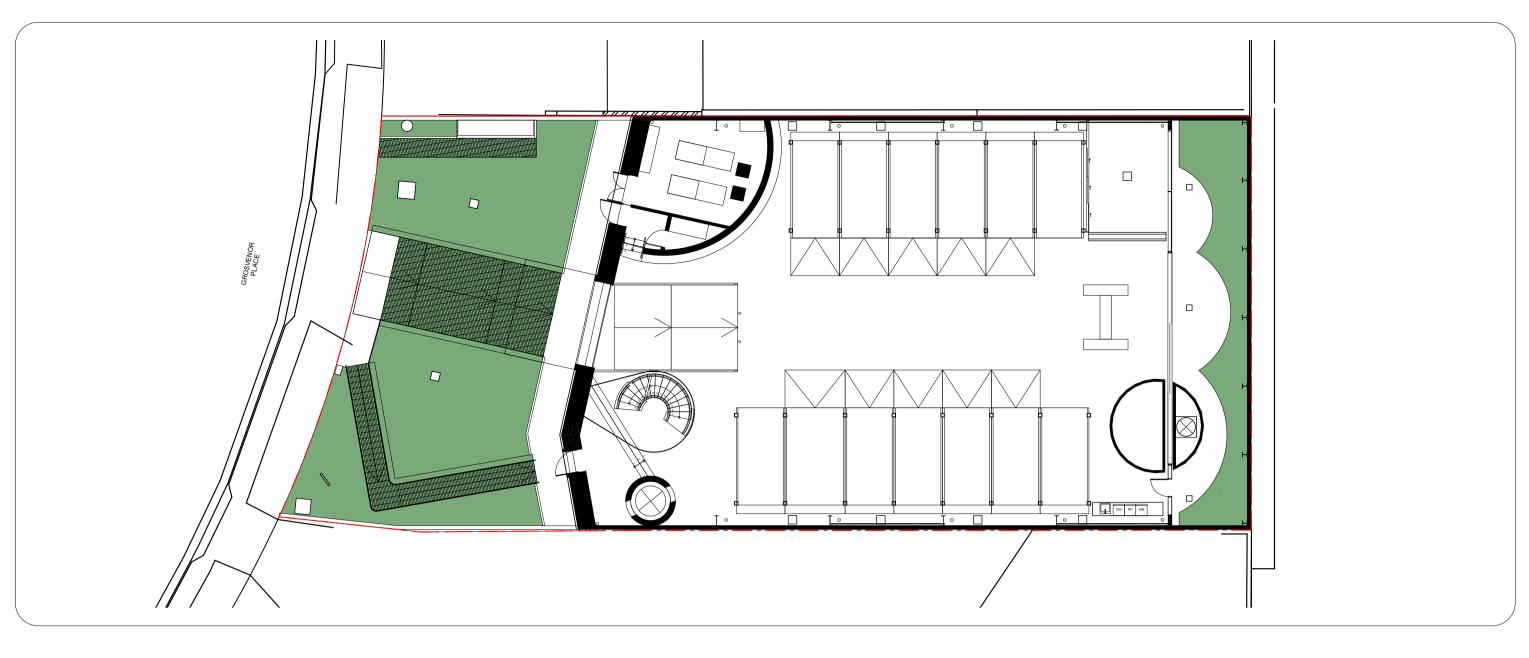




DEEP SOIL DIAGRAM

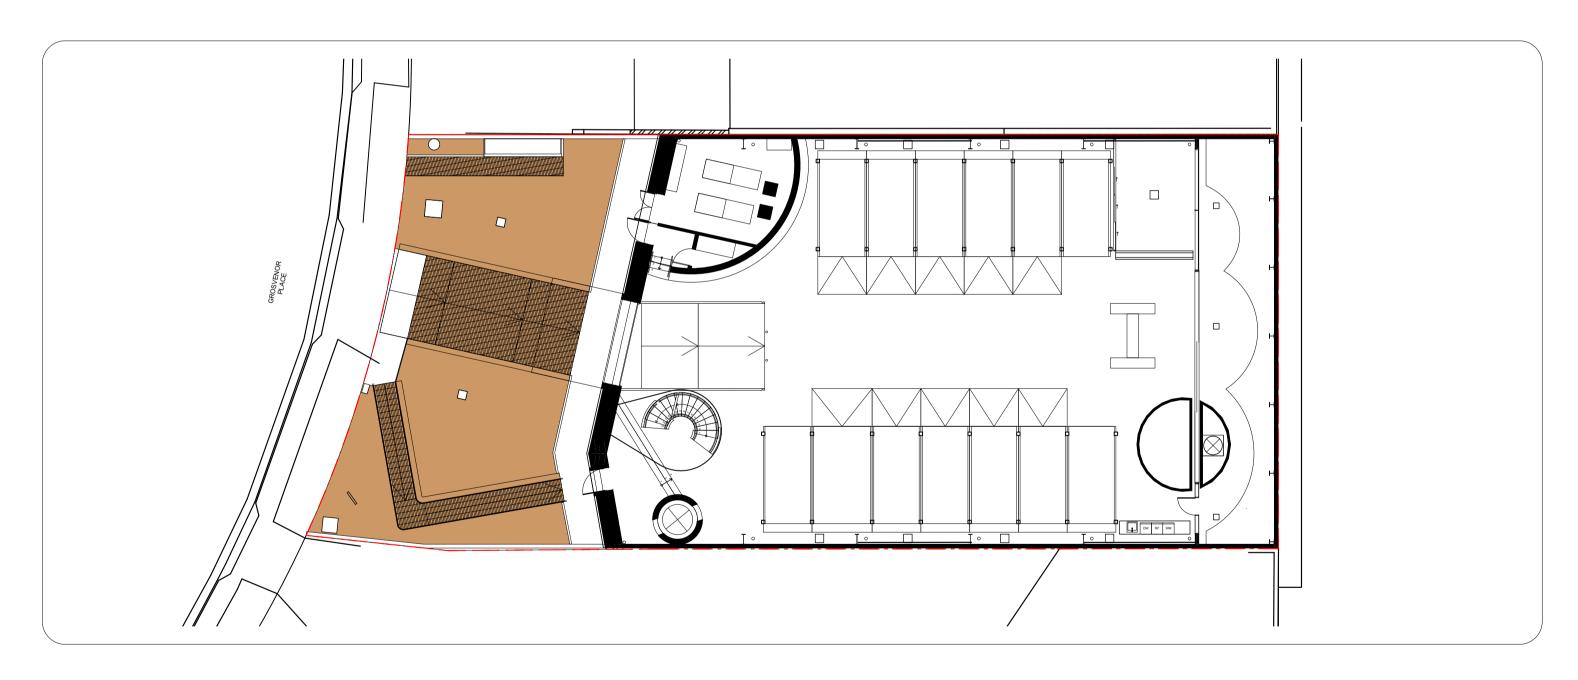

ught to the attention of the Project Landscape Architect written dimensions take preference. All dimensions in mm unless otherwise stated.	g Pty Ltd	CHECKED CB	DWG. TITLE Landscape Diagrams
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t in a professional manner by Qualified Tradesman according to Landscape Drawings and en by 360 Degrees Landscape Architects Pty Ltd for any variations in design, construction i, and general specifications without permission from the Project Engineer or Landscape 1:200	size A1	STAGE DA	8 Grosvenor Place, Br
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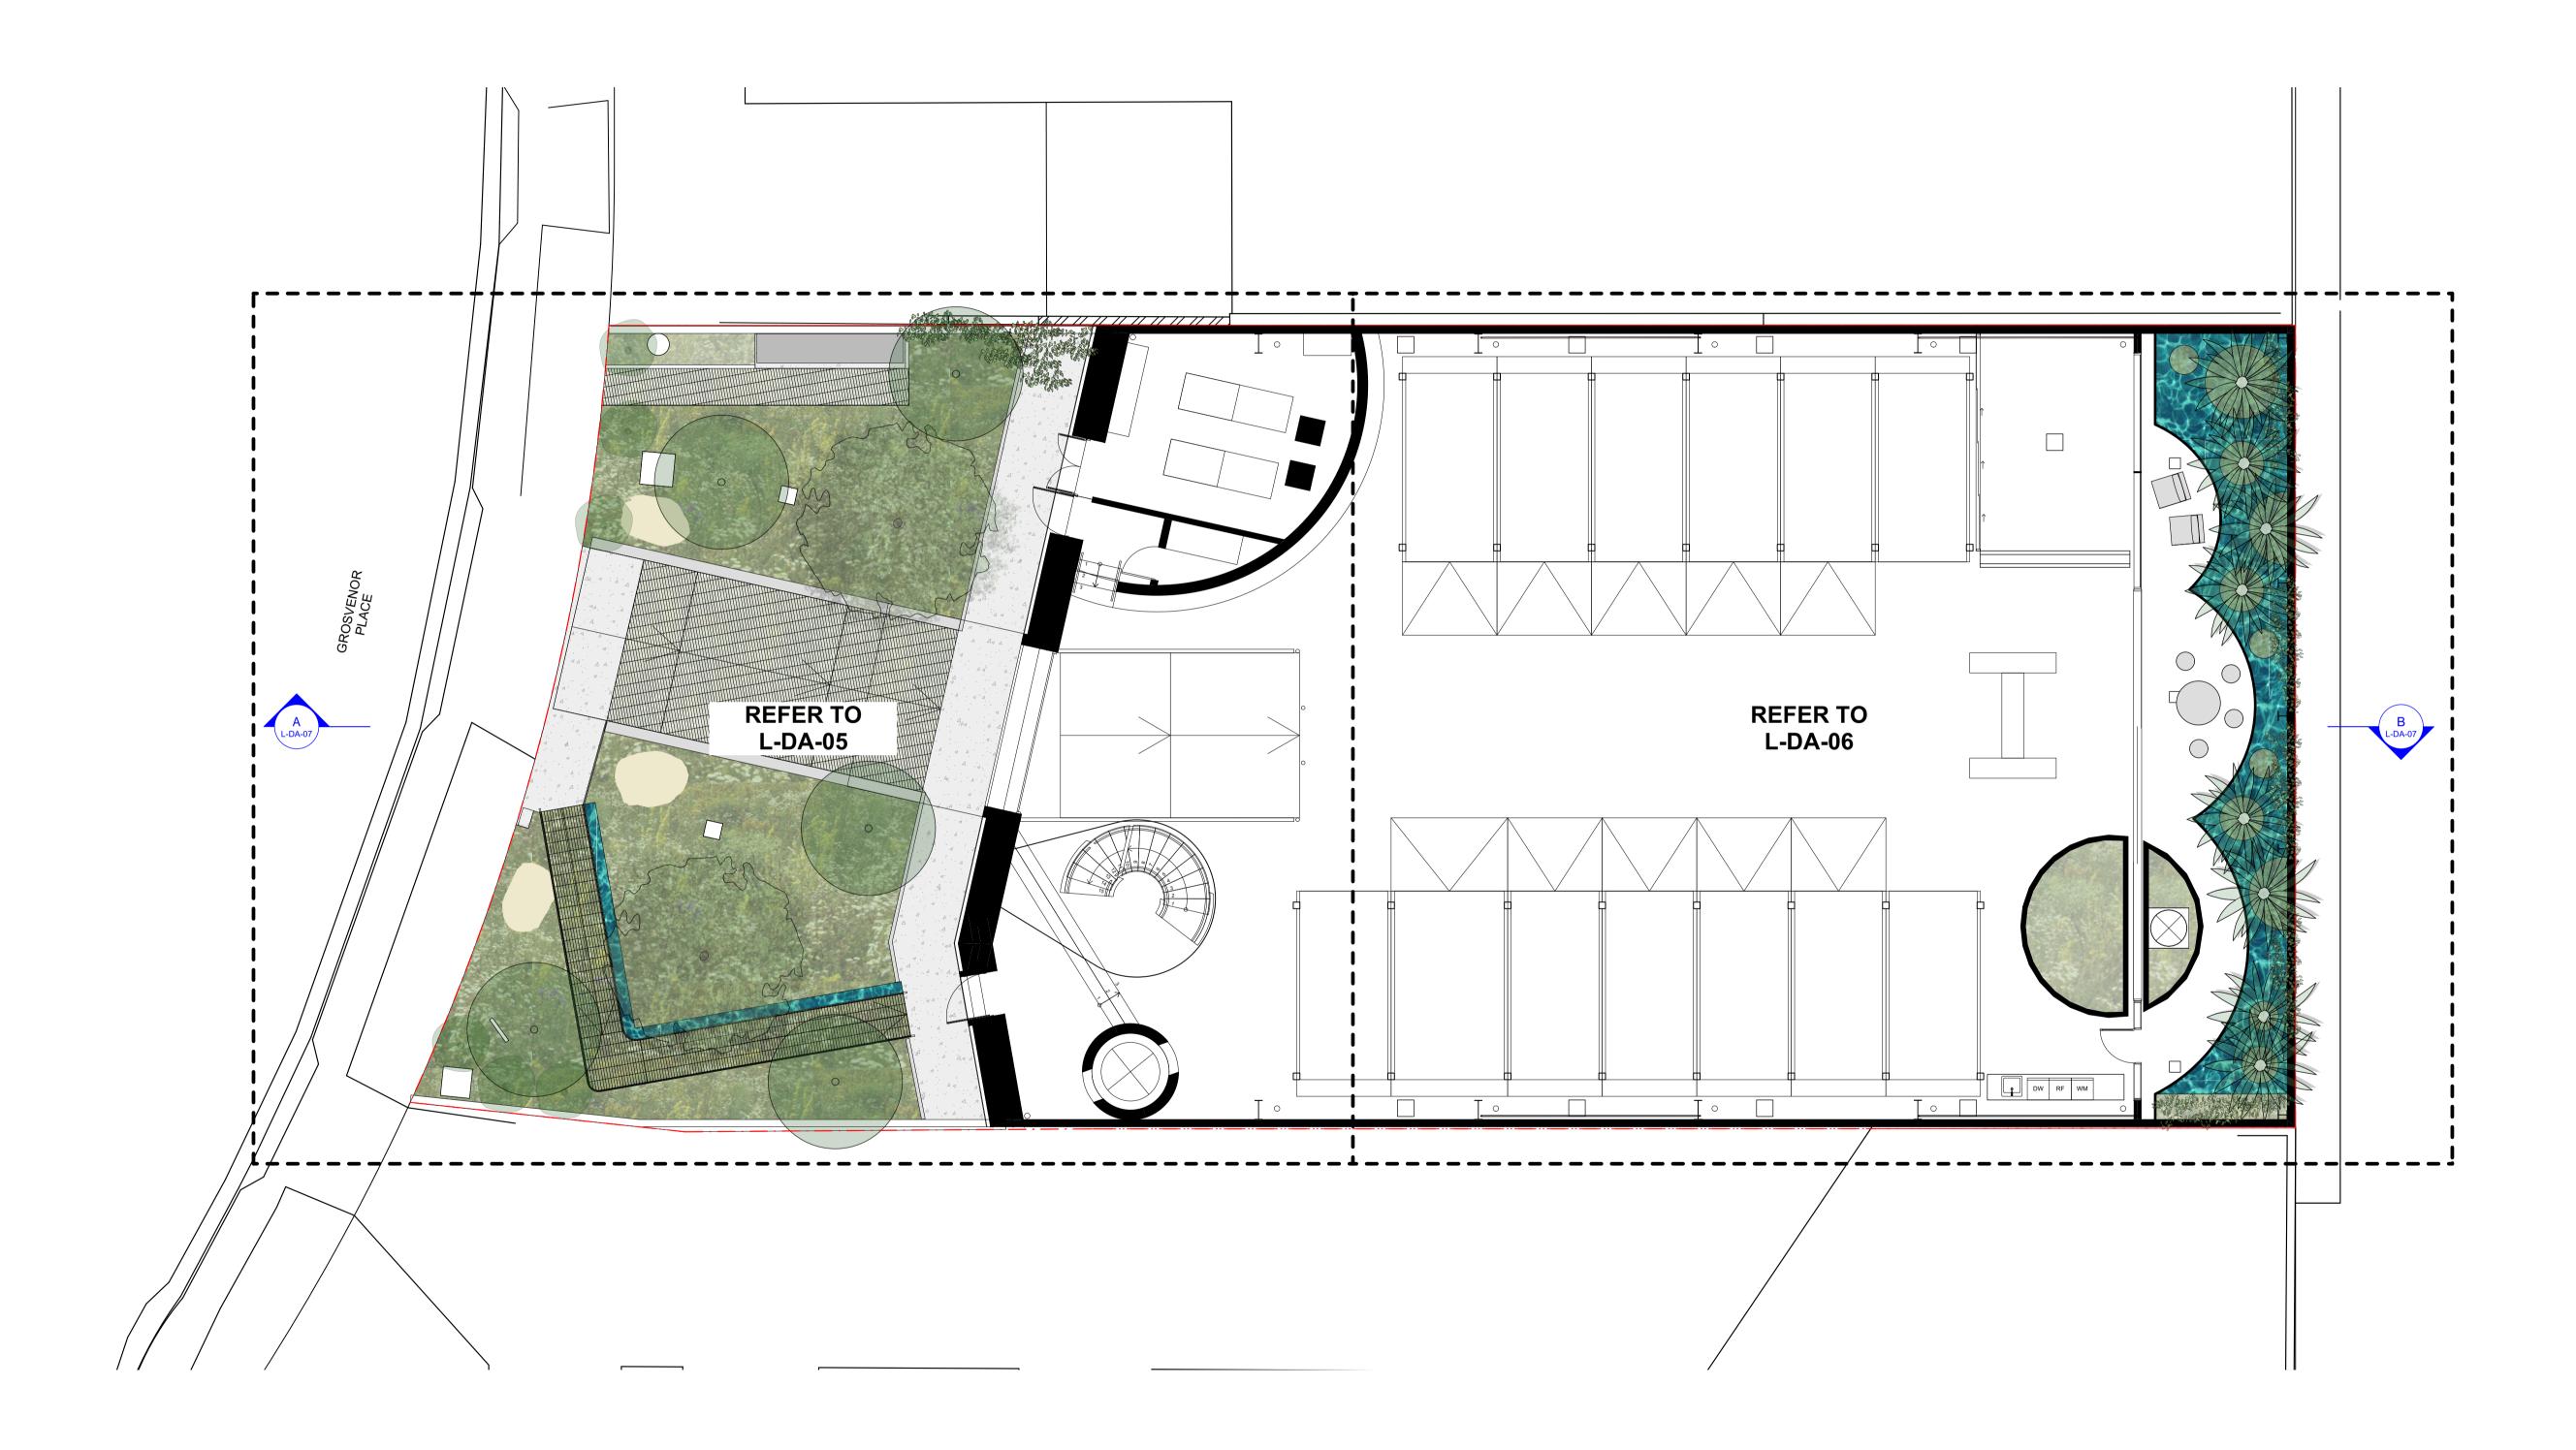


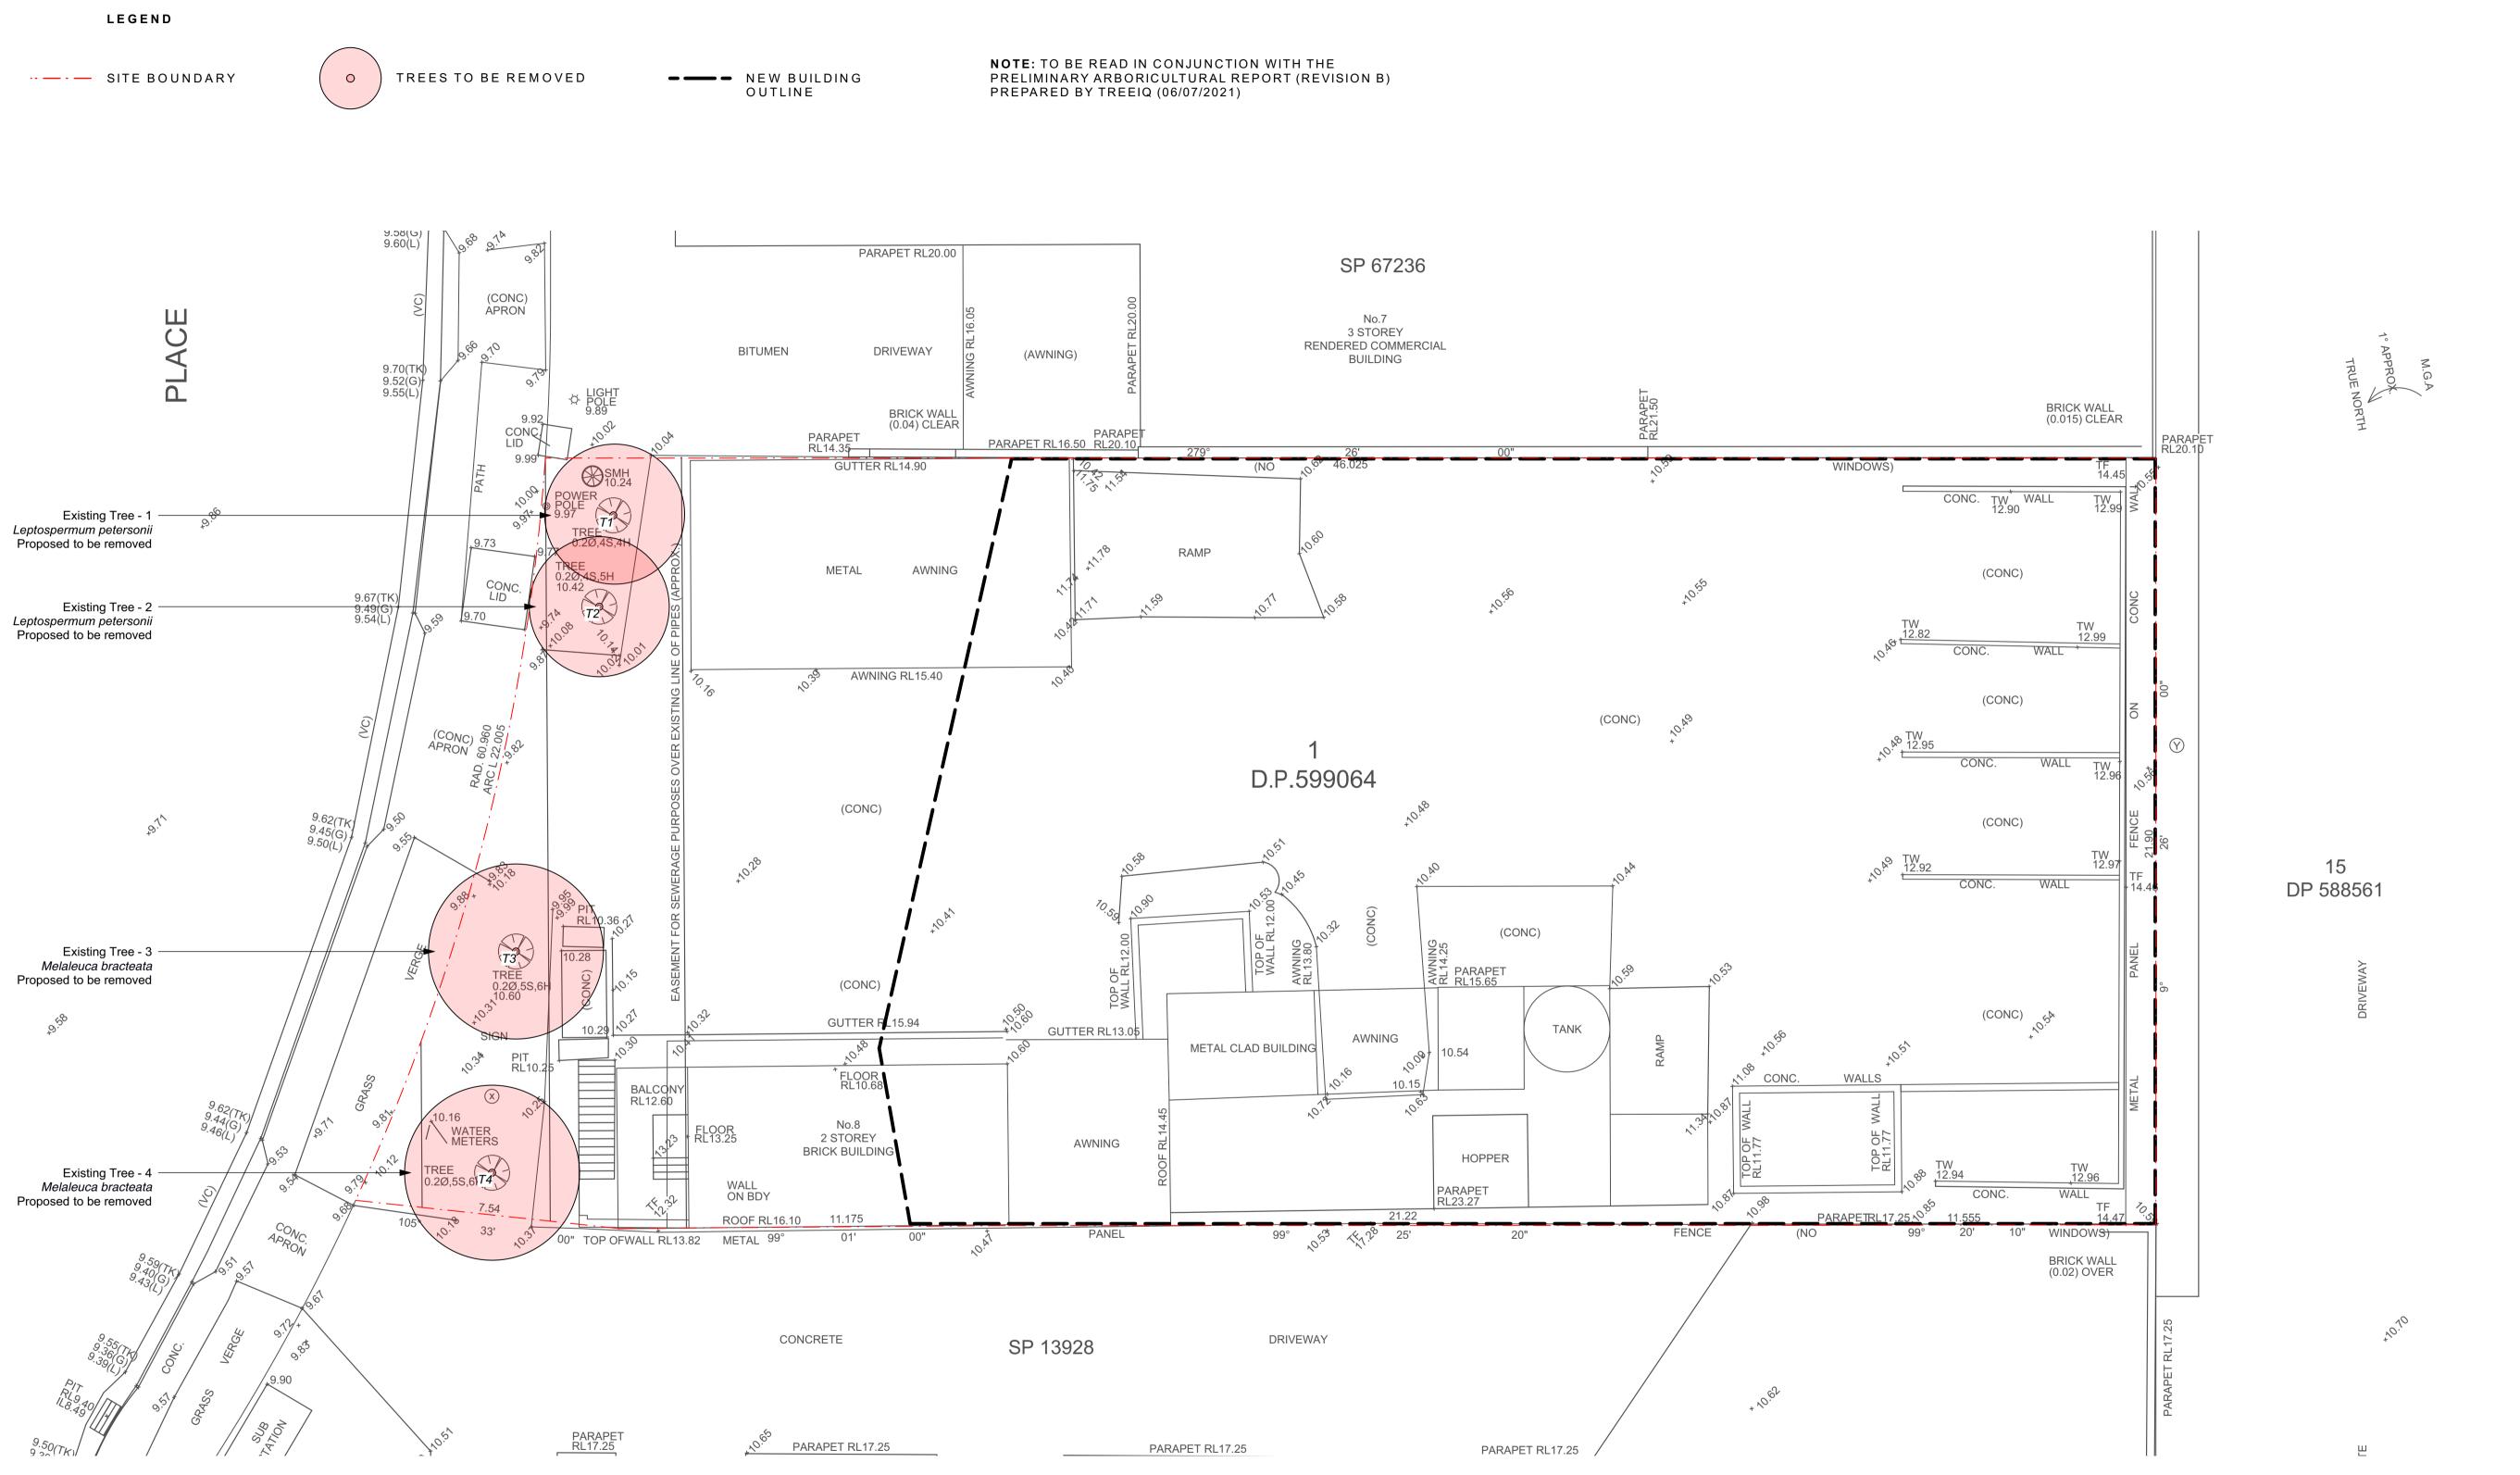

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									Use figured dimensions only. Verify all dimensions on site before the commencement of any works. Contractors shall locate and protect all services prior to construction. All work shall be carried out in accordance with NAS, BCA and Local Government Regulations. Structural Details shall be subject to Engineer's Specifications. Drainage & Water Feature Details shall be subject to Hydraulic Engineer's Specifications.	ARCHITECT Chenchow Li	ttle Architects	DRAWN BHC	- PROJECT
									All work shall be carried out in a professional manner by Qualified Tradesman according to Landscape Drawings and Engineer's Specifications. No responsibility will be taken by 360 Degrees Landscape Architects Pty Ltd for any variations in design, construction method, materials specified, and general specifications without permission from the Project Engineer or Landscape	scale 1:100	size A1	STAGE DA	8 Grosvenor Place, Bro
									Architect. This Drawing is copyright to 360 Degrees Landscape Architects Pty Ltd.	1.100		DA	





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Native climber to northern wall. Proposed species: *Hibbertia scandens* 

> Boundary wall/fence by Architect Existing sewer manhole

> Steel mesh walkway by Architect

Detention basin garden. Refer flood consultants report. Proposed native grass species: *Lomandra hystrix, Isolepis nodosa, Carex appressa, Poa sieberiana, Dianella caerulea 'Little Jess'* 

> Proposed native shrubs: Banksia robur Driveway kerb by Architect

GROSVENOR PLACE

Steel mesh driveway by Architect

Proposed sandstone boulders

Detention basin garden. Refer flood consultants report. Proposed native grass species: *Lomandra hystrix, Isolepis nodosa, Carex appressa, Poa sieberiana, Dianella caerulea 'Little Jess'* 

Steel mesh walkway by Architect

Proposed native trees: *Melaleuca linarifolia* 

Steel water feature connected to warehouse downpipes


Proposed native trees: *Tristaniopsis laurina 'Luscious'*/

Pillar by Ausgrid


Boundary wall/fence by / / Architect


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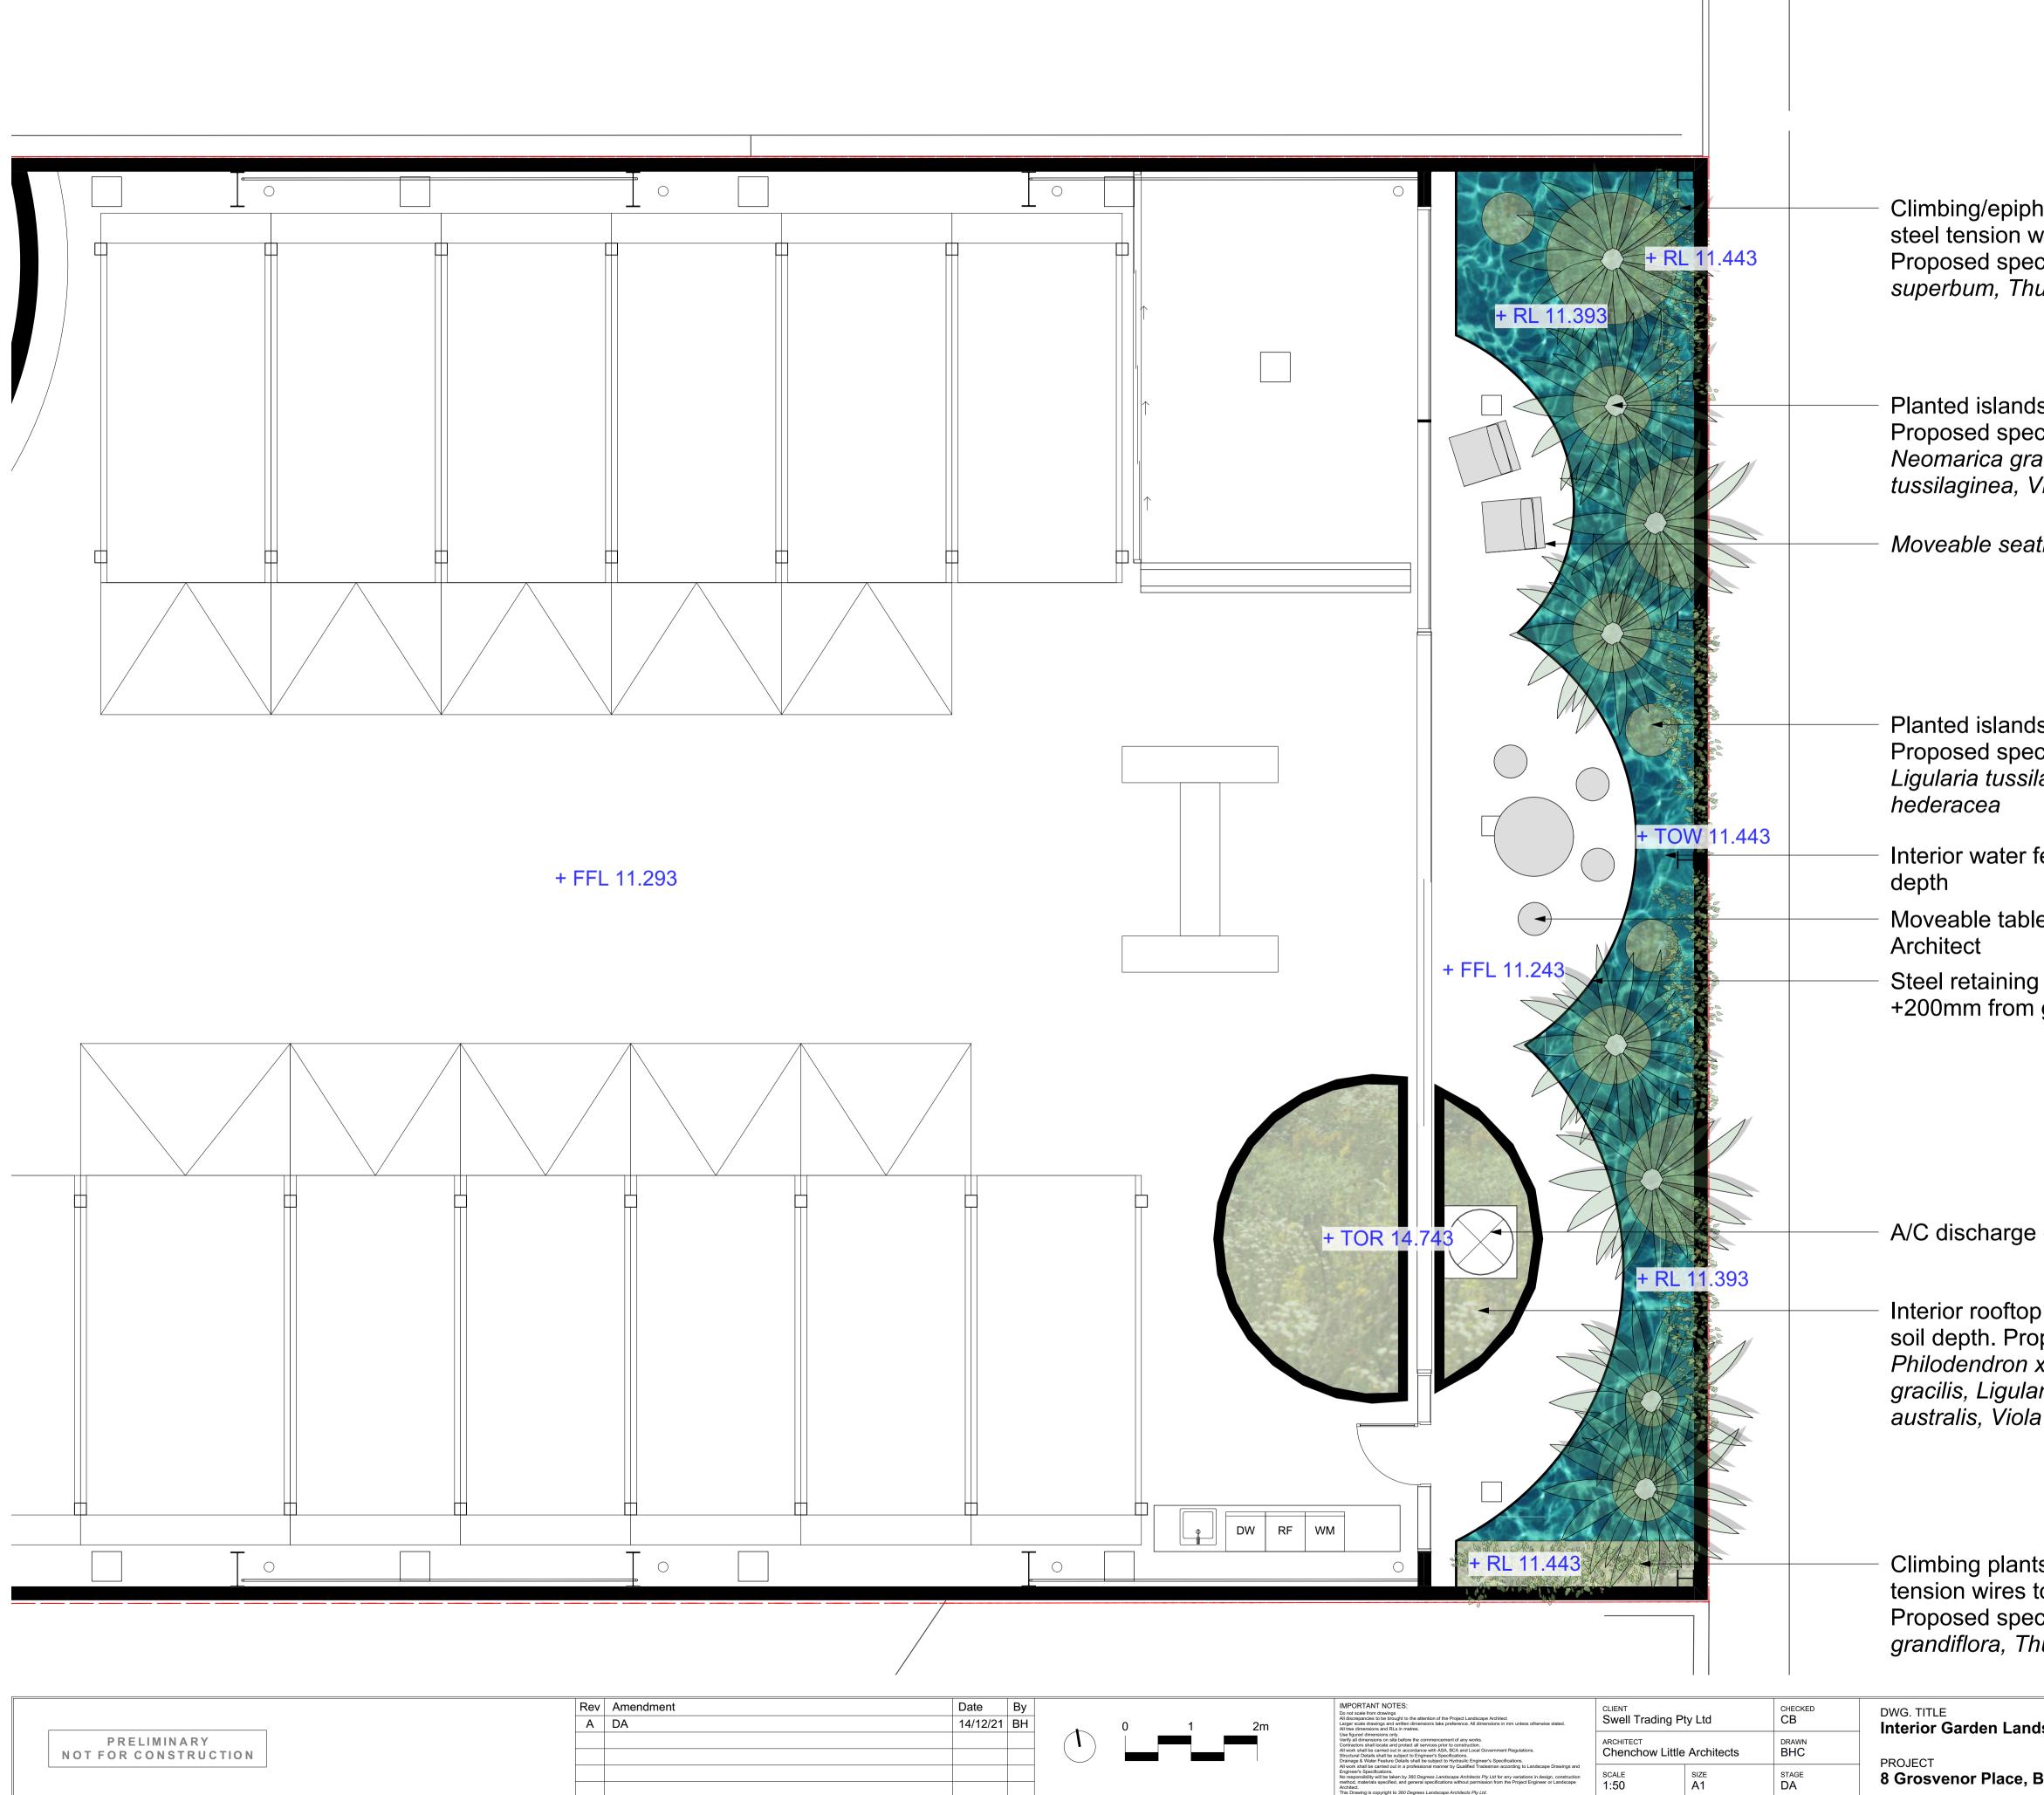
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							Confractors shall locate and protect all services prior to construction. All work shall be carried out in accordance with ASA, BCA and Local Government Regulations. Structural Details shall be subject to Ergineer's Specifications. Drainage & Water Feature Details shall be subject to Hydraulic Engineer's Specifications. All work shall be carried out in a professional manner by Qualified Tradesman according to Landscape Drawings and	ARCHITECT Chenchow Little Architects		
								scale 1:50	size A1	STAGE DA



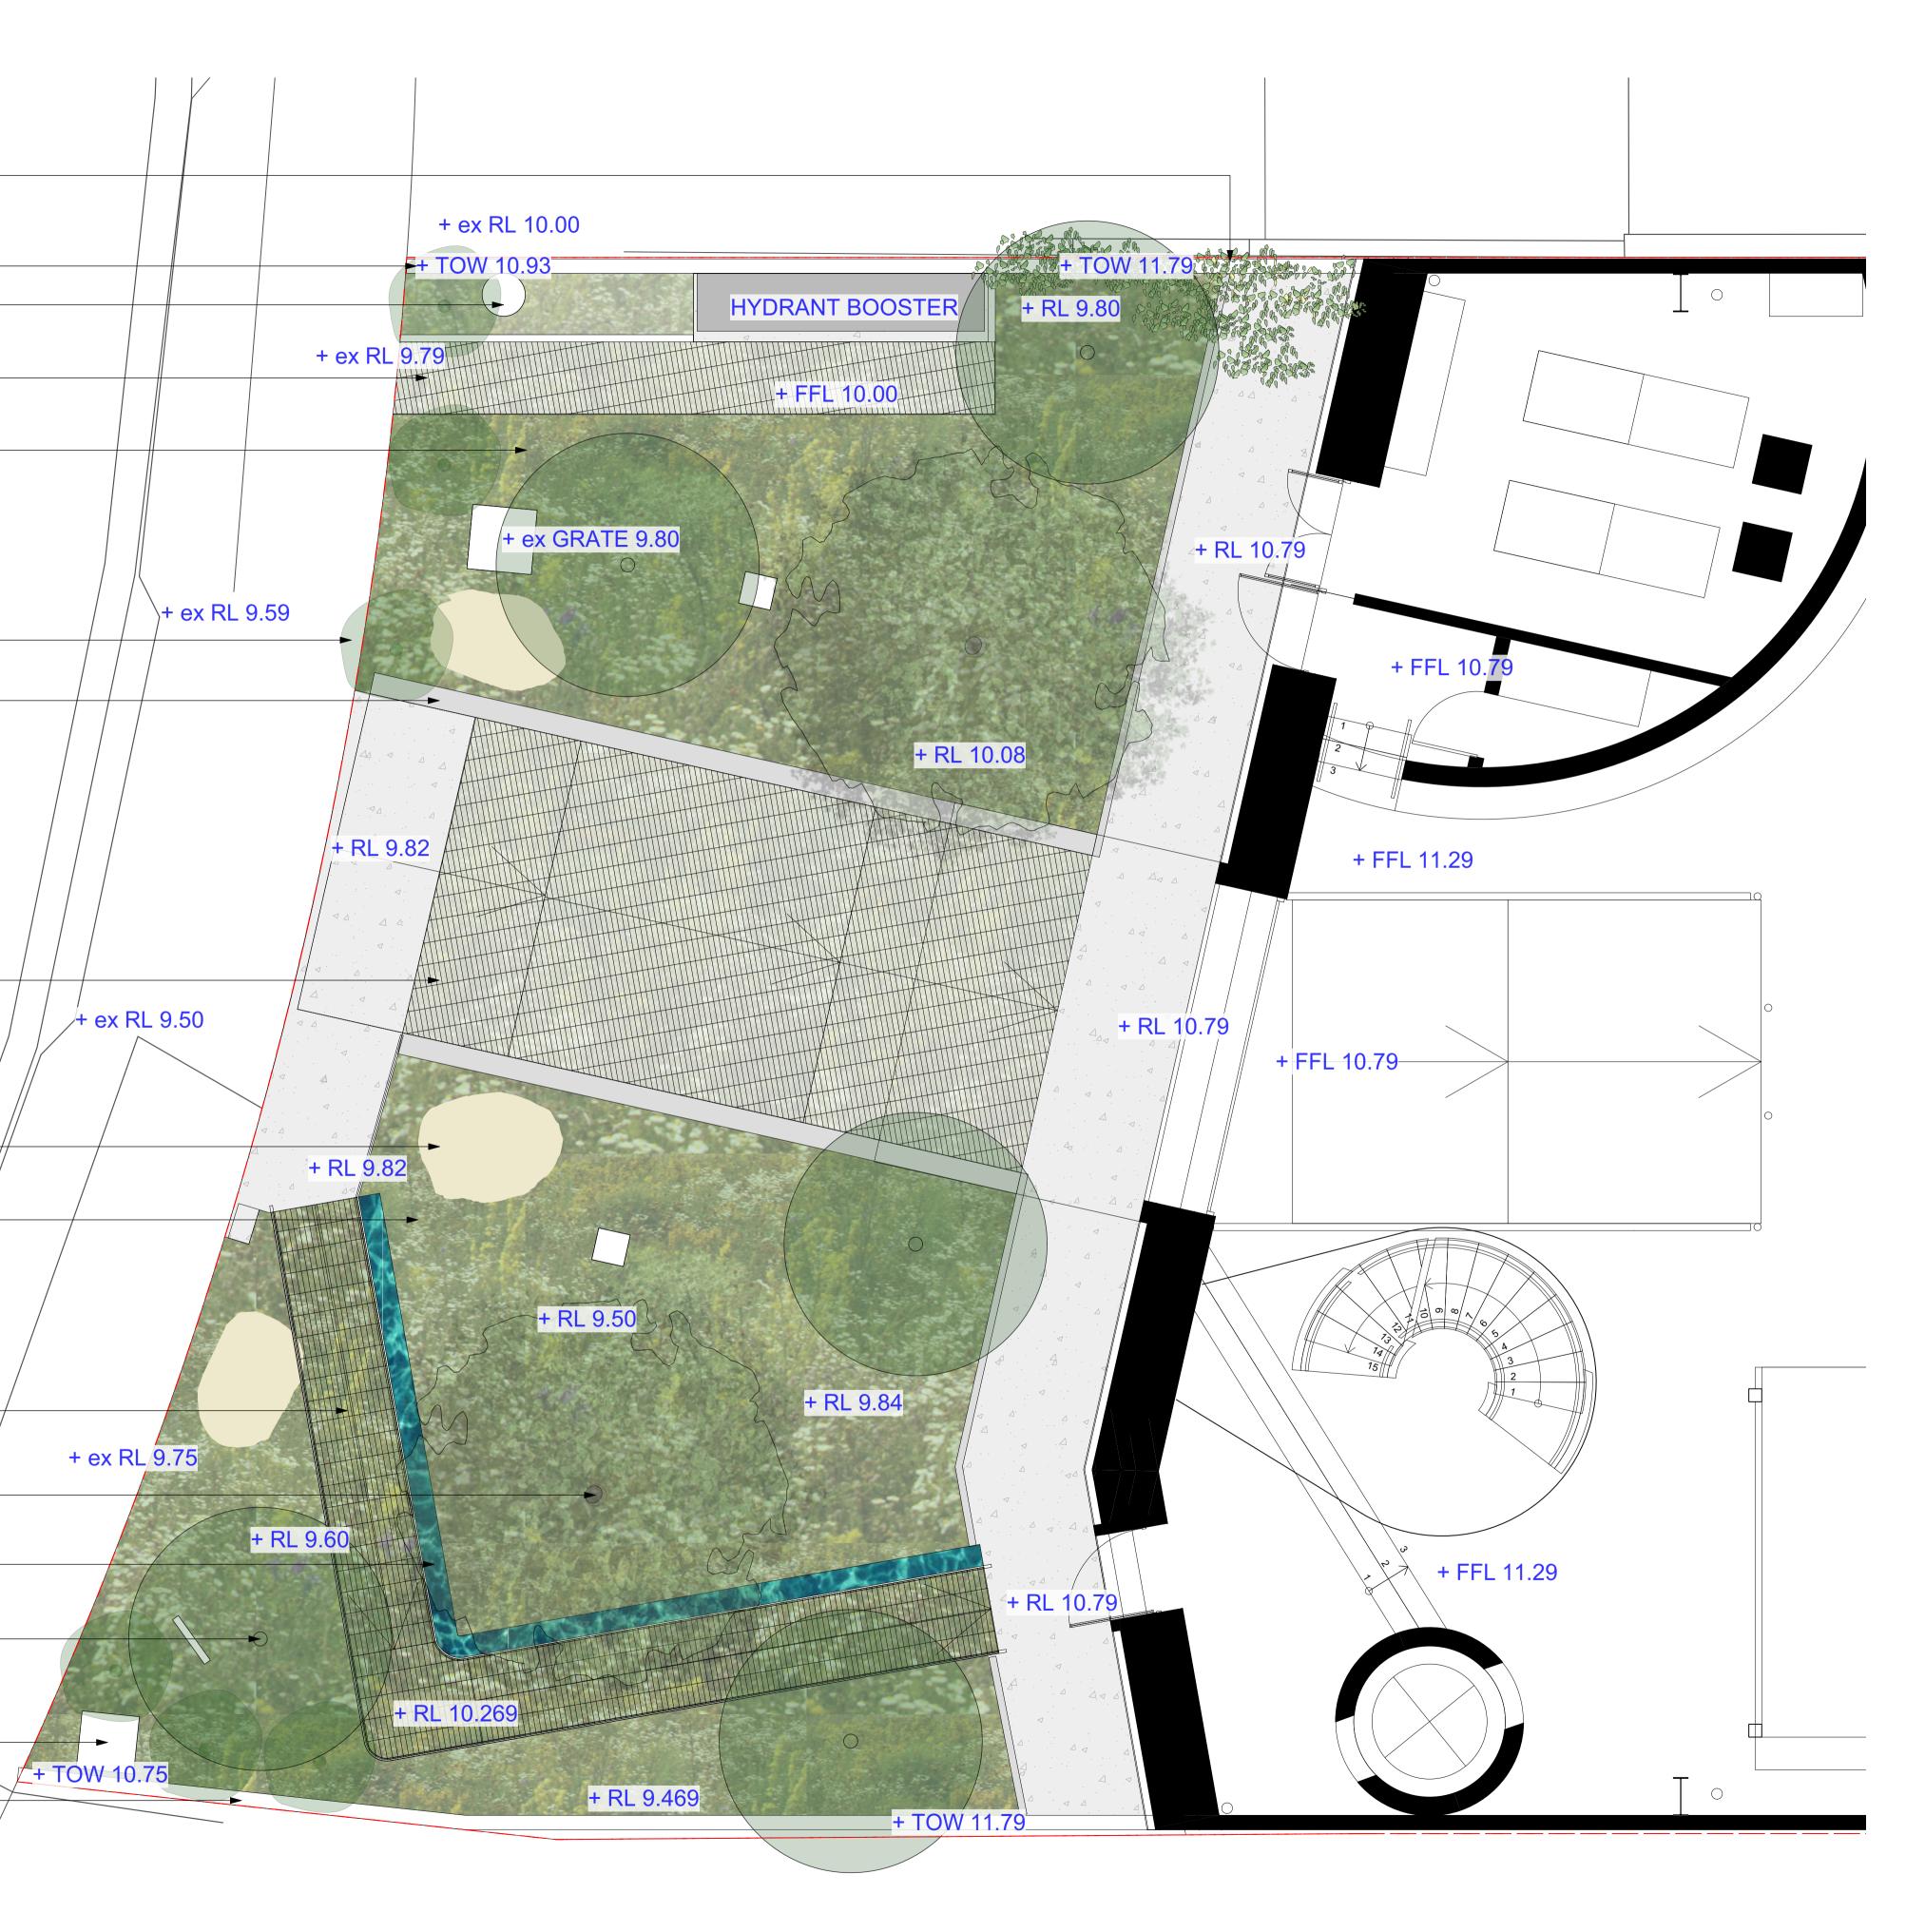

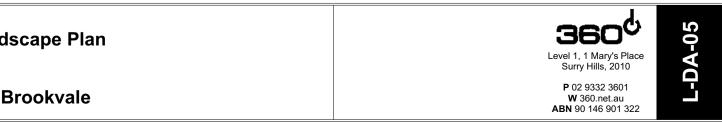

Climbing/epiphytic plants on stainless steel tension wires to interior wall. Proposed species: Platycerium superbum, Thunbergia grandiflora

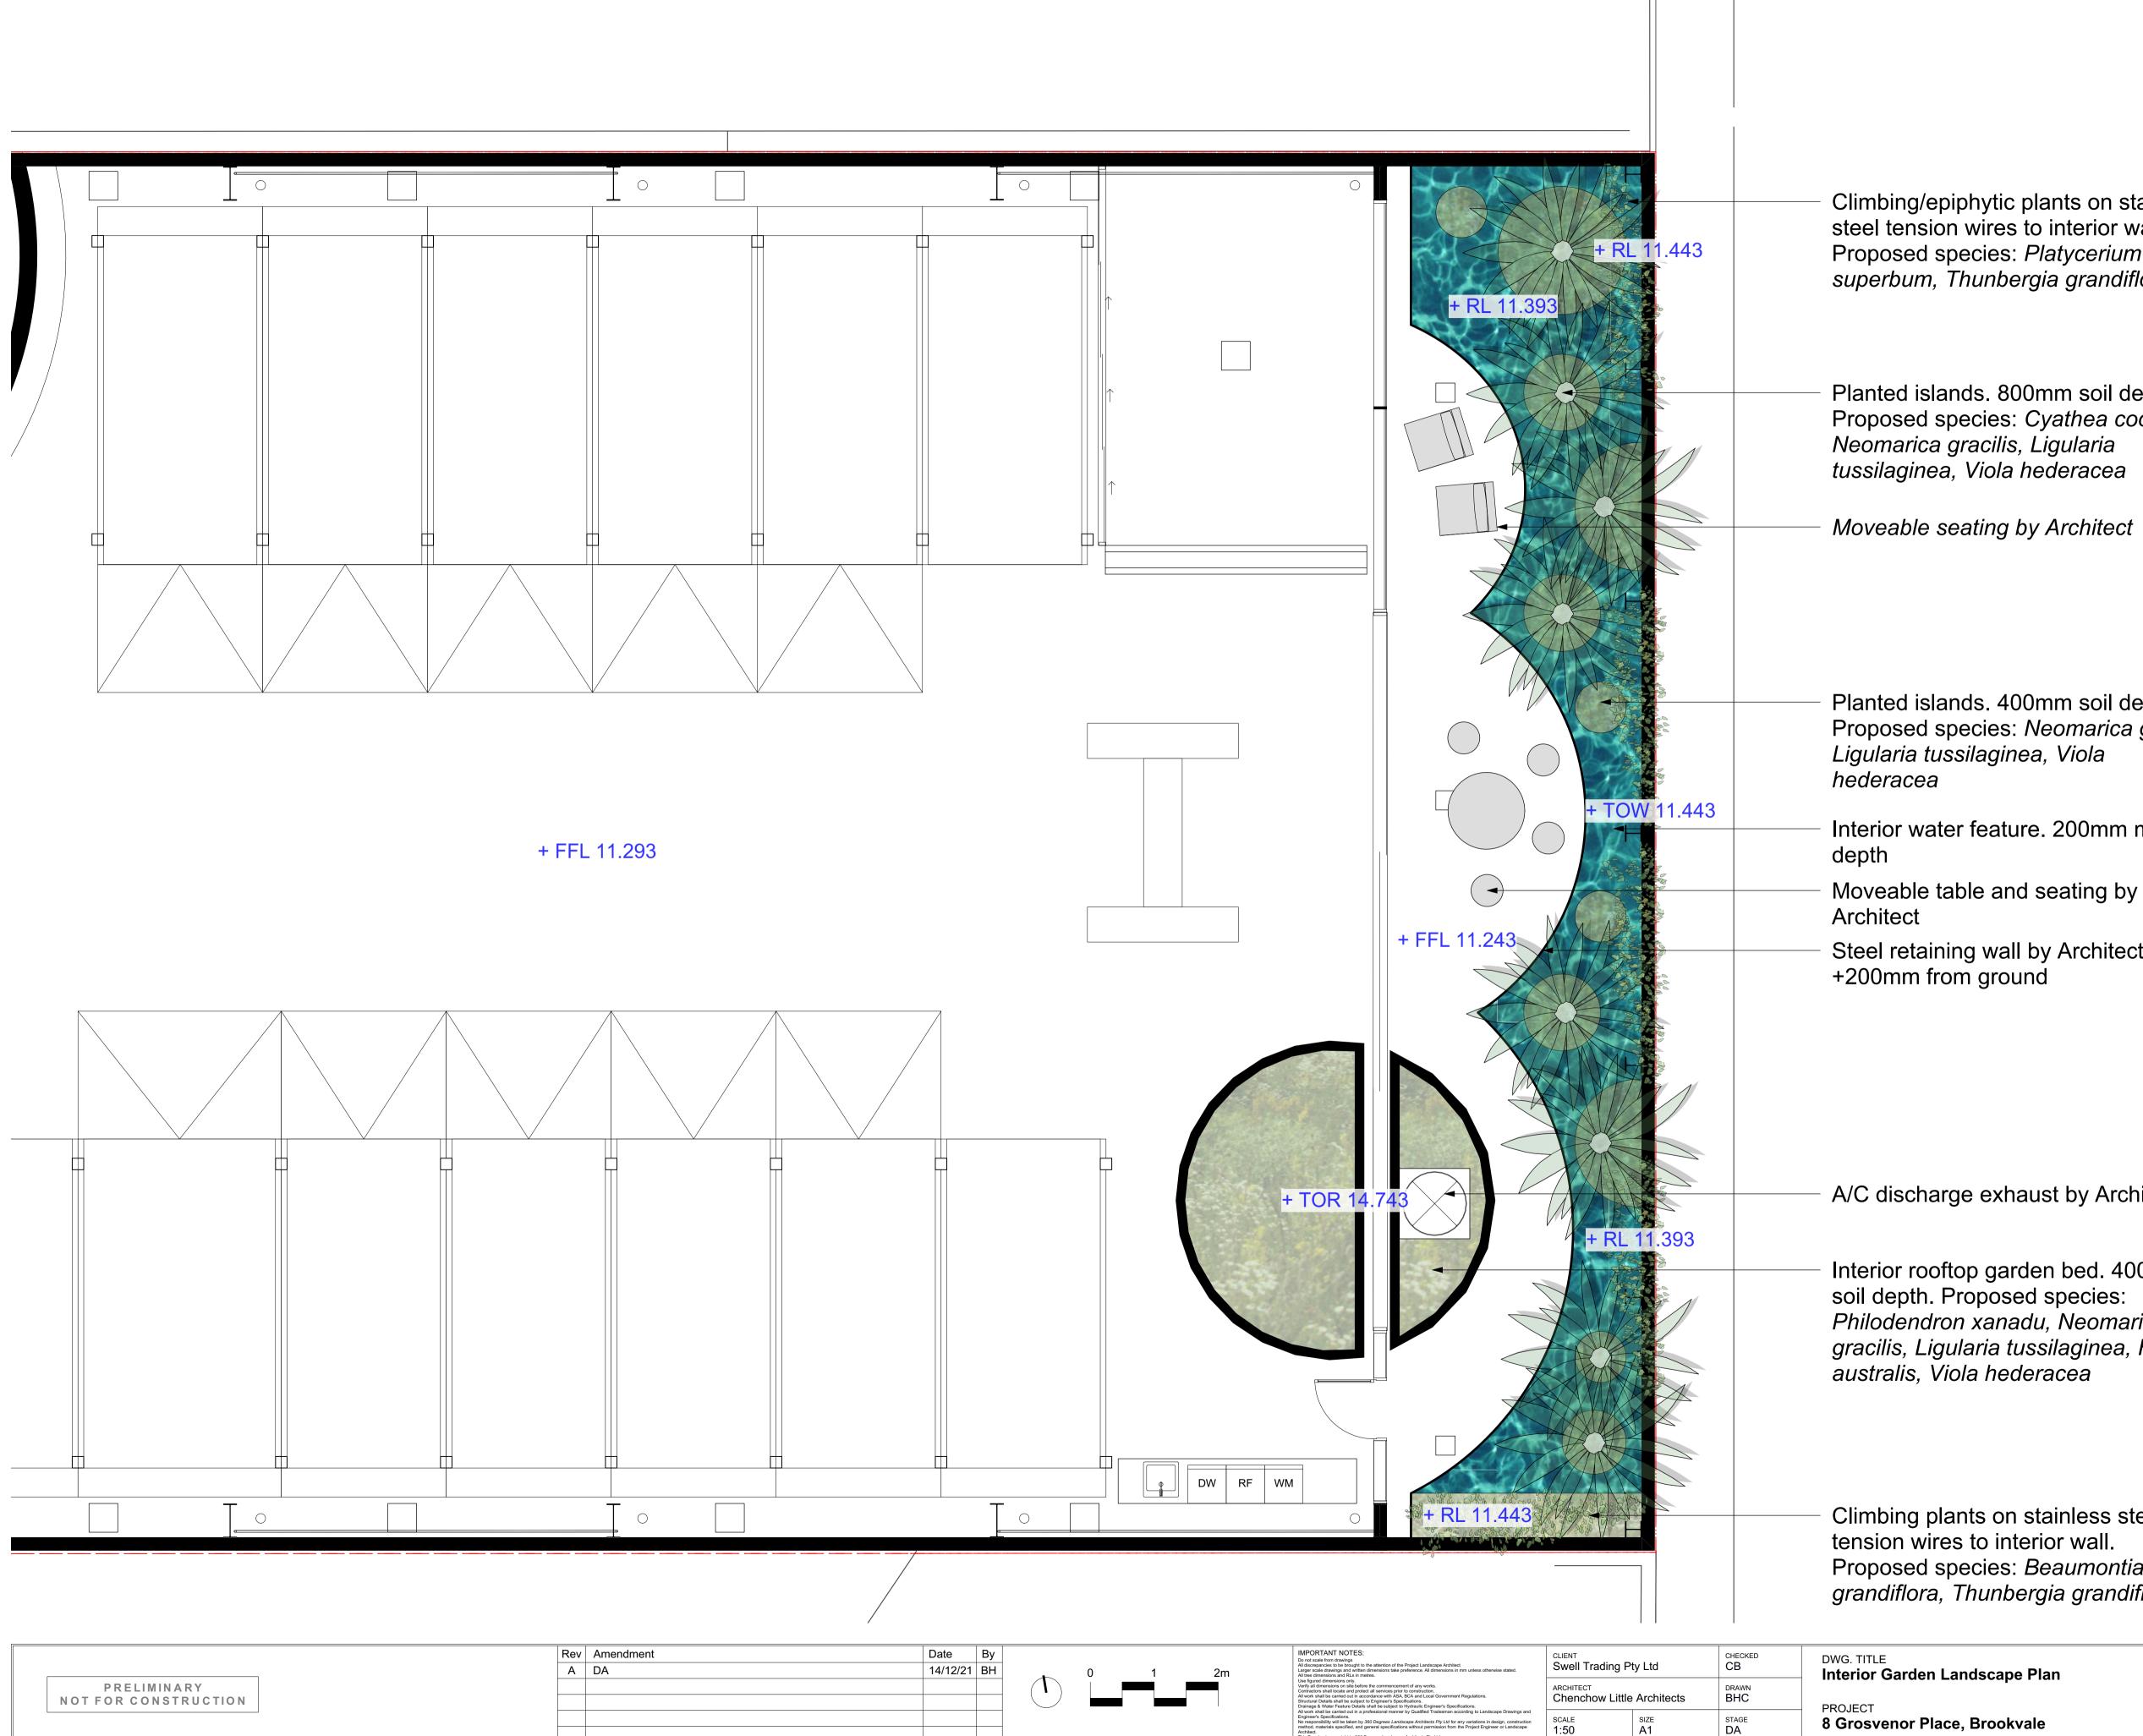Planted islands. 800mm soil depth. Proposed species: Cyathea cooperi,

Planted islands. 400mm soil depth. Proposed species: *Neomarica gracilis, Ligularia tussilaginea, Viola* 

Interior water feature. 200mm max


Steel retaining wall by Architect.

A/C discharge exhaust by Architect


Interior rooftop garden bed. 400mm Philodendron xanadu, Neomarica gracilis, Ligularia tussilaginea, Hoya

Climbing plants on stainless steel Proposed species: Beaumontia grandiflora, Thunbergia grandiflora



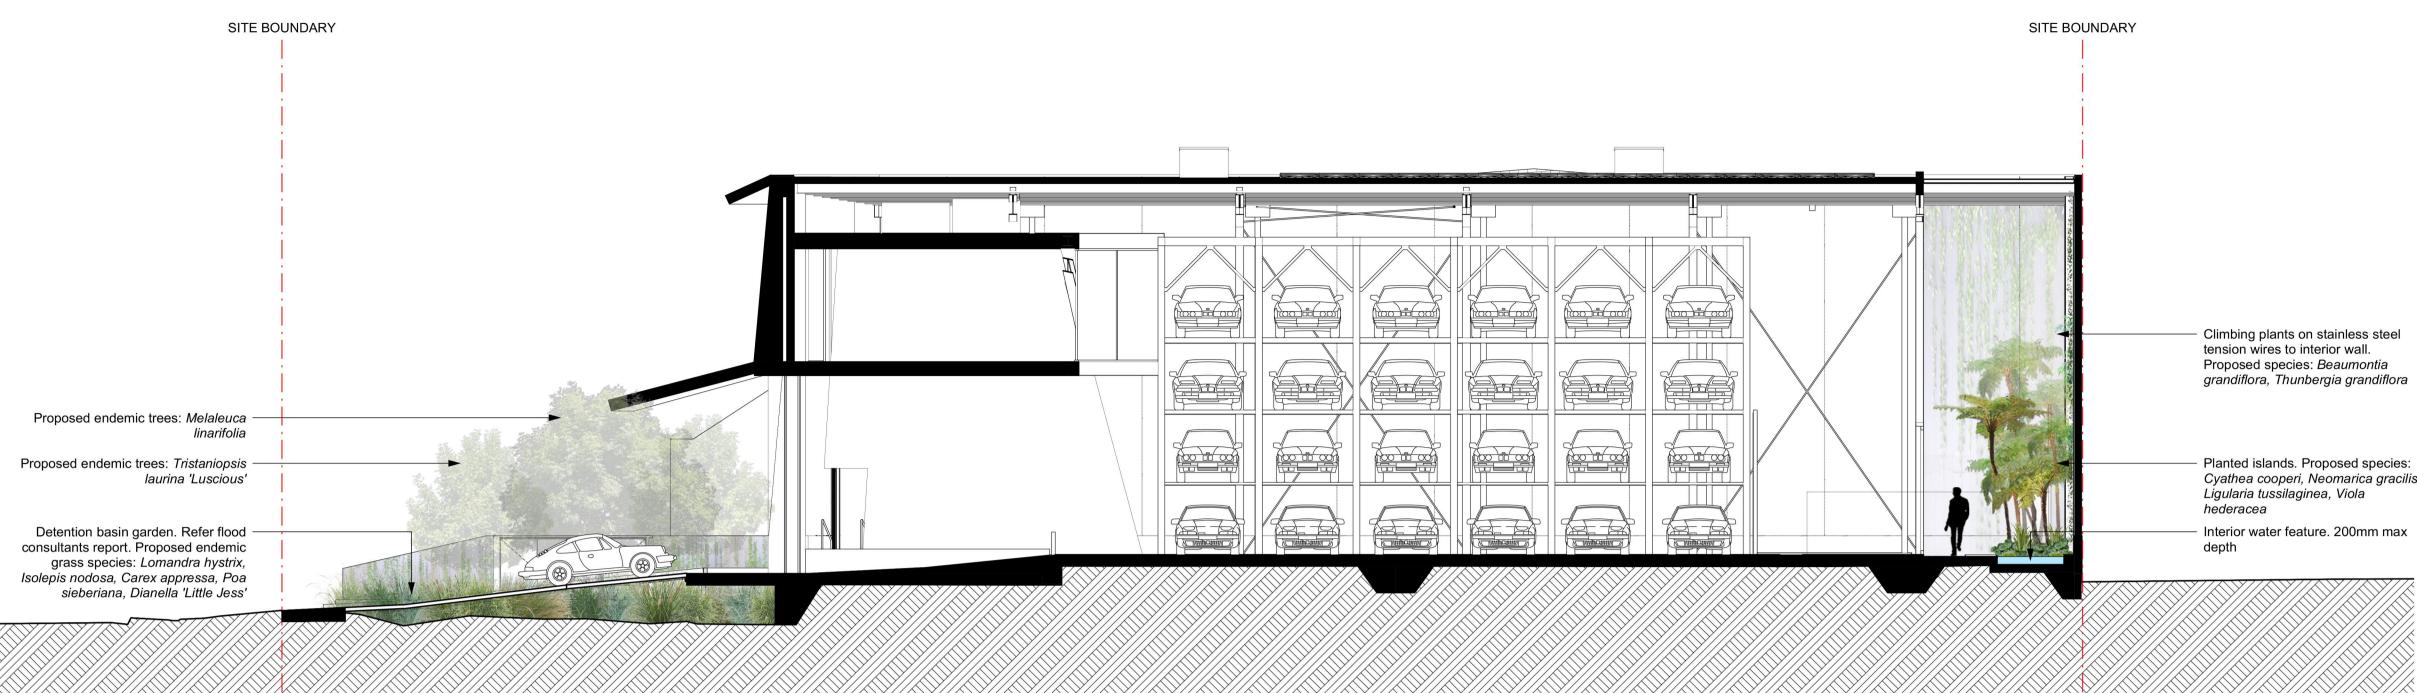



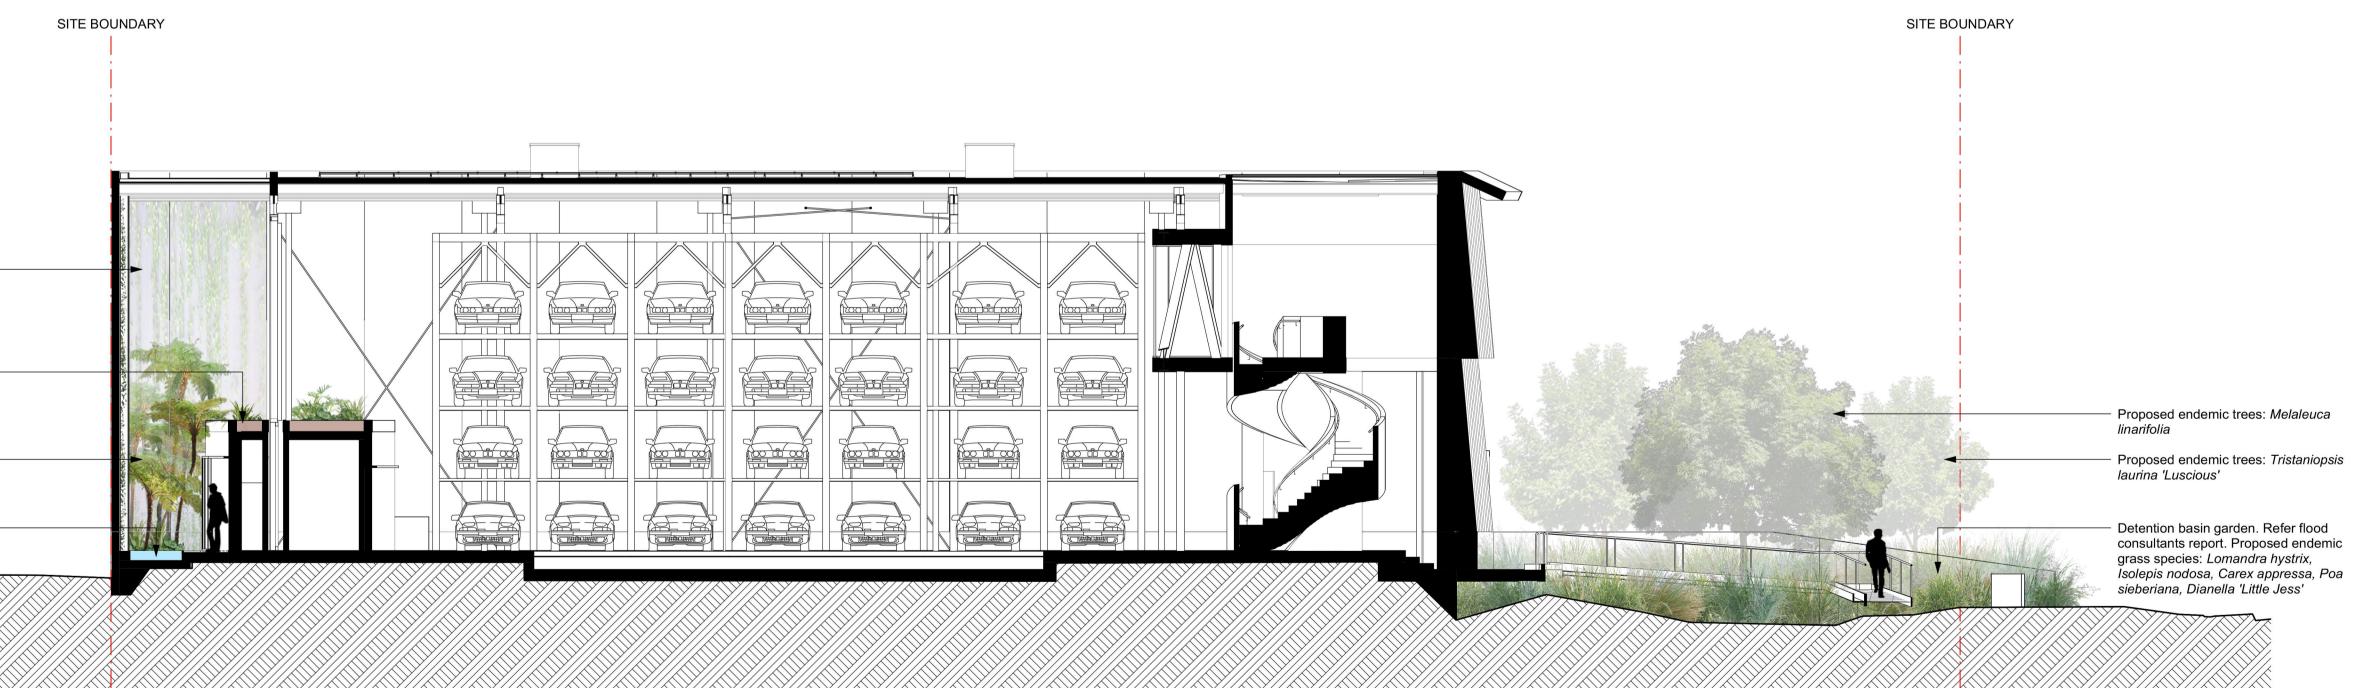

Climbing plants on stainless steel -tension wires to interior wall. Proposed species: Beaumontia grandiflora, Thunbergia grandiflora

Interior rooftop garden bed. Proposed -species: *Philodendron xanadu,* Neomarica gracilis, Ligularia tussilaginea, Hoya australis, Viola hederacea

Planted islands. Proposed species: -Cyathea cooperi, Neomarica gracilis, Ligularia tussilaginea, Viola hederacea

Interior water feature. 200mm max depth



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				scale 1:100	size A1	STAGE DA	8 Grosvenor Place, Bro

Planted islands. Proposed species: Cyathea cooperi, Neomarica gracilis, Ligularia tussilaginea, Viola

Interior water feature. 200mm max



Brookvale



### SHRUBS & GRASSES



LILIES



### EPIPHYTIC, GROUNDCOVER & CLIMBERS



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Beaumontia

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