

PROPOSED DEVELOPMENT
51 REDMAN ROAD, DEE WHY
STORMWATER MANAGEMENT PLANS

GENERAL NOTES:

1. THESE PLANS SHALL BE READ IN CONJUNCTION WITH OTHER RELEVANT CONSULTANTS'S PLANS, SPECIFICATIONS, CONDITIONS OF DEVELOPMENT CONEST AND CONSTRUCTION CERTIFICATE REQUIREMENTS. WHERE DISCREPANCIES ARE FOUND NASTASI & ASSOCIATES MUST BE CONTACTED IMMEDIATELY FOR VERIFICATION.
2. WHERE THESE PLANS ARE NOTED FOR DEVELOPMENT APPLICATION PURPOSES ONLY, THEY SHALL NOT BE USED FOR OBTAINING A CONSTRUCTION CERTIFICATE. NOR USED FOR CONSTRUCTION PURPOSES.
3. SUBSOIL DRAINAGE SHALL BE DESIGNED AND DETAILED BY THE STRUCTURAL ENGINEER. SUBSOIL DRAINAGE SHALL NOT BE CONNECTED INTO THE STORMWATER SYSTEM IDENTIFIED ON THESE PLAN UNLESS APPROVED BY NASTASI & ASSOCIATES ENGINEERS.

STORMWATER CONSTRUCTION NOTES:

1. ALL WORK SHALL BE CARRIED OUT IN ACCORDANCE WITH AS/NZS 3500 (CURRENT EDITION) AND THE REQUIREMENTS OF THE LOCAL COUNCIL'S POLICIES AND CODES
2. THE MINIMUM SIZE OF THE STORMWATER DRAINS SHALL NOT BE LESS THAN DN 90 FOR CLASS 1 BUILDINGS AND DN100 FOR OTHER CLASSES OF BUILDING OR AS REQUIRED BY REGULATORY AUTHORITY
3. THE MINIMUM GRADIENT OF STORMWATER DRAINS SHALL BE 1%, UNLESS NOTED OTHERWISE
4. COUNCIL'S TREE PRESERVATION ORDER IS TO BE STRICTLY ADHERED TO. NO TREES SHALL BE REMOVED UNTIL PERMIT IS OBTAINED
5. PUBLIC UTILITY SERVICES ARE TO BE ADJUSTED AS NECESSARY AT THE CLIENT'S EXPENSE
6. ALL PITS TO BE BENCHED AND STREAMLINED. PROVIDE STEP IRONS FOR ALL PITS OVER 1.2m DEEP
7. MAKE SMOOTH JUNCTION WITH ALL EXISTING WORK
8. VEHICULAR ACCESS AND ALL SERVICES TO BE MAINTAINED AT ALL TIMES TO ADJOINING PROPERTIES AFFECTED BY CONSTRUCTION
9. SERVICES SHOWN ON THESE PLANS HAVE BEEN LOCATED FROM INFORMATION SUPPLIED BY THE RELEVANT AUTHORITIES AND FIELD INVESTIGATIONS AND ARE NOT GUARANTEED COMPLETE NOR CORRECT. IT IS THE CLIENT & CONTRACTOR'S RESPONSIBILITY TO LOCATE ALL PRIOR TO CONSTRUCTION
10. ANY VARIATION TO THE WORKS AS SHOWN ON THE APPROVED DRAWINGS ARE TO BE CONFIRMED BY NASTASI & ASSOCIATES PRIOR TO THEIR COMMENCEMENT

RAINWATER RE-USE NOTES:

1. RAINWATER SUPPLY PLUMBING TO BE CONNECTED TO OUTLETS WHERE REQUIRED BY BASIX CERTIFICATE (BY OTHERS)
2. TOWN WATER CONNECTION TO RAINWATER TANK TO THE SATISFACTION OF THE REGULATORY AUTHORITY. THIS WAY REQUIRE PROVISION OF:
2.1. PERMANENT AIR GAP
2.2. BACKFLOW PREVENTION DEVICE
3. NO DIRECT CONNECTION BETWEEN TOWN WATER SUPPLY AND THE RAINWATER SUPPLY
4. AN APPROVED STOP VALVE AND/OR PRESSURE LIMITING VALVE AT THE RAINWATER TANK
5. PROVIDE AT LEAST ONE EXTERNAL HOSE COCK ON THE TOWN WATER SUPPLY FOR FIRE FIGHTING
6. PROVIDE APPROPRIATE FLOAT VALVES AND/OR SOLENOID VALVES TO CONTROL TOWN WATER SUPPLY INLET TO TANK IN ORDER TO ACHIEVE THE TOP-UP INDICATED ON THE TYPICAL DETAIL
7. ALL PLUMBING WORKS ARE TO BE CARRIED OUT BY LICENSED PLUMBERS IN ACCORDANCE WITH AS/NZS3500.1 NATIONAL PLUMBING AND DRAINAGE CODE
8. PRESSURE PUMP ELECTRICAL CONNECTION TO BE CARRIED OUT BY A LICENSED ELECTRICIAN
9. ONLY ROOF RUN-OFF IS TO BE DIRECTED TO THE RAINWATER TANK. SURFACE WATER INLETS ARE NOT BE CONNECTED
10. PIPE MATERIALS FOR RAINWATER SUPPLY PLUMBING ARE TO BE APPROVED MATERIALS TO AS/NZE3500 PART 1 SECTION 2 AND TO BE CLEARLY AND PERMANENTLY IDENTIFIED AS 'RAINWATER'. THIS MAY BE ACHIEVED FOR BELOW GROUND PIPES USING IDENTIFICATION TAPE (MADE IN ACCORDANCE WITH AS2648) OR FOR ABOVE GROUND PIPES BY USING ADHESIVE PIPE MARKERS (MAKE IN ACCORDANCE WITH AS1945)
11. EVERY RAINWATER SUPPLY OUTLET POINT AND THE RAINWATER TANK ARE TO BE LABELED 'RAINWATER' ON A METALLIC SIGN IN ACCORDANCE WITH AS191619
12. ALL INLETS AND OUTLETS TO THE RAINWATER TANK ARE TO HAVE SUITABLE MEASURES PROVIDED TO PREVENT MOSQUITO AND VERMIN ENTRY.

EROSION AND SEDIMENT NOTES:

1. THESE PLANS SHALL BE READ IN CONJUNCTION WITH EROSION AND SEDIMENT CONTROL DETAILS AS ATTACHED
2. THE CONTRACTOR SHALL IMPLEMENT ALL SOIL EROSION AND SEDIMENT CONTROL MEASURE AS NECESSARY AND TO THE SATISFACTION OF THE RELEVANT LOCAL AUTHORITY PRIOR TO THE COMMENCEMENT ANY DURING CONSTRUCTION. NO DISTURBANCE TO THE SITE SHALL BE PERMITTED OTHER THAN IN THE IMMEDIATE AREA OF THE WORKS AND NO MATERIAL SHALL BE REMOVED FROM THE SITE WITHOUT THE RELEVANT LOCAL AUTHORITY APPROVAL. ALL EROSION AND SEDIMENT CONTROL DEVICES TO BE INSTALLED AND MAINTAINED IN ACCORDANCE WITH STANDARDS OUTLINED IN NSW DEPARTMENT OF HOUSING'S "MANAGING URBAN STORMWATER - SOILS AND CONSTRUCTIONS"
3. TOPSOIL SHALL BE STRIPPED AND STOCKPILED OUTSIDE HAZARD AREA SUCH AS DRAINAGE LINES. THIS TOPSOIL SHALL BE RESPREAD LATER ON AREAS TO BE REVEGETATED AND STABILIZED ONLY. TOPSOIL SHALL NOT BE RESPREAD ON ANY OTHER AREA UNLESS SPECIFICALLY INSTRUCTED BY THE SUPERINTENDENT. IF THEY ARE TO REMAIN LONGER THAN ONE MONTH STOCK PILES SHALL BE PROTECTED FROM EROSION BY COVERING THEM WITH A MULCH AND HYDROSEEDING AND, IF NECESSARY, BY LOCATING BANKS OR DRAINS DOWNSTREAM OF A STOCKPILE TO RETARD SILT LADEN RUNOFF
4. THE CONTRACTOR SHALL REGULARLY MAINTAIN ALL EROSION AND SEDIMENT CONTROL DEVICES AND REMOVE ACCUMULATED SILT FROM SUCH DEVICES SUCH THAT MORE THAN 60% OF THEIR CAPACITY IS LOST. ALL THE SILT IS TO BE PLACED OUTSIDE THE LIMIT OF WORKS. THE PERIOD FOR MAINTAINING THESE DEVICES SHALL BE AT LEAST UNTIL ALL DISTURBED AREAS ARE REVEGETATED AND FURTHER AS MAY BE DIRECTED BY SUPERINTENDENT, OR COUNCIL
5. VEHICULAR TRAFFIC SHALL BE CONTROLLED DURING CONSTRUCTION CONFINING ACCESS WHERE POSSIBLE TO NOMINATED STABILISED ACCESS POINTS
6. THE CONTRACTOR SHALL IMPLEMENT DUST CONTROL BY REGULAR WETTING DOWN DISTURBED AREA
7. ALL DRAINAGE PIPE INLETS TO BE CAPPED UNTIL.
- DOWNPIPES CONNECTED
- PITS CONSTRUCTED AND PROTECTED WITH SILT BARRIER

MINIMUM PIPE COVER NOTES:

| LOCATION | MINIMUM COVER |
|-------------------------------|------------------------------|
| NO SUBJECT TO VEHICLE LOADING | 100mm SINGLE RESIDENTIAL |
| SUBJECT TO VEHICLE LOADING | 450mm WHERE NOT IN A ROAD |
| UNDER A SEALED ROAD | 600mm |
| UNSEALED ROAD | 750mm |
| PAVED DRIVEWAY | 100mm PLUS DEPTH OF CONCRETE |

SEE AS2032 INSTALLATION OF UPVC PIPES FOR FURTHER INFORMATION.

CONCRETE PIPE COVER SHALL BE IN ACCORDANCE WITH AS3725-1989 LOADS ON BURIED CONCRETE PIPES, HOWEVER A MINIMUM COVER OF 450mm WILL APPLY.

WHERE INSUFFICIENT COVER IS PROVIDED, THE PIPE SHALL BE COVERED AT LEAST 50mm THICK OVERLAY AND SHALL BE PAVED WITH AT LEAST:
- 150 mm REINFORCED CONCRETE WHERE SUBJECT TO HEAVY VEHICLE TRAFFIC
- 75mm THICKNESS OF BRICK OR 100mm OF CONCRETE PAVING WHERE SUBJECT TO LIGHT VEHICLE TRAFFIC, OR
- 50mm THICK BRICK OR CONCRETE PAVING WHERE NOT SUBJECT TO VEHICLE TRAFFIC

SURFACE STORMWATER PIT NOTES:

| PIT DEPTH (mm) | MINIMUM PIT SIZE (mm) |
|-------------------------------|-----------------------|
| UP TO 600 mm | 450 x 450 |
| FROM 600mm TO LESS THAN 900mm | 600 x 600 |
| FROM 900mm | 900 x 900 |

ALL BASEMENT PIT TO BE FITTED WITH HEAVY DUTY CLASS C GRADE & FRAME

LEGEND

| | |
|--|--|
| | DENOTES BELOW GROUND ON-SITE DETENTION TANK |
| | DENOTES ON-SITE DETENTION BASIN |
| | DENOTES Ø150 DOWNPIPE (U.N.O) |
| | DENOTES INSPECTION OPENING WITH SCREW DOWN LID AT FINISHED SURFACE LEVEL |
| | DENOTED PLANTER BOX DRAINS |
| | DENOTED FLOOR DRAINS |
| | DENOTED CLEANING EYE |
| | STORMWATER PIT - SOLID COVER |
| | STORMWATER PIT - GRATED INLET |
| | DENOTES GRATED DRAIN |
| | DENOTES ABSORPTION TRENCH |
| | DENOTES NON RETURN VALVE |
| | DENOTES OVERLAND FLOW PATH |
| | INVERT LEVEL |
| | TOP OF KERB |
| | REDUCED LEVEL/SURFACE LEVEL |
| | PROPOSED FINISH SURFACE LEVEL |
| | DENOTED Ø100mm PVC (SEWER GRADE) @1% MIN. FALL U.N.O |
| | DENOTED Ø150mm PVC (SEWER GRADE) @1% MIN. FALL U.N.O |
| | DENOTED Ø100mm PVC (SEWER GRADE) @0.5% MIN. FALL U.N.O |
| | DENOTE AGG PIPE |
| | DENOTE RAINWATER TANK |

SCHEDULE OF DRAWING

| DESCRIPTION | SHEET NUMBER |
|---------------------------|--------------|
| COVER SHEET & NOTES | C1 |
| DRAINAGE PLANS | C2 |
| OSD/RWT 1 PLAN & DETAILS | C3 |
| OSD/RWT 2 PLAN & DETAILS | C4 |
| OSD/RWT 3 PLAN & DETAILS | C5 |
| ABSORPTION SYSTEM DETAILS | C6 |
| SPREADER SYSTEM DETAILS | C7 |

DESIGN SUMMARY

NORTHERN BEACH COUNCIL - WARRINGAH DCP
STORMWATER DRAINAGE FROM LOW LEVEL PROPERTIES

SITE AREA = 1114.70 m²
EXISTING IMPERVIOUS AREA = 130.24 m² (12.00%)

THE PROPOSED DEVELOPMENT IS SINGLE DWELLING AND GRANNY FLAT. DUE TO THE SITE IS SLOPED TOWARD THE REAR AND DOWNSTREAM EASEMENT CANNOT BE ACHIEVED, THEREFORE COMBINATION BETWEEN OSD SYSTEM, ABSORPTION SYSTEM AND LEVEL SPREADER HAS BEEN PROPOSED.

SITE DISCHARGE ASSESSMENT BY DRAINS ILSAX MODEL

- MAIN HOUSE ROOF AREA = 135 m² TO RWT 1
- WORKSHOP ROOF AREA = 77.00 m² TO RWT 2
- GRANNY FLAT AREA = 62.00 m² TO RWT 3
- RWT 1 AND RWT 2 CONNECT TO ABSORPTION SYSTEM
- DRIVEWAY & FRONT LANDSCAPE AREA = 670.52 m² TO ABSORPTION SYSTEM
- ABSORPTION SYSTEM HYDRAULIC CONDUCTIVITY K = 4.5x10⁻⁵

| | PRE DEV | POST DEV | | | |
|-----|---------------------------|----------------------------------|-----------------------------|------------------------------|-----------------------------|
| ARI | Q _{PRE} (l/s) | Q _{ABSORPTION} (l/s) | Q _{RWT 3} (l/s) | Q _{BYPASS} (l/s) | Q _{TOTAL} (l/s) |
| 5 | 25 | 0 | 2.0 | 5.0 | 7 |
| 100 | 47 | 11.00 | 2.0 | 10.0 | 23 |

OSD/RWT 1 VOLUME REQUIRED = 1.95m³ AT 1% AEP 14min STORM
OSD/RWT 2 VOLUME REQUIRED = 0.51m³ AT 1% AEP 11min STORM
OSD/RWT 3 VOLUME REQUIRED = 0.57m³ AT 1% AEP 14min STORM
ORIFICE DIAMETER = 50mm

ISSUE FOR APPROVAL



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ABSORPTION SYSTEM
ATLANTIS MATRIX TANK MODULES OR APPROVED EQUAL WRAPPED IN
APPROVED GEOTEXTILE FABRIC AND INSTALLED TO MANUFACTURE'S
SPECIFICATION.


- SURFACE AREA = 25.21m²
- 110 SINGLE MODULES
- MODULES SIZE: 685mm L x 408mm W x 880mm H
- CAPACITY: 233.65L/MODULES
- STORAGE VOLUME = 25.70 m³ MINIMUM

200 WIDE STRIP DRAIN WITH
DEBRIS MESH AT OUTLET

PIT 3 - 450SQR
RL 55.15
IL 54.70

200 WIDE STRIP DRAIN WITH
DEBRIS MESH AT OUTLET

200 WIDE STRIP DRAIN WITH
DEBRIS MESH AT OUTLET

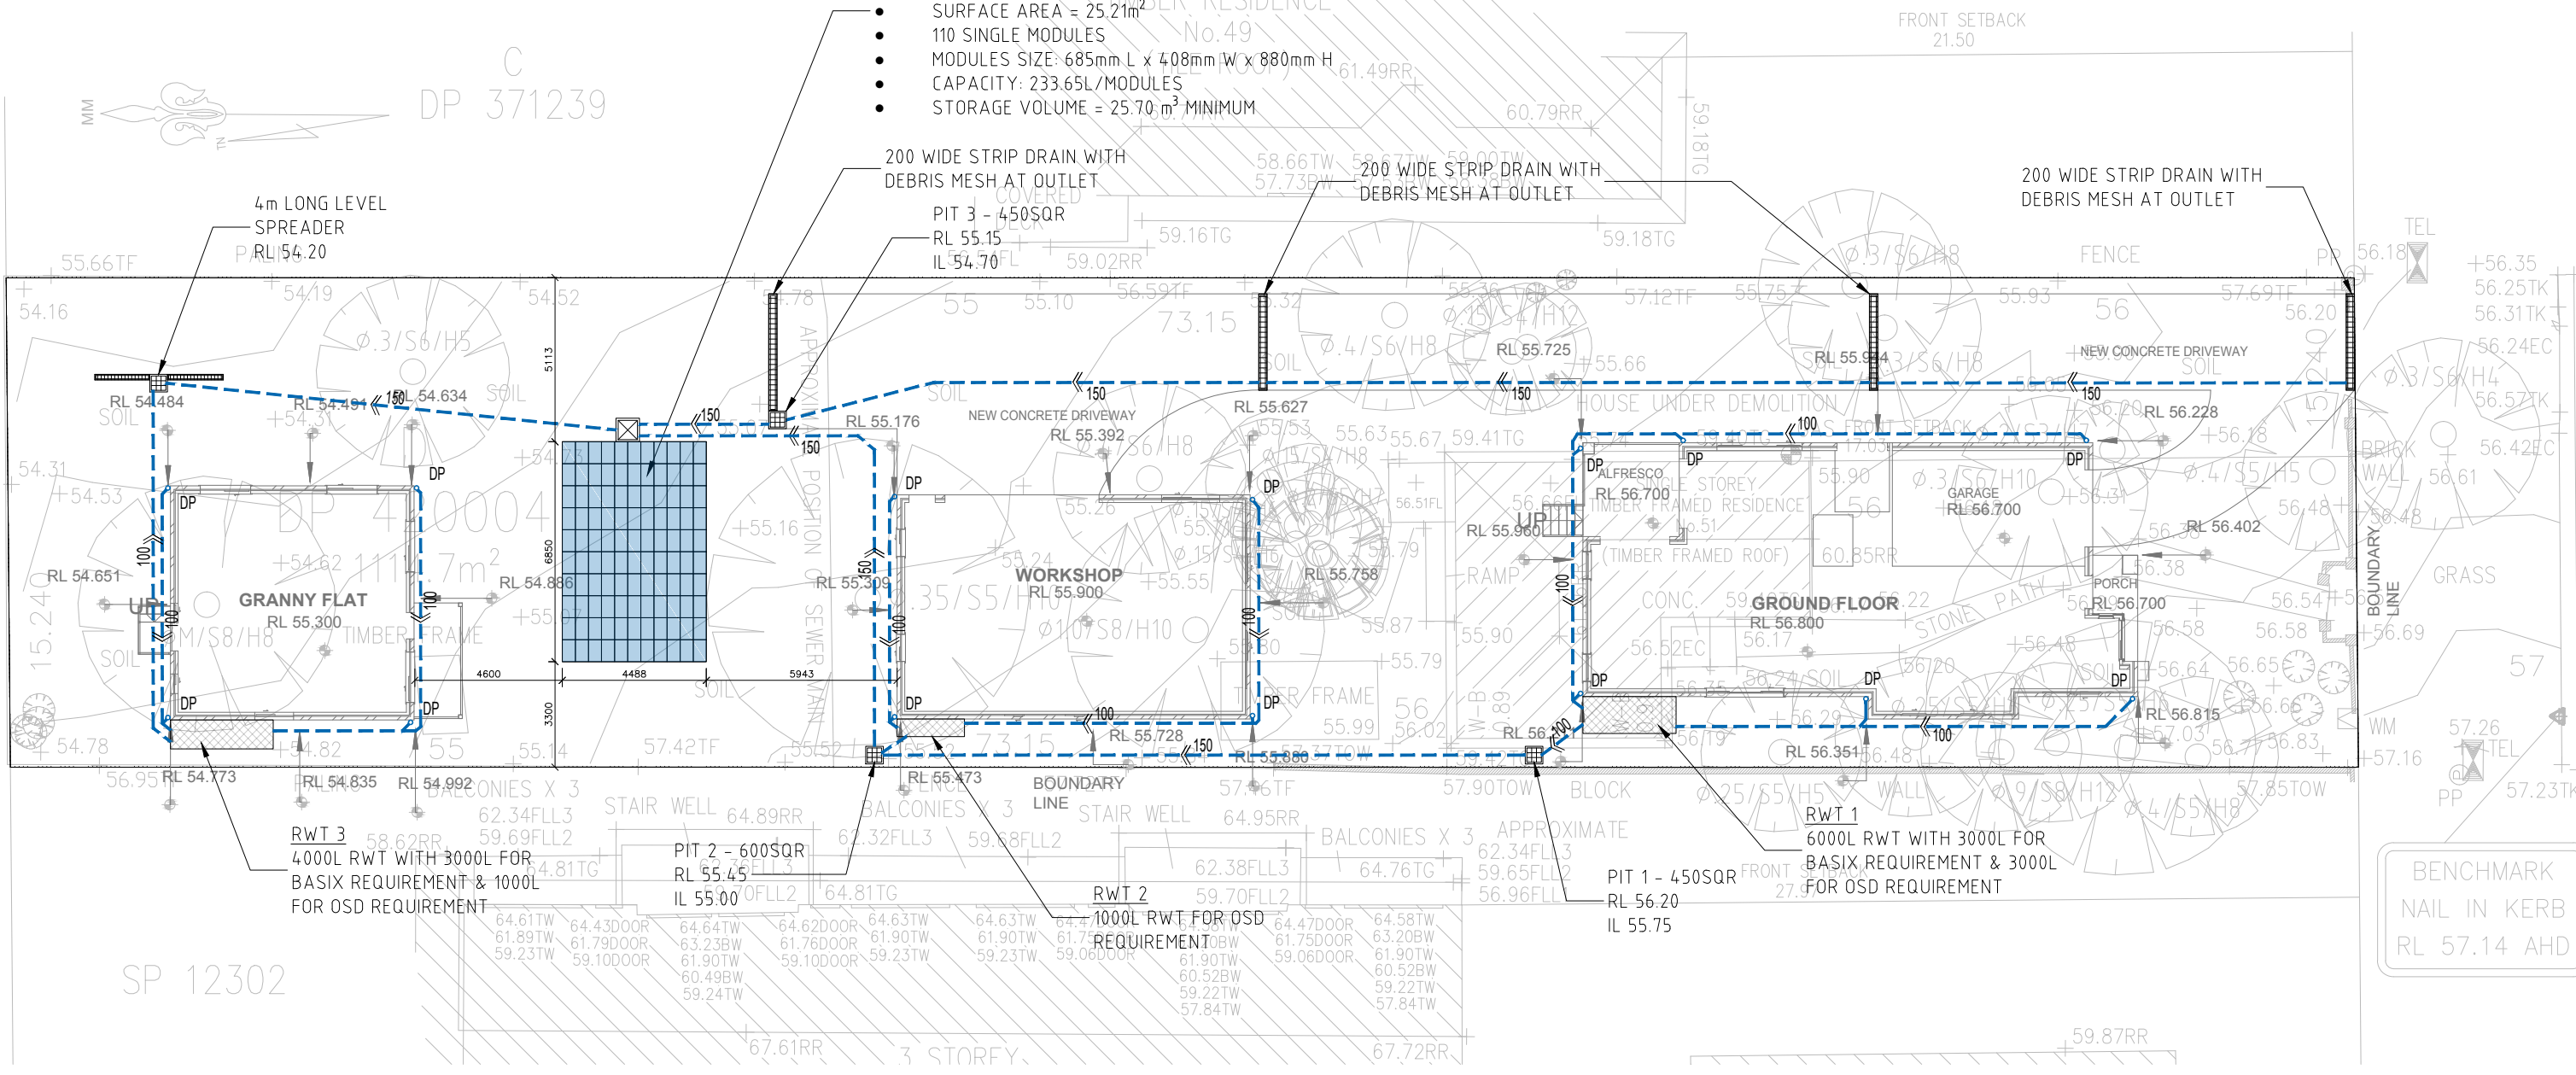

DRAINAGE PLAN
SCALE 1:200

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| ARCH. | | GSD090 - 230250 | | | | | | | | | | | | | |
| STRUCT. | | | | | | | | | | | | | | | |
| MECH. | | | | | | | | | | | | | | | |
| ELEC. | | | | | | | | | | | | | | | |
| HYD. | | | | | | | | | | | | | | | |
| FIRE | | | | | | | | | | | | | | | |
| LANDS | | | | | | | | | | | | | | | |
| CIVIL | | | | | | | | | | | | | | | |
| SURVEY | | | | | | | | | | | | | | | |
| DATE | | DATE | | DATE | | DATE | | DATE | | DATE | | DATE | | DATE | |
| REVISION | | REVISION | | REVISION | | REVISION | | REVISION | | REVISION | | REVISION | | REVISION | |
| ISSUE | | ISSUE | | ISSUE | | ISSUE | | ISSUE | | ISSUE | | ISSUE | | ISSUE | |
| B | | UPDATED ARCHITECTURAL PLAN | | 04.12.2019 | | | | | | | | | | | |
| A | | ISSUED FOR REVIEW | | 08.06.2019 | | | | | | | | | | | |

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UNIT 5.1-3 WHYALLA PLACE, PRESTONS NSW 2170
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MOB: 0419 041 401

| QUALITY CONTROL | |
|-----------------|------------|
| DESIGNED | DATE |
| MD | 04.12.2019 |
| CHECKED | DATE |

APPROVED:

S. NASTASI
B.E., M.I.E., CpEng, Nper-3

CLIENT: WOHL
ARCHITECT: GARDNER HOMES

ADDRESS: 51 REDMAN ROAD, DEE WHY
TITLE: DRAINAGE PLAN

| DRAWING STATUS | | |
|---------------------------|-------------|--------------|
| CONCEPT PLAN FOR APPROVAL | | |
| SCALE (AT ORIGINAL SIZE) | AS NOTED | |
| PROJECT NO. | DRAWING NO. | REVISION NO. |
| 18177 | C2 | B |


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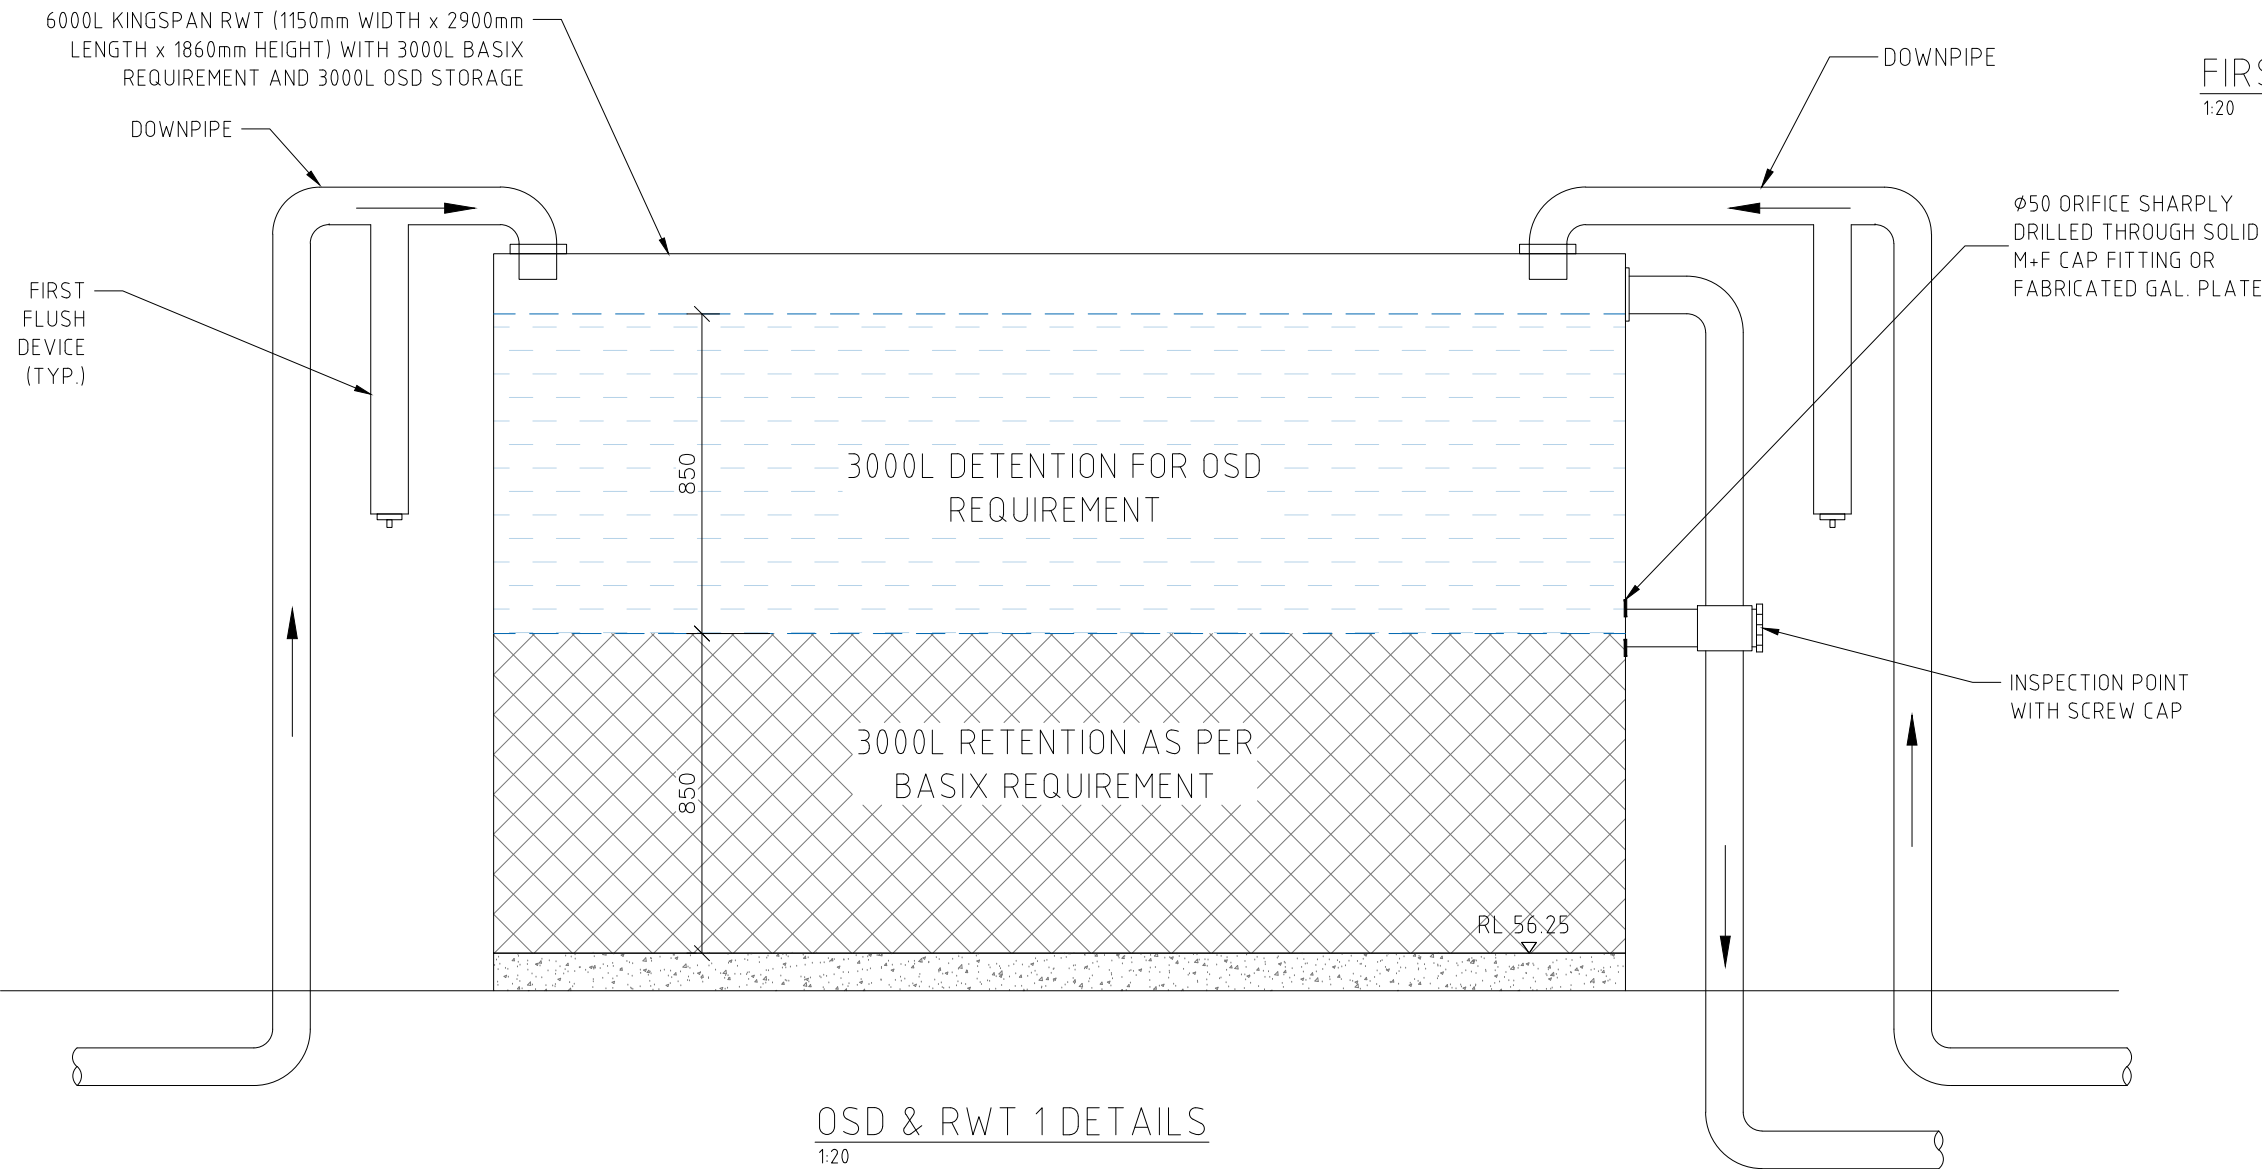
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RAINWATER TANK NOTES:

1. RAINWATER TANKS BY KINGSPAN (TEL: 1300 736 562) OR SIMILAR.
2. DIMENSIONS ARE INDICATIVE ONLY. EXACT DETAILS TO MANUFACTURER'S SPECIFICATIONS.
3. A FIRST FLUSH DEVICE IN ACCORDANCE WITH MANUFACTURER'S SPECIFICATIONS SHALL BE FITTED TO RAINWATER TANK SYSTEM TO FLUSH OUT THE FIRST 0.5mm OF RUN-OFF FROM THE ROOF AREA THAT DRAINED INTO THE TANK (E.G. 0.5L/m²).
4. PUMP SIZE & SPECIFICATION TO BE NOMINATED BY MANUFACTURER
5. ORIFICE PLATE INSTALLATION TO BE PERFORMED BY QUALIFIED PLUMBER AND TO BE MADE WATERTIGHT BY WASHER OR SUITABLE SEALANT.



FIRST FLUSH DEVICE DETAIL
1:20

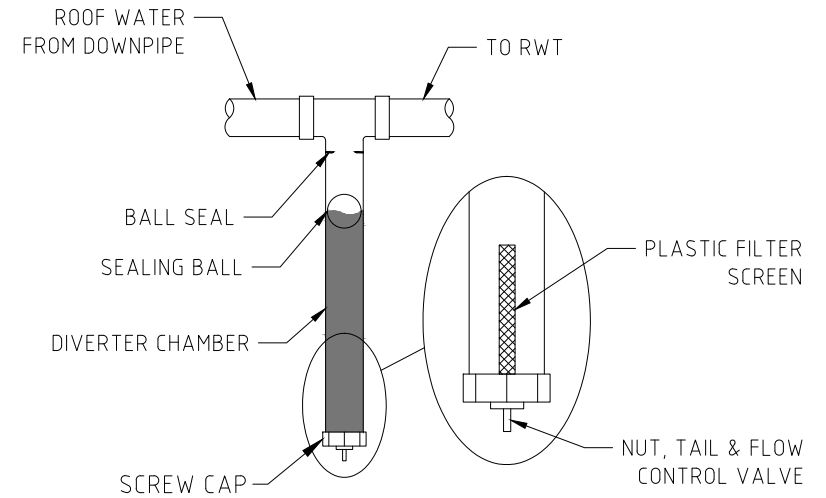

OSD & RWT 1 DETAILS
1:20

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| | | ARCH. | | GUN090 - 230250 | | | | FIRE | | | |
| | | STRUCT. | | | | | | LANDS | | | |
| | | MECH. | | | | | | CIVIL | | | |
| | | ELEC. | | | | | | SURVEY | | | |
| | | HYD. | | | | | | | | | |
| B | UPDATED ARCHITECTURAL PLAN | 04.12.2019 | | | | | | | | | |
| A | ISSUED FOR REVIEW | 08.06.2019 | | | | | | | | | |
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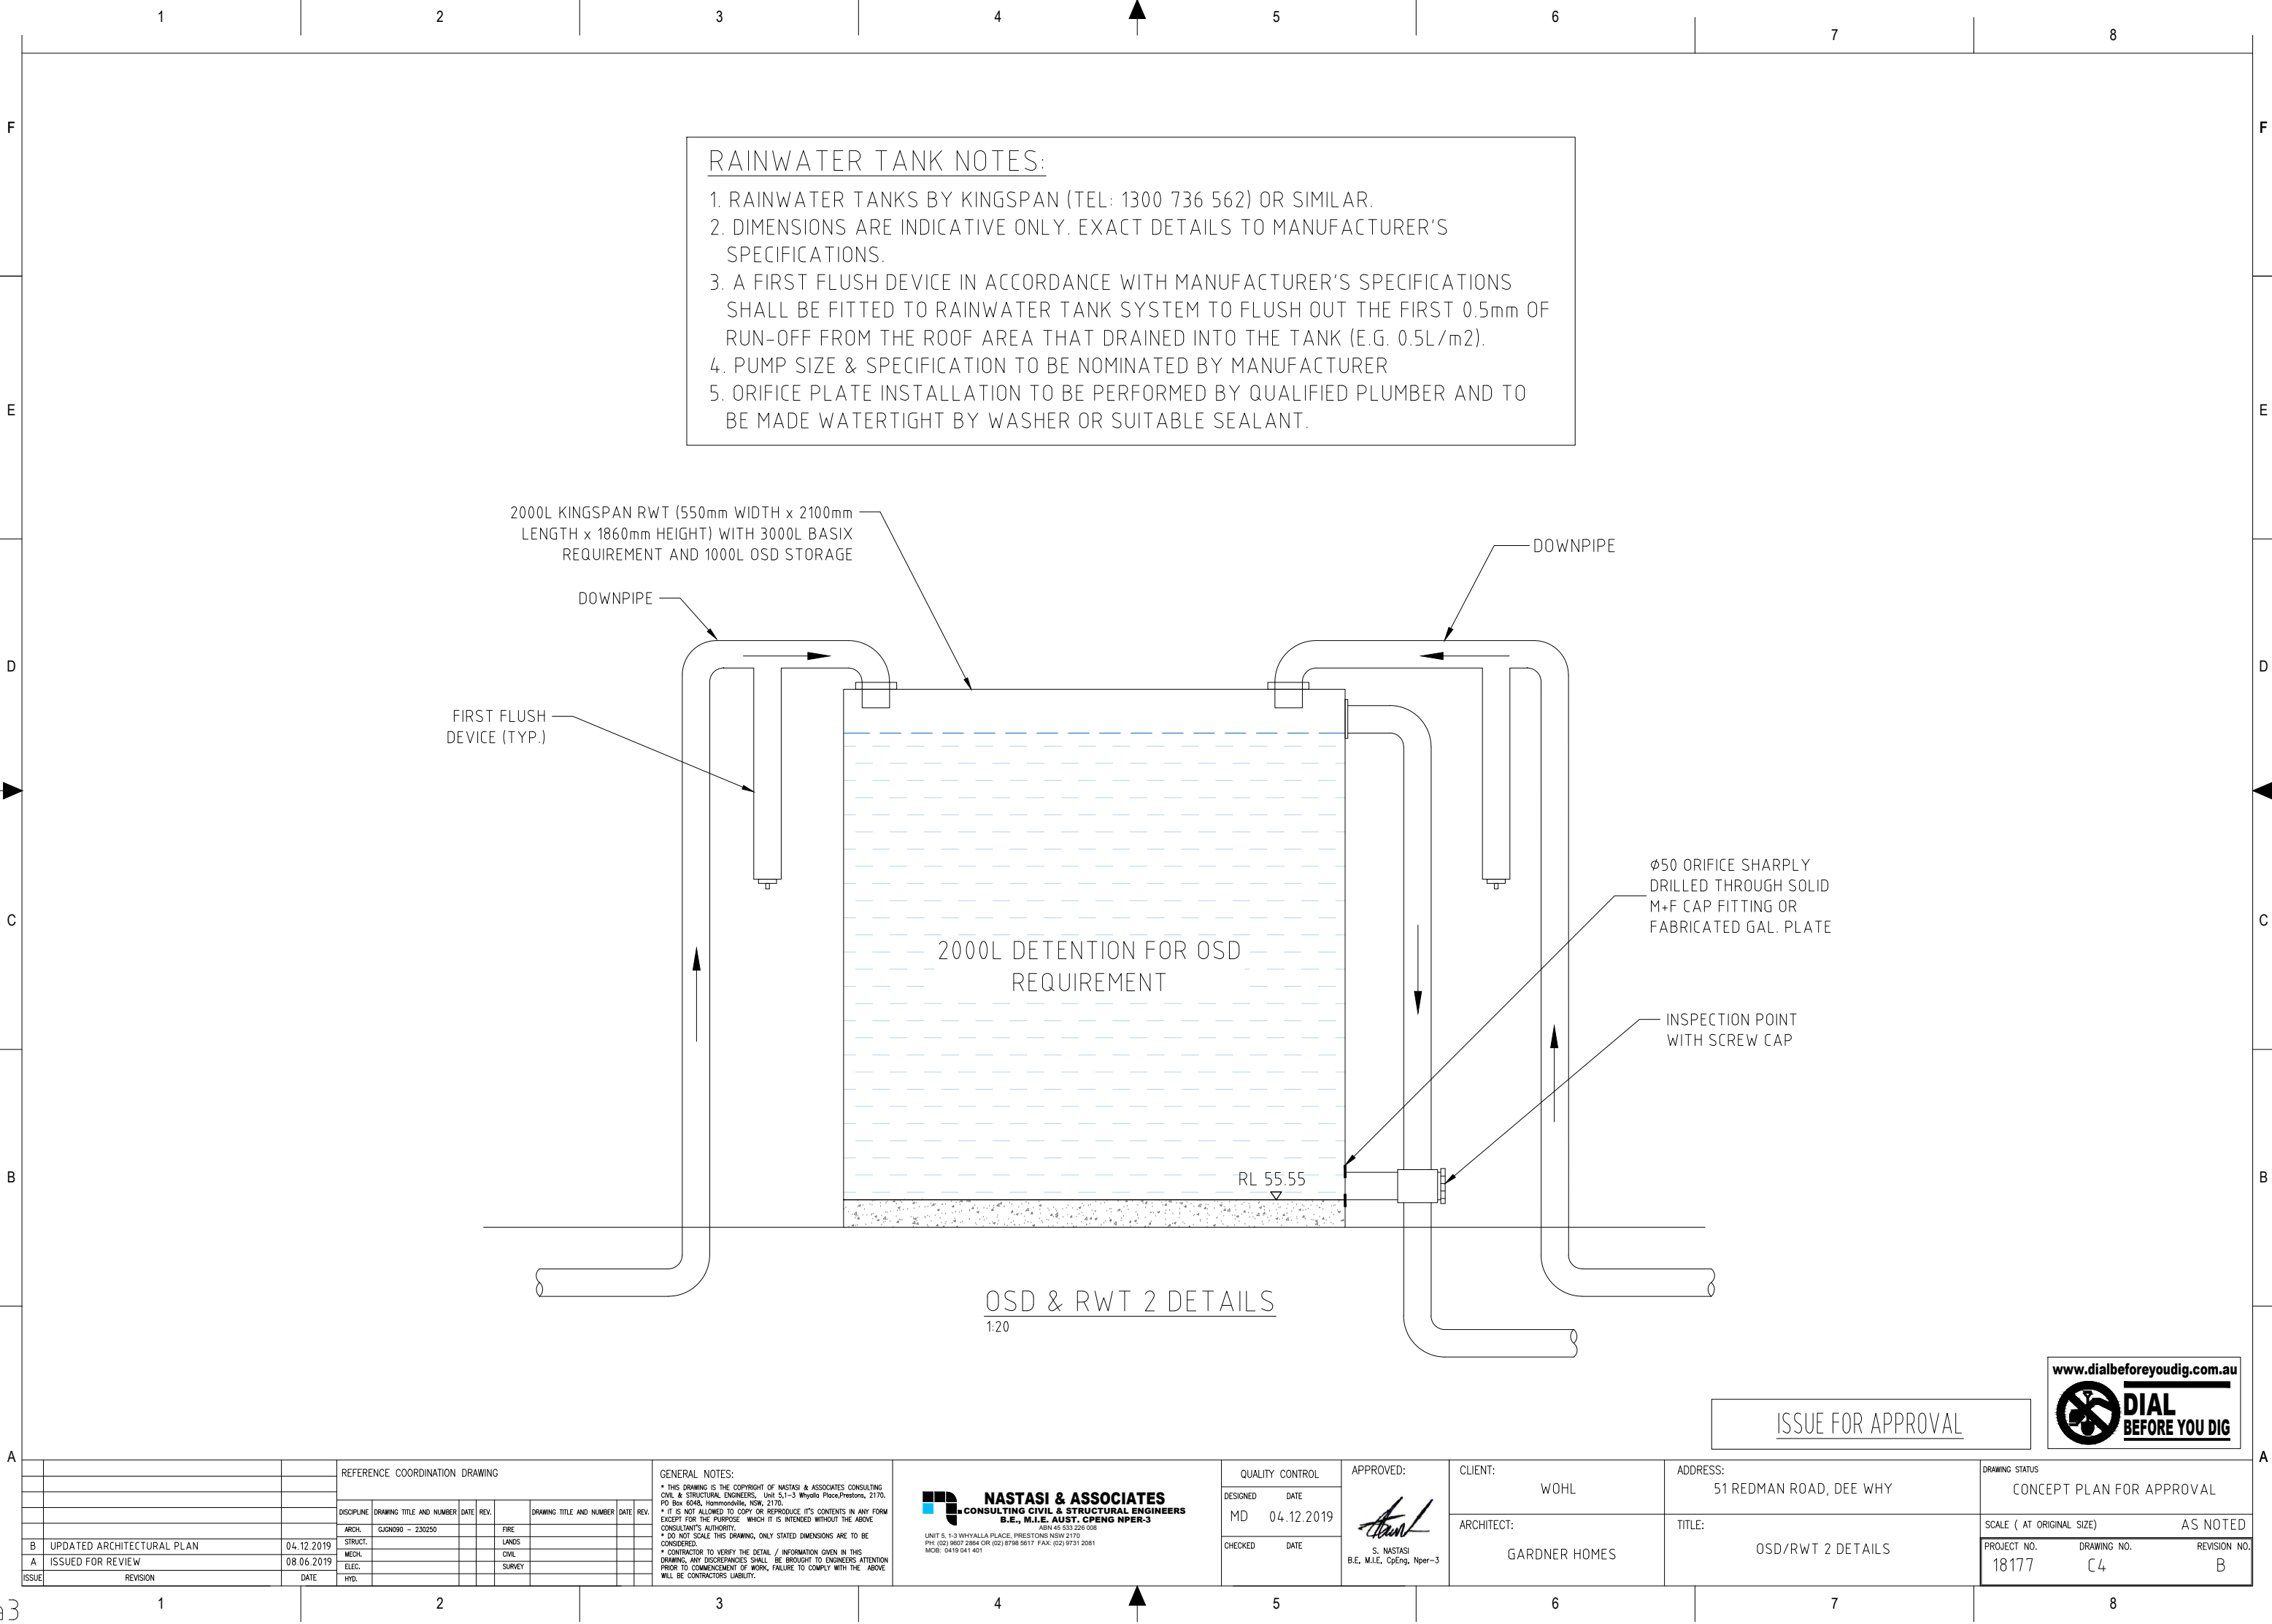
APPROVED:

S. NASTASI
B.E., M.I.E., CpEng, Nper-3

CLIENT:
WOHL
ARCHITECT:
GARDNER HOMES

ADDRESS:
51 REDMAN ROAD, DEE WHY
TITLE:
OSD/RWT 1 DETAILS

| DRAWING STATUS | | |
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| SCALE (AT ORIGINAL SIZE) | | AS NOTED |
| PROJECT NO. | DRAWING NO. | REVISION NO. |
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


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OSD & RWT 2 DETAILS
1:20


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| B | UPDATED ARCHITECTURAL PLAN | 04.12.2019 | DISCIPLINE | | DRAWING TITLE AND NUMBER | DATE | REV. | | DRAWING TITLE AND NUMBER | DATE | REV. | | | | | | | | | | | | | | |
| A | ISSUED FOR REVIEW | 08.06.2019 | ARCH. | GJGN090 - 230250 | | | | FIRE | | | | | | | | | | | | 18177 | | C4 | | B | |
| | | | STRUCT. | | | | | LANDS | | | | | | | | | | | | | | | | | |
| | | | MECH. | | | | | CIVIL | | | | | | | | | | | | | | | | | |
| | | | ELEC. | | | | | SURVEY | | | | | | | | | | | | | | | | | |
| | | | HYD. | | | | | | | | | | | | | | | | | | | | | | |

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| REFERENCE COORDINATION DRAWING | | DISCIPLINE | | DRAWING TITLE AND NUMBER | | DATE | REV. | DRAWING TITLE AND NUMBER | | DATE | REV. |
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| | | ARCH. | | GUN090 - 230250 | | | | FIRE | | | |
| B | | STRUC. | | | | 04.12.2019 | | LANDS | | | |
| A | | MECH. | | | | 08.06.2019 | | CIVIL | | | |
| | | ELEC. | | | | | | SURVEY | | | |
| | | HYD. | | | | | | | | | |

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B.E., M.I.E. AUST. CPENG NPER-3


UNIT 5, 1-3 WHYALLA PLACE, PRESTONS NSW 2170
PH: (02) 9607 2864 OR (02) 8798 5517 FAX: (02) 9751 2081
MOB: 0419 041 401

QUALITY CONTROL

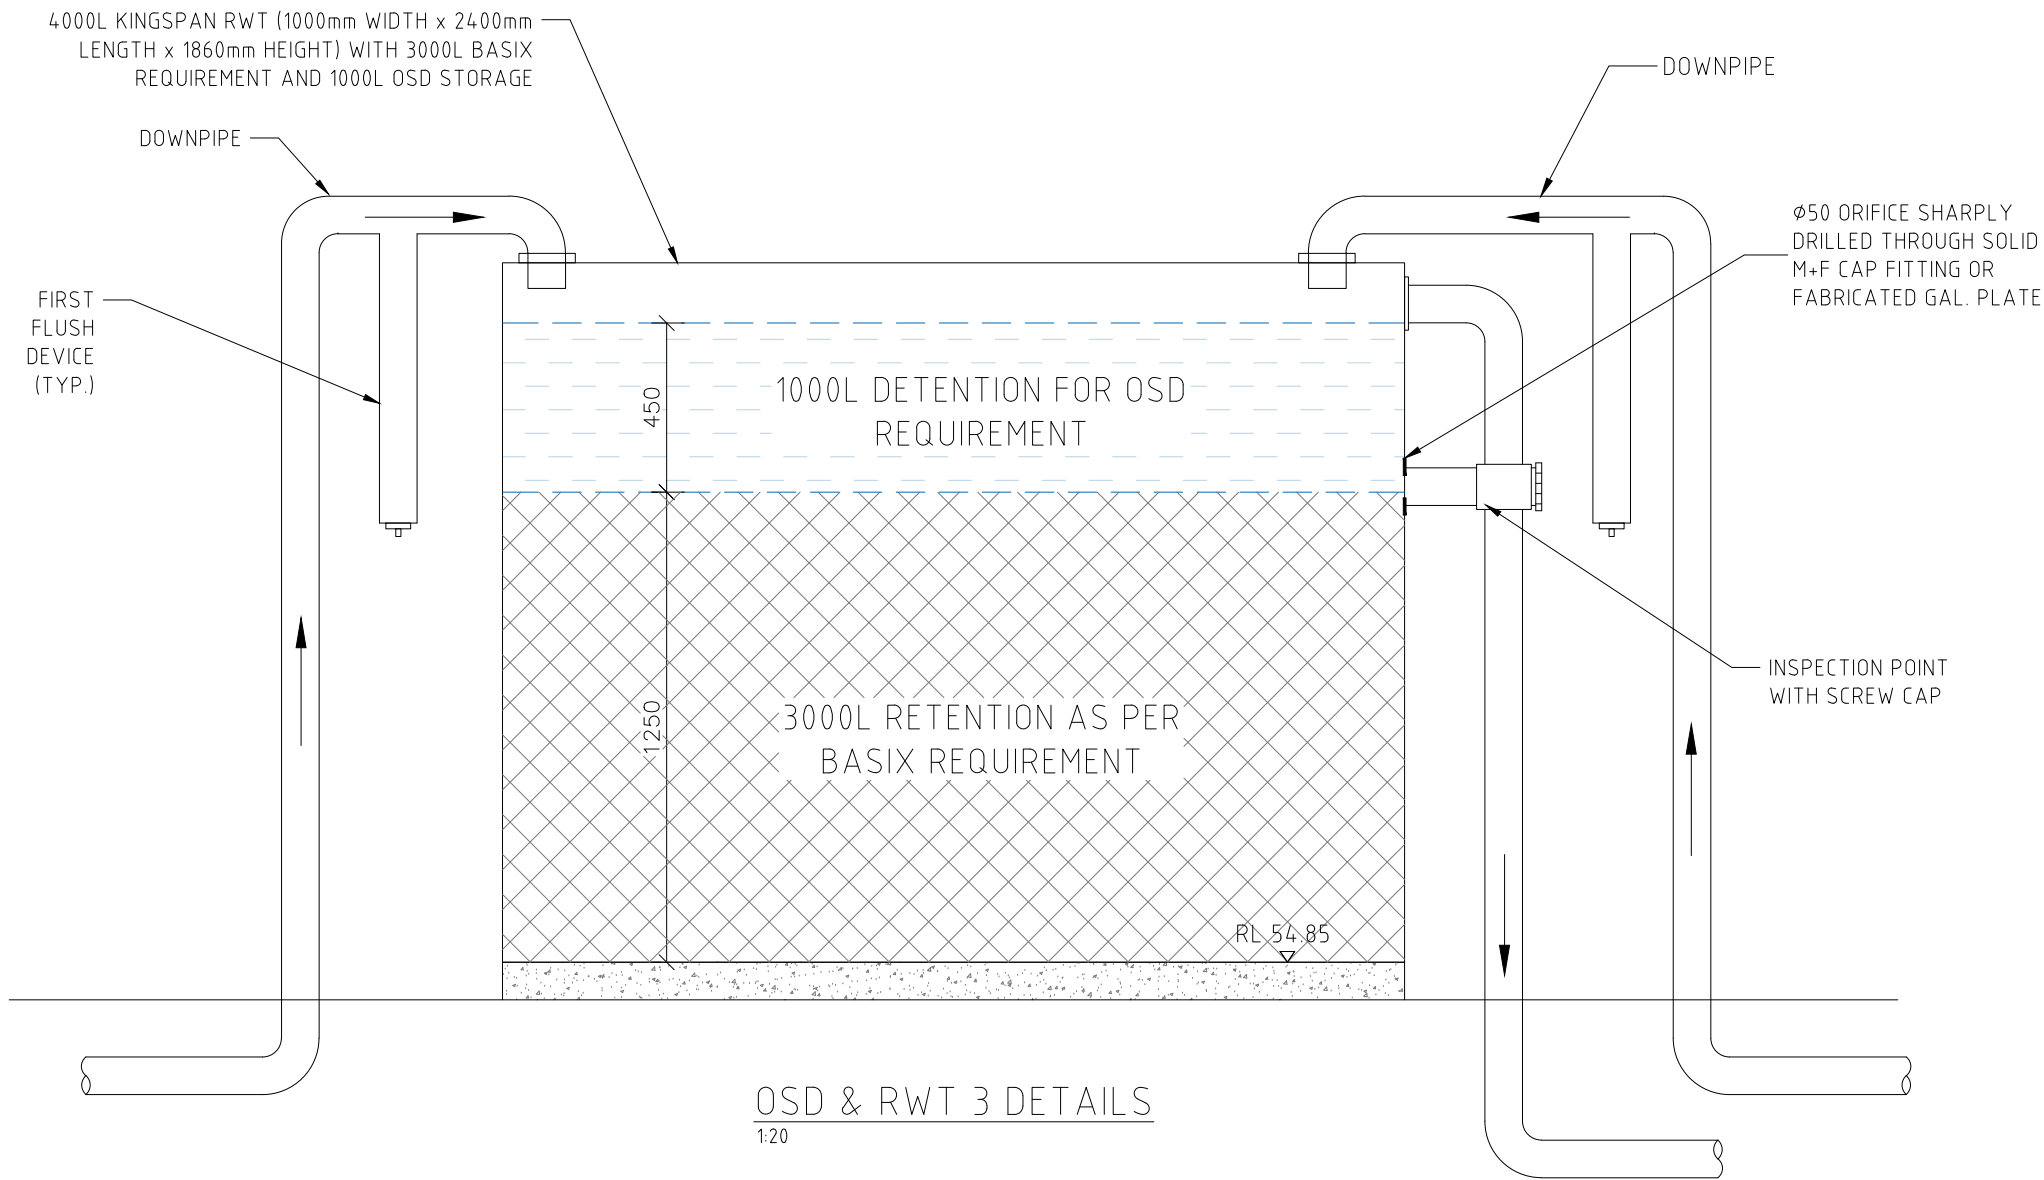DESIGNED DATE
MD 04.12.2019

CHECKED DATE

APPROVED:


S. NASTASI
B.E., M.I.E., CpEng, Nper-3

CLIENT:

WOHL

ARCHITECT:

GARDNER HOMES

ADDRESS:

51 REDMAN ROAD, DEE WHY

TITLE:

OSD/RWT 3 DETAILS

DRAWING STATUS

CONCEPT PLAN FOR APPROVAL

SCALE (AT ORIGINAL SIZE)

AS NOTED

PROJECT NO.





18177

DRAWING NO.

C5


REVISION NO.

B

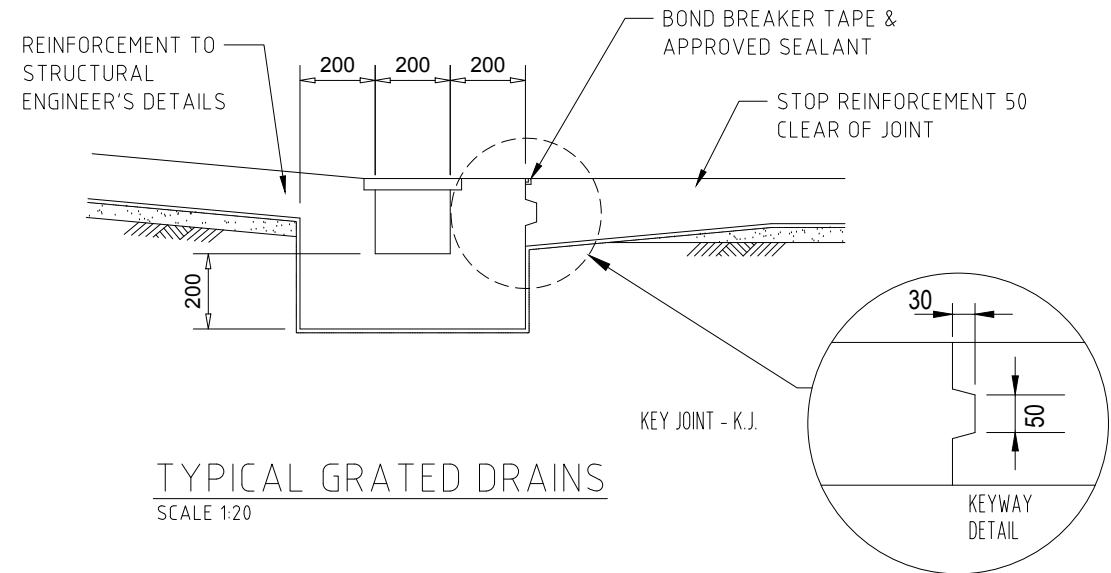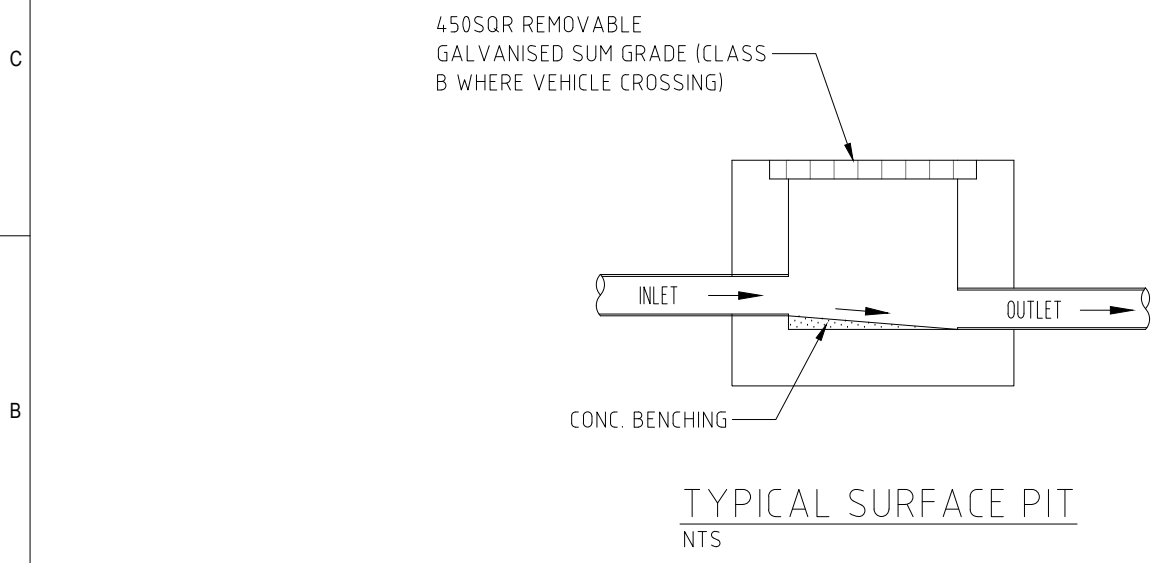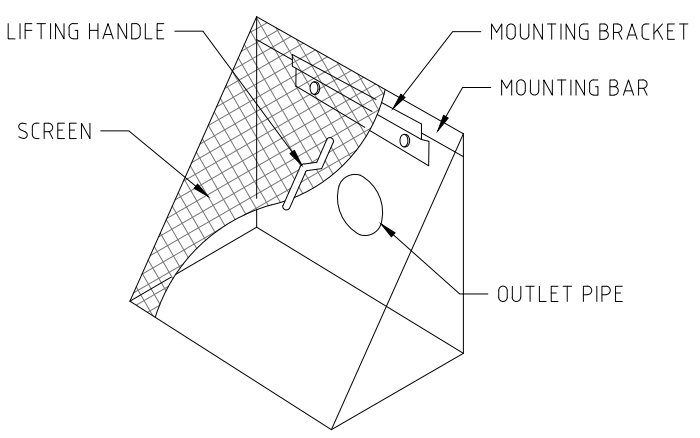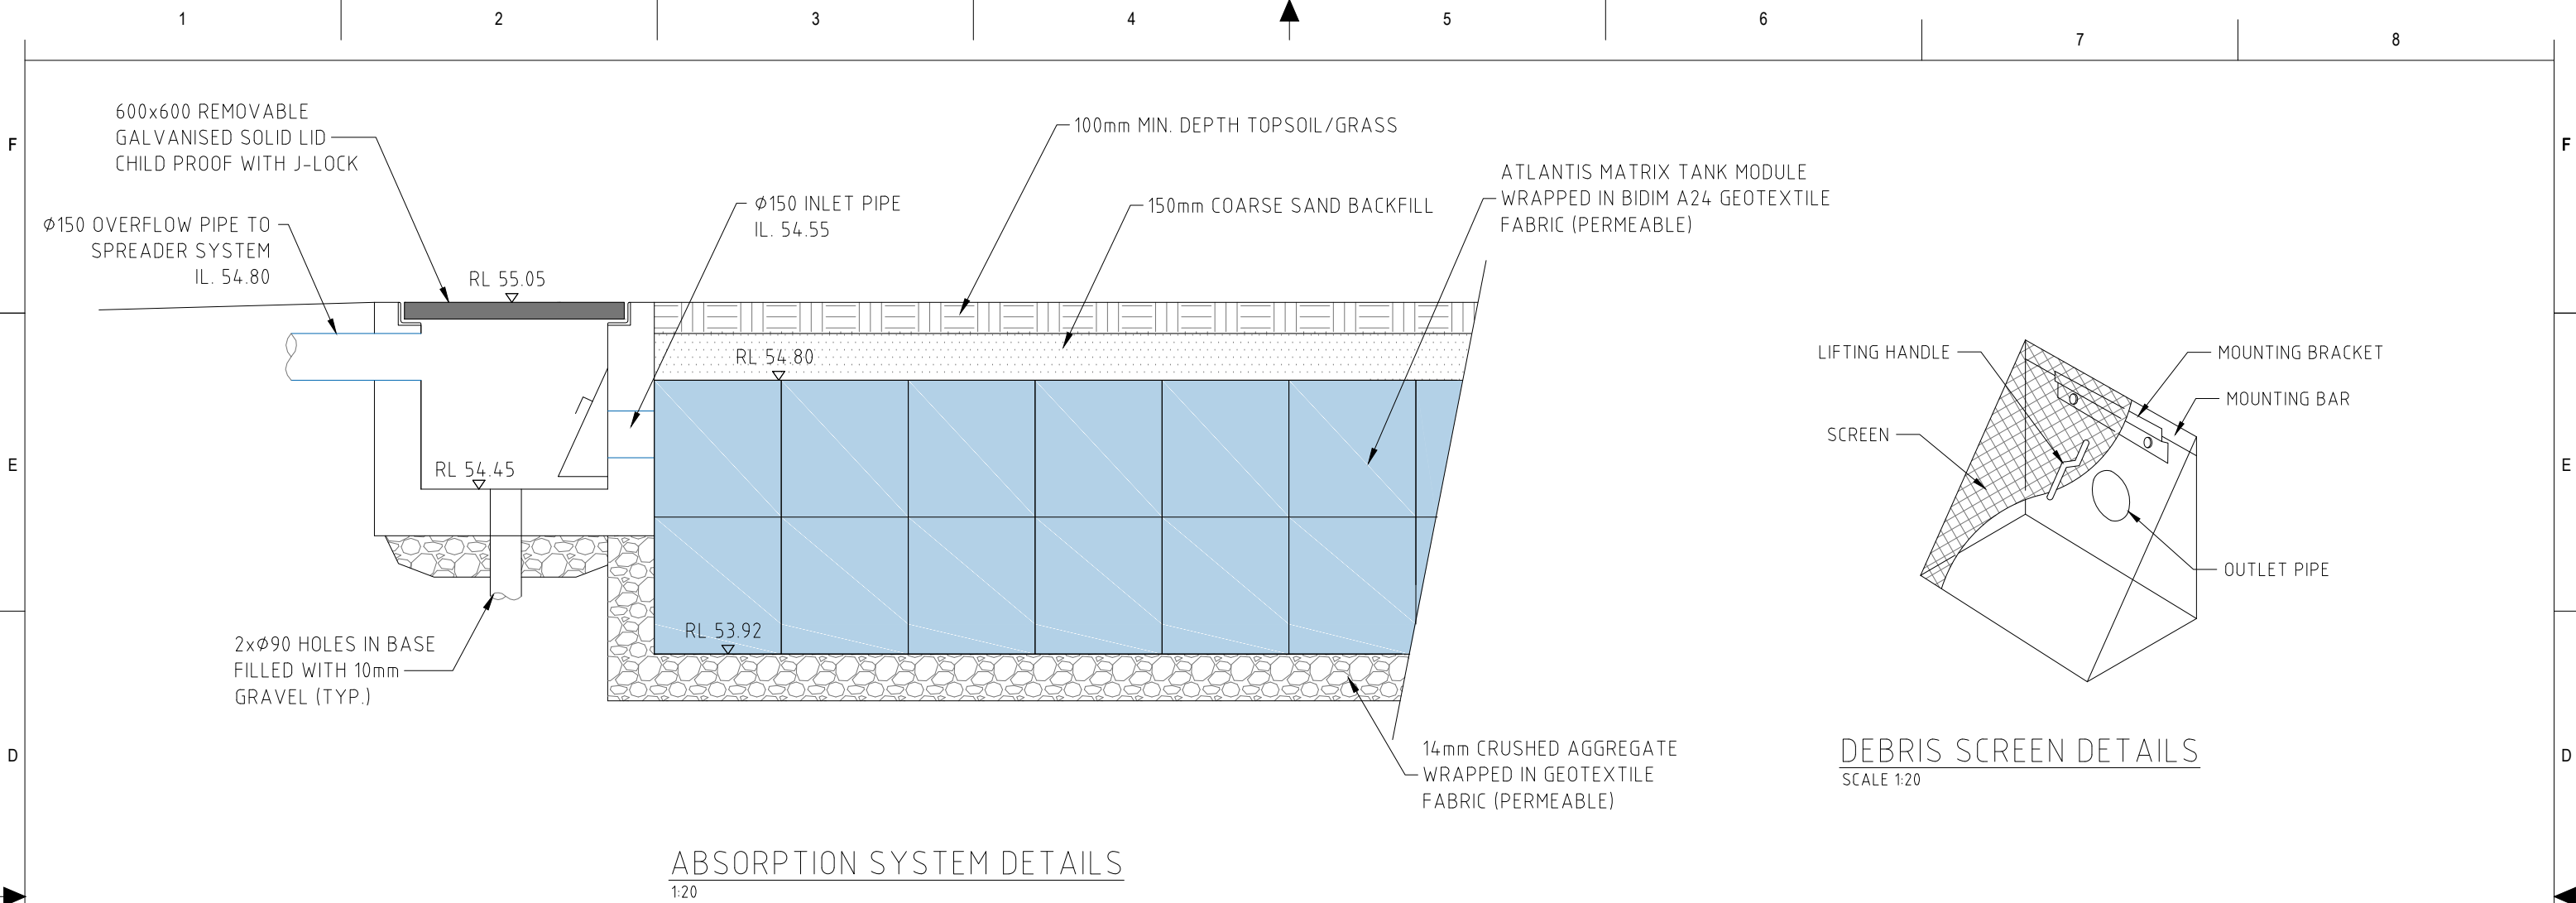


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| | | REFERENCE COORDINATION DRAWING | | | | | | GENERAL NOTES: | | QUALITY CONTROL | | APPROVED: | | CLIENT: | | ADDRESS: | | DRAWING STATUS | |
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| | | | | | | | | * IT IS NOT ALLOWED TO COPY OR REPRODUCE ITS CONTENTS IN ANY FORM EXCEPT FOR THE PURPOSE WHICH IT IS INTENDED WITHOUT THE ABOVE CONSULTANT'S AUTHORITY. | | MD | | | | | | | | | |
| | | | | | | | | * DO NOT SCALE THIS DRAWING. ONLY STATED DIMENSIONS ARE TO BE CONSIDERED. | | CHECKED | | DATE | | ARCHITECT: | | TITLE: | | SCALE (AT ORIGINAL SIZE) | |
| B | | UPDATED ARCHITECTURAL PLAN | | | | | | * CONTRACTOR TO VERIFY THE DETAIL / INFORMATION GIVEN IN THIS DRAWING. ANY DISCREPANCIES SHALL BE BROUGHT TO ENGINEERS ATTENTION PRIOR TO COMMENCEMENT OF WORK. FAILURE TO COMPLY WITH THE ABOVE WILL BE CONTRACTORS LIABILITY. | | | | S. NASTASI | | GARDNER HOMES | | ABSORPTION SYSTEM DETAILS | | AS NOTED | |
| A | | ISSUED FOR REVIEW | | | | | | | | | | B.E., M.I.E., CpEng, Nper-3 | | | | | | PROJECT NO. | |
| | | | | | | | | | | | | | | | | | | DRAWING NO. | |
| | | | | | | | | | | | | | | | | | | REVISION NO. | |
| | | | | | | | | | | | | | | | | | | 18177 | |
| | | | | | | | | | | | | | | | | | | C6 | |
| | | | | | | | | | | | | | | | | | | B | |



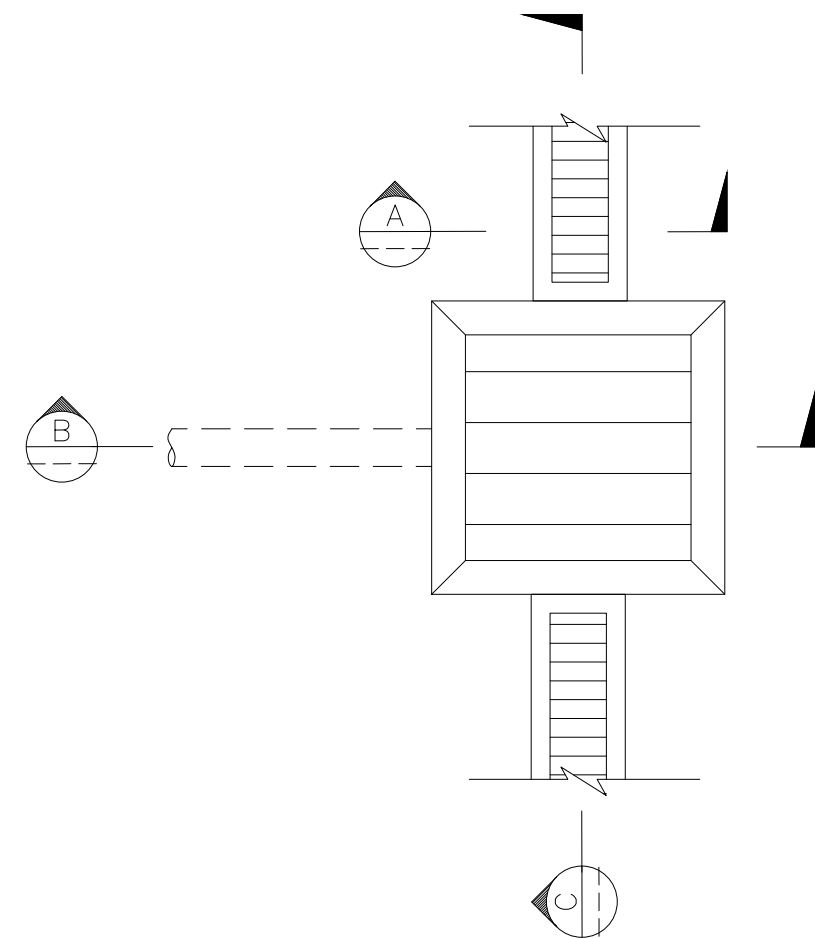

SPREADER SYSTEM PLAN

SCALE 1:20

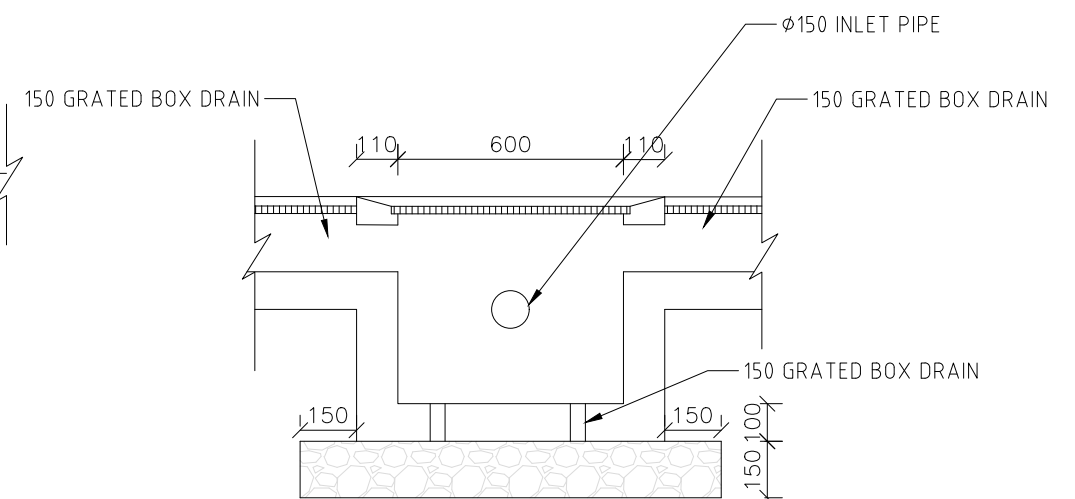

SECTION C

SCALE 1:20

| | | | | | | | | | | | |
|--|--|--------------------------------|--|--|--|--|--|----------------|--|---|--|
| | | REFERENCE COORDINATION DRAWING | | | | | | GENERAL NOTES: | | <div><div></div><div><div><div></div><div></div></div><div><div></div><div></div></div><div><div></div><div></div></div></div><div><div><div></div><div></div></div><div><div></div><div></div></div><div><div></div><div></div></div></div><div><div><div></div><div></div></div><div><div></div><div></div></div><div><div></div><div></div></div></div></div> <div><div><div></div><div></div></div><div><div></div><div></div></div><div><div></div><div></div></div></div> <div><div><div></div><div></div></div><div><div></div><div></div></div><div><div></div><div></div></div></div> <div><div><div></div><div></div></div><div><div></div><div></div></div><div><div></div><div></div></div></div> <div><div><div></div><div></div></div><div><div></div><div></div></div><div><div></div><div></div></div></div> <div><div><div></div><div></div></div><div><div></div><div></div></div><div><div></div><div></div></div></div> 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