DEVELOPMENT APPLICATION

12 CAPUA PLACE - AVALON











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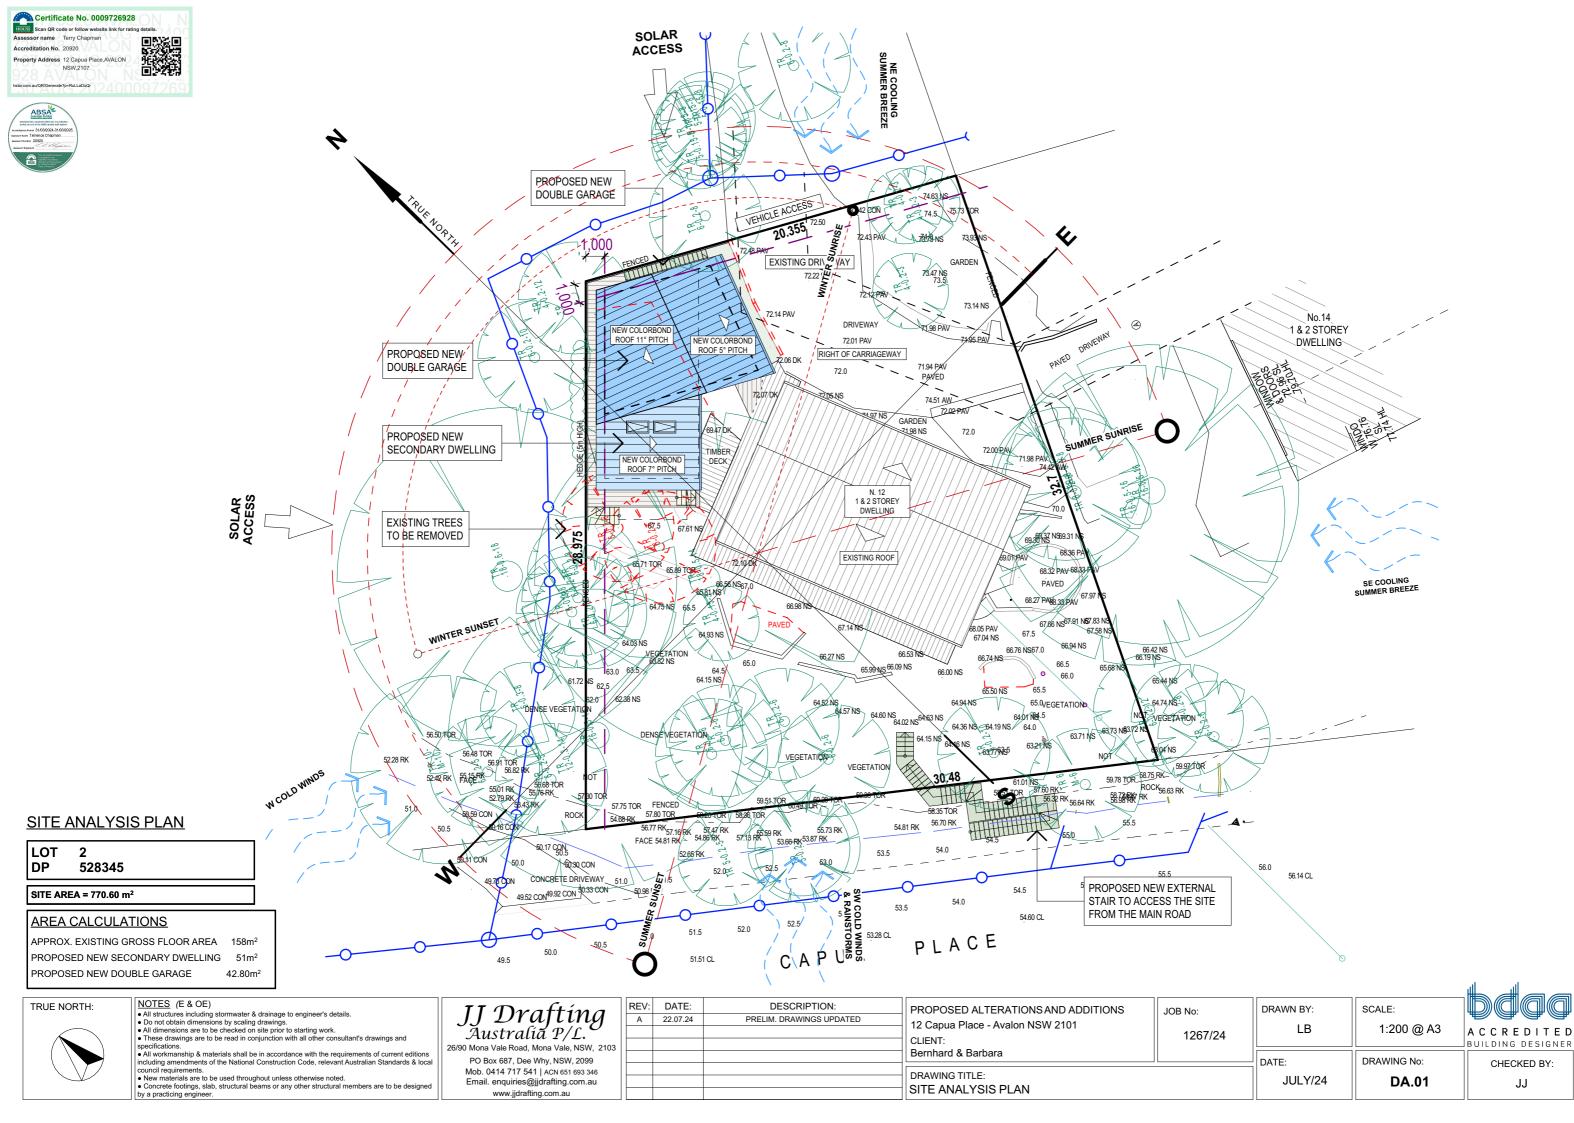
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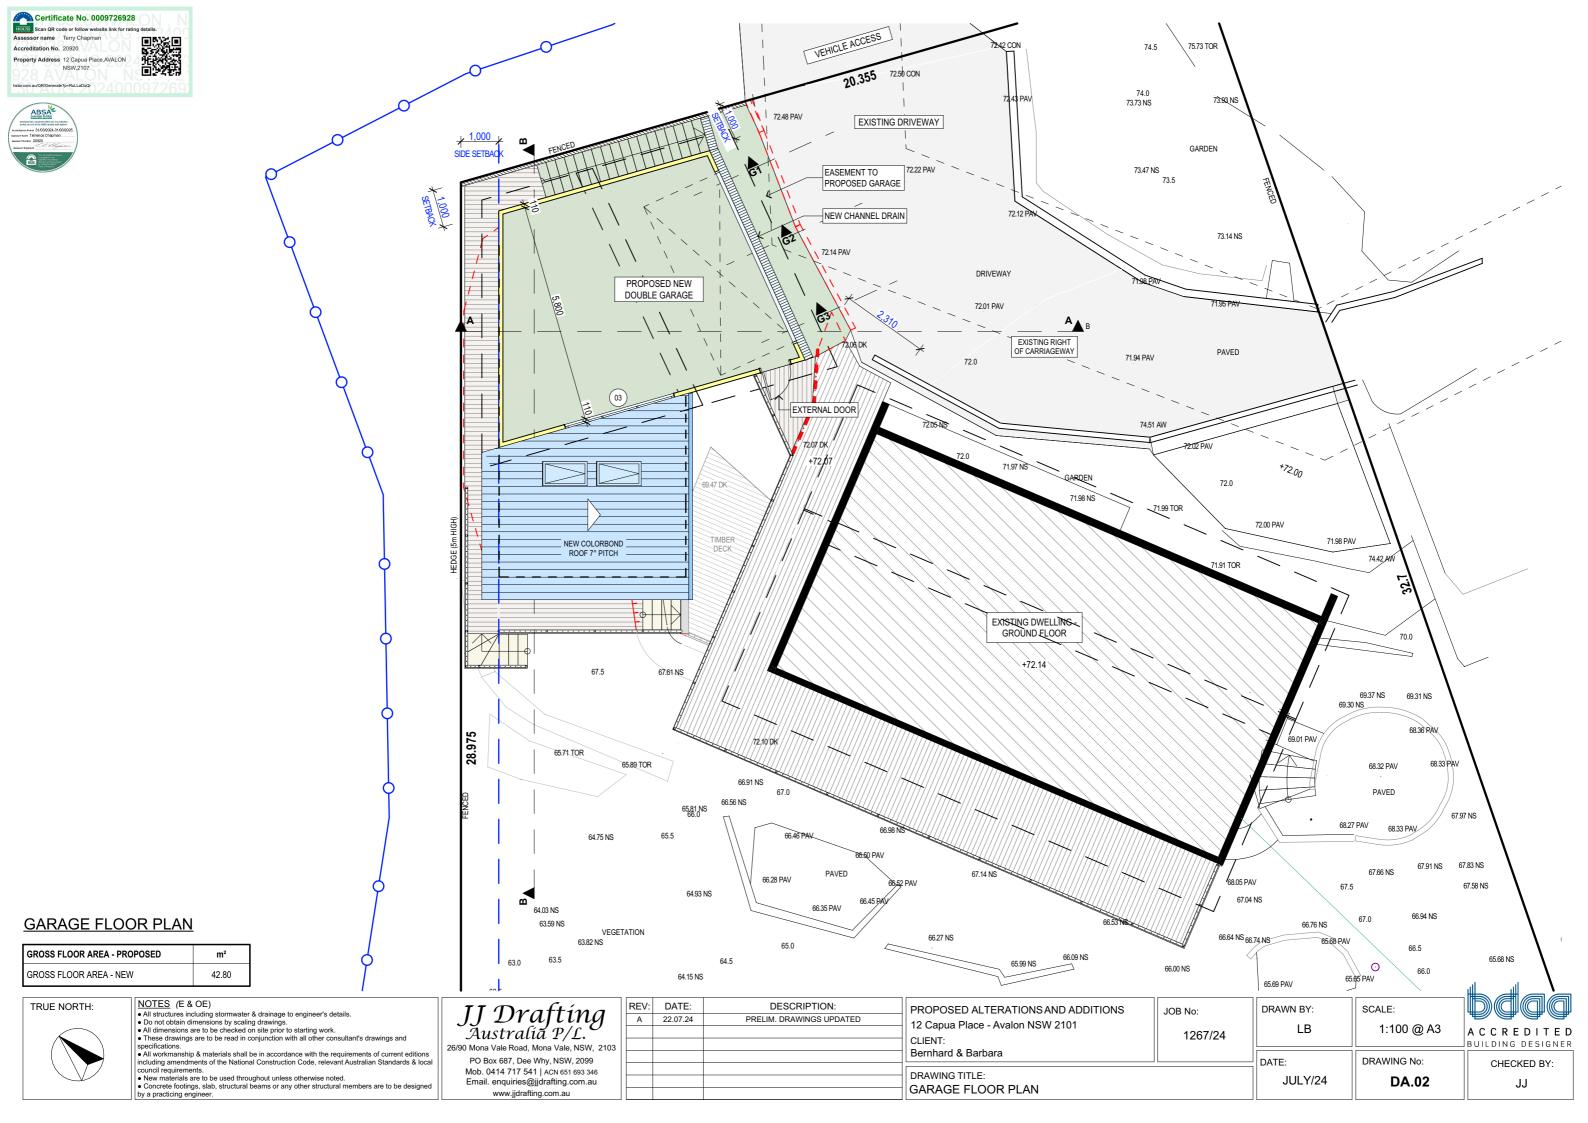
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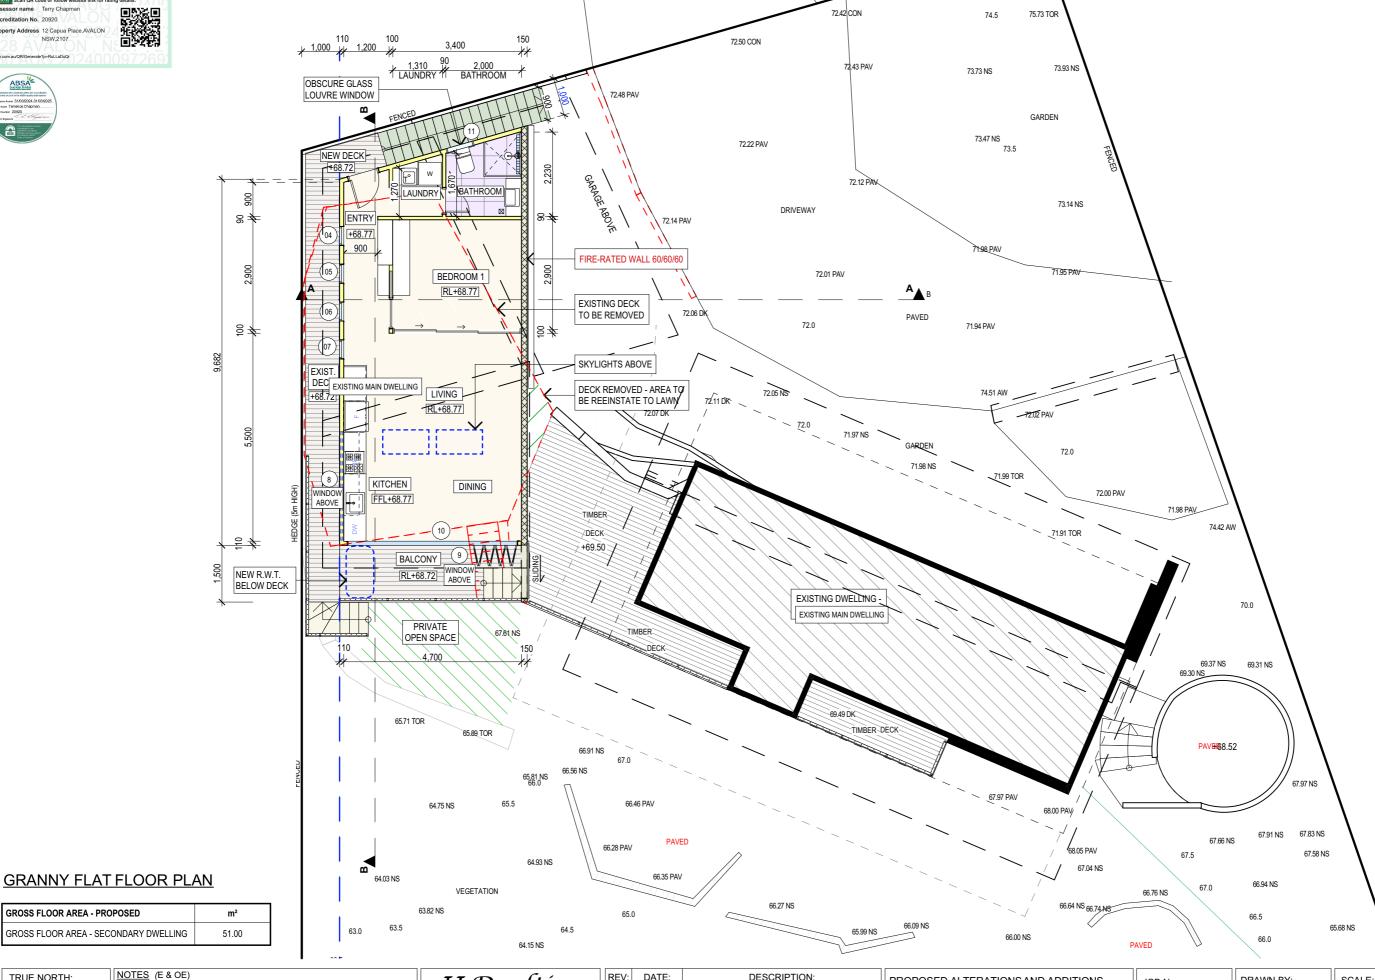


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GROSS FLOOR AREA - PROPOSED

GROSS FLOOR AREA - SECONDARY DWELLING

NOTES (E & OE)

All structures including stormwater & drainage to engineer's details
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- . These drawings are to be read in conjunction with all other consultant's drawings and

- New materials are to be used throughout unless otherwise noted.
 Concrete footings, slab, structural beams or any other structural members are to be designed. by a practicing engineer.

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PROPOSED ALTERATIONS AND ADDITIONS	
12 Capua Place - Avalon NSW 2101	
CLIENT:	
Bernhard & Barbara	
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SECONDARY DWELLING FLOOR PLAN


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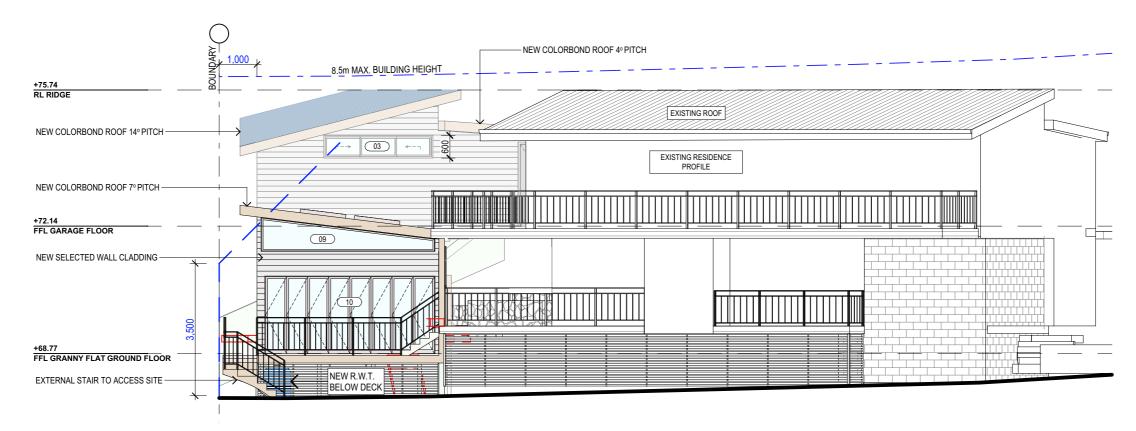
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1267/24	LB
	DATE:

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PROPOSED NEW SECONDARY DEWLLING

SOUTH ELEVATION

- NOTES (E & OE)

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- by a practicing engineer.
- ▼All workinariship a materials shall be in accordance with the legitlements of correct equions including amendments of the National Construction Code, relevant Australian Standards & local council requirements.
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PROPOSED ALTERATIONS AND ADDITIONS 12 Capua Place - Avalon NSW 2101	
CLIENT: Bernhard & Barbara	

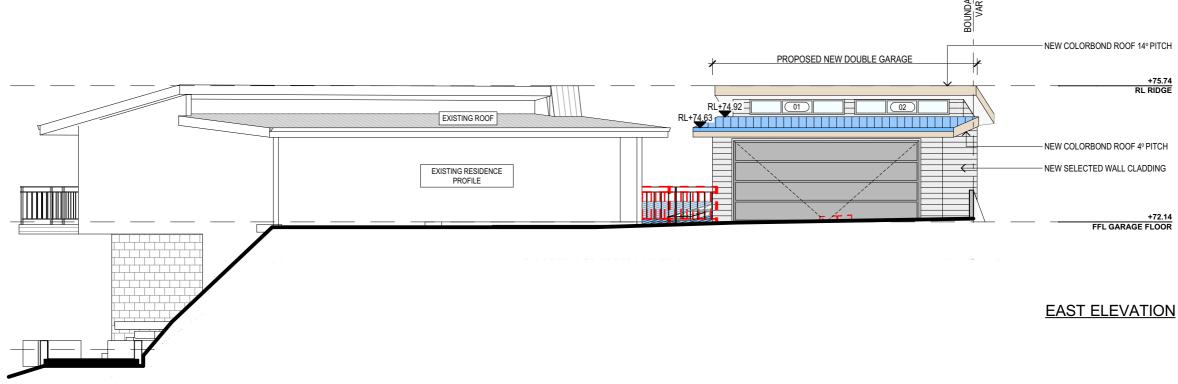DRAWING TITLE:

EAST AND SOUTH ELEVATIONS

DRAWN BY: JOB No: LB 1267/24 DATE:

JULY/24


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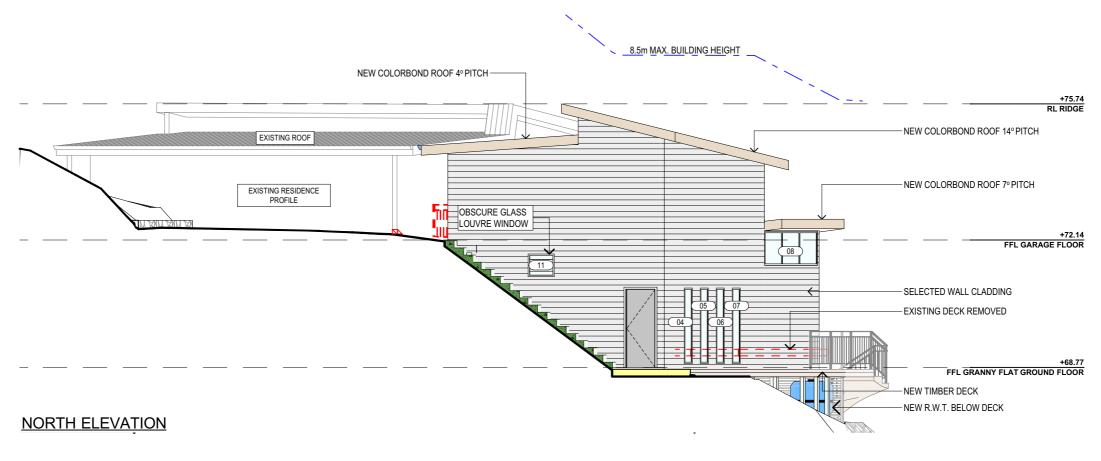
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DA.04





WEST ELEVATION

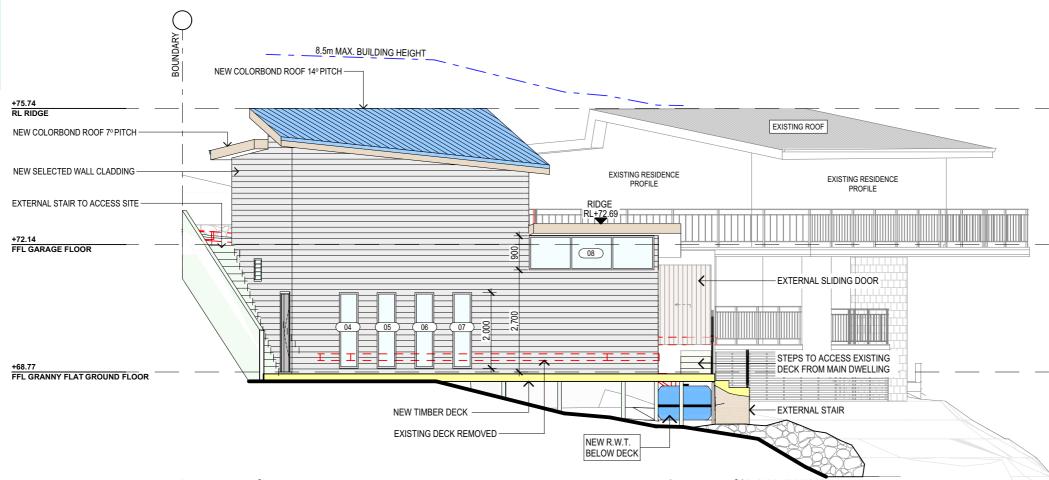

- NOTES (E & OE)

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DRAWING TITLE: WEST AND NORTH ELEVATIONS		

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LB		A C C R E D I T E D
DATE:	DRAWING No:	CHECKED BY:

HECKED BY: JULY/24 **DA.05** JJ

SPECIFICATION NOTES

PROVIDE PLASTERBOARD LINING

- INSTALL TO MANUFACTURERS SPECIFICATIONS & AS 2589

BRICK VENEER WALLS WITH SELECTED BRICKS TO DWELLING.

- ALL EXTERNAL WALL CLADDINGS MUST BE COMPLIANT WITH THE REQUIREMENTS OF NCC 2022 - ABCB HOUSING PROVISIONS PART 7, AS1684 AND ALL RELEVANT CODEMARK

- ROOF AND WALL CLADDING INSTALLATION TO NCC 2022 H1D7 & AS 1562 DESIGN AND INSTALLATION OF SHEET ROOF AND WALL CLADDING.

CONDENSATION MANAGEMENT:
- CONDENSATION MANAGEMENT MUST BE ADHERED TO IN ACCORDANCE WITH NCC 2022 -HOUSING PROVISIONS PART 10.8.

FLOOR:
- GROUND FLOOR TO BE REINFORCED CONCRETE SLAB IN ACCORDANCE WITH AS2870. - FIRST FLOOR TO BE TIMBER FRAMED FINISHED WITH T&G HARDWOOD FLOORING.

- ALL WATERPROOFING TO NCC 2022 - ABCB HOUSING PROVISIONS PART 10, AS3740 AND PROVIDE A GUARANTEED FLEXIBLE WATERPROOF MEMBRANE TO ALL WET AREA FLOORS & SHOWER WALLS TO MANUFACTURED SPECIFICATIONS AND INSTALLATION

WATERPROOF INSTALLATION NCC (2022): HOUSING PROVISIONS PART 10, AS 3740 WATERPROOFING OF DOMESTIC WET AREAS (INTERNAL) & AS 4654 WATERPROOF MEMBRANES FOR EXTERNAL USE.

BEARERS AND JOISTS:
- SHALL BE INSTALLED TO COMPLY WITH AS1684 AS AMENDED FOR TIMBER COMPONENTS OR AS3620 FOR LIGHTWEIGHT STEEL FRAMING SECTIONS OR AS PER THE NASH

- SHALL BE INSTALLED IN ACCORDANCE WITH AS3660.

PROFILED STEEL ROOF:
- COLORBOND ROOF CLADDING

- METAL ROOF DESIGN AND INSTALLATION SHALL BE IN ACCORDANCE WITH NCC 2022 -ABCB HOUSING PROVISIONS PART 7, AS 1562.

ROOF TILES OR SHINGLES:

- NCC 2022 -ABCB HOUSING PROVISIONS PART 7.3.

SHALL BE IN ACCORDANCE WITH NCC 2022 - ABCB HOUSING PROVISIONS PART 4.2.10. - ALL WORKMANSHIP AND MATERIALS SHALL BE IN ACCORDANCE WITH CURRENT EDITIONS

BRICK AND BLOCKWORK:
- MASONRY STRUCTURES TO NCC 2022 - ABCB HOUSING PROVISIONS PART 5 & AS 3700 MASONRY STRUCTURES

- FOOTINGS TO BE IN ACCORDANCE WITH AS1480.
- FOOTINGS TO BE IN ACCORDANCE WITH NCC VOL.2 PARTS H1D4
 ALL REINFORCEMENTS SHALL CONFORM TO AS1302, AS1303 AND AS1304.
- RESIDENTIAL SLABS, FOOTINGS AND CONCRETE STRUCTURES TO NCC 2022 ABCB
- HOUSING PROVISIONS PART 3 & 4, AS 2870 RESIDENTIAL SLABS AND FOOTING & AS 3600 CONCRETE STRUCTURES.

CARPENTRY:
- TIMBER TO COMPLY WITH AS1170.2 OR AS4055. - ALL WORKMANSHIP AND MATERIALS SHALL BE IN ACCORDANCE WITH AS1684 AND 1720

-TERMITE MANAGEMENT INSTALLATION OF PERIMETER & COLLARS TO NCC 2022 - ABCB HOUSING PROVISIONS PART 3.4 & AS 3660.1 TERMITE MANAGEMENT - NEW BUILDING

TIMBER FRAMING:
-ALL EXTERNAL TIMBER FRAMED WALLS TO BE WRAPPED IN A BREATHABLE VAPOUR PERMEABLE MEMBRANE IN ACCORDANCE WITH NCC VOL.2 PART H1D6, INSTALLED WITH AS/NZS 4200.1 & AS/NZS 4200.2.

-TIMBER FRAMING INSTALLATION TO NCC 2022 - VOL.2 PART HAD6(4), AS 1684.4 RESIDENTIAL TIMBER FRAMED CONSTRUCTION & AS/NZS 1170 STRUCTURAL DESIGN

- GROUND FLOOR TIMBERS SHALL BE ONLY OF HARDWOOD, CYPRESS PINE OR PRESSURE TREATED RADIATA OR CANADA PINE BELOW A HEIGHT OF 300mm ABOVE FINISHED GROUND LEVEL AND MUST NOT BE BUILT INTO BRICKWORK

- SUBFLOOR VENTILATION SHALL CONFORM TO NCC 2022 - ABCB HOUSING PRIVIONS PART

- IN BUSHFIRE PRONE AREAS SPECIAL CONDITIONS APPLY.
- WHERE TERMITE BARRIERS NEED TO BE INSPECTED, 400mm CLEARANCE IS REQUIRED BETWEEN THE UNDERSIDE OF BEARER AND GROUND SURFACE
- USE TREATED TIMBER WHERE REQUIRED FOR DURABILITY.
- DO NOT USE TIMBER UNSUITABLE FOR EXPOSURE TO MOISTURE IN EXPOSED LOCATION
- PROVIDE STRUCTURE BRACING IN ACCORDANCE WITH AS1684 - PROVIDE STRUCTURE TIEDOWN IN ACCORDANCE WITH AS1684
- USE GALVANISED FIXINGS WHERE EXPOSED TO WEATHER.

-ALL STEEL FRAMING TO NCC 2022 - VOL.2 PARTH1D6(3), AS 4100 STEEL STRUCTURES, AS/ NZS 4600 COLD-FORMED STEEL STRUCTURES & NASH STANDARD.

- TERMITE CONTROL:
 TO BE IN ACCORDANCE WITH TO AS3660.1
- SHALL BE IN ACCORDANCE WITH NCC 2022 ABCB HOUSING PROVISION PART 3.4

- SELECTION AND INSTALLATION OF METAL RAINWATER GOODS REFER TO AS2180
 FLASH PROJECTIONS ABOVE THE ROOF WITH TWO PART FLASHINGS CONSISTING OF AN
- APRON FLASHING AND OVER FLASHING, WITH AT LEAST 100mm OVERLAP.
- PROVIDE FOR INDEPENDENT MOVEMENT BETWEEN ROOF AND PROJECTION - DAMP PROOF COURSE AND FLASHINGS TO NCC 2022 - VOL.2 PART H2 & AS/NZS 2904 DAMP-PROOF COURSES AND FLASHINGS.

CONCRETE BLOCKS OR BRICKS:
- TO COMPLY WITH TO AS4455 MASONRY BUILDING BLOCKS/PAVER.

LIGHTING:

- 40% OF NEW OR ALTERED LIGHT FIXTURES TO BE FITTED WITH FLUORESCENT, COMPACT FLUORESCENT, OR LIGHT-EMITTING-DIODE (LED) LAMPS

- DOORS & WINDOWS: - ALL FRAMED WINDOWS SHALL BE INSTALLED IN ACCORDANCE WITH AS2047-48 FOR ALUMINIUM WINDOWS AND AS2047 FOR TIMBER WINDOWS.
- ALUMINIUM FRAMED WINDOWS AND DOORS.
- WEATHER STRIPPING IS TO BE PROVIDED TO ALL EXTERNAL WINDOWS AND DOORS.
 ALL WINDOWS ARE TO BE RESTRICTED IN ACCORDANCE WITH NCC 2022 ABCB HOUSING PROVISIONS PART 11.3.7 & PART 11.3.8 PROTECTION OF OPENABLE WINDOWS WHERE SURFACE BELOW IS MORE THAN 2M.

- PROVIDE LIFT-OFF HINGES WHERE THE TOILET PAN IS WITHIN 1.2 METRES OF THE HINGED SIDE OF THE DOOR IN ACCORDANCE WITH NCC 2022 - ABCB HOUSING PROVISIONS PART 10.4.

$\underline{\text{STAIRS}, \text{HANDRAILS AND BALUSTRADES:}}$

- RELATIONSHIP OF RISER TO GOING SHALL BE BETWEEN 1:2 AND 1:1.35 UNLESS OTHERWISE DIRECTED TO GOING SHALL BE BETWEEN 1:2 AND 1:1.35 UNLESS OTHERWISE DIRECTED OR

 BALUSTRADES SHALL BE PROVIDED TO ALL LANDINGS, RAMPS, DECKS, ROOFS AND OTHER ELEVATED PLATFORMS WHERE THE VERTICAL DISTANCE FROM THAT LEVEL IS MORE THAN m ABOVE THE ADJOINING FLOOR OR FINISHED GROUND LEVEL

- THE HEIGHT OF BALUSTRADE MUST BE A MINIMUM OF 1m HIGH ABOVE LANDING AND NOT LESS THAN 865mm ABOVE THE NOSINGS OF ANY STAIR TREADS OR FLOOR RAMP AND HAVE

- THE HEIGHT OF BALUSTRADE TO THE NEW STAIRCASES IS TO BE MEASURED A MINIMUM 865mm ABOVE THE NOSING LINE AND HAVE NO OPENING GREATER NO OPENING GREATER

- ALL BALUSTRADES & PRIVACY SCREENS TO COMPLY WITH NCC 2022 - ABCB HOUSING PROVISIONS PART 11, AS 1684, AS 1170, AS 1288 & AS/NZS 2208

SLIP RESISTANCE

- MATERIALS TO BE USED FOR SURFACES OF FLOORS, STAIR LANDING, STEPS AND NOSINGS SHALL BE IN ACCORDANCE WITH THE CLASSIFICATIONS FOR SLIP RESISTANCE AS APPLY IN AS4586 AND HB198.

- ALL STAIRS PROVIDING ACCESS TO COMPLY WITH NCC 2022 - ABCB HOUSING PROVISIONS PART 11, AS 4586 INCLUDING SLIP RESISTANCE P3 / R10 FOR DRY OR P4 / R11 FOR WET.

EAVES GUTTERS, VALLEY GUTTERS AND DOWPIPES

- TO COMPLY WITH AS/NZS 2179 FOR METAL AND AS1273 FOR UPVC COMPONENTS.
- IN ACCORDANCE WITH NCC VOL 2 PART 3.5.3
- NEW DOWNPIPES TO BE CONNECTED INTO EXISTING STORMWATER LINE
- COLORBOND GUTTERS AND DOWNPIPES
- MINIMUM SLOPE OF EAVES AND GUTTERS 1:200

NCC VOI 2 PART H1D8 ABCB HOUSING PROVISIONS PART 8, 3

-ALL WINDOW GLAZING AND DOOR GLAZING TO BE INSTALLED IN ACCORDANCE TO NCC 2022 -ABCB HOUSING PROVISIONS PART 8, AS 1288 GLASS IN BUILDINGS, AS/NZS 2208 SAFETY GLAZING MATERIALS IN BUILDINGS & AS 2047 WINDOWS AND EXTERNAL DOORS IN BUILDINGS.

SHOWER SCREEN/MIRRORS / WARDROBE GLASS INSTALLATION TO NCC 2022 - HOUSING PROVISIONS PART 8 AS 1288 & AS/NZS 2208

- GLASS BALUSTRADE INSTALLATION TO NCC 2022 - HOUSING PROVISIONS PART 11, AS 1288 GLASS IN BUILDINGS, AS/NZS 2208 SAFETY GLAZING MATERIALS IN BUILDINGS & AS 1170 STRUCTURAL DESIGN ACTIONS.

WATERPROOFING FOR EXTERNAL TILED BALCONIES:

- WATERPROOFING TO COMPLY WITH AS4654

- ALL WATERPROOFING TO NCC 2022 - ABCB HOUSING PROVISIONS PART 10, AS3740 AND PROVIDE A GUARANTEED FLEXIBLE WATERPROOF MEMBRANE TO ALL WET AREA FLOORS & SHOWER WALLS TO MANUFACTURED SPECIFICATIONS AND INSTALLATION INSTRUCTIONS.

WASTE MANAGEMENT:

- ALL WASTE SHALL BE TAKEN AWAY BY TRUCKS TO A SUITABLE LANDFILL OR RECYCLE
- ALL WASTE SHALL BE COVERED DURING TRANSPORTATION.
 WASTE GENERATED DURING CONSTRUCTION SHALL BE PLACED IN STEEL BINS AND TAKEN AWAY BY AN APPROVED CONTRACTOR TO A APPROVED LANDFILL SITE.

FIRE SAFETY, SMOKE DETECTORS/ALARMS:
- PROVIDE HARDWIRED & INTERCONNECTED SMOKE ALARM DEVICES COMPLYING WITH THE REQUIREMENTS OF THE LOCAL GOVERNMENT ACT AND/OR STATE OR TERRITORY REGULATIONS MUST BE FITTED IN THE LOCATIONS REQUIRED AND APPROVED BY THE AUTHORITY. SMOKE ALARMS TO BE INSTALLED TO NCC 2022 – ABCB HOUSING PROVISIONS PART 9.5, NSW 9.5.1 & AS 3786. INSTALLATIONS IN BUILDINGS OTHER THAN CLASS 1 AND 10 MUST BE INSTALLED AND MANAGED TO COMPLY WITH NCC SPEC, E2.2a.

- FIRE SEPARATING WALL, A WALL WITHIN 900MM OF BOUNDARY INSTALLATION CERTIFICATE (FRL60/60/60) INCL ACOUSTIC SOUND (RW) + CTR50 TO NCC 2022 - ABCB HOUSING PROVISIONS PART 9 & PART 10 7 AS 1530 ALL PARTS

- BUSHFIRE-PRONE AREAS CERTIFICATE FOR BUILDING - NCC 2022 - VOL. 2 PART NSW H7D4 CONSTRUCTION IN BUSHFIRE PRONE AREAS - AS 3959 CONSTRUCTION OF BUILDING IN BUSHFIRE-PRONE AREAS & PLANNING FOR BUSHFIRE PROTECTION 2019.

SEDIMENT CONTROL:

+75.74

RL RIDGE

FFL GARAGE FLOOR

NOTE: 1m SIDE

EXISTING DECK REMOVED -

FFL GRANNY FLAT GROUND FLOOR

NEW TIMBER DECK

SETBACK TO FINISHED

EXTERNAL WALLS

- A FILTER CLOTH SYSTEM SHALL BE INSTALLED TO STOP ANY SEDIMENT ENTERING COUNCILS STORMWATER SYSTEM...

SWIMMING POOLS & SAFETY:

-POOL PLUMBING/CIRCULATION TO COMPLY WITH NCC 2022 PART NSW H7D2, AS 1926.3 SWIMMING POOL SAFETY - WATER RECIRCULATION SYSTEMS

- ALL POOL FENCING TO BE INSTALLED TO: NCC 2022 NSW H7D2. AS 1926.1 - 2012 - SAFETY BARRIERS FOR SWIMMING POOLS, AS 1926.2 - 20007 - LOCATION OF SAFETY BARRIERS FOR SWIMMING POOLS, AS 1170 STRUCTURAL DESIGN ACTIONS AND IF GLASS POOL FENCING TO ADDITIONALLY COMPLY WITH AS 1288 - 2021 GLASS IN BUILDINGS, AS/NZS 2208 - SAFETY GLASS, - AS 2783 USE OF REINFORCED CONCRETE FOR SMALL SWIMMING POOLS

MISCELLANEOUS ITEMS


- ALLOW FOR SEPARATE TAPS FOR THE WASHING MACHINE AND KEEP THEM SEPARATE FROM THOSE OF THE LAUNDRY TUB. A DEDICATED LAUNDRY SPACE COMPRISING OF ONE WASHTUB AND A SPACE FOR A WASHING MACHINE MUST BE PROVIDED IN ACCORDANCE WITH NCC 2022 - ABCB HOUSING PROVISIONS PART 10.4.

DRAWING TITLE:

SECTION / SPECIFICATIONS

GAS FIRE SUPPLY AND INSTALLATION TO COMPLY WITH NCC 2022 - ABCB HOUSING PROVISIONS PART 12.4, AS/NZS 5601 GAS INSTALLATIONS.

ALL PLANS ARE TO BE READ IN CONJUNCTION AND COMPLY WITH THE BASIX CERTIFICATE, BUSHFIRE AND GEOTECH REPORTS

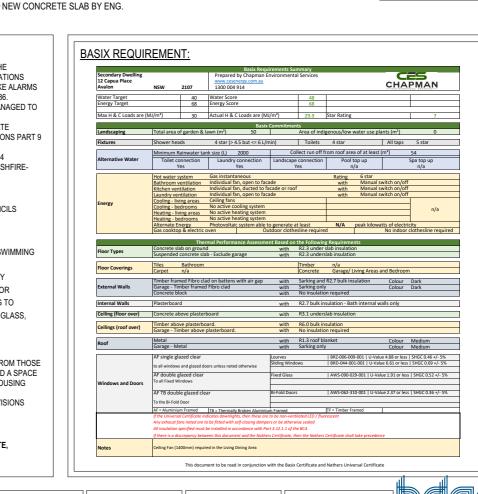

NOTES (E & OE)

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PROPOSED ALTERATIONS AND ADDITIONS 12 Capua Place - Avalon NSW 2101 Bernhard & Barbara

8.5m MAX. BUILDING HEIGHT

BEDROOM 1

WATERPROOF MEMBRANE

ON A 50mm SAND BED

NEW COLORBOND ROOF 14º PITCH

PROPOSED NEW

DOUBLE GARAGE

1267/24

DATE:

JULY/24

JOB No:

DRAWN BY SCALE: LB

1:100 @ A3

Certificate No. 0009726928

NEW COLORBOND ROOF 4º PITCH

FOOTINGS AS PER

DRAINAGE DETAILS BY ENGINEER

NEW RETAINING WALL BY ENG.

PORTION TO BE EXCAVATED

FOOTINGS AS PER ENG. DRAWINGS

SHOWN HATCHED

EXISTING DRIVEWAY

DRAWING No: **DA.06** CHECKED BY: JJ


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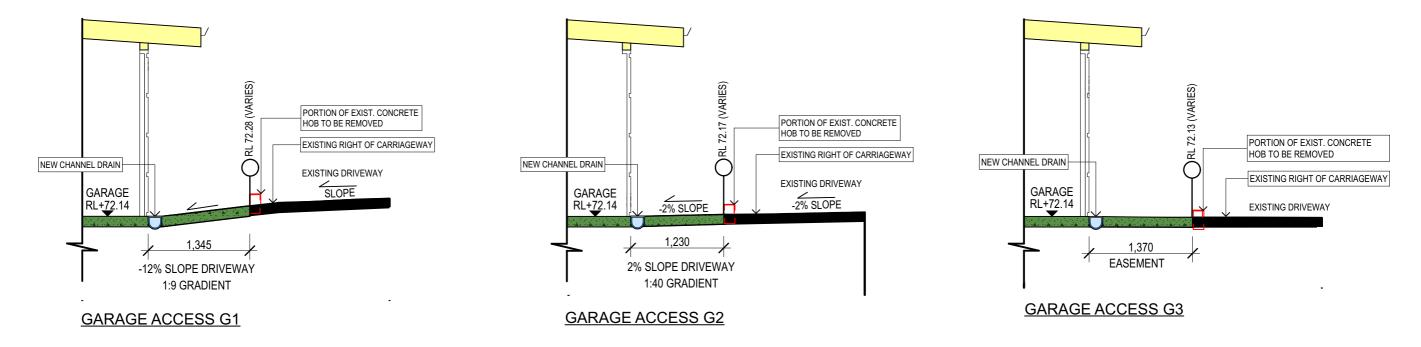
BUILDING DESIGNER

SECTION A-A







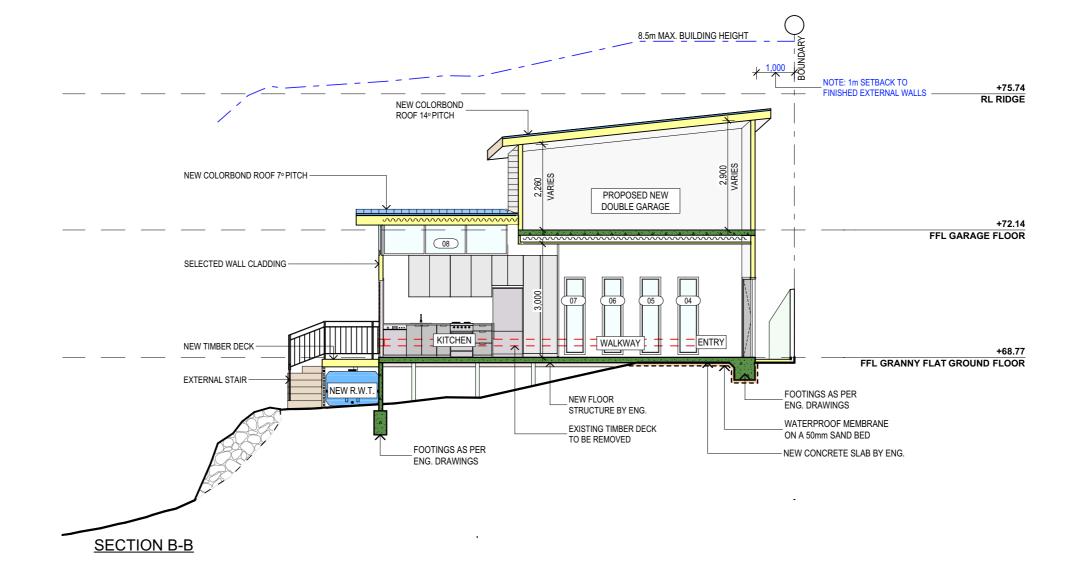

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- by a practicing engineer.
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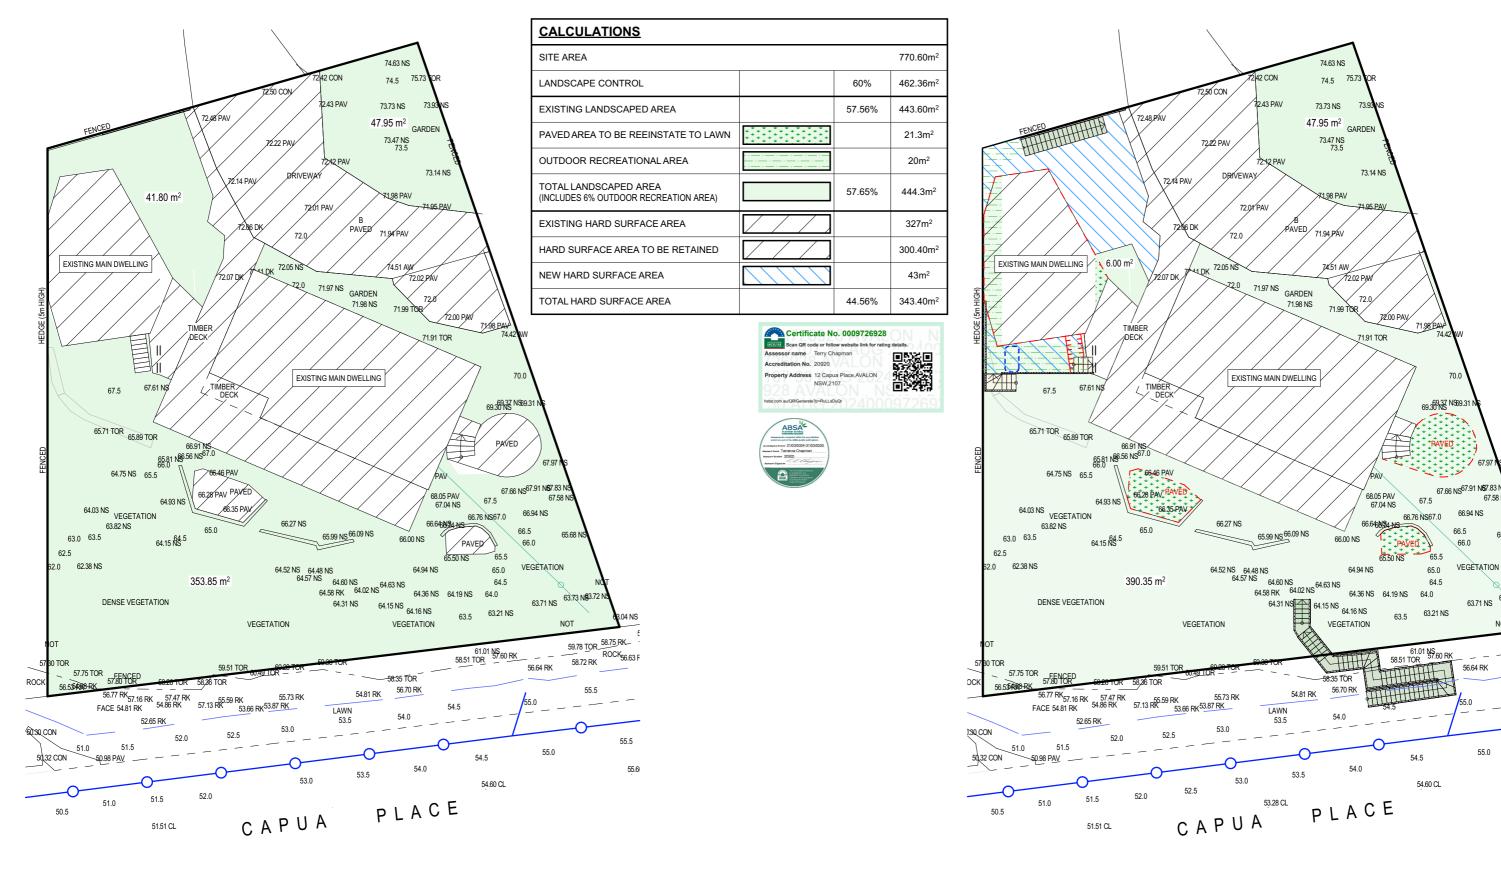
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1267/24	LB
	DATE:

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1:100, 1:50 @ A3 | A C C R E D I T E D BUILDING DESIGNER DRAWING No: CHECKED BY:

JJ

DRAWING TITLE: JULY/24 **DA.07** SECTIONS BB; G1, G2 & G3



EXISTING LANDSCAPE CALCULATION AREA

PROPOSED LANDSCAPE CALCULATION AREA



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3	Α	22.07.24	PRELIM. DRAWINGS UPDATED	12 Capua Place - Avalon NSW 2101
				CLIENT: Bernhard & Barbara
				DRAWING TITLE: LANDSCAPED AREA CALCULATION PLAN

DESCRIPTION:

REV: DATE:

PROPOSED ALTERATIONS AND ADDITIONS 12 Capua Place - Avalon NSW 2101	JOB No:	
CLIENT: Bernhard & Barbara	1267/24	
DRAWING TITLE:		

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DA.08

JULY/24



66.94 NS

VEGETATION

63.71 NS

56.64 RK

63.73 N§3.72

59.78 TOR 58.75 RK


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ROCK_{56.6}

66.0



STORMWATER CONCEPT PLAN

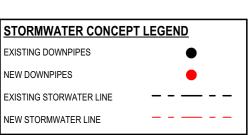

by a practicing engineer.

NOTES (E & OE) TRUE NORTH: All structures including stormwater & drainage to engineer's detail Do not obtain dimensions by scaling drawings. All dimensions are to be checked on site prior to starting work. • These drawings are to be read in conjunction with all other consultant's dra

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12 Capua Place - Avalon NSW 2101		IB
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		DATE:
DRAWING TITLE:		JULY/24
ROOF & STORMWATER CONCEPT PLAN		0021724

74.63 NS

GARDEN

74.5 73!/9 NS

71.94 PAV PAVED

GARDEN

1 & 2 STOREY DWELLING

EXISTING ROOF

65.99 NS 66.09 NS

64.52 NS 64.57 NS 64.60 NS 64.02 NS 64.02 NS

53.5

66.00 NS

64.16 NS_.

58:35 TOR

56.70 RK

PLACE

64.15 NS

VEGETATION 30.48

66.27 NS

VEGETATION

53.66 RK^{53.87} RK

52.5

53.0

CAPUA

57.13 RK 53

74.51 AW

72.00 PAV

71.98 PAV

69.37 NS69.31

68.32 PAV 68.33

67.66 NS^{67.91} N**6**7.83 N

66.94 NS

63.71 NS

55.0

66.42 NS 66.19 NS

65.44 NS

64.74 NS

59.78 TOR 58.75 RK 59.97 TOR

58.73 **RK** RK

ROCK_{56.63} RK

55.5

55.60 CL

VEGETATION

PAVED • 68.27 PANS.33 PAV

(66.0

65.0/EGETATIONS

65.5

66.76 NS67.0

63.776%s EXISTING STORMWATER

58.51 TOR 57.60 RK — 56.64 RK 54.5

2.42 CON

DRIVEWAY

72.01 PAV RIGHT OF CARRIAGEWAY

EXISTING DRIVEWAY

72.14 PAV

NEW COLORBONE ROOF 5° PITCH

DECK

66.56 NS_{67.0}

64.5 64.15 NS

NEW DOWNPIPES

ROOF 11° PITCH

NEW COLORBOND ROOF 7° PITCH

67.5 67.61 NS

65.71 TOR 65.89 TOR |

64.75 NS 65.5

DENSE VEGETATION

64.03 NS

63.0 63.5

62.38 NS

57.75 TOR FENCED

57.80 TOR

FACE 54.81 RK

56.77 RK 57.16 RK 57.47 RK

51.51 CL

DENSE VEGETATION

56 68 TOR

50.0

CONCRETE DRIVEWAY 51.0 49.52 CON 49.92 CON 50.33 CON

56.50 TOR

_ 56.48 TOR

50.59 CON .

52.42 RK 55.15 RK

50.5

56.91 TOR

55.01 RK 52.79 RK

NEW DOWNPIPES

72.22 PAV



BUILDING DESIGNER JJ

NOTES

DESIGNATED SITE MANAGER/BUILDER

PRIOR TO COMMENCEMENT OF WORK A SITE MANAGER OR BUILDER MUST BE NOMINATED. THE SITE MANAGER OR BUILDER WILL BE RESPONSIBLE AND LIABLE FOR ALL WORKS CARRIED OUT ON THE SITE. THIS ASSUMES THE RESPONSIBILITY FOR THE ACTIONS OF ALL SUBCONTRACTED PARTIES AS WELL AS ADVISING THEM OF COUNCIL'S REQUIREMENTS WHEN CARRYING OUT

TOPSOIL MANAGEMENT

PRIOR TO THE STRIPPING OF TOPSOIL, THE VEGETATIVE COVER MUST BE REDUCED BY EITHER SLASHING OR MOWING. ALL TOPSOIL IS TO BE RETAINED AND PROTECTED FOR REUSE ON SITE. SOIL STOCKPILES MUST NOT BE LOCATED ON NATURE STRIPS, FOOTPATHS, ROADWAYS, KERBS, ACCESSWAYS, WITHIN DRAINAGE LINES/FLOWS/PATHS OR AROUND OR AGAINST TREE SHRUBS. SEDIMENT CONTROL MEASURES MUST BE INCORPORATED WITH ANY RESULTING STOCKPILE. THE STOCKPILE CAN BE PROTECTED FROM EROSION BY COVERING IT WITH AN MPERVIOUS MATERIAL, IN CONJUNCTION WITH THE INSTALLATION OF A SEDIMENT FENCE AROUND IT. IF STOCKPILES ARE TO REMAIN FOR MORE THAN ONE MONTH THEY ARE TO BE GRASSED IMMEDIATELY AND STABILISED WITHIN FOURTEEN DAYS. SURPLUS TOPSOIL MUST BE REASONABLY REMOVED FROM SITE.

BUILDING MATERIAL STOCKPILING

SUFFICIENT AREA MUST BE ALLOCATED WITHIN THE SITE FOR SUCH STORAGE OF BUILDING MATERIALS, DEMOLITION WASTE, WASTE CONTAINERS, ETC. AS WILL BE REQUIRED.

A SEDIMENT FENCE SHOULD BE LOCATED ALONG THE DOWNSLOPE BOUNDARY(S) OF THE SITE. ON THE CONSTRUCTION SIDE OF THE TURF FILTER STRIP OR NATIVE VEGETATION, AND AROUND ALL STOCKPILES OF MATERIAL ON THE SITE.

ALL TRUCKS/UTES MUST COVER THEIR LOADS AT ALL TIMES. APPROPRIATE METHODS ARE TO BE EMPLOYED TO PREVENT BLOWING DUST CREATING AN UNACCEPTABLE HAZARD OR NUISANCE ON THE SITE OR DOWN WIND. PRODUCTION OF DUST CAN BE MINIMISED BY LIMITING AREA OF EARTHWORKS, WATERING AND PROGRESSIVE VEGETATION. WHERE DUST IS CREATED AS A RESULT WORKS AND/OR SOIL EXPOSURE, THE BARE SOIL AREAS MUST BE WATERED, DURING AND/OR AT THE END OF EACH DAY TO LAY THE DUST. EARTH MOVING ACTIVITIES SHOULD BE AVOIDED WHERE WINDS ARE SUFFICIENTLY STRONG ENOUGH TO RAISE VISIBLE

EROSION & SEDIMENT CONTROLS

APPROPRIATE EROSION AND SEDIMENT CONTROLS MUST BE IMPLEMENTED ON ALL SITES THAT INVOLVE SOIL DISTURBANCE. THE MEASURES MUST BE IN PLACE PRIOR TO THE COMMENCEMENT OF WORK. THOSE CONTROLS ARE TO BE MONITORED AND MAINTAINED IN ORDER TO SERVE THEIR INTENDED FUNCTION FOR THE DURATION OF THE WORKS OR UNTIL SUCH TIME AS THE SITE IS FULLY STABILISED. IF ANY CONTROLS ARE DAMAGED OR BECOME INEFFECTIVE DURING THE COURSE OF THE WORKS THEY ARE TO BE REINSTATED OR REPLACED IMMEDIATELY. SUFFICIENT ACCESS TO THESE CONTROLS MUST BE PROVIDED IN CASE OF THE

SEDIMENT TRAPS

WHERE A SEDIMENT FENCE IS NOT USED APPROPRIATE SEDIMENT TRAPS SHOULD BE LOCATED AT ALL POINTS WHERE STORMWATER LEAVES THE CONSTRUCTION SITE OR LEAVES THE GUTTER AND ENTERS THE DRAINAGE SYSTEM. A COMMON TECHNIQUE IS THE GRAVEL SAUSAGE.

DIVERSION CHANNELS


A DIVERSION CHANNEL IS AN EXCAVATED EARTH DITCH OR PATH. THESE STRUCTURES ARE USED TO INTERCEPT AND DIRECT RUN-OFF TO A DESIRED LOCATION WHERE POSSIBLE. ALL STORMWATER RUN-OFF FLOWING ONTO DISTURBED AREAS, INCLUDING STOCKPILES, MUST BE INTERCEPTED, DIVERTED AND/OR SAFELY DISPOSED OF. THIS CAN BE ACHIEVED BY CONSTRUCTING A TEMPORARY EARTH BANK AROUND THE UPSLOPE EXTENT OF THE CONSTRUCTION SITE WHERE THE DIVERSION DOES NOT AFFECT THE NEIGHBOURING


VEHICLE MOVEMENTS


TO LIMIT DISTURBANCE TO THE SITE AND TRACKING OF MATERIAL ONTO THE STREET ALL VEHICLES AND PLANT EQUIPMENT ARE TO USE A SINGLE ENTRY/EXIT POINT UNLESS COUNCIL HAS APPROVED ALTERNATIVE ARRANGEMENTS. ACCESS POINTS AND PARKING AREAS ARE TO BE STABILISED WITH COMPACTED SUB-GRADE ASAP AFTER THEIR FORMATION. IF SPILLAGE DOES OCCUR IT IS TO BE CONTAINED IMMEDIATELY AND CAREFULLY REMOVED. THE AREA AFFECTED IS TO BE RESTORED TO A STANDARD EQUAL TO OR BETTER THAN ITS PREVIOUS CONDITION. ALL VEHICLES ARE TO BE WASHED PRIOR TO EXISTING THE SITE. THIS SERVES THE PURPOSE OF REMOVING SITE MATERIAL ON THE VEHICLE AND PREVENTS IT FROM BEING DEPOSITED ON THE ROAD NETWORK ADJACENT TO THE SITE AND THUS, THE STORMWATER SYSTEM. NO VEHICLE ASSOCIATED WITH THE WORK IS TO BE PARKED ON A FOOTPATH OR PUBLIC RESERVE. ALL VEHICLES VISITING THE SITE DURING DEMOLITION, EXCAVATION AND/OR CONSTRUCTION WORKS, ARE TO COMPLY WITH THE PARKING REQUIREMENTS IN THAT AREA.





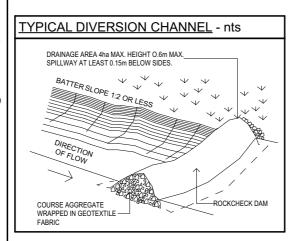

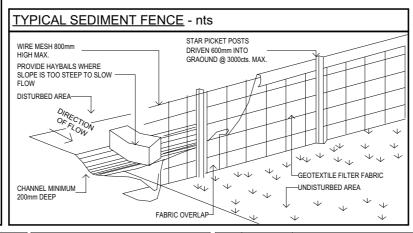

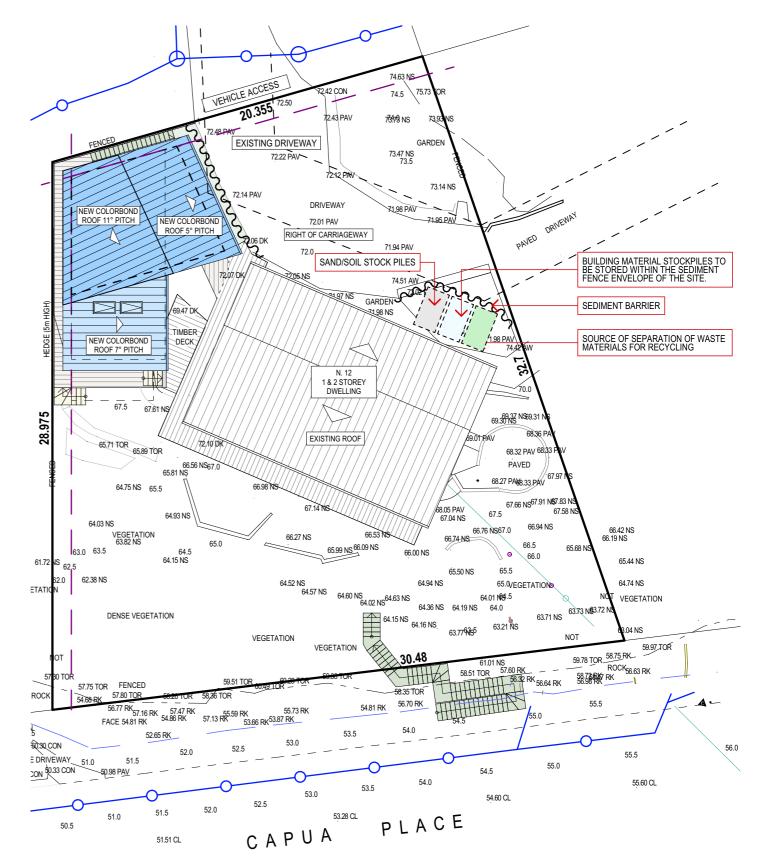

EROSION AND SEDMENT CONTROL

PLAN

TRUE NORTH:





NOTES (E & OE)

- Do not obtain dimensions by scaling drawings
- All dimensions are to be checked on site prior to starting work
- These drawings are to be read in conjunction with all other consultant's drawings and All workmanship & materials shall be in accordance with the requirements of current editi
- ouncil requirements.

 New materials are to be used throughout unless otherwise noted.

 Concrete footings, slab, structural beams or any other structural members are to be designed. by a practicing engineer

JJ Draftíng ^{Australia} P/L. 26/90 Mona Vale Road, Mona Vale, NSW, 2103

PO Box 687, Dee Why, NSW, 2099 Mob. 0414 717 541 | ACN 651 693 346 Email. enquiries@jjdrafting.com.au www.jjdrafting.com.au

П	REV:	DATE:	DESCRIPTION:
ı	Α	22.07.24	PRELIM. DRAWINGS UPDATED
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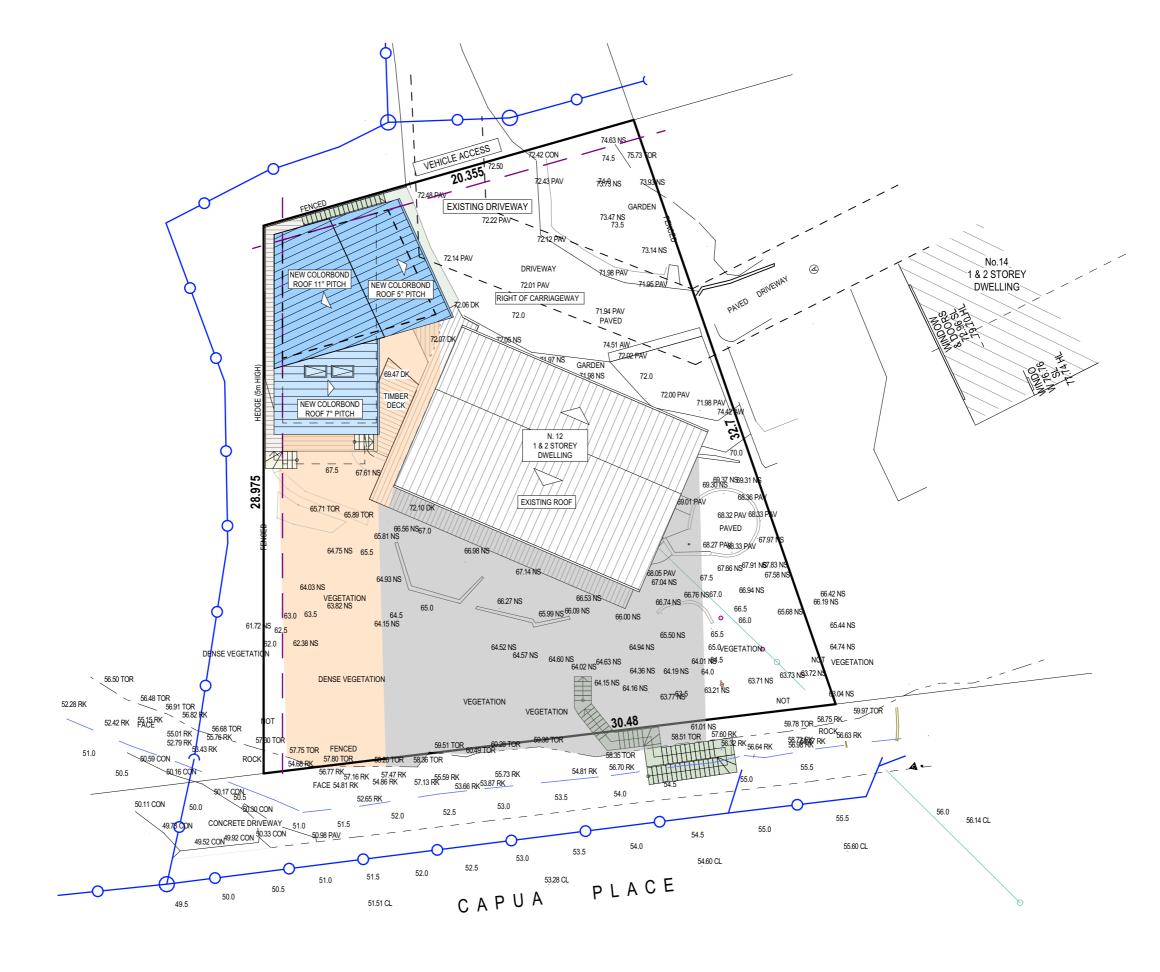
PROPOSED ALTERATIONS AND ADDITIONS 12 Capua Place - Avalon NSW 2101 CLIENT:	JOB No: 1267/24	DRAWN BY:	SCALE: 1:200 @ A3
Bernhard & Barbara		DATE:	DRAWING No:
DRAWING TITLE: EROSION & SEDIMENT CONTROL / WASTE	JULY/24	DA.10	

ACCREDITED

BUILDING DESIGNER

CHECKED BY:





SHADOW DIAGRAM JUNE 21 9:00 am

21 JUNE SHADOW DIAGRAM LEGEND EXISTING SHADOWS

NEW SHADOWS

TRUE NORTH:



- All structures including stormwater & drainage to engineer's details
 Do not obtain dimensions by scaling drawings.
 All dimensions are to be checked on site prior to starting work.
- . These drawings are to be read in conjunction with all other consultant's draw
- All workmanship & materials shall be in accordance with the require New materials are to be used throughout unless otherwise noted.
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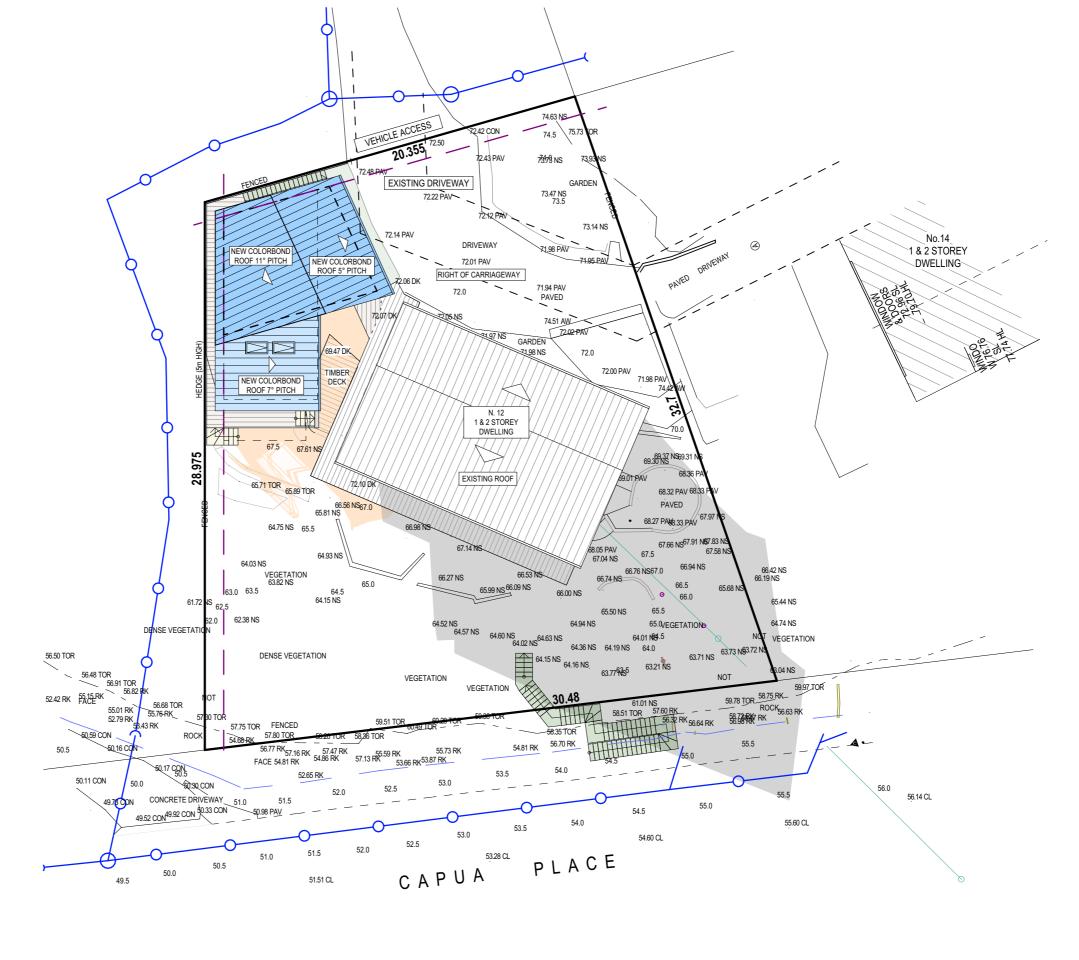
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12 Capua Place - /	PROPOSED ALTERATIONS AND ADDITIONS 12 Capua Place - Avalon NSW 2101 CLIENT:		DRAWN BY:	SCALE: 1:200 @ <i>F</i>	
Bernhard & Barba	ra		DATE:	DRAWING No:	
DRAWING TITLE: SHADOW DIAG	RAM JUNE 21 9:00 am		JULY/24	DA.11	







SHADOW DIAGRAM JUNE 21 12 noon

21 JUNE SHADOW DIAGRAM LEGEND

EXISTING SHADOWS

NEW SHADOWS

TRUE NORTH:



- All structures including stormwater & drainage to engineer's details
 Do not obtain dimensions by scaling drawings.
 All dimensions are to be checked on site prior to starting work.
- . These drawings are to be read in conjunction with all other consultant's drawings and

- New materials are to be used throughout unless otherwise noted.
 Concrete footings, slab, structural beams or any other structural members are to be designed. by a practicing engineer.

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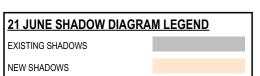
PROPOSED ALTERATIONS AND ADDITIONS 12 Capua Place - Avalon NSW 2101 CLIENT:	JOB No: 1267/24	DRAWN BY:
Bernhard & Barbara		DATE:
DRAWING TITLE: SHADOW DIAGRAM JUNE 21 12 noon		JULY/24







SHADOW DIAGRAM JUNE 21 3:00 pm



TRUE NORTH:



	REV:	DATE:	DESCRIPTION:
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PROPOSED ALTERATIONS AND ADDITIONS 12 Capua Place - Avalon NSW 2101	JOB No:		
CLIENT: Bernhard & Barbara	1267/24		
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No.14

1 & 2 STOREY

DWELLING

HECKED BY: JJ

NOTES (E & OE)	II Docaftina	REV:	DATE:	DESCRIPTION:	PROPOSED ALTERATIONS AND ADDITIONS	JOB No:	DRAWN BY:	SCALE:	
All structures including stormwater & drainage to engineer's details. Do not obtain dimensions by scaling drawings.	JJ Drafting	Α	22.07.24	PRELIM. DRAWINGS UPDATED	12 Capua Place - Avalon NSW 2101	OOD NO.			
All dimensions are to be checked on site prior to starting work. These drawings are to be read in conjunction with all other consultant's drawings and	Australia P/L.					1267/24	LB	1:200 @ A3	ACCRE
specifications.	26/90 Mona Vale Road, Mona Vale, NSW, 2103				CLIENT:	1201721			BUILDING
All workmanship & materials shall be in accordance with the requirements of current editions including amendments of the National Construction Code, relevant Australian Standards & local	PO Box 687, Dee Why, NSW, 2099				Bernhard & Barbara		DATE:	DRAWING No:	CHEC
council requirements.	Mob. 0414 717 541 ACN 651 693 346				DRAWING TITLE:]		
New materials are to be used throughout unless otherwise noted. Concrete footings, slab, structural beams or any other structural members are to be designed.	Email. enquiries@jjdrafting.com.au				SHADOW DIAGRAM JUNE 21 3:00 pm		JULY/24	DA.13	,
by a practicing engineer.	www.jjdrafting.com.au				STIADOW DIAGRAM JUNE 21 3.00 PM]	<u> </u>	

53.0

CAPUA

74.63 NS-

74.5 \75.73 73179 NS

71,98 PAV

PAVED 74.51 AW

GARDEN

73.14 NS

71.95 PAV

72.00 PAV

68.05 PAV 67.04 NS

66.74 NS

65.50 NS

64.36 NS 64.19 NS 64.0

69.37 NS69.3 68.36 F

68.32 PAV 68.3

67.66 NS^{67.91} N**S**7.83 N

65.44 NS

64.74 NS

59.78 TOR 58.75 RK. 59.97 TOR ROCK 56.63 RK

55.5

55.60 CL

VEGETATION

56.0

56.14 CL

PAVED

• 68.27 PANS.33 PAV 67.9

66.76 NS67.0 66.94 NS

65.5

63.21 NS

54.5

54.60 CL

66.0 €

65.0/EGETATION

63.71 NS 63.73 N§3.72 N

55.0

67.5

VEHICLE ACCESS

72.14 PAV

NEW COLORBOND ROOF 5° PITCH

DECK

66.56 NS_{67.0}

65.81 NS

64.93 NS

64.5 64.15 NS

NEW COLORBOND ROOF 11° PITCH

NEW COLORBOND

28.975

61.72

DENSE VEGETATION

56.68 TOR 55.76-RK

49.76 CON CONCRETE DRIVEWAY 51.0 49.52 CON 49.92 CON 50.33 CON 50.9

56.50 TOR

56.48 TOR

50.59 CON

50.11 CON

52.42 RK FACERK

56.91 TOR 56.82 F

√50.16 CO

55.01 RK 55.76 52.79 RK 53.43 RK

67.5 67.61 NS

65,71 TOR 65.89 TOR

64.03 NS

63.0 63.5

62.38 NS

57.75 TOR FENCED 54.68.RK 57.80 TOR

51.0

62,5

64.75 NS 65.5

VEGETATION 63.82 NS

DENSE VEGETATION

56.77 RK 57.16 RK 57.47 RK FACE 54.81 RK 54.86 RK

51.5

51.51 CL

EXISTING DRIVEWAY

72.22 PAV~

DRIVEWAY

72.01 PAV

RIGHT OF CARRIAGEWAY

1 & 2 STOREY DWELLING

EXISTING ROOF

65.99 NS 66.09 NS

64.15 NS 64.16 NS.

58.35 TOR

56.70 RK

PLACE

64.52 NS 64.57 NS 64.60 NS 64.02 NS 64.03 NS

VEGETATION

54.81 RK

66.27 NS

VEGETATION

57.13 RK