DOCUMENTATION OF STORMWATER CONCEPT DESIGN

NEW DEVELOPMENT

12-14 ROCK BATH ROAD PALM BEACH NSW

JAMES TAYLOR AND ASSOCIATES

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Sheet Number	STORMWATER DRAWING LIST
	Sheet Name
SW1 STORM	IWATER CONCEPT DESIGN COVER SHEET
SW2 EXISTIN	NG SERVICES PLAN
SW3 STORM	IWATER DRAINAGE PLAN - LOWER GROUND FLOOR
SW4 STORM	IWATER DRAINAGE PLAN - GROUND FLOOR
SW5 STORM	1WATER DRAINAGE PLAN - LEVEL 1
SW6 STORM	1WATER DRAINAGE PLAN - LEVEL 2
SW7 STORM	IWATER DRAINAGE PLAN - ROOF
SW8 SECTION)N

STORMWATER NOTES

- SW1. STORMWATER DRAINS TO BE RUN TO SUIT THE LOCAL SEWERAGE AND DRAINAGE BOARD, FROM THE STORMWATER DRAINS WITH PIPES AND FITTINGS SET NOT LESS THAN MINIMUM FALLS RECOMMENDED BY THE GOVERNING AUTHORITY, WITH MATERIALS AND LEVELS SHOWN ON THE DRAWINGS AND IN THE SPECIFICATION.
- SW2. ALL PIPES SHALL BE UPVC 100mm DIAMETER U.N.O. IN ACCORDANCE WITH AS3500.3 NATIONAL PLUMBING AND DRAINAGE CODE, PART 3: STORMWATER
- SW3. ALL PIPES TO BE UPVC OR CONCRETE AS NOTED AND IN ACCORDANCE WITH AS3500.3 NATIONAL PLUMBING AND DRAINAGE CODE, PART 3: STORMWATER DRAINAGE.
- SW4. ALL UPVC PIPES TO BE INSTALLED IN ACCORDANCE WITH AUSTRALIAN STANDARD AS2032.
- SW5. ALL PIPES SHALL BE LAID AT A MINIMUM GRADE OF 1 IN 100 U.N.O.
- SW6. ARROWS INDICATE THE DIRECTION OF GRADE.
 SW7. ALL FOOTPATH AND DRIVEWAY CROSSINGS SHALL BE
 TO LOCAL COUNCIL REQUIREMENTS.
- SW8. ALL LEVELS ARE APPROXIMATE ONLY AND SHALL NEED TO BE CONFIRMED PRIOR TO CONSTRUCTION. SW9. ALL EXISTING LEVELS ARE SHOWN AS A SPOT LEVEL
- OR A CONTOUR WITHOUT ANY PREFIX OR DESCRIPTION.
 LEVEL DESCRIPTIONS ARE AS FOLLOWS;
- FL FLOOR LEVEL
 SL SURFACE LEVEL
- IL INVERT LEVEL
- ALL LEVELS ARE TO AUSTRALIAN HEIGHT DATUM (AHD) U.N.O.
- SW10. MINIMUM COVER TO UPVC STORMWATER PIPES SHALL BE; TRAFFICABLE AREAS - 450 mm LANDSCAPE AREAS - 300 mm
 - COVER IS MEASURED VERTICALLY FROM THE TOP OF THE PIPE TO THE FINISHED SURFACE LEVEL. PIPES TO BE PROTECTED BY CONCRETE ENCASEMENT TO ENGINEERS APPROVAL IF MINIMUM
- COVER CANNOT BE ACHIEVED.

 SW11. CONNECTION OF UPVC TO PRECAST PITS TO BE BY TREATING THE PIPE WITH PVC GLUE AND SEAL WITH A
- 3:1 SAND CEMENT MORTAR.

 SW12. ALL CONCRETE PIPES AND ASSOCIATED ELEMENTS
 SHALL BE MANUFACTURED AND PROVIDED WITH A
 STRENGTH CLASSIFICATION IN ACCORDANCE WITH
 AS4058, PRECAST CONCRETE PIPES (PRESSURE AND
 NON-PRESSURE).
- SW13. ALL CONCRETE PIPES AND ASSOCIATED ELEMENTS SHALL BE INSTALLED IN ACCORDANCE WITH AS3725, LOADS ON BURIED CONCRETE PIERS AND AS3500.3 NATIONAL PLUMBING AND DRAINAGE CODE, PART 3: STORMWATER DRAINAGE.
- SW14. "K" ON PLAN DENOTES KERB AS DETAILED WITH
 "T.O.K" DENOTING LEVEL FOR TOP OF KERB FOR
 DATUM INDICATED.
- SW15. PITS SHALL BE OF A SIZE AS SHOWN OR NOTED WITH GALVANISED GRATED COVERS OR AN APPROVED EQUIVALENT. ALL PITS IN BARKED OR WOODCHIP LANDSCAPED AREAS SHALL HAVE COVERS OR STANDARD COVERS MODIFIED TO ENSURE DEBRIS DOES NOT ENTER STORMWATER SYSTEM.

REFERENCE DOCUMENTS

1. SURVEY DRAWING PREPARED BY:
TSS TOTAL SURVEYING SOLUTIONS
JOB No: 220083
PLAN No: 220083-1
DATE: 02/03/2022

GENERAL COMPACTION NOTES

- 1. FOUNDATION MATERIAL DEEMED BY THE SUPERINTENDENT AS UNSUITABLE TO BE REMOVED AS DIRECTED BY THE SUPERINTENDENT AND REPLACED WITH APPROVED MATERIAL SATISFYING THE REQUIREMENTS LISTED BELOW.
- UNLESS OTHERWISE APPROVED OR SPECIFIED. ALL FILL MATERIAL SHALL BE FROM A SOURCE APPROVED BY THE SUPERINTENDENT AND SHALL COMPLY WITH THE FOLLOWING:

 A) FREE FROM ORGANIC AND PERISHABLE MATTER B) MAXIMUM PARTICLE SIZE 75MM
 C) PLASTICITY INDEX BETWEEN 2% AND 20%
- D) CBR > 10
 THE PAVEMENT AREAS SHALL BE PROOF ROLLED
 WITH AN 8TROLLER PRIOR TO COMPACTION. LOOSE
 OR SOFT AREAS SHALL BE REMOVED & REPLACED
 WITH ENGINEERED FILL MATERIAL
- 4. SELECT FILL MATERIAL SHALL BE PLACED IN MAXIMUM 200MM LOOSE THICK LAYERS AND COMPACTED AT OPTIMUM MOISTURE CONTENT (+ OR 2%) TO ACHIEVE A DRY DENSITY DETERMINED IN ACCORDANCE WITH AS1289E3.1 OF NOT LESS THAN THE FOLLOWING STANDARD MAXIMUM DRY DENSITY IN ACCORDANCE WITH AS1289E1.1:
- LOCATION STANDARD DRY DENSITY
 AREAS OF SERVICE TRENCHES 98%
 EMBANKMENTS 100%
 LANDSCAPED AREAS 90%
- CONCRETE FOUNDATIONS 100% - PAVEMENT SLABS 100%
- MINIMUM SUBGRADE THICKNESS WHERE NOT ON ROCK SHALL BE 450mm
- THE CONTRACTOR SHALL PROGRAMME THE EARTHWORKS OPERATION SO THAT THE WORKING AREAS ARE ADEQUATELY DRAINED DURING THE PERIOD OF CONSTRUCTION. THE SURFACE SHALL BE GRADED AND SEALED OFF TO REMOVE DEPRESSIONS. ROLLER MARKS AND SIMILAR WHICH WOULD ALLOW WATER TO POND AND PENETRATE THE UNDERLYING MATERIAL. ANY DAMAGE RESULTING FROM THE CONTRACTOR NOT OBSERVING THESE REQUIREMENTS SHALL BE RECTIFIED BY THE CONTRACTOR AT HIS COST.
- COMPACTION CONTROL TESTING SHALL BE CARRIED OUT BY AND AT THE COST OF THE CONTRACTOR TO CONFORM WITH LEVEL 1. AS DEFINED IN AS3798 (LATEST EDITION).

SERVICES NOTES:

- THE LOCATION OF ALL EXISTING SERVICES SHOWN ON THE DRAWINGS ARE APPROXIMATE ONLY AND HAVE BEEN TAKEN FROM SURVEY (REFERENCE DOCUMENT 1)
- 2. EXISTING PITS GRL, SL & RL ARE TAKEN FROM SURVEY (REFERENCE DOCUMENT 1).

 3. IT IS THE CONSTRUCTORS RESPONSIBILITY TO NOTIFY.
- IT IS THE CONSTRUCTORS RESPONSIBILITY TO NOTIFY THE RELEVANT SERVICES AUTHORITIES OF THE WORKS AND VERIFY THE LOCATIONS OF ALL EXISTING SERVICES PRIOR TO ANY CONSTRUCTION ACTIVITIES COMMENCING.
- THE CONSTRUCTOR SHALL LIAISE AND COORDINATE THE TIMING OF THE CONSTRUCTION OF THE WORKS WITH THE RELEVANT SERVICES AUTHORITIES AND/OR OTHER CONSTRUCTORS INSTALLING SERVICES CONCURRENTLY AT THIS SITE.
- 5. THE CONSTRUCTOR SHALL BE RESPONSIBLE FOR ALL DAMAGE CAUSED TO EXISTING SERVICES AS A RESULT OF THE CONSTRUCTION WORKS.
- PRIOR TO COMMENCEMENT CONTRACTOR SHALL
 ACCURATELY LOCATE EXISTING SERVICES TO IDENTIFY
 THEIR POSITION, DEPTH AND CONDITION. POTENTIAL
 CLASHES SHALL BE IDENTIFIED AND SERVICES RELOCATED
 OR CAPPED OFF AS REQUIRED.



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HL	R.Y.	FOR DA	16.02.2023	Α
BY	CHKD	DESCRIPTION	DATE	RE'

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12-14 ROCK BATH ROAD PALM BEACH NSW

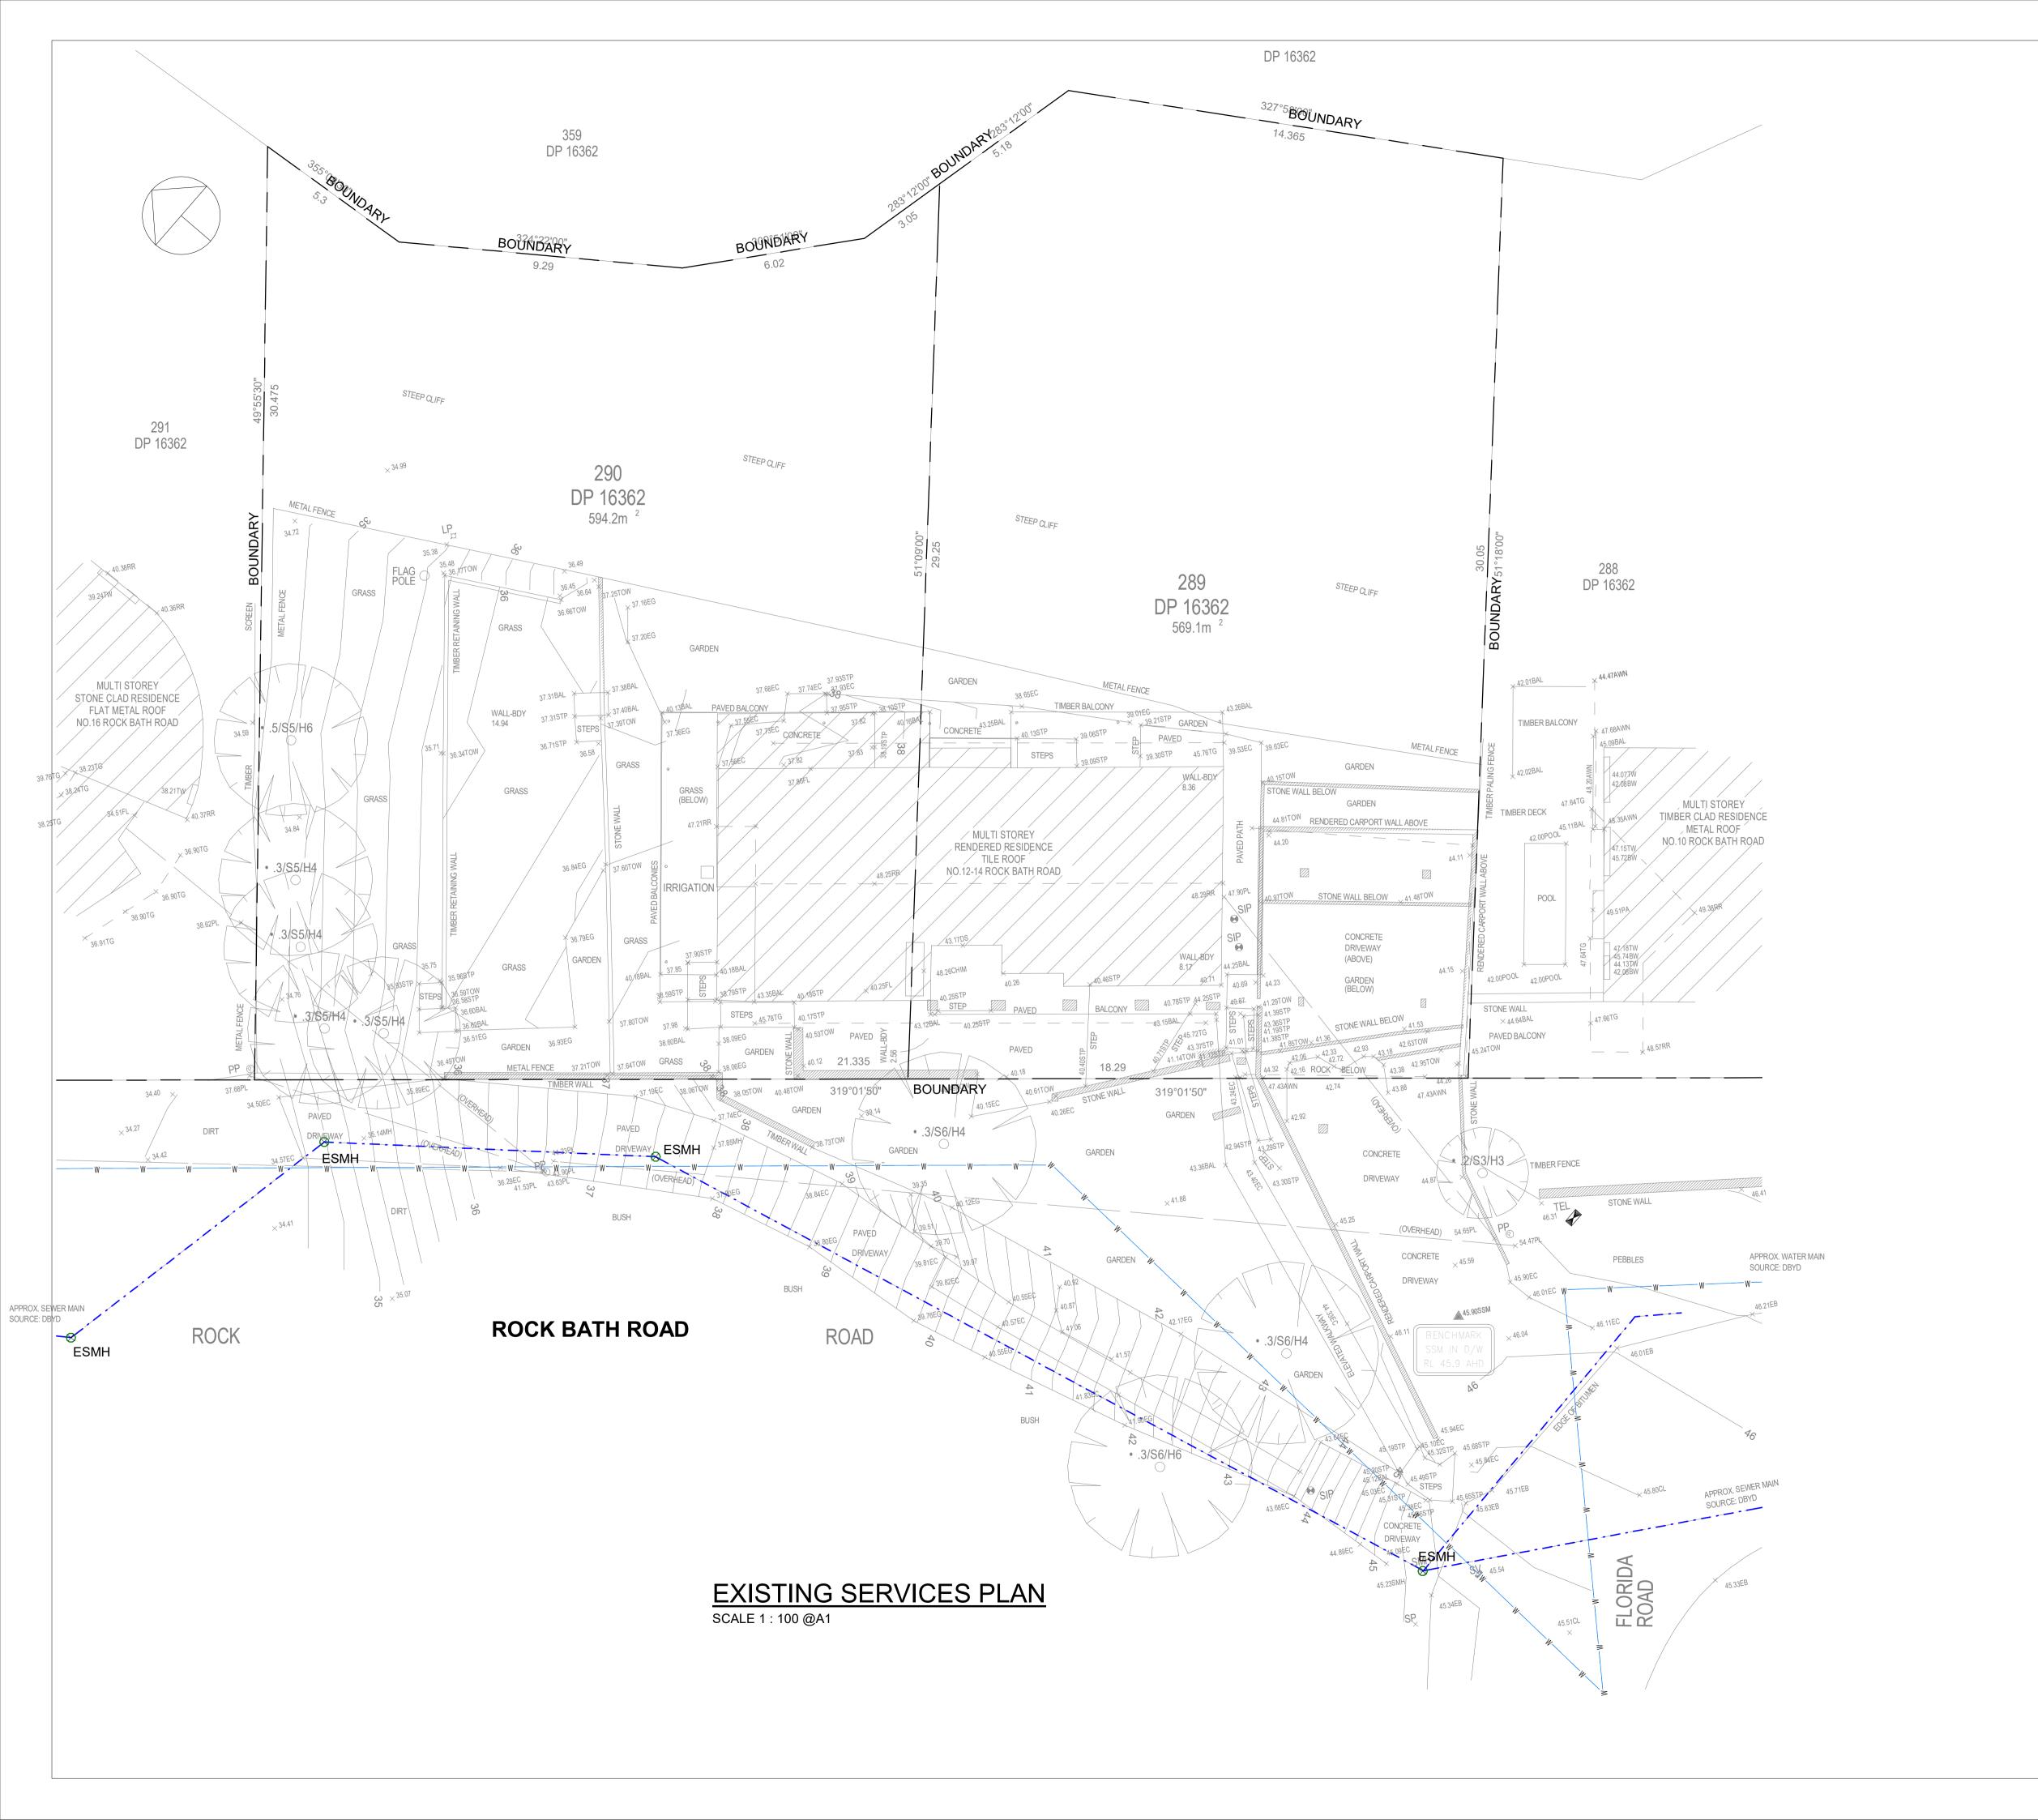
STORMWATER CONCEPT DESIGN COVER SHEET

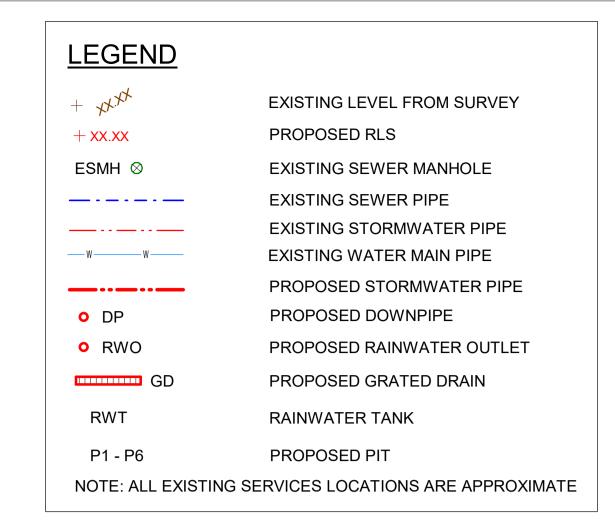
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DESIGN RY DRAWN HL

A1 SCALE As indicated DATE

SW1





REFERENCE DOCUMENTS

1. SURVEY DRAWING PREPARED BY: TSS TOTAL SURVEYING SOLUTIONS JOB No: 220083 PLAN No: 220083-1 DATE: 02/03/2022

GEOTECHNICAL REPORT



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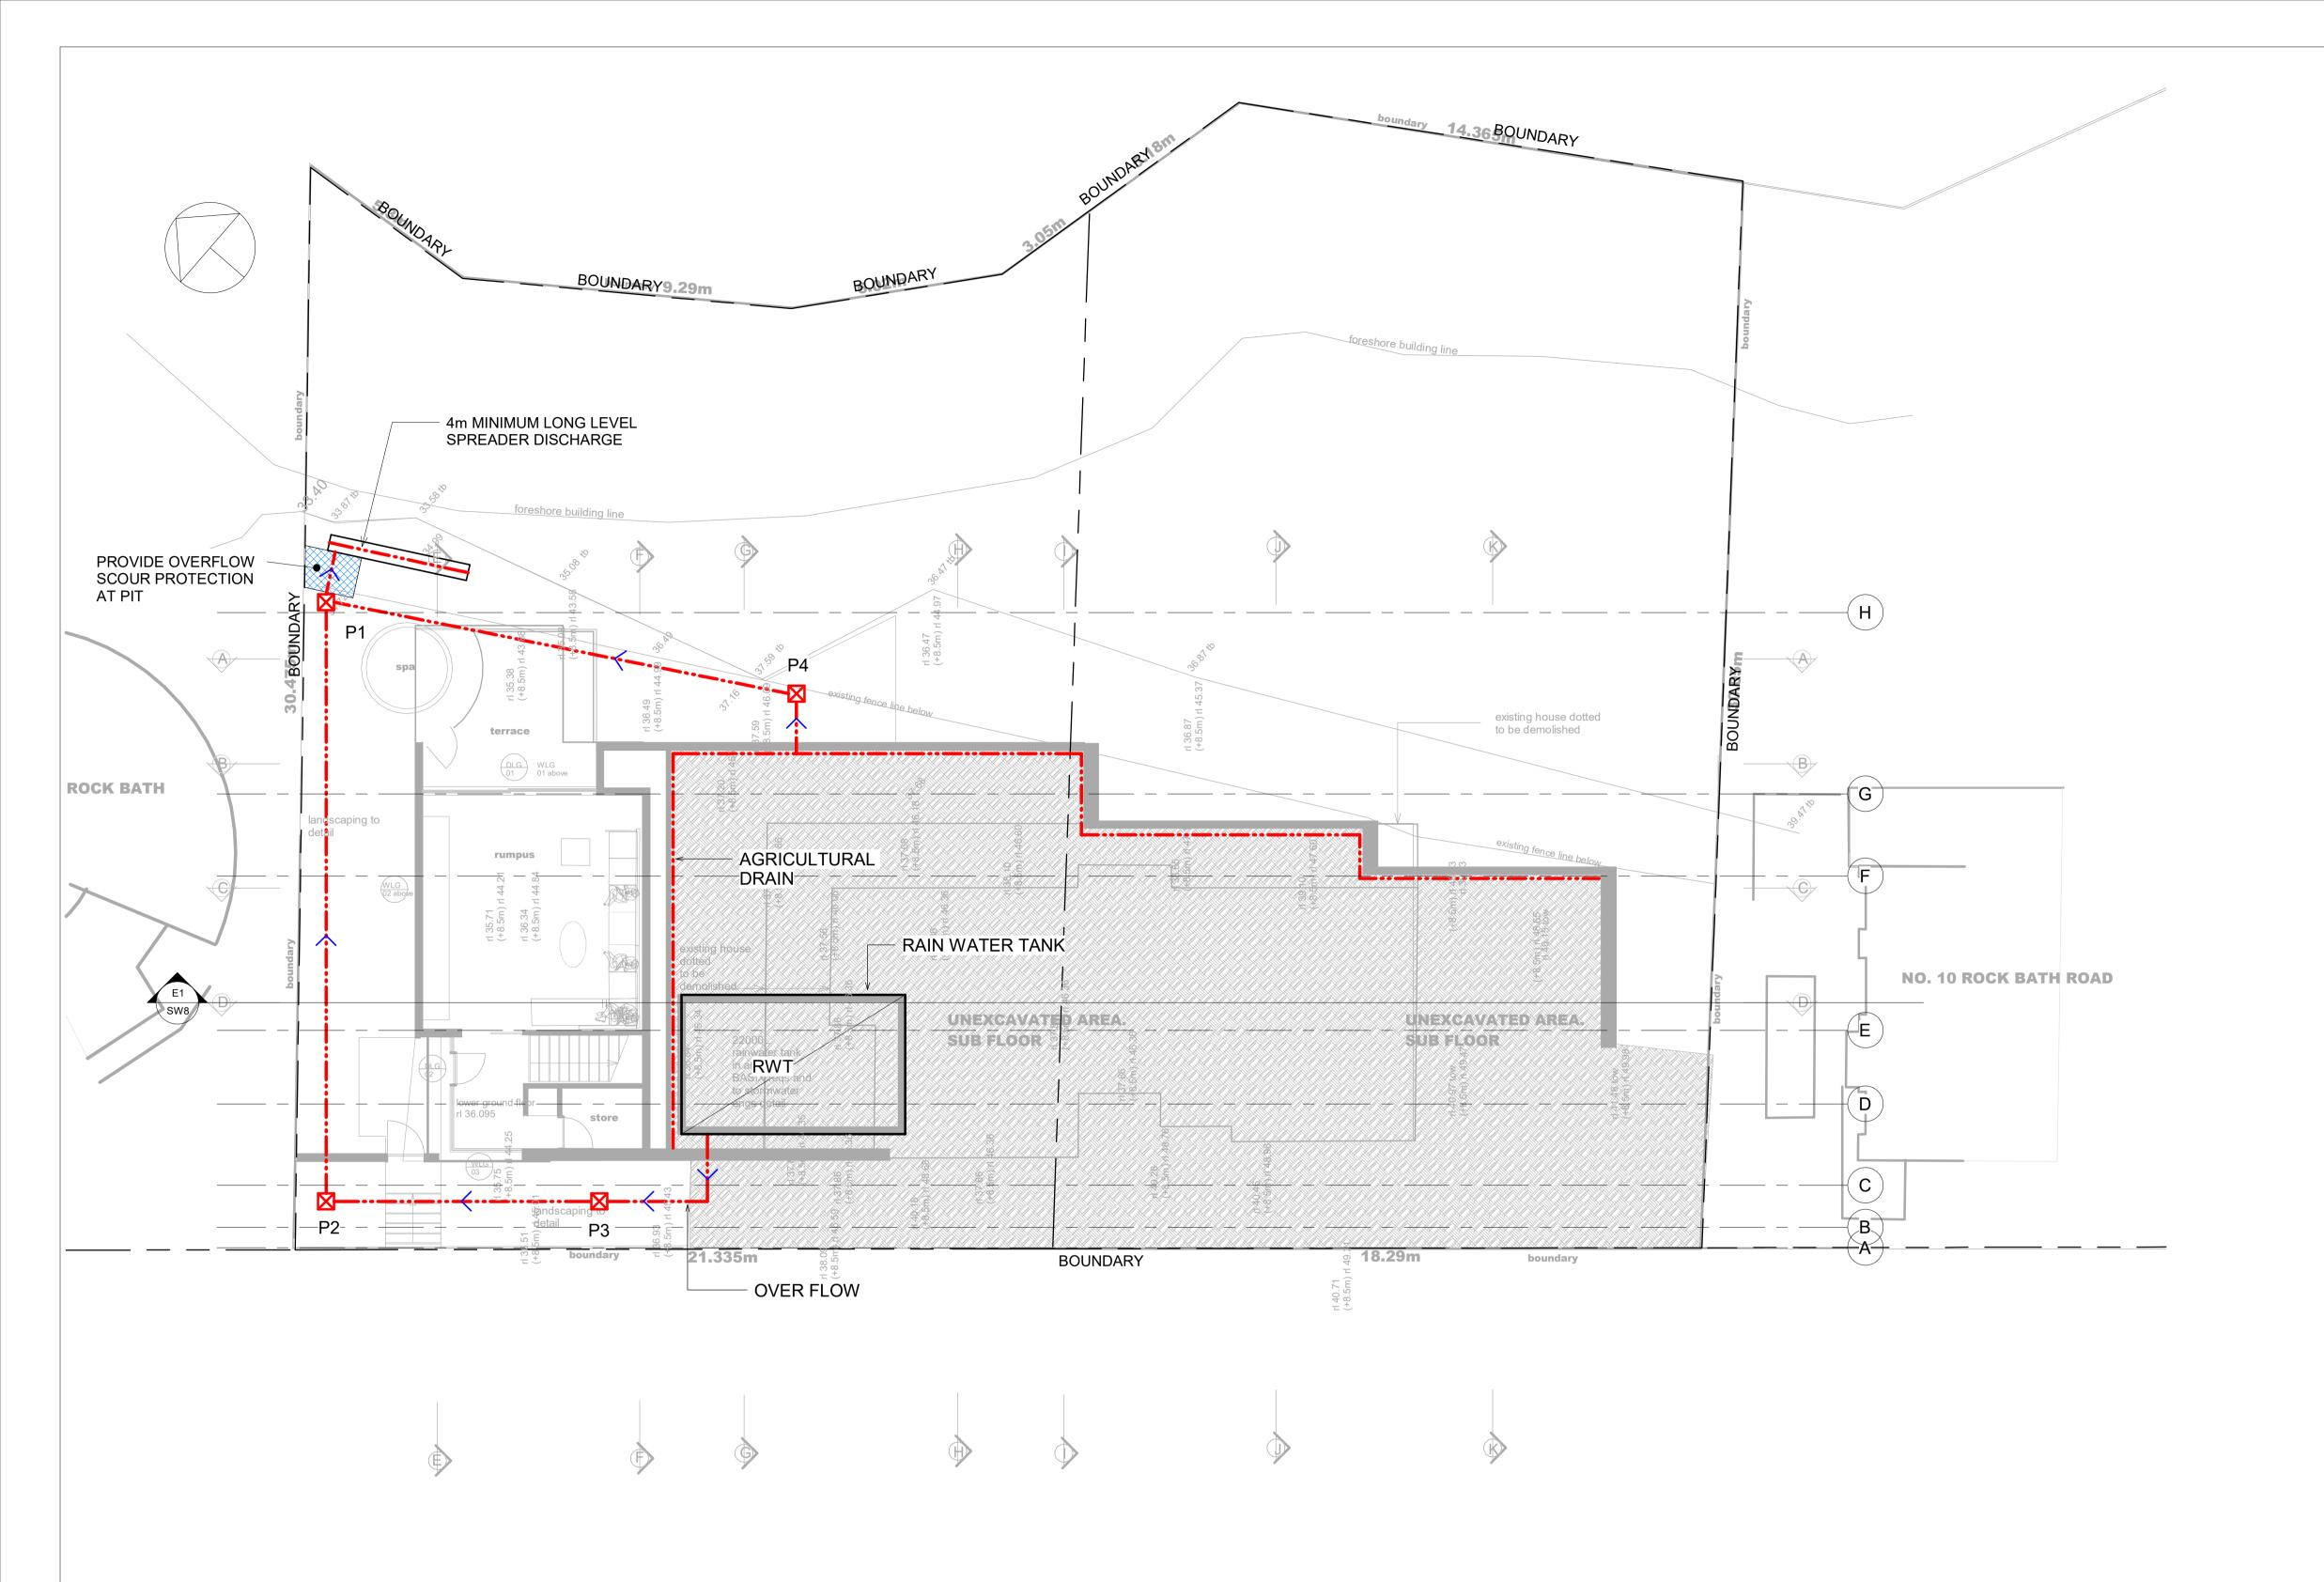
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EXISTING SERVICES PLAN

	DESIGN RY	DRAWN	HL	PROJEC	CT NO.
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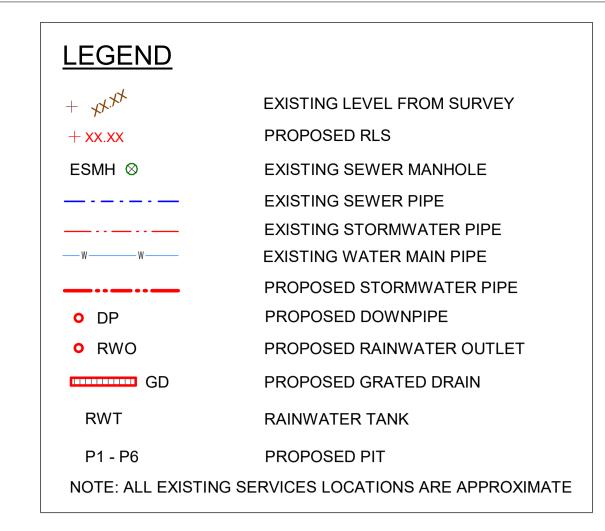


STORMWATER DRAINAGE PLAN - LOWER GROUND FLOOR

SCALE 1 : 100 @A1

ALL PIPEWORK TO AS3500 AND LOCAL AUTHORITY REQUIREMENTS 100 UPVC AT MIN 1:100 FALL U.N.O.

FINAL PIT LOCATIONS SUBJECT TO COORDINATION WITH ARCHITECT



ALL PITS 1200x1200 U.N.O.



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STORMWATER DRAINAGE PLAN - LOWER GROUND

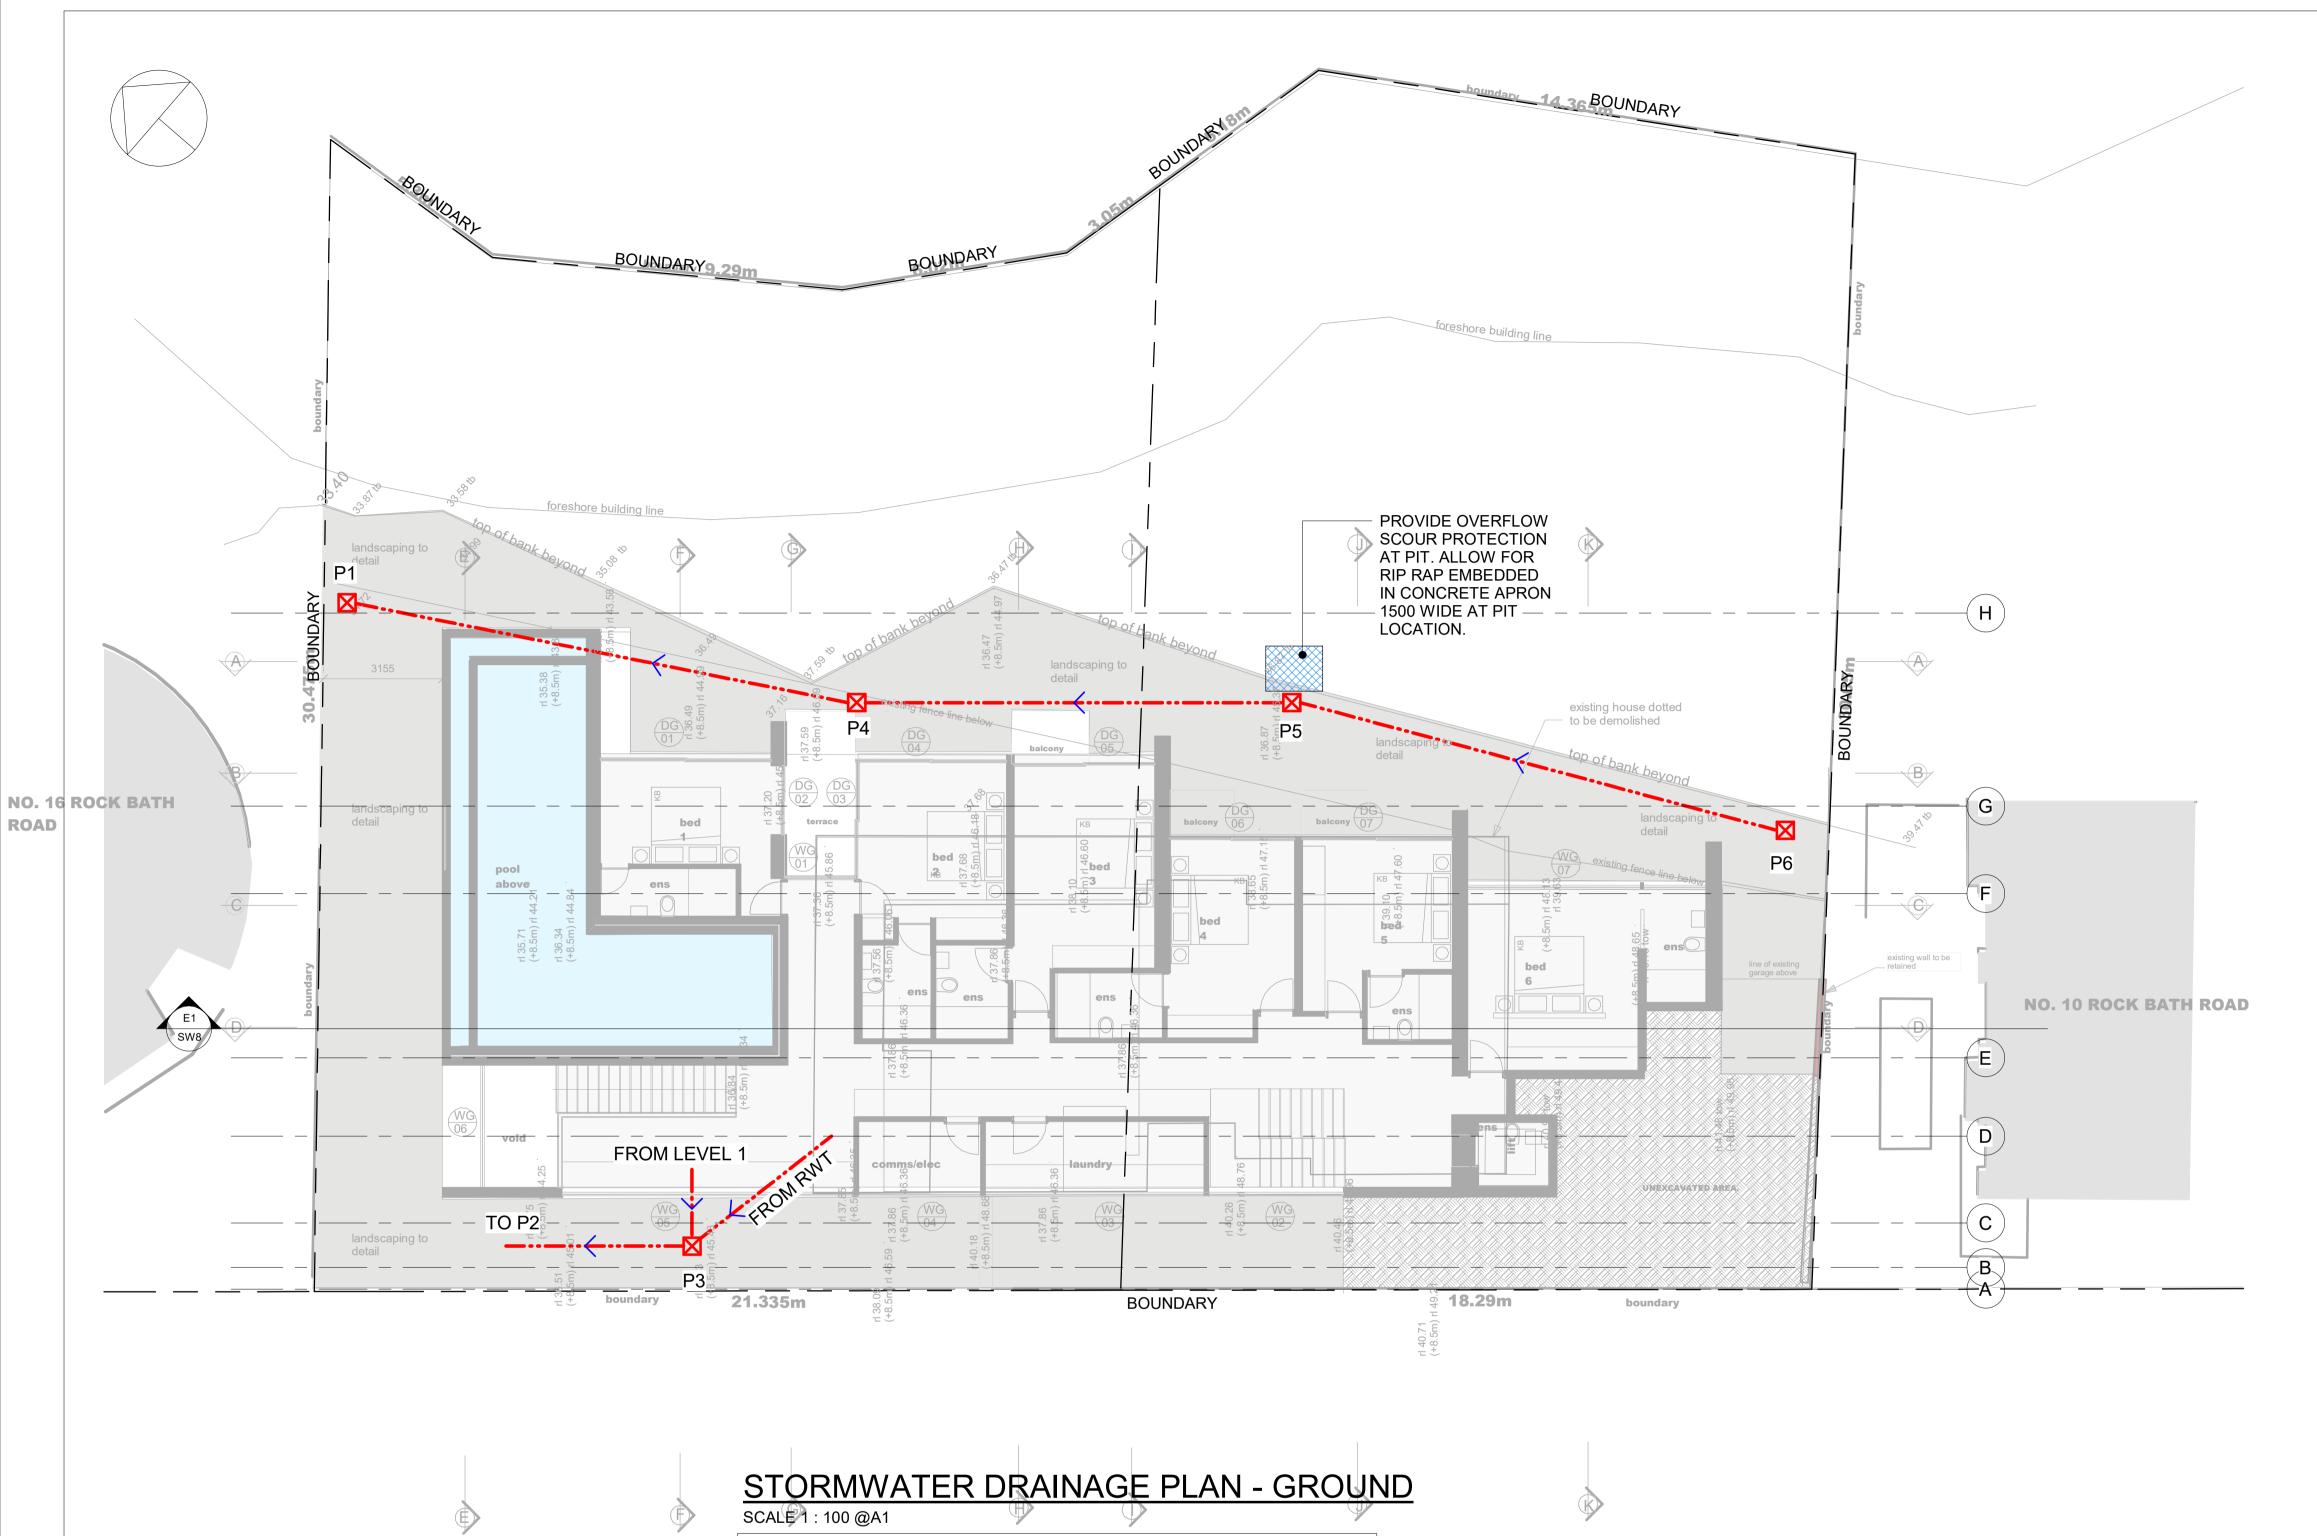
FLOOR

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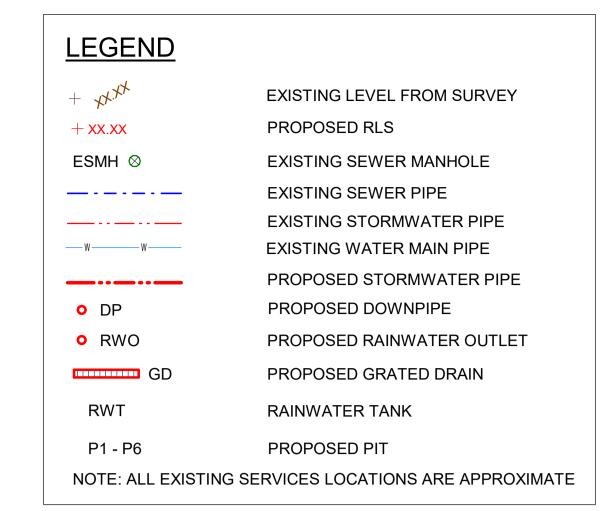
A1 SCALE As indicated DATE

SW3



ALL PIPEWORK TO AS3500 AND LOCAL AUTHORITY REQUIREMENTS 100 UPVC AT MIN 1:100 FALL U.N.O.

RAINWATER OUTLET LOCATIONS SUBJECT TO COORDINATION CONFIRM LEVEL, FALLS, THRESHOLDS WITH ARCHITECT TYPICAL.



RWT - 22000L REFER BASIX CERTIFICATE CONNECT TO OUTLETS AS NOMINATED IN BASIX REFER CERTIFICATE DISPLAY NON POTABLE SIGNAGE AT ALL RWT SUPPLIED OUTLETS



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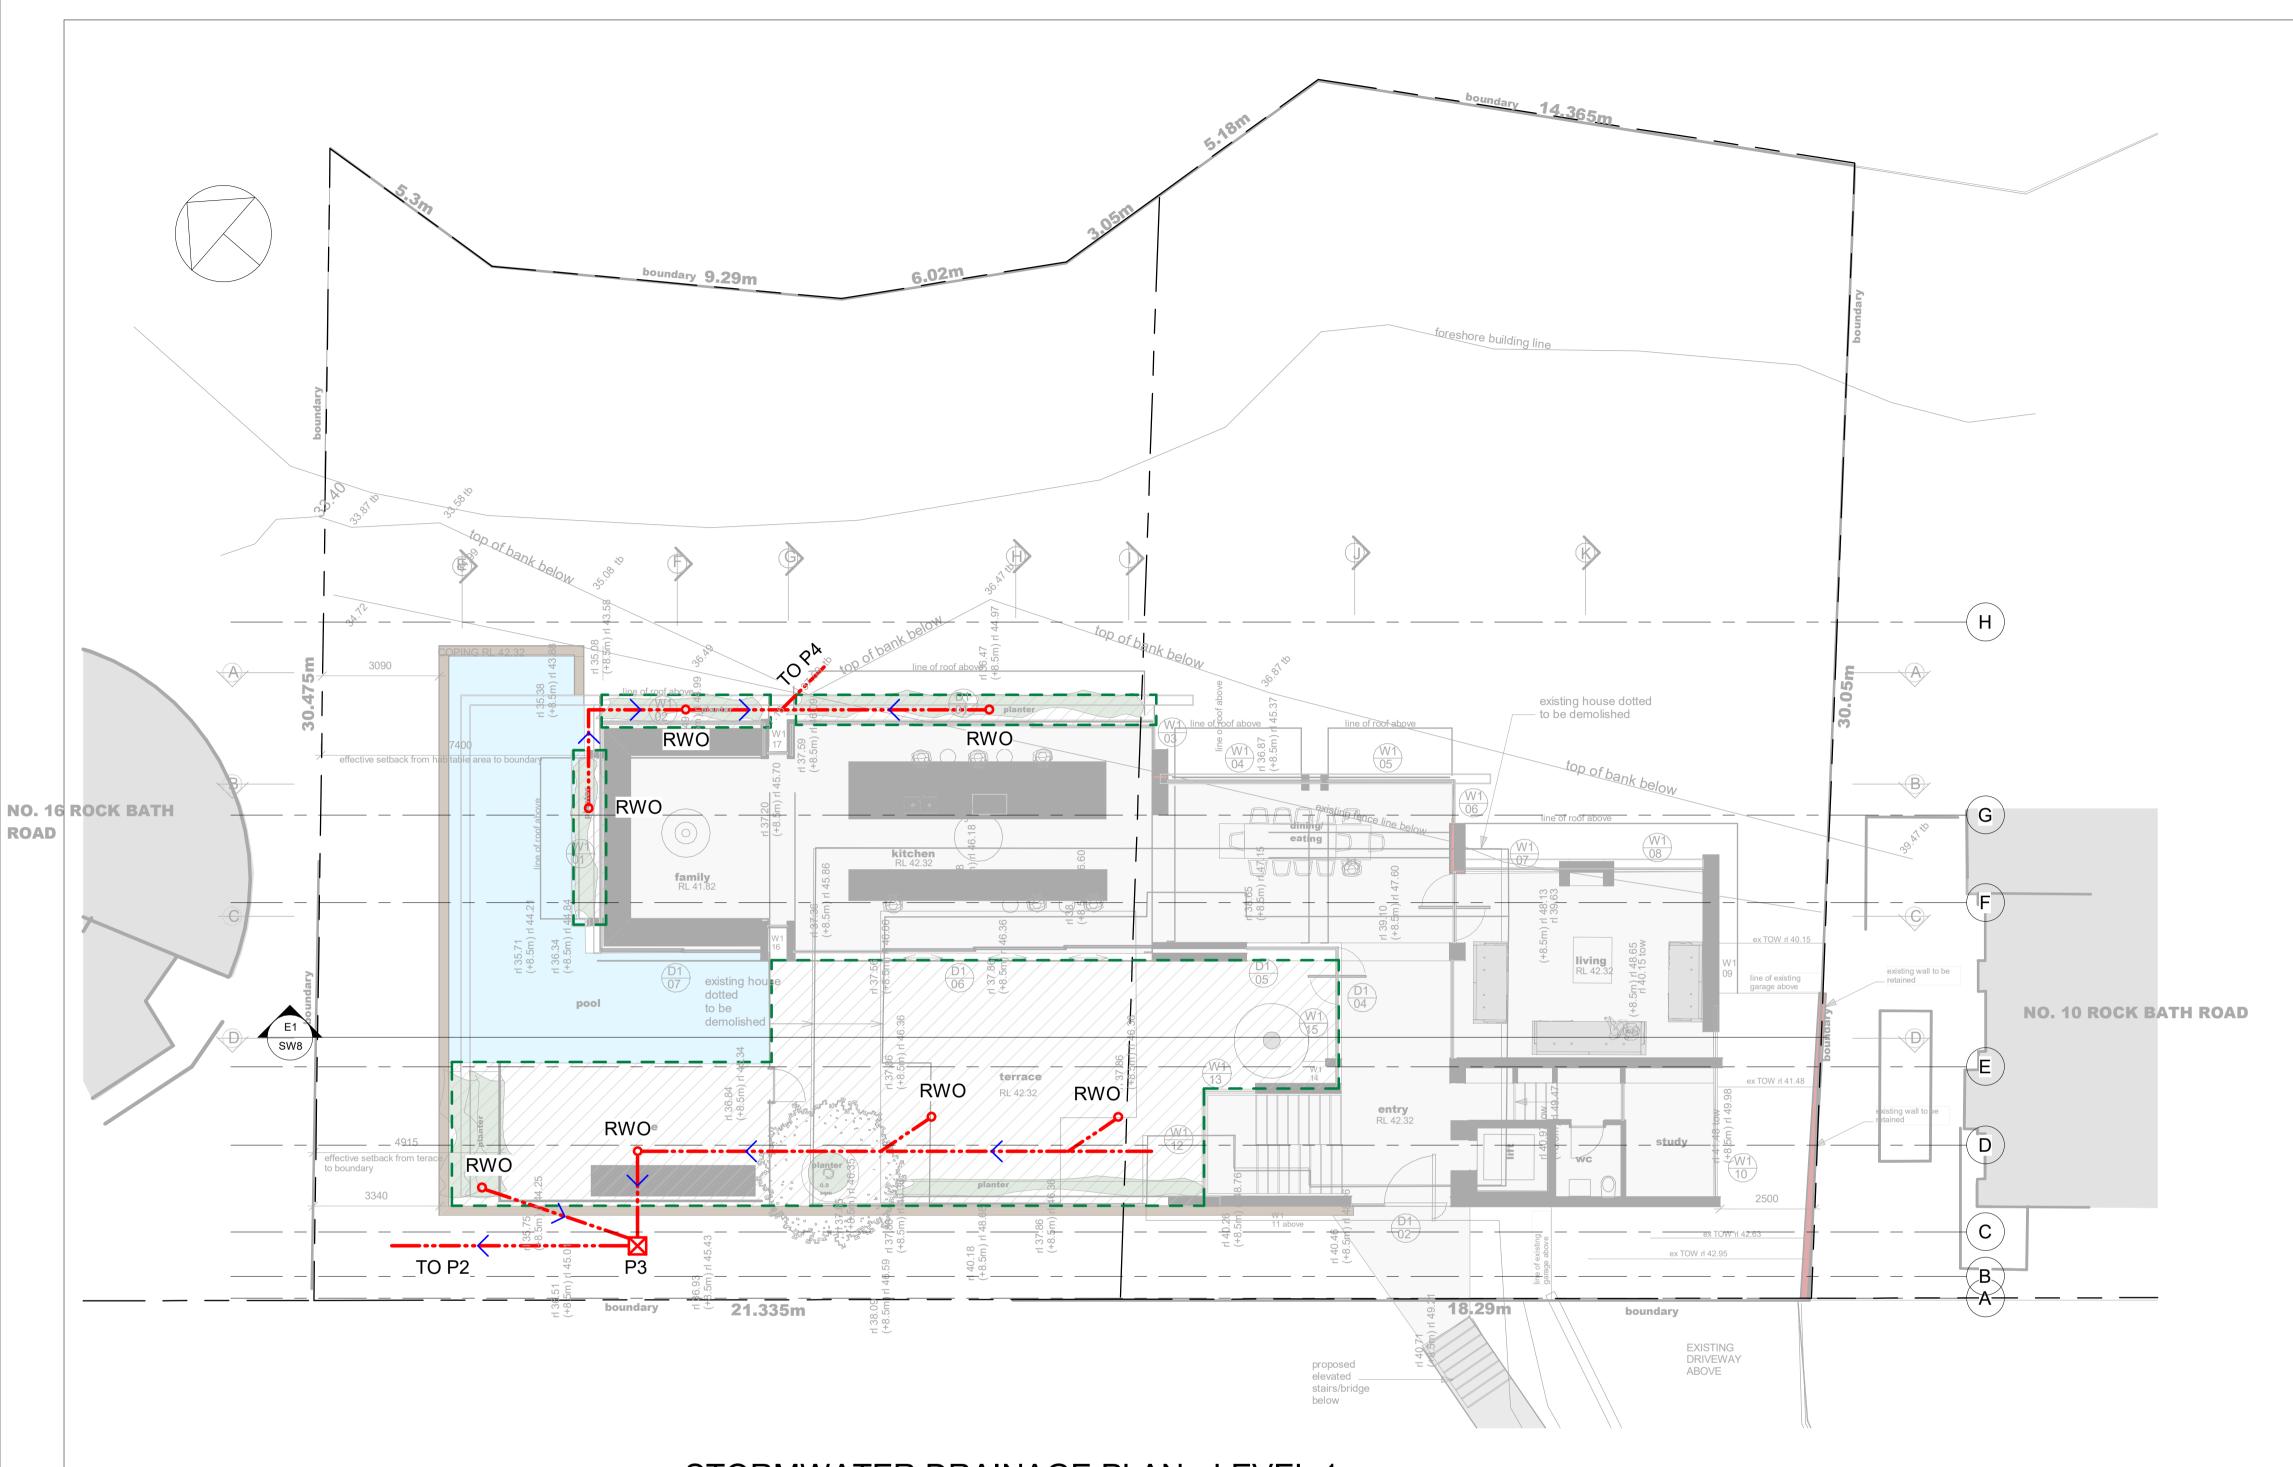
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STORMWATER DRAINAGE PLAN - GROUND FLOOR

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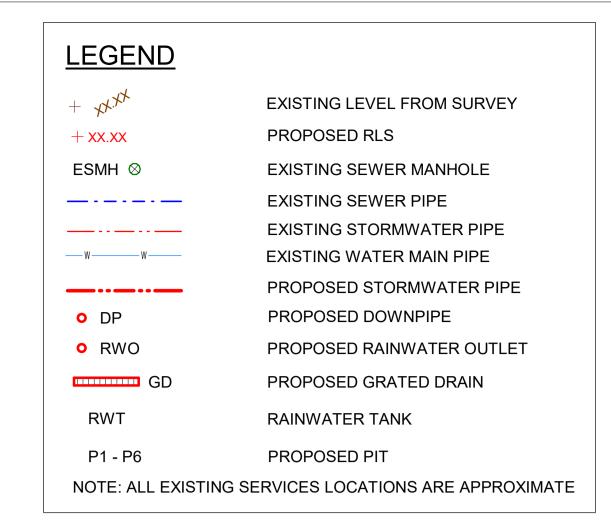


STORMWATER DRAINAGE PLAN - LEVEL 1

SCALE 1: 100 @A1

ALL PIPEWORK TO AS3500 AND LOCAL AUTHORITY REQUIREMENTS 100 UPVC AT MIN 1:100 FALL U.N.O.

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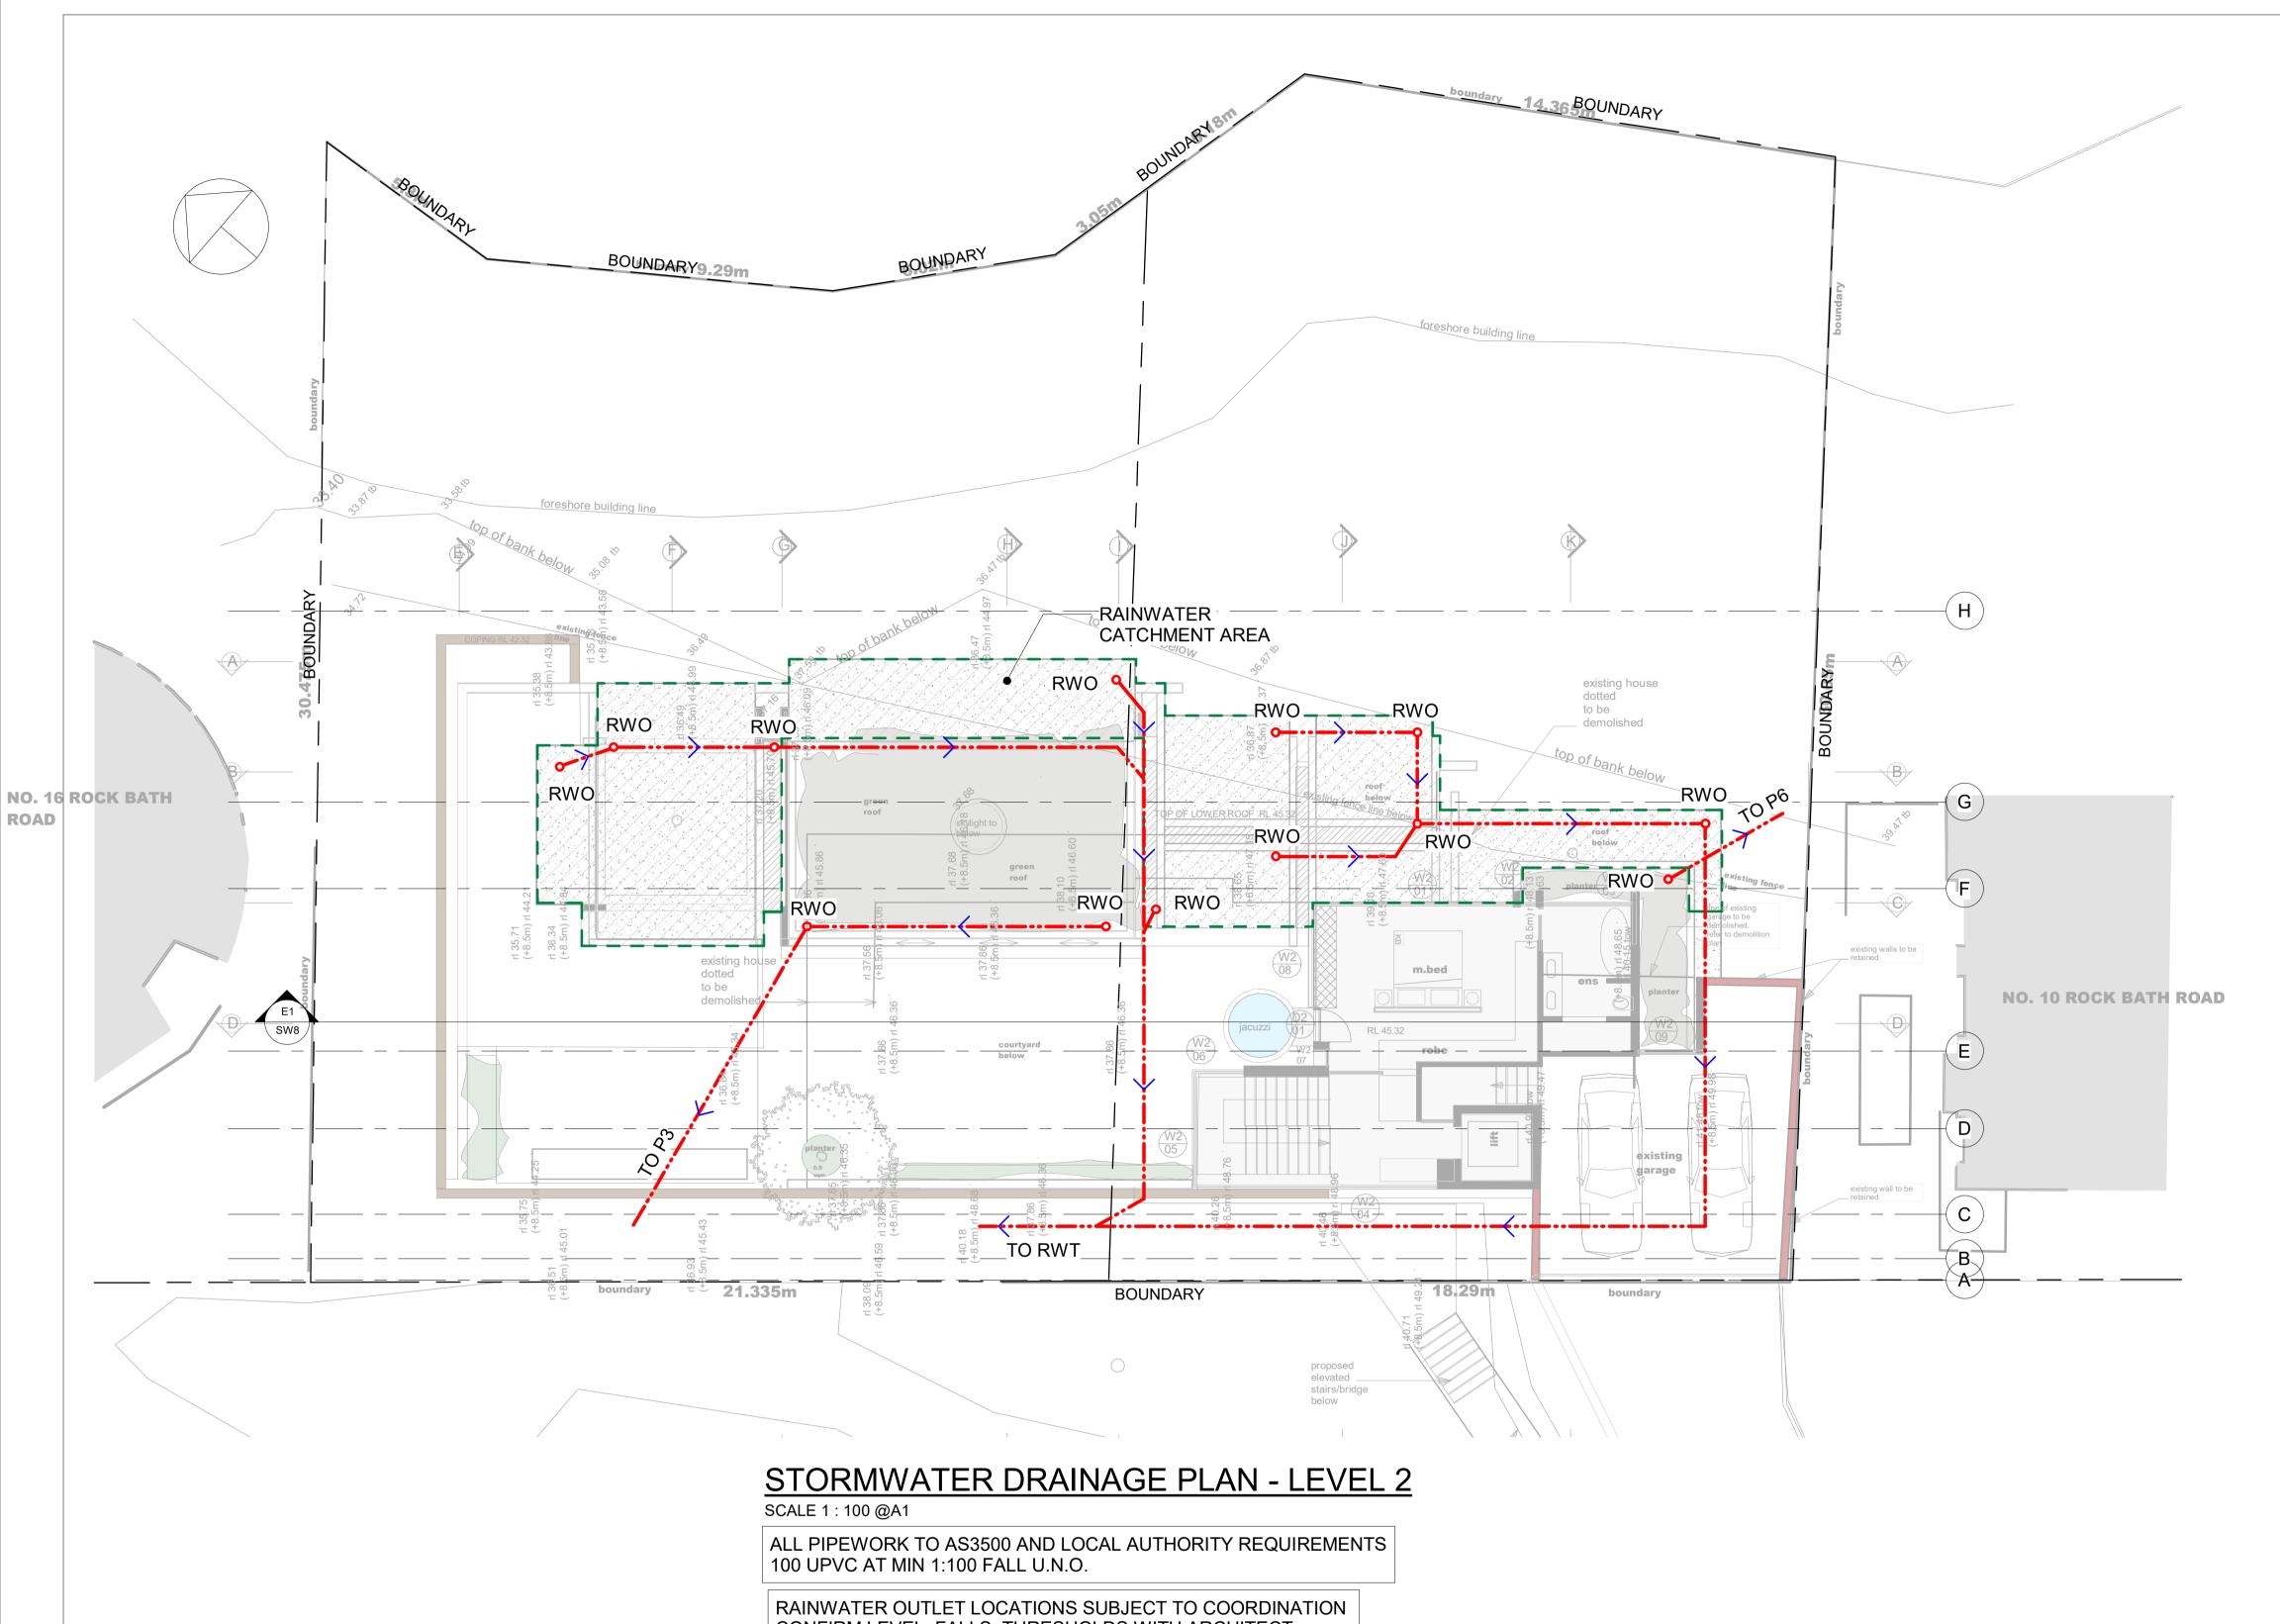
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STORMWATER DRAINAGE PLAN - LEVEL 1

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CONFIRM LEVEL, FALLS, THRESHOLDS WITH ARCHITECT TYPICAL.

LEGEND EXISTING LEVEL FROM SURVEY PROPOSED RLS +xx.xxESMH ⊗ **EXISTING SEWER MANHOLE EXISTING SEWER PIPE** __-_-EXISTING STORMWATER PIPE **EXISTING WATER MAIN PIPE** PROPOSED STORMWATER PIPE PROPOSED DOWNPIPE O DP PROPOSED RAINWATER OUTLET RWO GD PROPOSED GRATED DRAIN RWT RAINWATER TANK PROPOSED PIT NOTE: ALL EXISTING SERVICES LOCATIONS ARE APPROXIMATE

MINIMUM TOTAL ROOF CATCHMENT AREA DRAINING TO RWT REQUIRED BY BASIX 150m²

RAIN WATER CATCHMENT AREA:

120m² FROM LEVEL 2 127m² FROM ROOF TOTAL: 247m²



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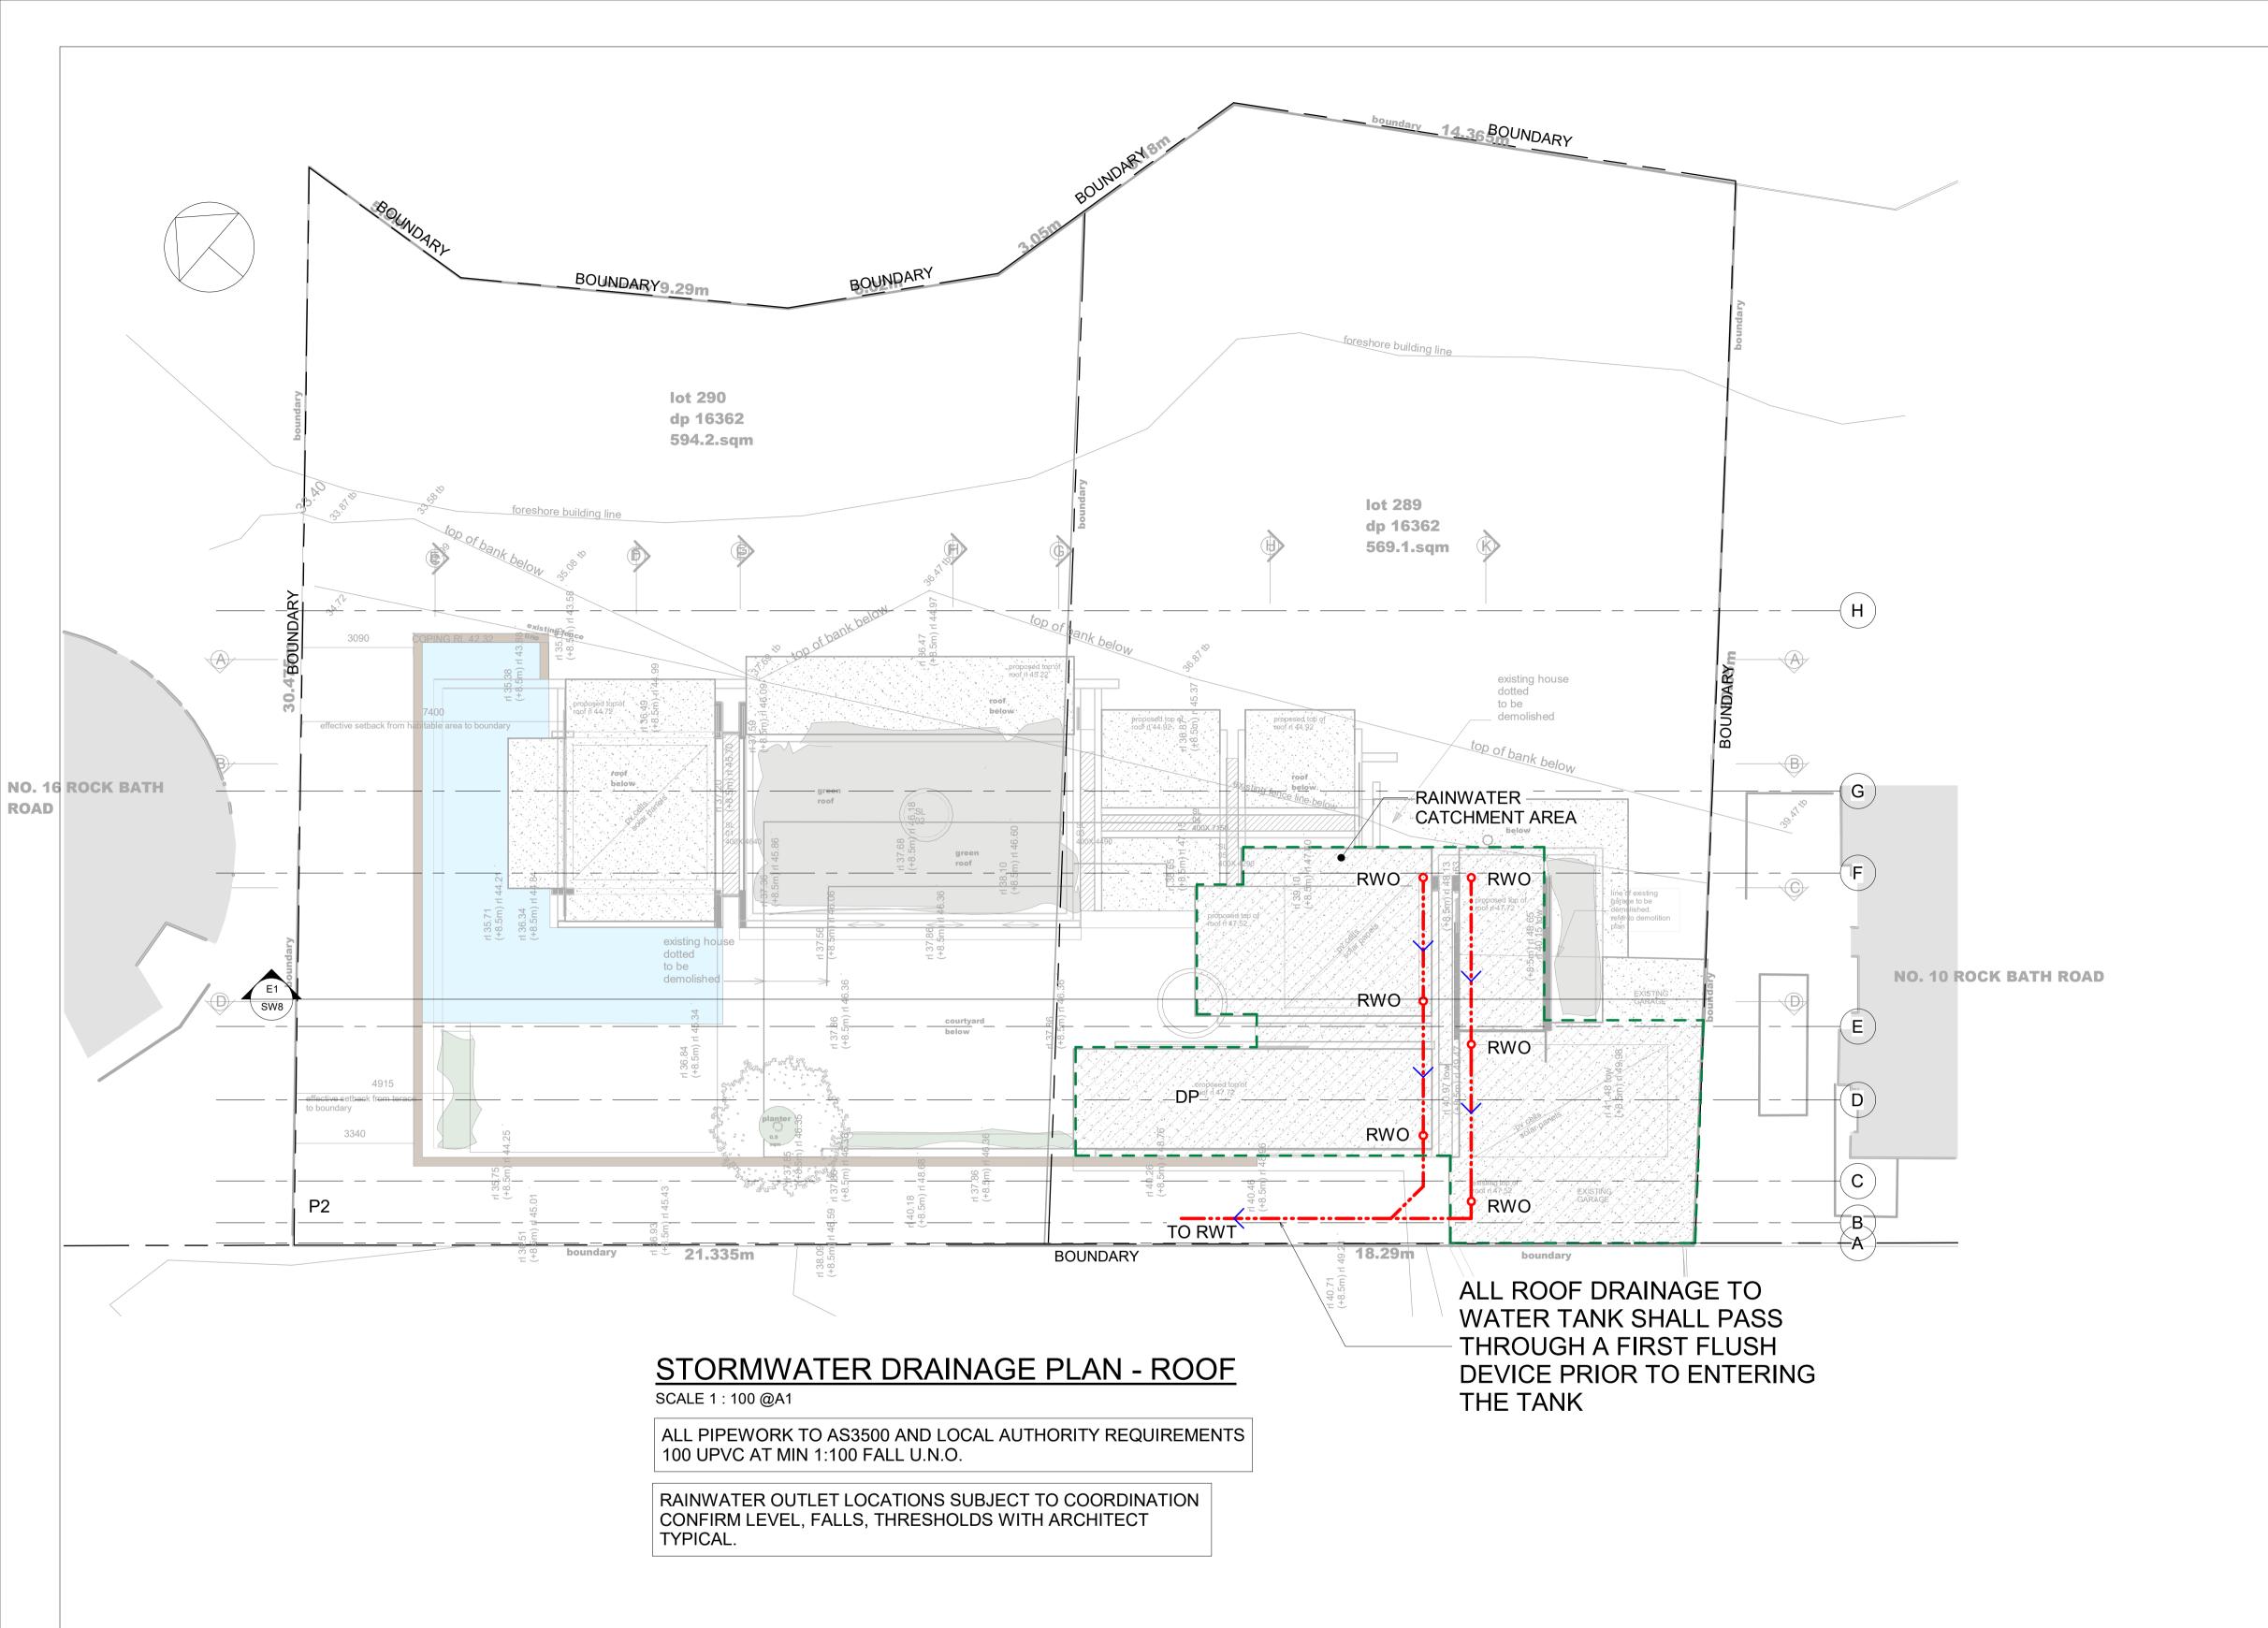
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STORMWATER DRAINAGE PLAN - LEVEL 2

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LEGEND **EXISTING LEVEL FROM SURVEY** PROPOSED RLS +xx.xxESMH ⊗ **EXISTING SEWER MANHOLE EXISTING SEWER PIPE** __-_-EXISTING STORMWATER PIPE **EXISTING WATER MAIN PIPE** PROPOSED STORMWATER PIPE PROPOSED DOWNPIPE O DP RWO PROPOSED RAINWATER OUTLET GD PROPOSED GRATED DRAIN RWT RAINWATER TANK PROPOSED PIT NOTE: ALL EXISTING SERVICES LOCATIONS ARE APPROXIMATE

RWT - 22000L REFER BASIX CERTIFICATE
PROVIDE FILTRATION AND PUMP TO CONNECT TO
OUTLETS AS NOMINATED IN THE BASIX CERTIFICATE
DISPLAY NON POTABLE SIGNAGE AT ALL RWT
SUPPLIED OUTLETS



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STORMWATER DRAINAGE PLAN - ROOF

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