


NOTE:

- NEW DOWNPIPES TO BE CONNECTED INTO NEW DISPERSION TRENCH BY HYDRAULIC ENG.

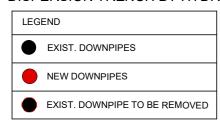

ROOF PLAN & STORMWATER CONCEPT PLAN

TRUE NORTH:

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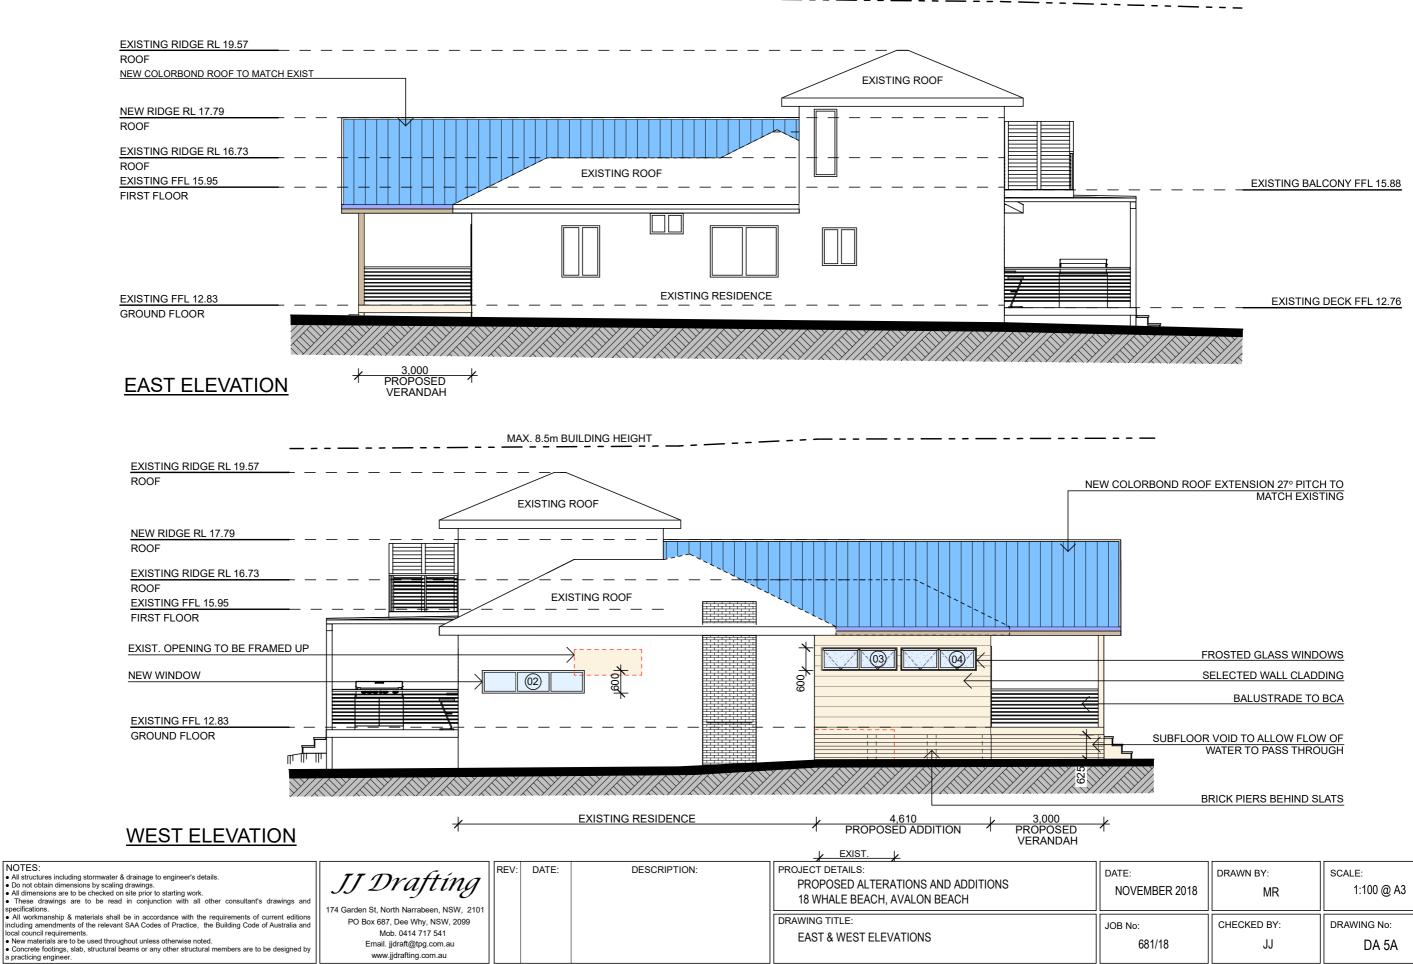
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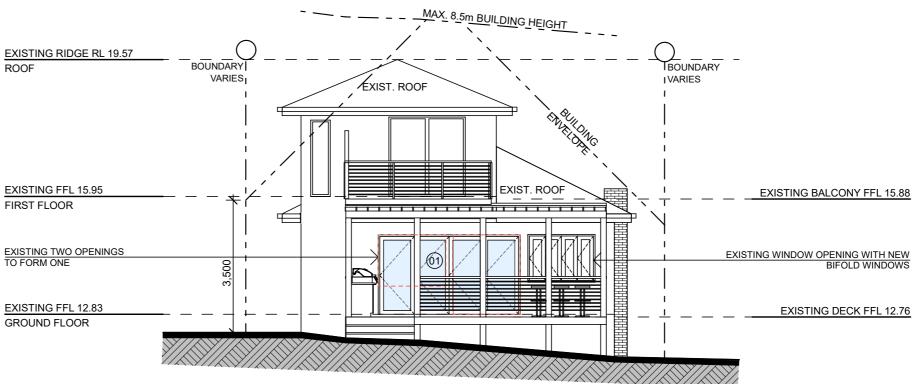
PROJECT DETAILS: PROPOSED ALTERATIONS AND ADDITIONS 18 WHALE BEACH, AVALON BEACH	DATE: NOVEMBER 2018	DRAWN BY:	SCALE: 1:200 @ A3
DRAWING TITLE: ROOF PLAN & STORMWATER CONCEPT PLAN	JOB No: 681/18	CHECKED BY:	DRAWING No: DA 4A




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TRUE NORTH:



NORTH ELEVATION



SOUTH ELEVATION

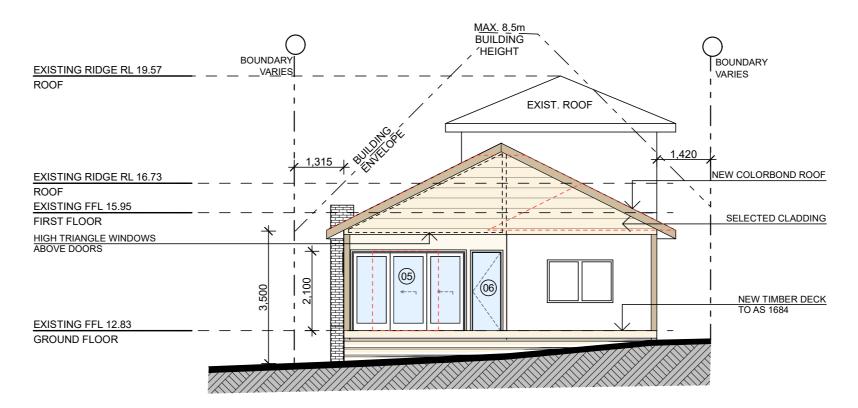

NOTES:

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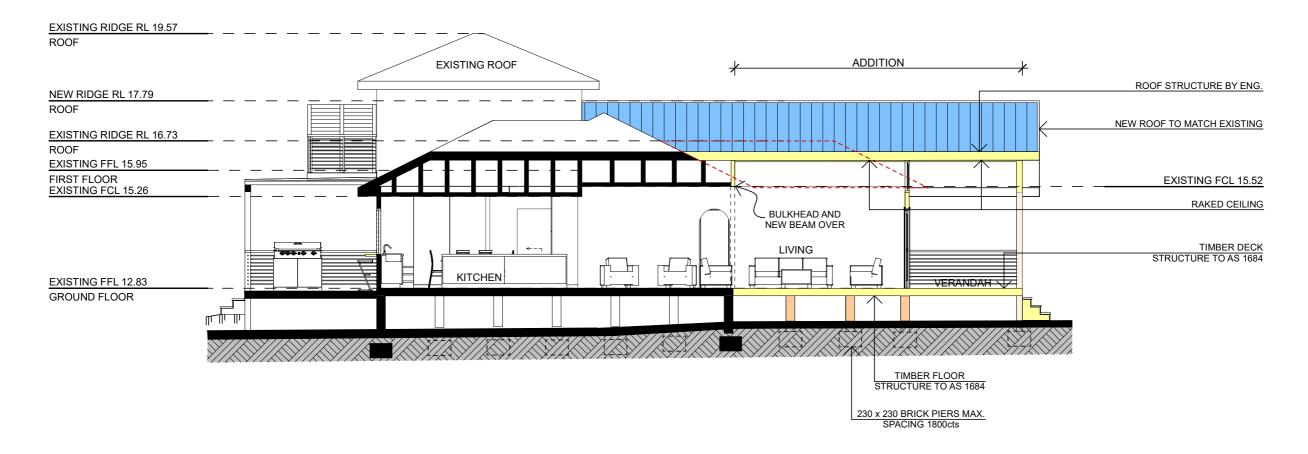
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	PROJECT DETAILS:
	PROPOSED ALTERATIONS AND ADDITIONS
	18 WHALE BEACH, AVALON BEACH
- 1	
	DRAWING TITLE:
	NORTH & SOUTH ELEVATIONS

DATE: NOVEMBER 2018	DRAWN BY:	SCALE: 1:100 @ <i>F</i>
JOB No:	CHECKED BY:	DRAWING No:
681/18	JJ	DA 6A

1:100 @ A3



SECTION AA



SPECIFICATION NOTES:

- LIGHT FRAME WALLS FINISHED OFF WITH SELECTED CLADDING

DOORS AND WINDOWS

- ALUMINIUM FRAMED WINDOWS AND DOORS - WEATHER STRIPPING IS TO BE PROVIDED TO ALL EXTERNAL WINDOWS AND DOORS

- TIMBER FLOOR FRAMING TO BE FINISHED WITH T&G HARDWOOD FLOORING

STORMWATER

- NEW DOWNPIPES TO BE CONNECTED INTO NEW DISPERSION TRENCH

ROOFING

- COLORBOND ROOF CLADDING

GUTTERS AND DOWNPIPES

- COLORBOND GUTTERS AND DOWNPIPES - MINIMUM SLOPE OF EAVES AND GUTTERS 1:200

FLASHING AND CAPPINGS

- SELECTION AND INSTALLATION OF METAL RAINWATER GOODS REFER TO AS2180
- FLASH PROJECTIONS ABOVE THE ROOF WITH TWO PART FLASHINGS CONSISTING OF AN APRON FLASHING AND OVER FLASHING, WITH AT LEAST 100mm OVERLAP. - PROVIDE FOR INDEPENDENT MOVEMENT BETWEEN

ROOF AND PROJECTION TERMITE CONTROL

- TO AS3660.1

TIMBER FRAMING

- USE TREATED TIMBER WHERE REQUIRED FOR DURABILITY
- DO NOT USE TIMBER UNSUITABLE FOR EXPOSURE TO MOISTURE IN EXPOSED LOCATION
- ALL WORKMANSHIP AND MATERIALS SHALL BE IN ACCORDANCE WITH AS1684 AND 1720 AS APPLICABLE - PROVIDE STRUCTURE BRACING IN ACCORDANCE WITH AS1684
- PROVIDE STRUCTURE TIEDOWN IN ACCORDANCE WITH AS1684
- USE GALVANISED FIXINGS WHERE EXPOSED TO WEATHER

CONCRETE

- ALL WORKMANSHIP AND MATERIALS SHALL BE IN ACCORDANCE WITH CURRENT EDITIONS OF THE AS3600
- FOOTINGS TO BE IN ACCORDANCE WITH AS1480 - ALL REINFORCEMENTS SHALL CONFORM TO AS1302, AS1303 AND AS1304

INTERNAL LININGS

- PROVIDE PLASTERBOARD LINING

SMOKE ALARMS

- CONNECT TO CONSUMER MAINS POWER AND INSTALL TO AS1670.6. 1997 (fire detection, warning control and intercom systems - systems design, installational commissioning - smoke alarms) and as3786 -1996 (smoke alarms)

WASTE MANAGEMENT

- ALL WASTE SHALL BE TAKEN AWAY BY TRUCKS TO A SUITABLE LANDFILL OR RECYCLE DEPOT
- ALL WASTE SHALL BE COVERED DURING TRANSPORTATION
- WASTE GENERATED DURING CONSTRUCTION SHALL BE PLACED IN STEEL BINS AND TAKEN AWAY BY AN APPROVED CONTRACTOR TO A APPROVED LANDFILL SITE

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SEDIMENT CONTROL

- A FILTER CLOTH SYSTEM SHALL BE INSTALLED TO STOP ANY SEDIMENT ENTERING COUNCILS STORMWATER SYSTEM

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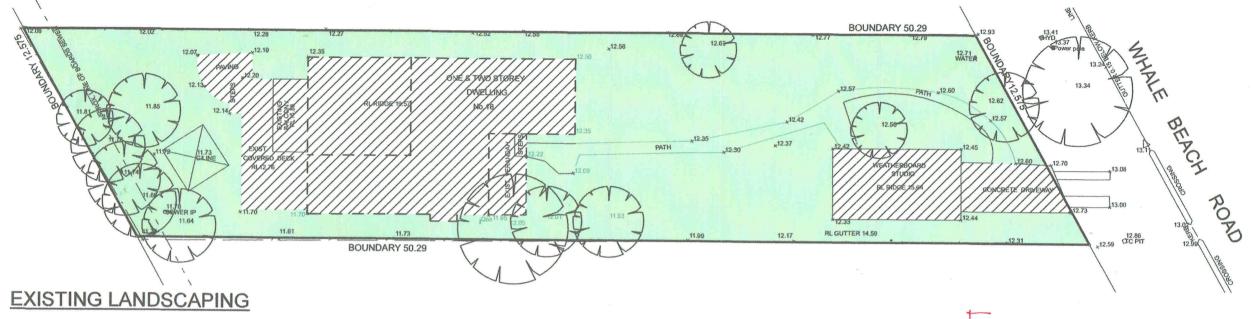
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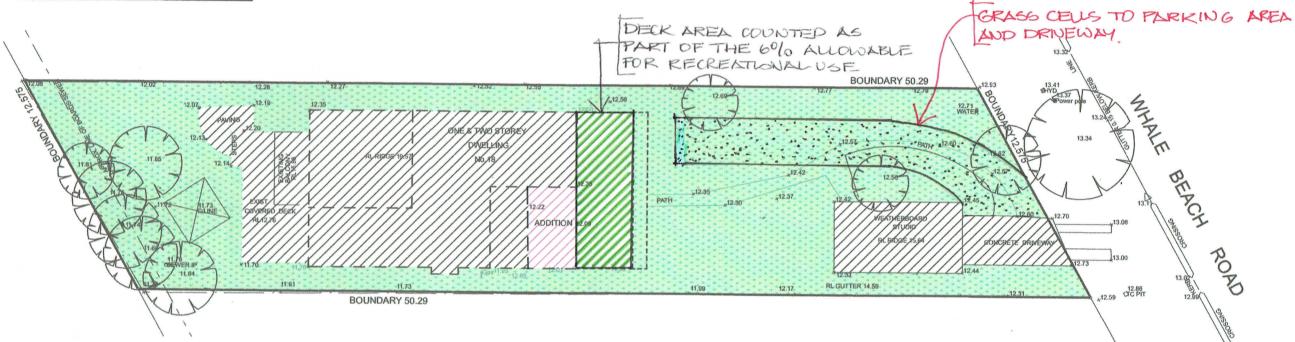
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PROJECT DETAILS:
PROPOSED ALTERATIONS AND ADDITIONS
18 WHALE BEACH, AVALON BEACH
DRAWING TITLE:

ROJECT DETAILS: PROPOSED ALTERATIONS AND ADDITIONS 18 WHALE BEACH, AVALON BEACH	DATE: NOVEMBER 2018	DRAWN BY:	SCALE: 1:100 @ A	
RAWING TITLE: SECTION AA	JOB No:	CHECKED BY:	DRAWING No:	
SECTION AN	681/18	JJ	DA 7A	





PROPOSED LANDSCAPING

	The Court of the C	
CALCULATIONS		
SITE AREA		553.30 m ²
LANDSCAPE CONTROL	MIN. 50%	276.65 m ²
EXISTING LANDSCAPE AREA	68.85%	380.97 m ²
NEW LANDSCAPE AREA INCLUDES 6% OF SITE AREA TO OUTDOOR RECREATIONAL USE	57.5%	318-195m ²
EXISTING HARD SURFACE AREA		172.33 m²
NEW HARD SURFACE AREA		(10·775 m²)
TOTAL NEW HARD SURFACE		183.105m²

LANDSCAPED CALCULATION PLAN



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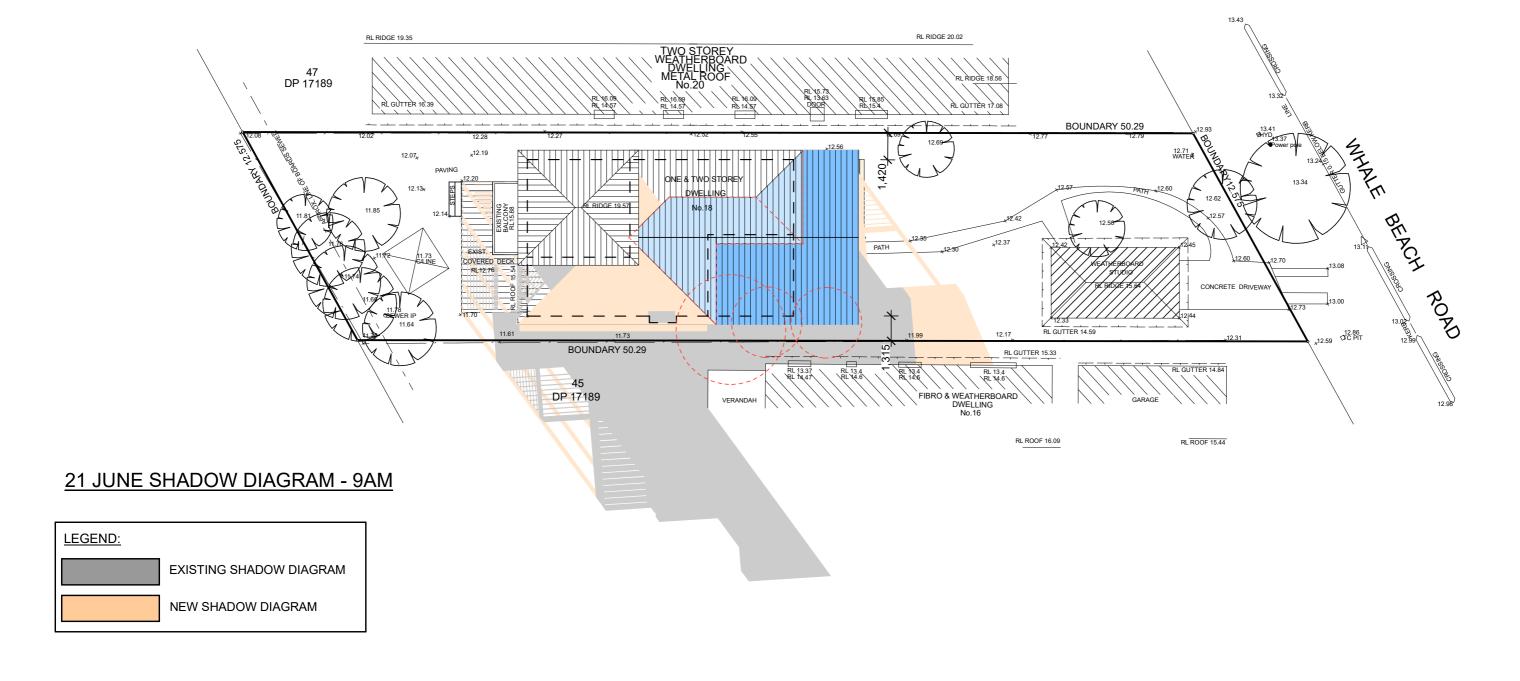
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PROJECT DETAILS: PROPOSED ALTERATIONS AND ADDITIONS 18 WHALE BEACH, AVALON BEACH	DATE: NOVEMBER 2018	DRAWN BY:	SCALE: 1:200 @ A3
DRAWING TITLE: LANDSCAPE OPEN SPACE CALCULATION PLAN	JOB No: 681/18	CHECKED BY:	DRAWING No:







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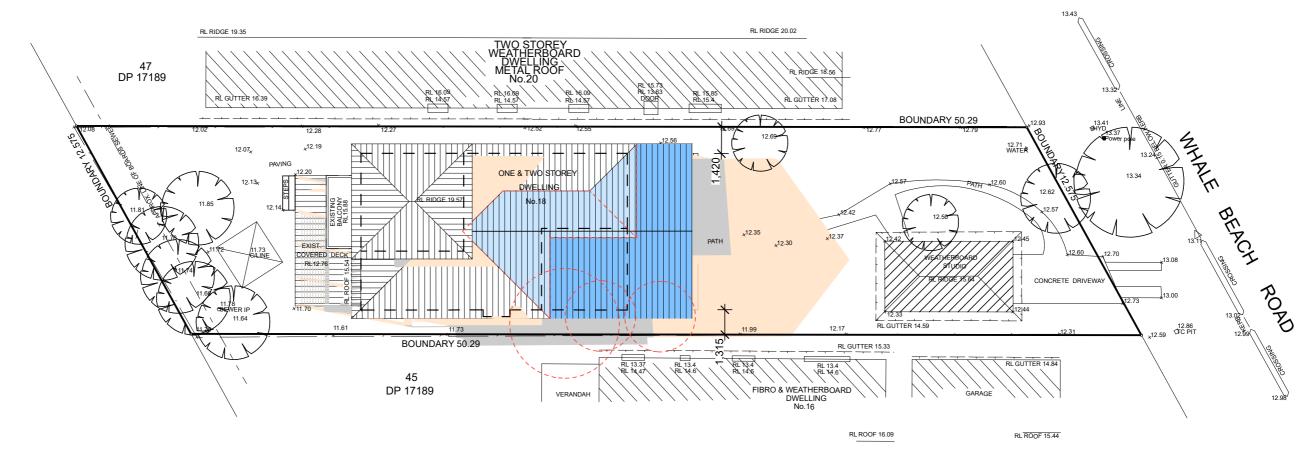
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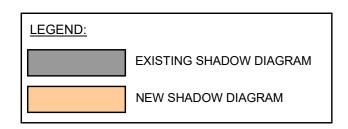
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PROJECT DETAILS: PROPOSED ALTERATIONS AND ADDITIONS 18 WHALE BEACH, AVALON BEACH	DATE: NOVEMBER 2018	DRAWN BY:	SCALE: 1:200 @ A3
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21 JUNE SHADOW DIAGRAM - 12NOON



TRUE NORTH:

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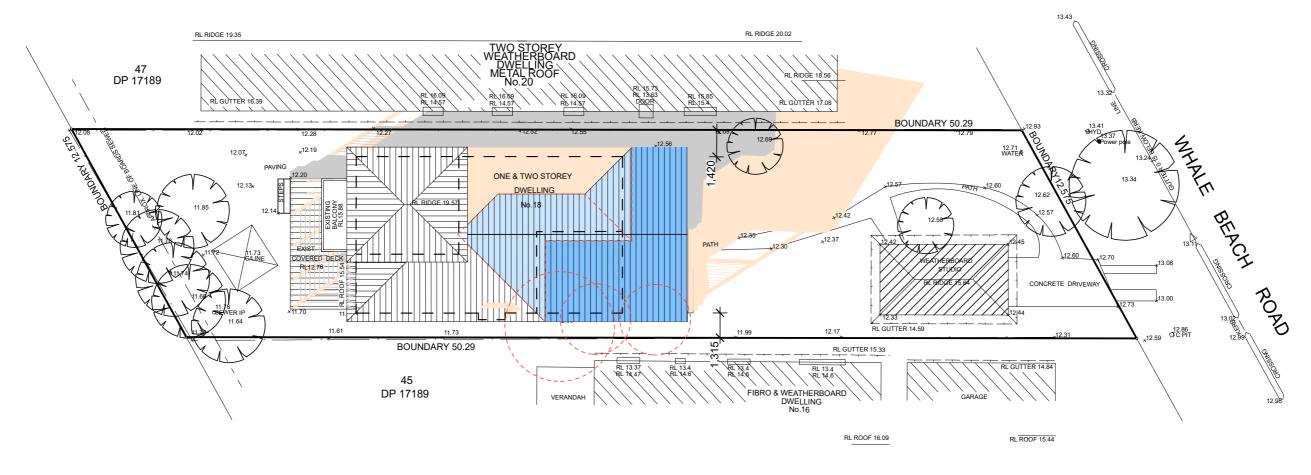
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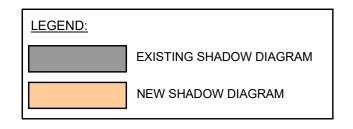
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DRAWING TITLE: JUNE 21_12NOON	JOB No: 681/18	CHECKED BY:	DRAWING No:



21 JUNE SHADOW DIAGRAM - 3PM





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DRAWING TITLE: JUNE 21_3PM	JOB No: 681/18	CHECKED BY:	DRAWING No:

Designated Site Manager/Builder

PRIOR TO COMMENCEMENT OF WORK A SITE MANAGER OR BUILDER MUST BE NOMINATED. THE SITE MANAGER OR BUILDER WILL BE RESPONSIBLE AND LIABLE FOR ALL WORKS CARRIED OUT ON THE SITE. THIS ASSUMES THE RESONSIBILITY FOR THE ACTIONS OF ALL SUBCONTRACTED PARTIES AS WELL AS ADVISING THEM OF COUNCIL'S REQUIREMENTS WHEN CARRYING OUT WORKS.

Topsoil Management

PRIOR TO THE STRIPPING OF TOPSOIL, THE VEGETATIVE COVER MUST BE REDUECED BY EITHER SLASHING OR MOWING.

ALL TOPSOIL IS TO BE RETAINED AND PROTECTED FOR REUSE ON SITE. SOIL STOCKPILES MUST NOT BE LOCATED ON NATURE STRIPS, FOOTPATHS, ROADWAYS, KERBS, ACCESSWAYS, WITHIN DRAINAGE LINES/FLOWS/PATHS OR AROUND OR AGAINST TREE SHRUBS.

SEDIMENT CONTROL MEASURES MUST BE INCORPORATED WITH ANY RESULTING STOCKPILE. THE STOCKPILE CAN BE PROTECTED FROM EROSION BY COVERING IT WITH AN IMPERVIOUS MATERIAL, IN CONJUNCTION WITH THE INSTALLATION OF A SEDIMENT FENCE AROUND IT.

IF STOCKPILES ARE TO REMAIN FOR MORE THAN ONE MONTH THEY ARE TO BE GRASSED IMMEDIATELY AND STABILISED WITHIN FOURTEEN DAYS. SURPLUS TOPSOIL MUST BE REASONABLY REMOVED FROM SITE.

Builidng Material Stockpiling

SUFFICIENT AREA MUST BE ALLOCATED WITHIN THE SITE FOR SUCH STORAGE OF BUILDING MATERIALS, DEMOLITION WASTE, WASTE CONTAINERS, ETC. AS WILL BE REQUIRED

Sediment Fences

A SEDIMENT FENCE SHOULD BE LOCATED ALONG THE DOWNSLOPE BOUNDARY(S)OF THE SITE. ON THE CONSTRUCTION SIDE OF THE TURF FILTER STRIP OR NATIVE VEGETATION. AND AROUND ALL STOCKPILES OF MATERIAL ON THE SITE.

Dust Control

ALL TRUCKS/UTES MUST COVER THEIR LOADS AT ALL TIMES. APPROPRIATE METHODS ARE TO BE EMPLOYED TO PREVENT BLOWING DUST CREATING AN UNACCEPTABLE HAZARD OR NUISANCE ON THE SITE OR DOWN WIND. PRODUCTION OF DUST CAN BE MINIMISED BY LIMITING AREA OF EARTHWORKS, WATERING AND PROGRESSIVE VEGETATION. WHERE DUST IS CREATED AS A RESULT WORKS AND/OR SOIL EXPOSURE, THE BARE SOIL AREAS MUST BE WATERED, DURING AND/OR AT THE END OF EACH DAY TO LAY THE DUST

EARTH MOVONG ACTIVITIES SHOULD BE AVOIDED WHERE WINDS ARE SUFFICIENTLY STRONG ENOUGH TO RAISE VISIBLE DUST.

Erosion & Sediment Controls

APPROPRIATE EROSION AND SEDIMENT CONTROLS MUST BE IMPLEMENTED ON ALL SITES THAT INVOLVE SOIL DISTURBANCE, THE MEASURES MUST BE IN PLACE PRIOR TO THE COMMENCEMENT OF WORK.

THOSE CONTROLS ARE TO BE MONITORED AND MAINTAINED IN ORDER TO SERVE THEIR INTENDED FUNCTION FOR THE DURATION OF THW WORKS OR UNTIL SUCH TIME AS THE SITE IS FULLY STABILISED. IF ANY CONTROLS ARE DAMAGED OR BECOME INFEFECTIVE DURING THE COURSE OF THE WORKS THEY ARE TO BE REINSTATED OR REPLACED IMMEDIATELY. SUFFICIENT ACCESS TO THESE CONTROLS MUST BE PROVIDED IN CASE OF THE NEED TO REPAIR.


Sediment Traps

WHERE A SEDIMENT FENCE IS NOT USED APPROPRIATE SEDIMENT TRAPS SHOULD BE LOCATED AT ALL POINTS WHERE STORMWATER LEAVES THE CONSTRUCTION SITE OR LEAVES THE GUTTER AND ENTERS THE DRAINAGE SYSTEM. A COMMON TECHNIQUE IS THE GRAVEL SAUSAGE.


Diversion Channels

A DIVERSION CHANNEL IS AN EXCAVATED EARTH DITCH OR PATH. THESE STRUCTURES AREE USED TO INTERCEPT AND DIRECT RUN-OFF TO A DESIRED LOCATION WHERE POSSIBLE.

ALL STORMWATER RUN-OFF FLOWING ONTO DISTURBED AREAS, INCLUDING STOCKPILES, MUST BE INTERCEPTED, DIVERTED AND/OR SAFELY DISPOSED OF, THIS CAN BE ACHIVED BY CONSTRUCTING A TEMPORARY EARTH BANK AROUND THE UPSLOPE EXTENT OF THE CONSTRUCTION SITE WHERE THE DIVERSION DOES NOT AFFECT THE NEIGHBOURING PROPERTIES.

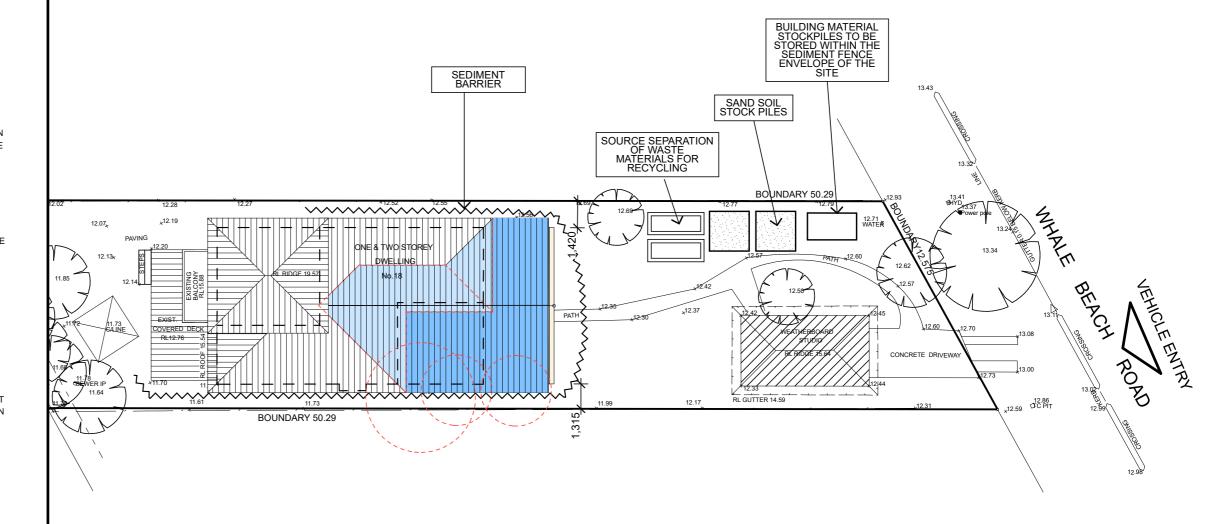

EROSION AND SEDIMENT CONTROL & WASTE MANAGEMENT PLAN

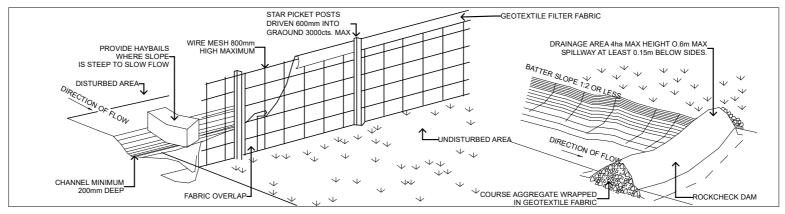

TYPICAL SEDIMENT FENCE SCALE NTS

TYPICAL DIVERSION CHANNEL

SCALE NTS

Vehicle Movements

INTO THE STORMWATER SYSTEM.

TO LIMIT DISTURBANCE TO THE SITE AND TRACKING OF MATERIAL ONTO THE STREET ALL VEHICLES AND PLANT EQUIPMENT ARE TO USE A SINGLE ENTRY/EXIT POINT UNLESS COUMCIL HAS APPROVED ALTERNATIVE ARRANGEMENTS.

ACCESS POINTS AND APRKING AREAS ARE TO BE STABILISED WITH COMPACTED SUB-GRADE AS SOON AS POSSIBLE AFTER THEIR FORMATION. WHERE SPILLAGE DOES OCCUR IT IS TO BE CONTAINED IMMEDIATELY AND CAREFULLY REMOVED. THE AREA AFFECTED IS TO BE RESTORED TO A STANDARD EQUAL TO OR BETTER THAN ITS PREVIOUS CONDITION. ALL VEHICLES ARE TO BE WASHED PRIOR TO EXISTING THE SITE. THIS SERVES THE PURPOSE OF REMOVING SITE MATERIAL ON THE VEHICLE AND PREVENTS IT FROM BEING DEPOSITED ON THE ROAD NETWORK ADJACENT TO THE SITE AND THUS, THE STORWATER SYSTEM. ALL POLLUTED WATER MUST BE RETAINED ON SITE FOR TREATMENT BEFORE IT IS DISCHARGED

NO VEHICLE ASSOCIATED WITH THE WORK IS TO BE PARKED ON A FOOTPATH

ALL VEHILCES VISITING THE SITE DURING DEMOLITION, EXCAVATION AND/OR CONSTRUCTION WORKS, ARE TO COMPLY WITH THE PARKING REQUIREMENTS

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DATE: DRAWN BY: SCALE: NOVEMBER 2018 MR CHECKED BY DRAWING No: JJ