





ADDRESS: 8 JENDI AVENUE BAYVIEW


BALCONY UPGRADE + ADDITION

DRAWN: DRAWING TITLE: CHECKED: P + C HEAL SITE PLAN + SITE ANALYSIS SCALE: 1:200

- budget, to engineers for engineering (26.3.21), issued to Town Planner for submission (dated 7.4.21).
- C. Boundaries added to plans, site plan updates as per council request.

07.04.21 12.05.21

DRAWING No: 1 / 13

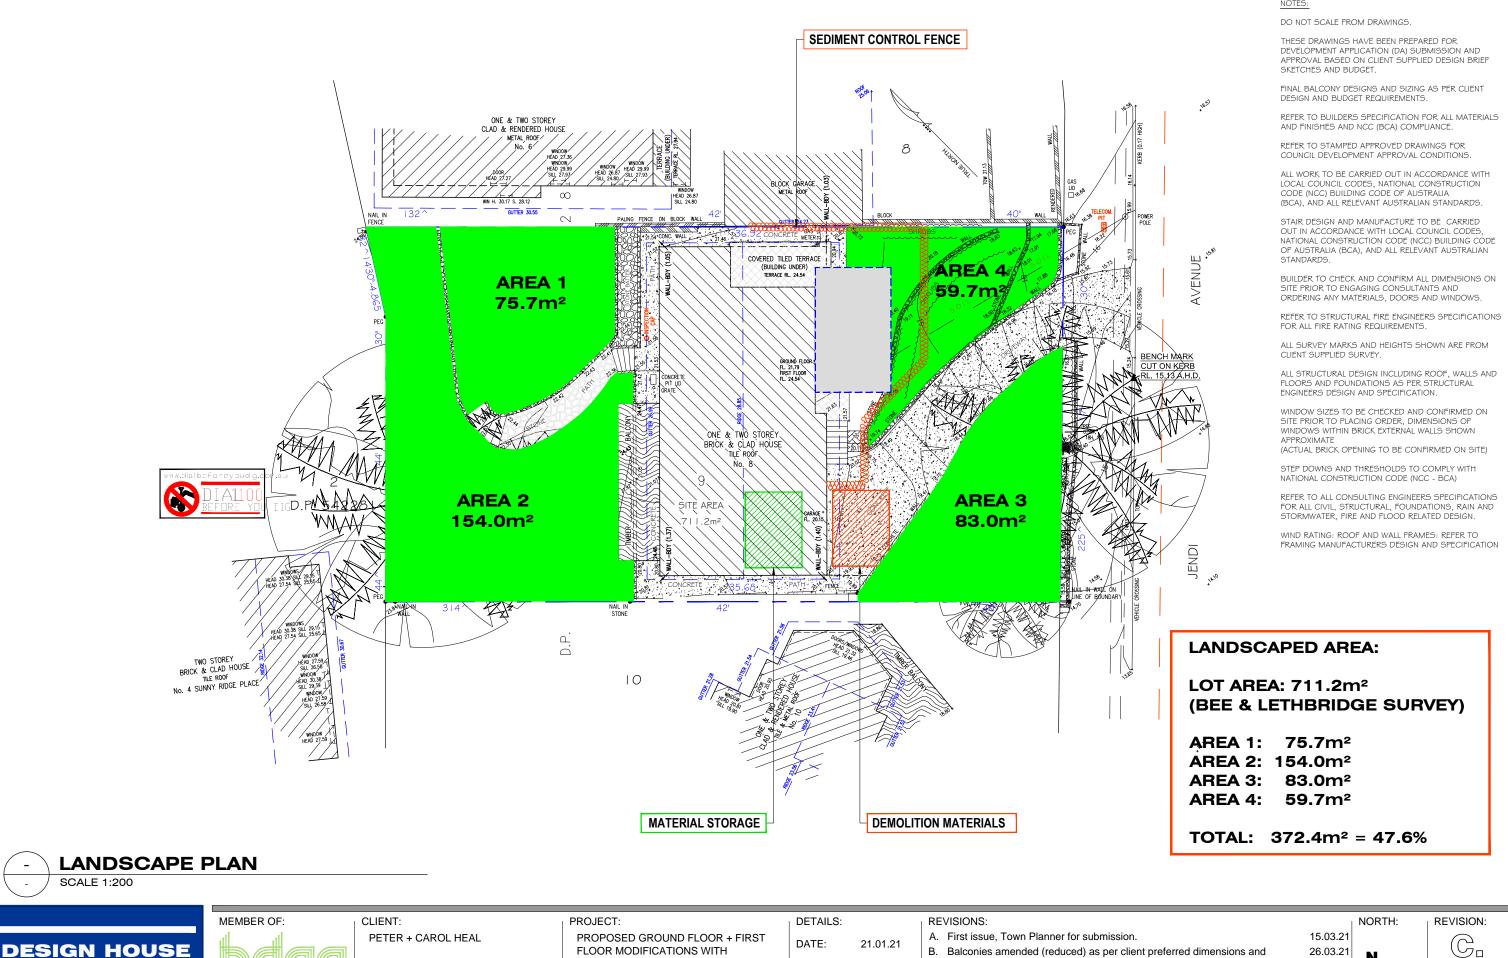





PETER + CAROL HEAL

ADDRESS: 8 JENDI AVENUE

BAYVIEW

PROPOSED GROUND FLOOR + FIRST FLOOR MODIFICATIONS WITH BALCONY UPGRADE + ADDITION

DRAWING TITLE: LANDSCAPE PLAN, EROSION AND SEDIMENT CONTROL + WASTE MANAGEMENT

DATE: 21.01.21

1:200

DRAWN: B.BENCH CHECKED: P + C HEAL

SCALE:

A. First issue, Town Planner for submission.

B. Balconies amended (reduced) as per client preferred dimensions and budget, to engineers for engineering (26.3.21), issued to Town Planner for submission (dated 7.4.21).


C. Boundaries added to plans, site plan updates as per council request.

26.03.21

07.04.21

12.05.21

DRAWING No: 2 / 13

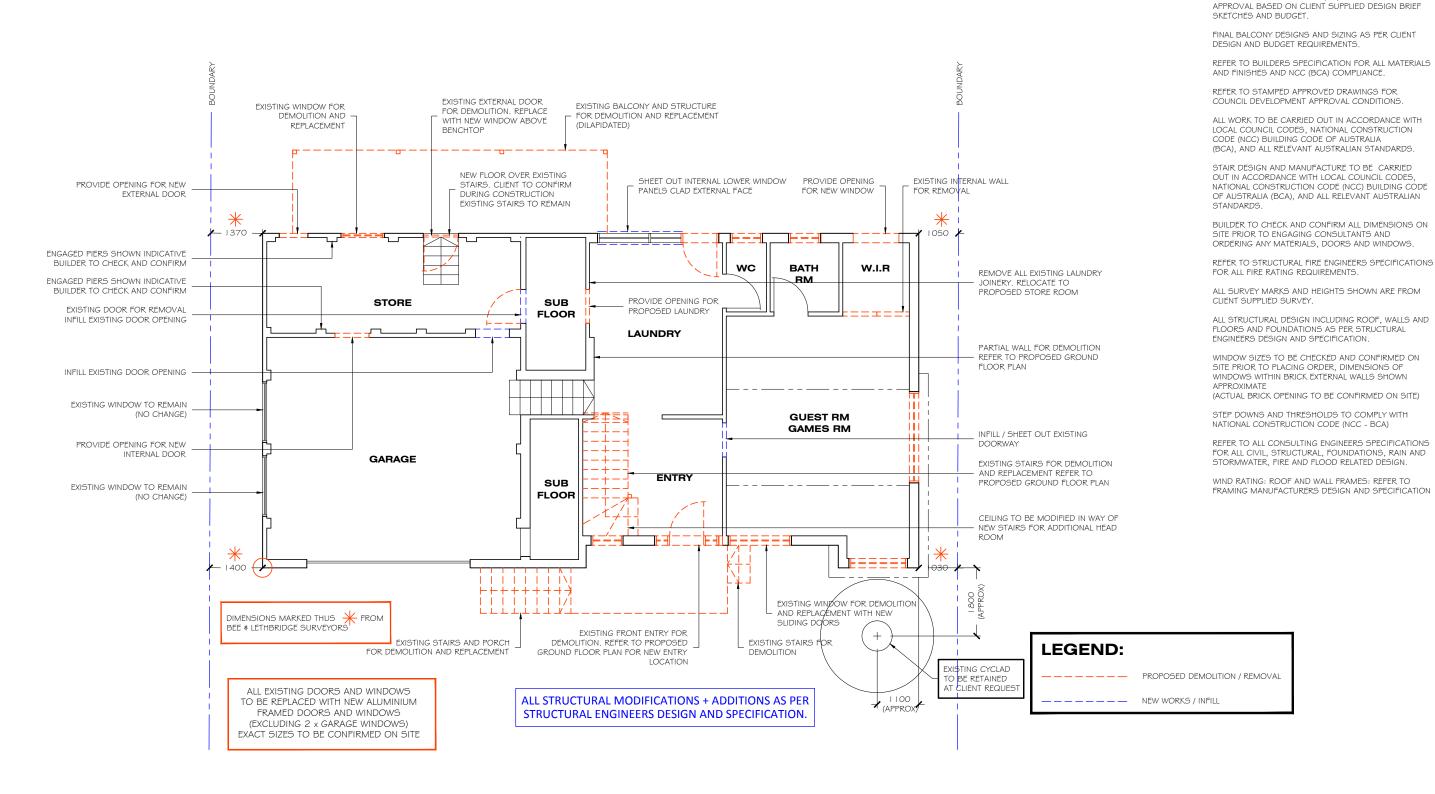



LOWER GROUND + GROUND FLOOR PLAN - EXISTING + DEMOLITION

SCALE 1:100





PETER + CAROL HEAL

ADDRESS: 8 JENDI AVENUE BAYVIEW

PROPOSED GROUND FLOOR + FIRST FLOOR MODIFICATIONS WITH **BALCONY UPGRADE + ADDITION** DRAWING TITLE: LOWER GROUND + GROUND FLOOR

EXISTING + PROPOSED DEMOLITION

DETAILS: DATE: 21.01.21 DRAWN: **B.BENCH** CHECKED: P + C HEAL SCALE: 1:100

- A. First issue, Town Planner for submission.
- B. Balconies amended (reduced) as per client preferred dimensions and budget, to engineers for engineering (26.3.21), issued to Town Planner for submission (dated 7.4.21).
- C. Boundaries added to plans, site plan updates as per council request.

15.03.21 26.03.21

07.04.21

12.05.21

NOTES:


DO NOT SCALE FROM DRAWINGS

THESE DRAWINGS HAVE BEEN PREPARED FOR DEVELOPMENT APPLICATION (DA) SUBMISSION AND

NORTH:

REVISION:

DRAWING No: 3 / 13

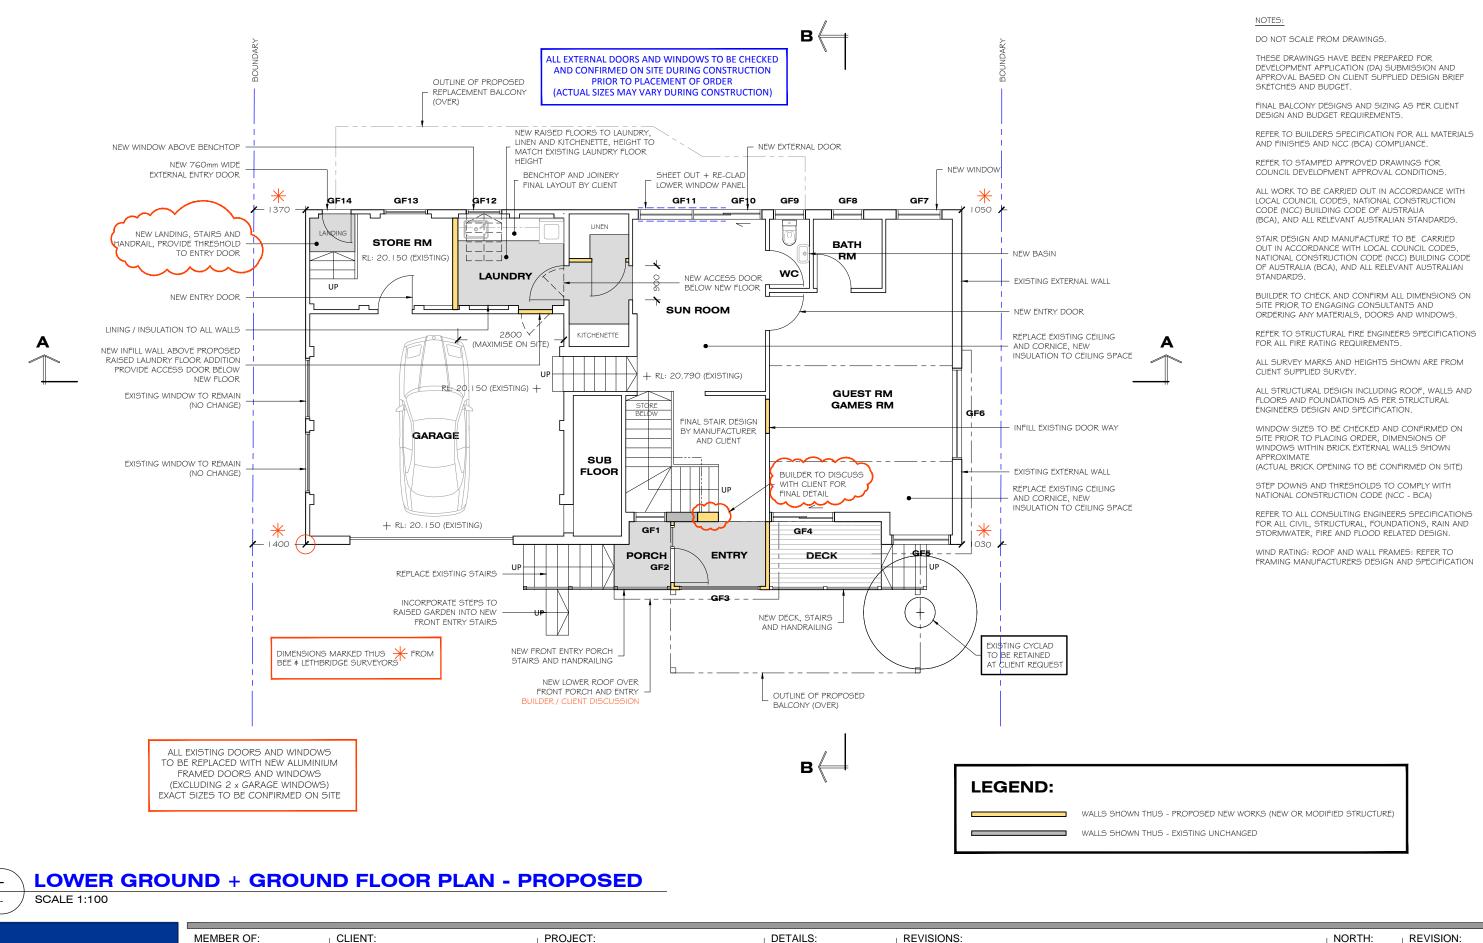





ASSOCIATION OF AUSTRALIA

PETER + CAROL HEAL

ADDRESS: 8 JENDI AVENUE BAYVIEW

PROPOSED GROUND FLOOR + FIRST FLOOR MODIFICATIONS WITH **BALCONY UPGRADE + ADDITION** DRAWING TITLE:


DATE: 21.01.21 DRAWN: B.BENCH CHECKED: P + C HEAL PROPOSED LOWER GROUND + GROUND FLOOR PLAN SCALE: 1:100

- A. First issue, Town Planner for submission.
- B. Balconies amended (reduced) as per client preferred dimensions and budget, to engineers for engineering (26.3.21), issued to Town Planner for submission (dated 7.4.21).
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15.03.21 26.03.21 07.04.21

12.05.21

DRAWING No: 4 / 13

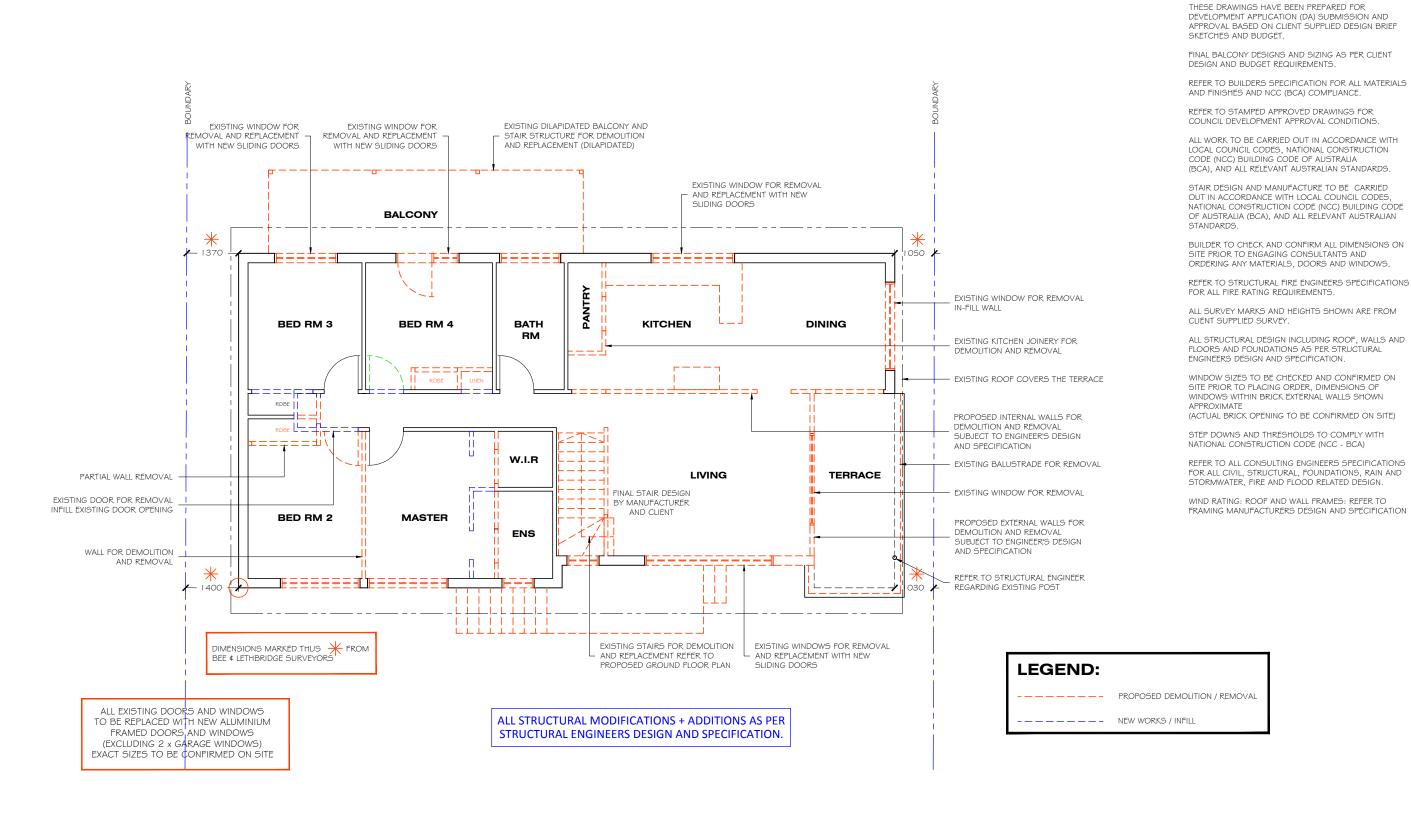

FIRST FLOOR PLAN - EXISTING + DEMOLITION

SCALE 1:100





PETER + CAROL HEAL

ADDRESS: 8 JENDI AVENUE BAYVIEW

PROPOSED GROUND FLOOR + FIRST FLOOR MODIFICATIONS WITH **BALCONY UPGRADE + ADDITION** DRAWING TITLE:

FIRST FLOOR EXISTING + PROPOSED DEMOLITION SCALE:

DETAILS: DATE: 21.01.21

DRAWN: B.BENCH CHECKED: P + C HEAL 1:100

- A. First issue, Town Planner for submission.
- B. Balconies amended (reduced) as per client preferred dimensions and budget, to engineers for engineering (26.3.21), issued to Town Planner for submission (dated 7.4.21).
- C. Boundaries added to plans, site plan updates as per council request.

NORTH: 15.03.21

26.03.21

07.04.21


12.05.21

NOTES:

DO NOT SCALE FROM DRAWINGS

REVISION: \mathbb{G}^{\square}

DRAWING No: 5 / 13

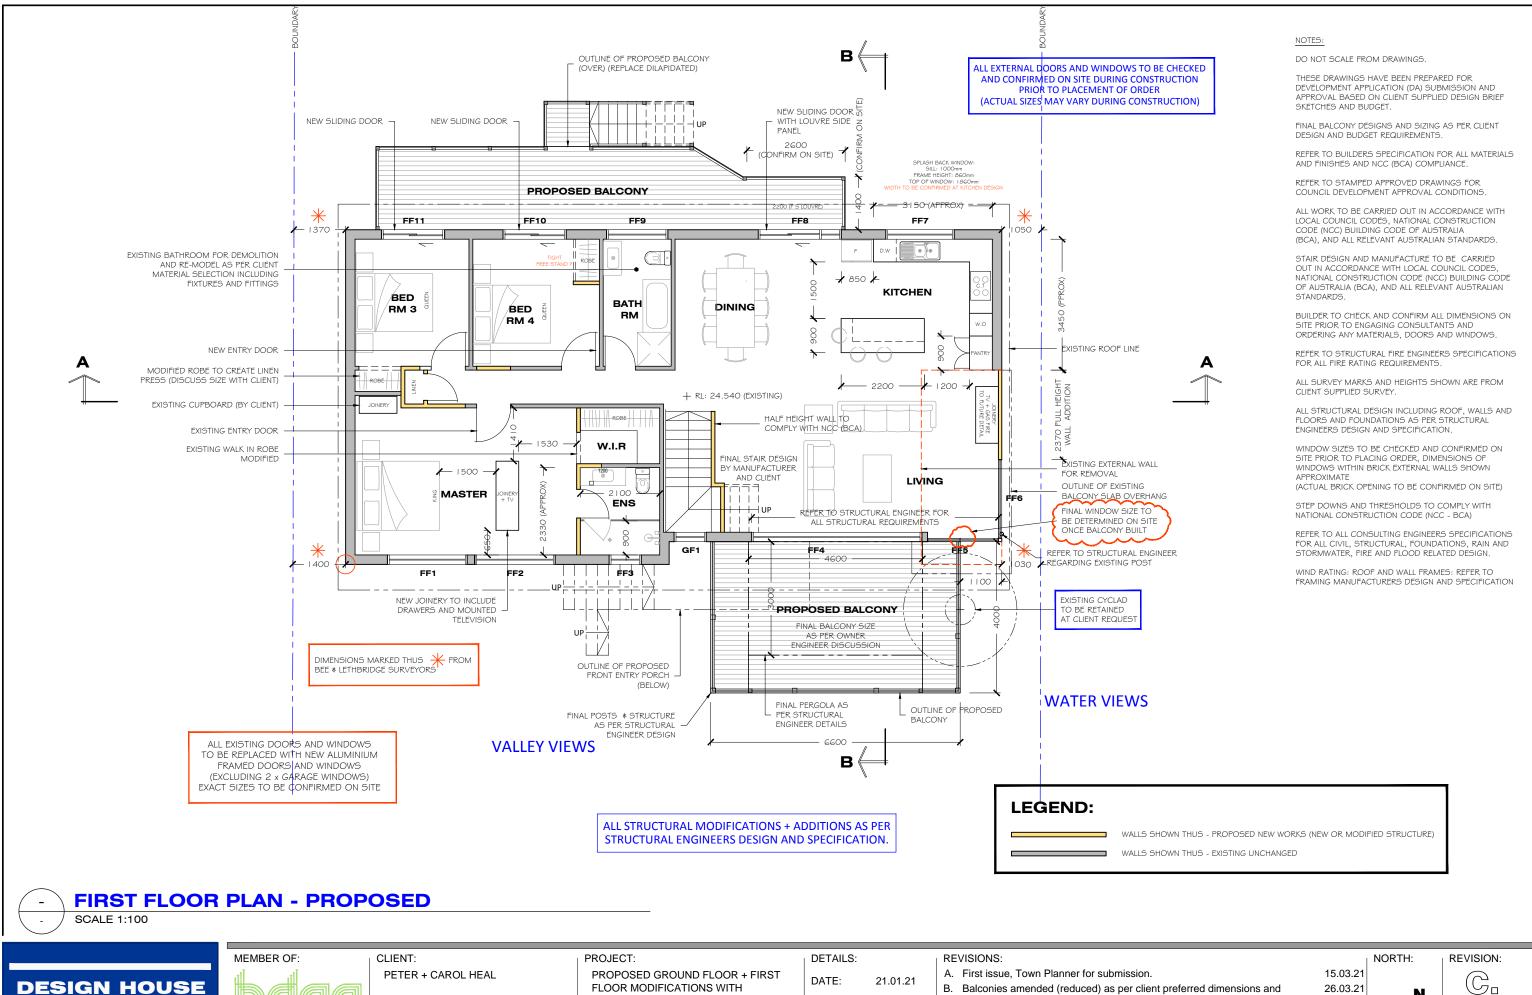





PETER + CAROL HEAL

ADDRESS: 8 JENDI AVENUE BAYVIEW

PROPOSED GROUND FLOOR + FIRST FLOOR MODIFICATIONS WITH **BALCONY UPGRADE + ADDITION** DRAWING TITLE:

DATE: DRAWN: B.BENCH CHECKED: P + C HEAL FIRST FLOOR PLAN PROPOSED SCALE: 1:100

A. First issue, Town Planner for submission.

B. Balconies amended (reduced) as per client preferred dimensions and budget, to engineers for engineering (26.3.21), issued to Town Planner for submission (dated 7.4.21).

C. Boundaries added to plans, site plan updates as per council request.


26.03.21


07.04.21


12.05.21


STAGE: DEVELOPMENT APPLICATION (DA)


DRAWING No: 6 / 13

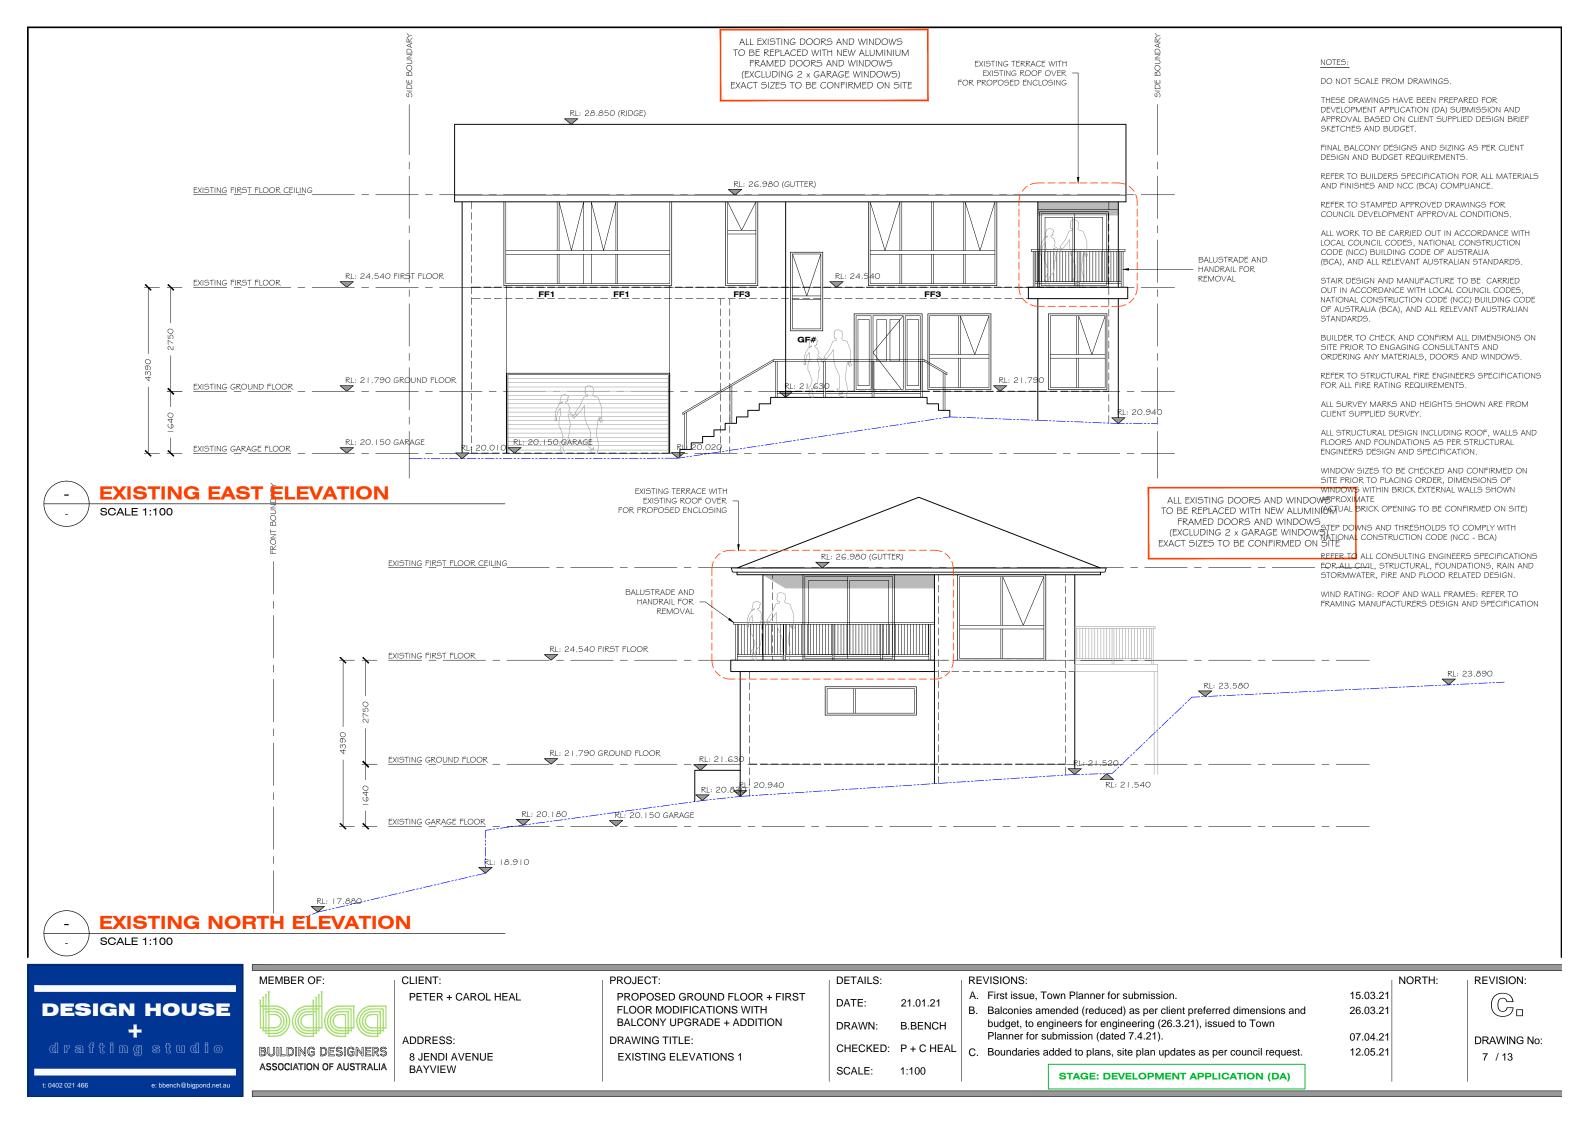


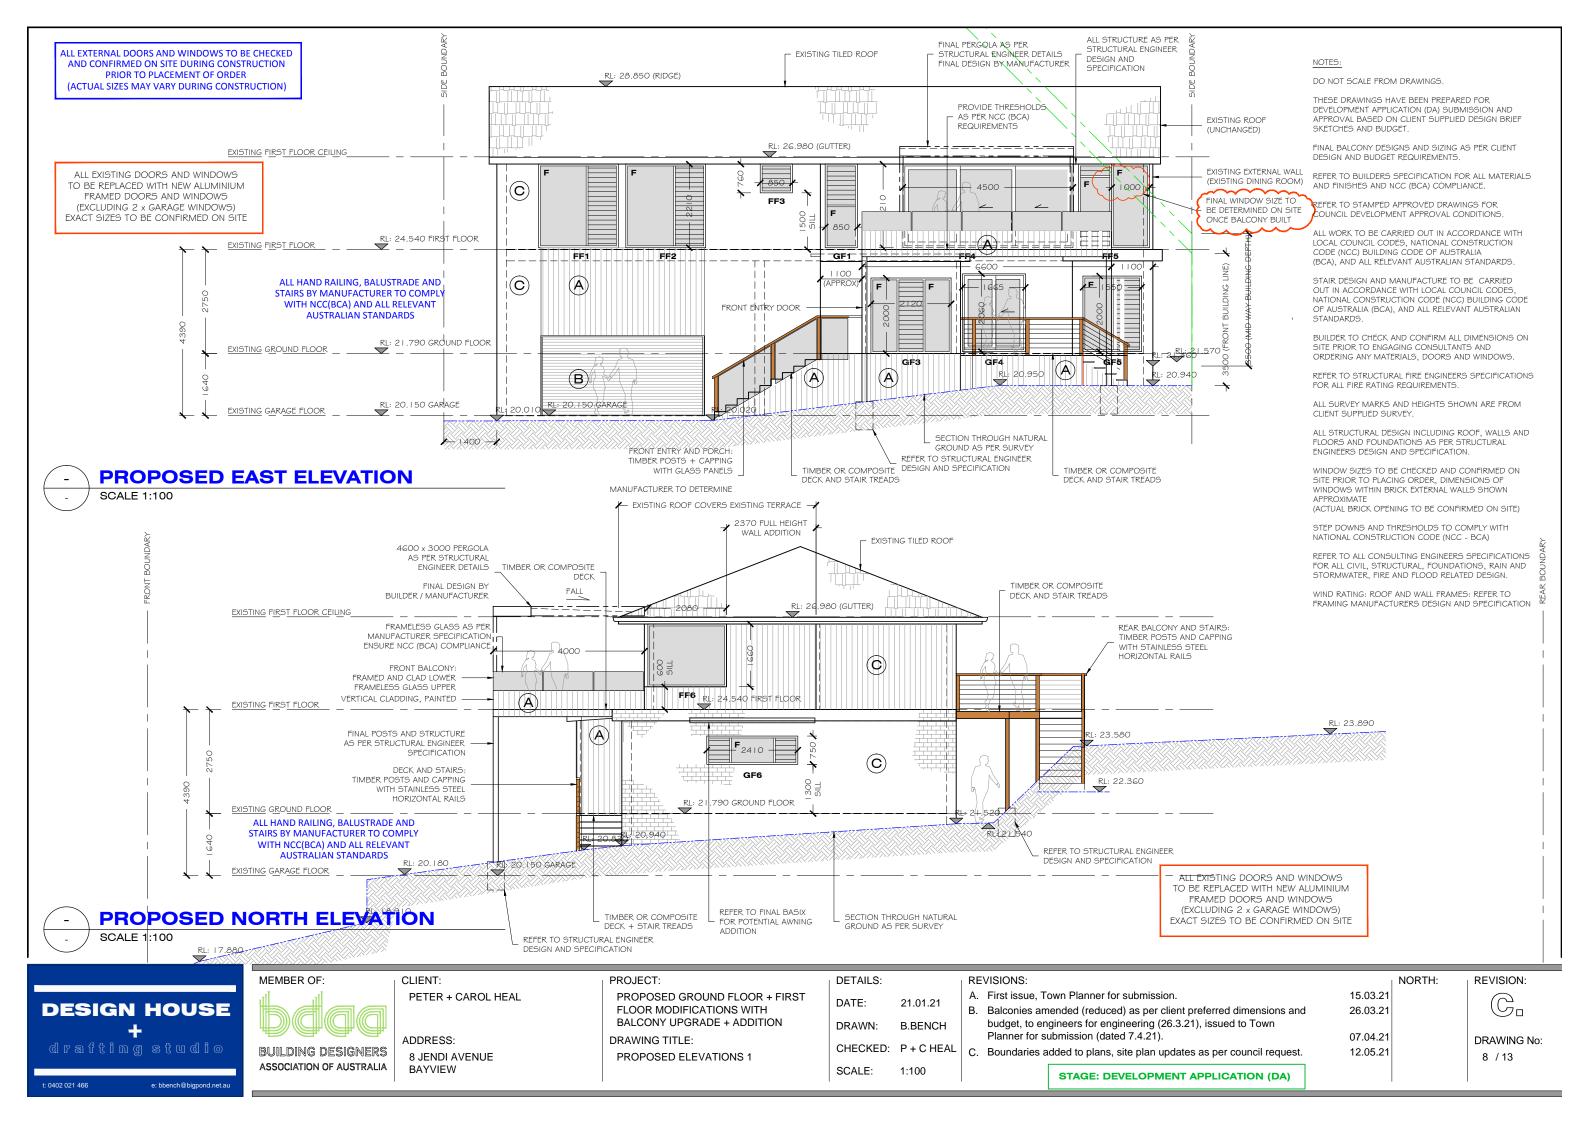

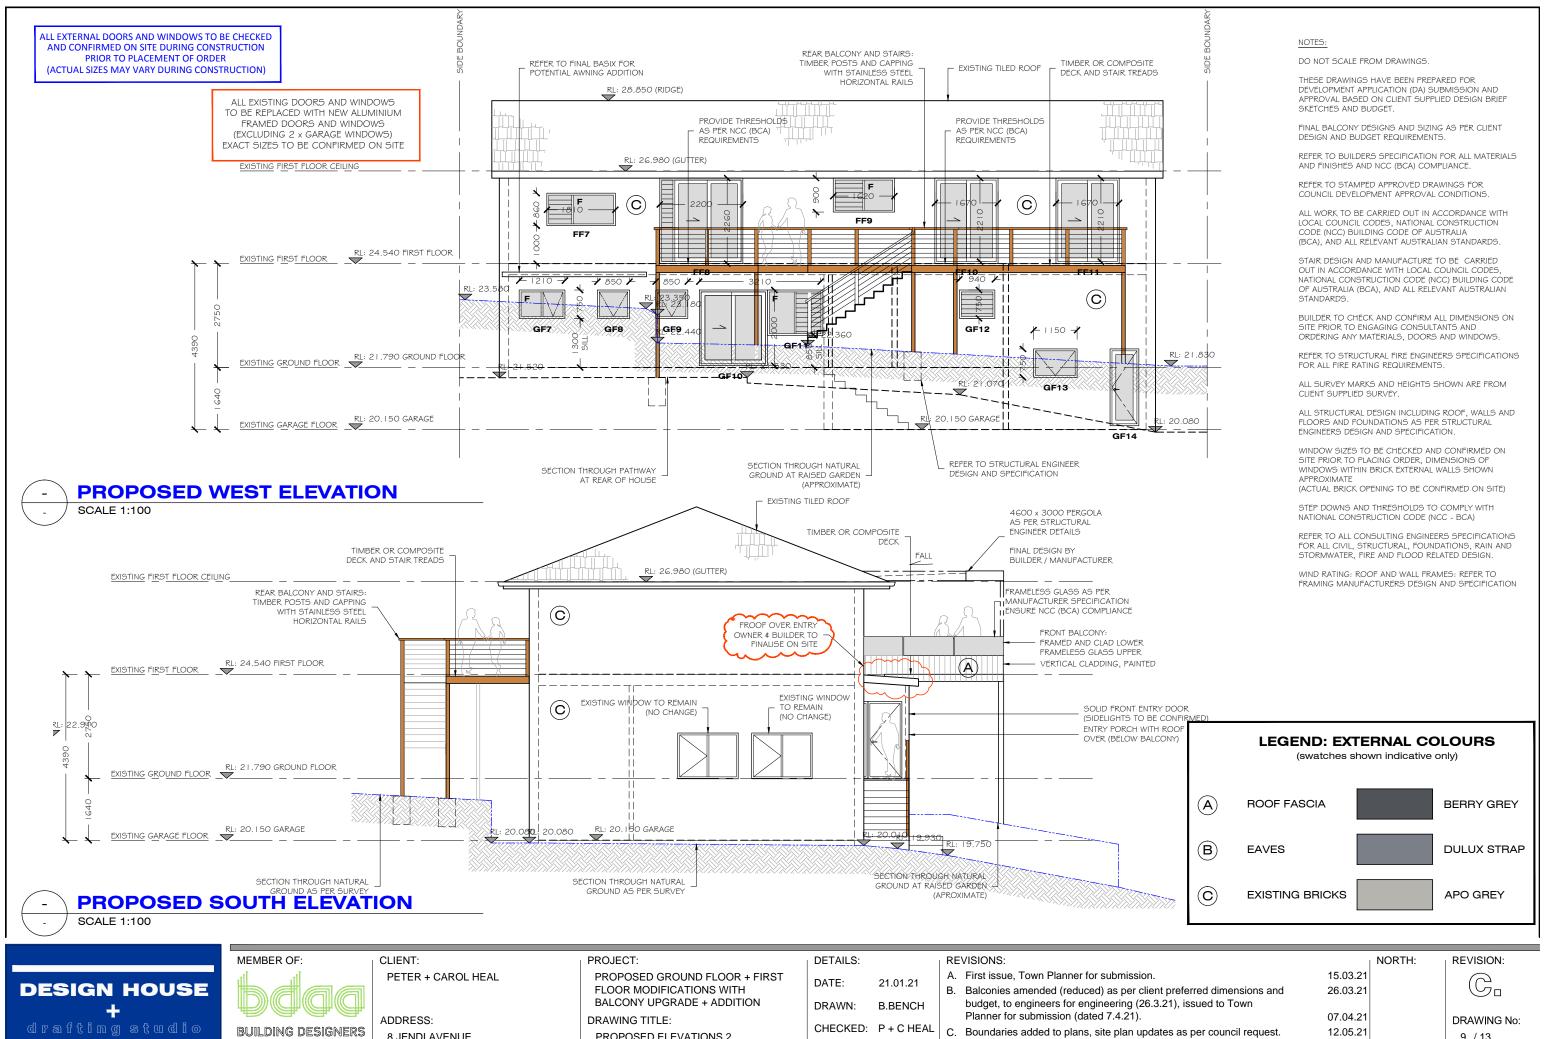

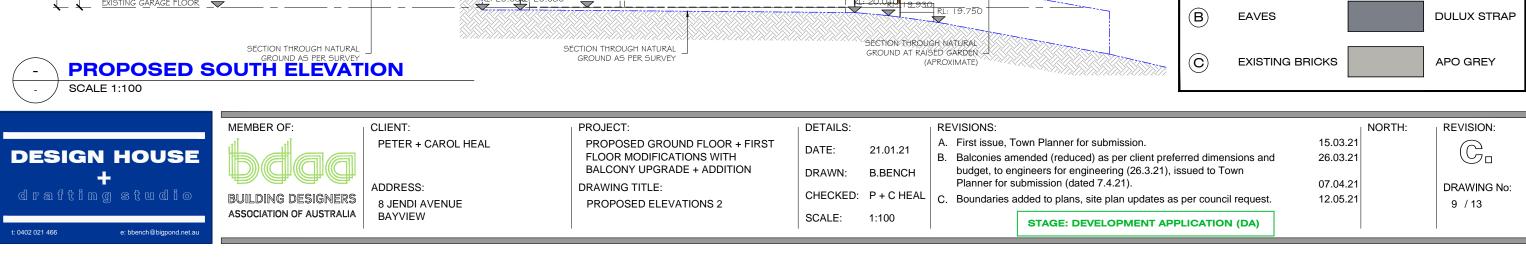

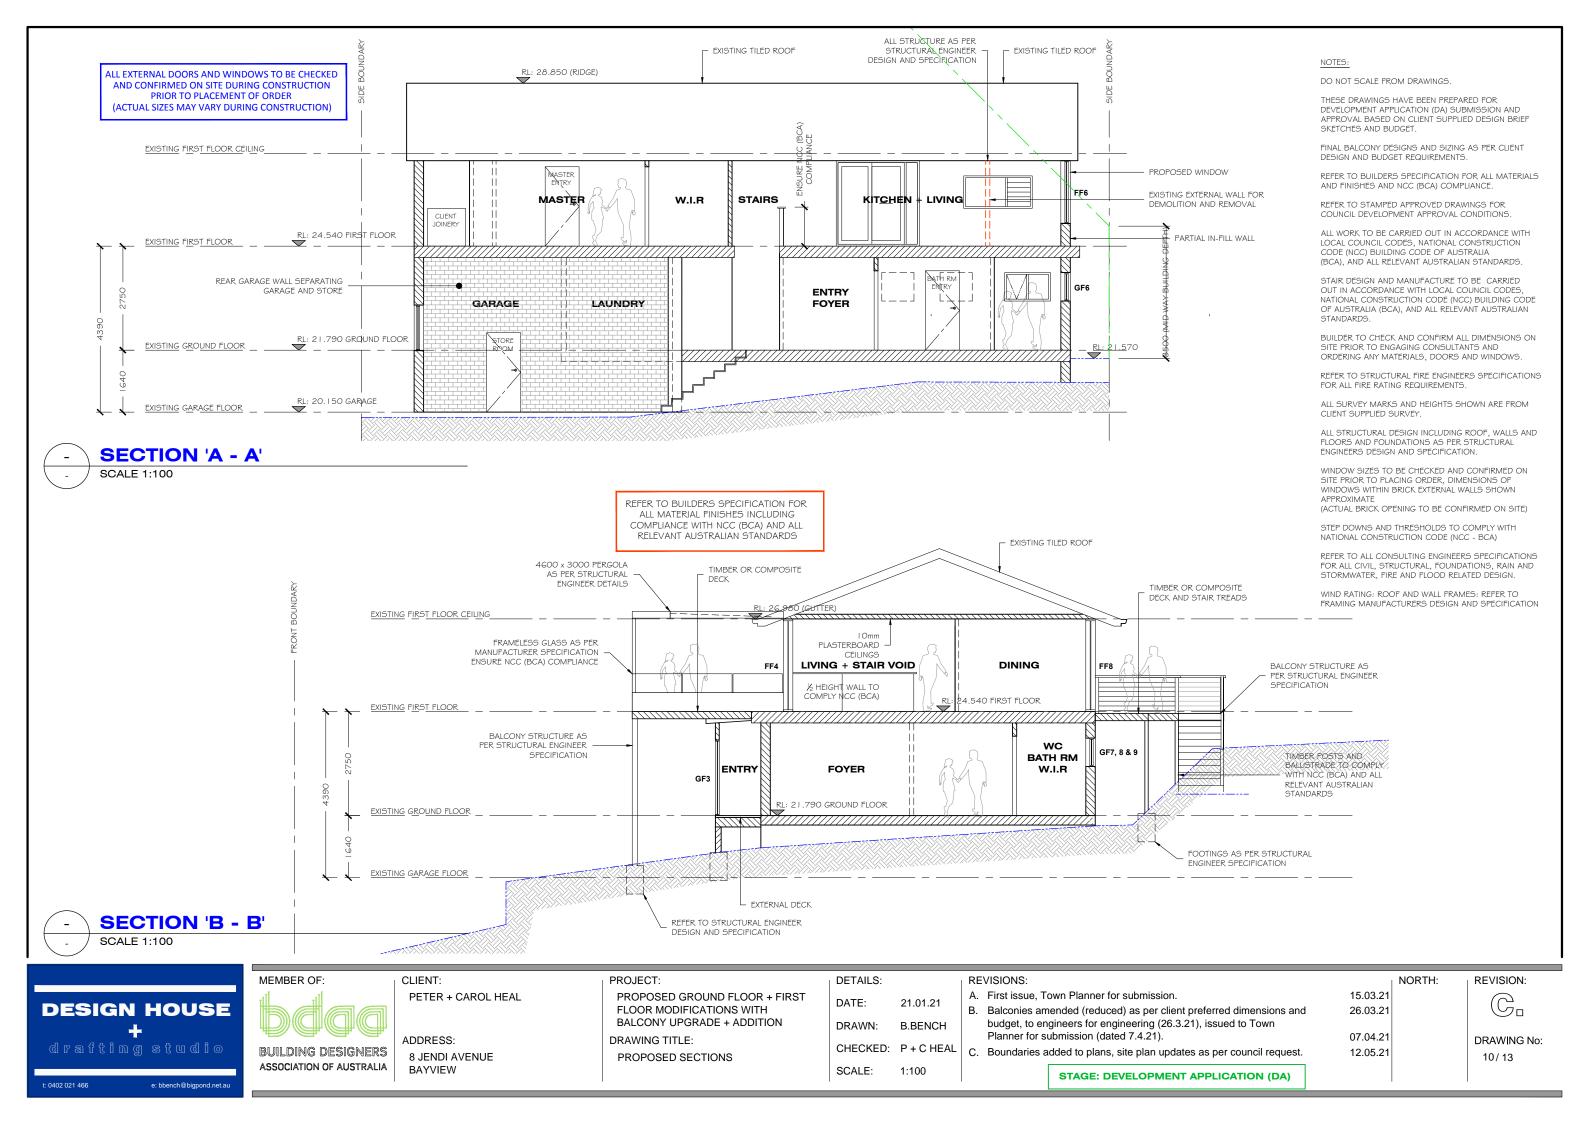

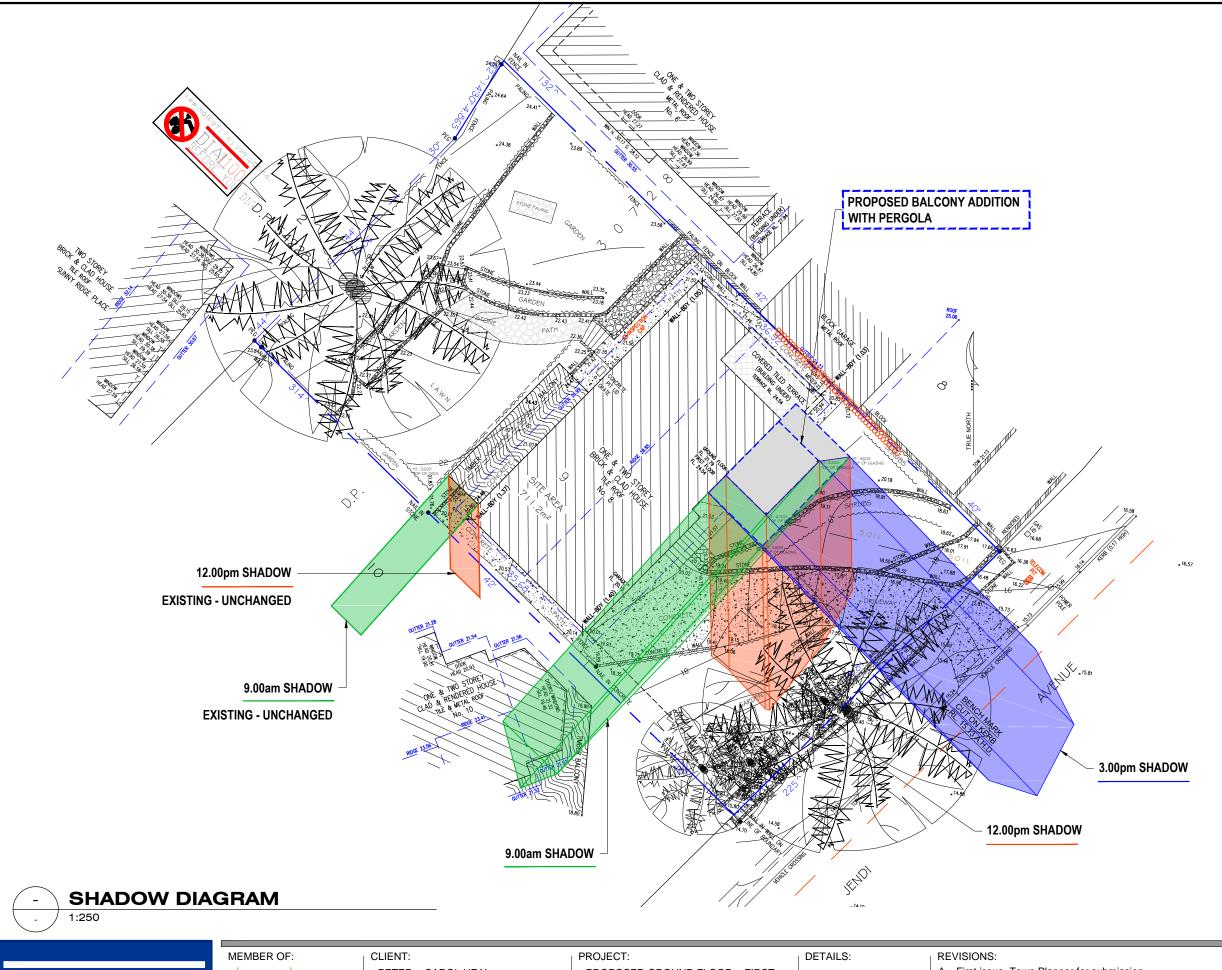

NOTES

DO NOT SCALE FROM DRAWINGS.

THESE DRAWINGS HAVE BEEN PREPARED FOR DEVELOPMENT APPLICATION (DA) SUBMISSION AND APPROVAL BASED ON CLIENT SUPPLIED DESIGN BRIEF SKETCHES AND BUDGET.

FINAL BALCONY DESIGNS AND SIZING AS PER CLIENT DESIGN AND BUDGET REQUIREMENTS.

REFER TO BUILDERS SPECIFICATION FOR ALL MATERIALS AND FINISHES AND NCC (BCA) COMPLIANCE.

REFER TO STAMPED APPROVED DRAWINGS FOR COUNCIL DEVELOPMENT APPROVAL CONDITIONS.

ALL WORK TO BE CARRIED OUT IN ACCORDANCE WITH LOCAL COUNCIL CODES, NATIONAL CONSTRUCTION CODE (NCC) BUILDING CODE OF AUSTRALIA (BCA), AND ALL RELEVANT AUSTRALIAN STANDARDS.

STAIR DESIGN AND MANUFACTURE TO BE CARRIED OUT IN ACCORDANCE WITH LOCAL COUNCIL CODES, NATIONAL CONSTRUCTION CODE (NCC) BUILDING CODE OF AUSTRALIA (BCA), AND ALL RELEVANT AUSTRALIAN STANDARDS.

BUILDER TO CHECK AND CONFIRM ALL DIMENSIONS ON SITE PRIOR TO ENGAGING CONSULTANTS AND ORDERING ANY MATERIALS, DOORS AND WINDOWS.

REFER TO STRUCTURAL FIRE ENGINEERS SPECIFICATIONS FOR ALL FIRE RATING REQUIREMENTS.

ALL SURVEY MARKS AND HEIGHTS SHOWN ARE FROM CLIENT SUPPLIED SURVEY.

ALL STRUCTURAL DESIGN INCLUDING ROOF, WALLS AND FLOORS AND FOUNDATIONS AS PER STRUCTURAL ENGINEERS DESIGN AND SPECIFICATION.

WINDOW SIZES TO BE CHECKED AND CONFIRMED ON SITE PRIOR TO PLACING ORDER, DIMENSIONS OF WINDOWS WITHIN BRICK EXTERNAL WALLS SHOWN APPROXIMATE (ACTUAL BRICK OPENING TO BE CONFIRMED ON SITE)

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STEP DOWNS AND THRESHOLDS TO COMPLY WITH NATIONAL CONSTRUCTION CODE (NCC - BCA)

REFER TO ALL CONSULTING ENGINEERS SPECIFICATIONS FOR ALL CIVIL, STRUCTURAL, FOUNDATIONS, RAIN AND STORMWATER, FIRE AND FLOOD RELATED DESIGN.

WIND RATING: ROOF AND WALL FRAMES: REFER TO FRAMING MANUFACTURERS DESIGN AND SPECIFICATION



MEMBER OF:

BUILDING DESIGNERS
ASSOCIATION OF AUSTRALIA

PETER + CAROL HEAL

ADDRESS: 8 JENDI AVENUE BAYVIEW PROPOSED GROUND FLOOR + FIRST FLOOR MODIFICATIONS WITH BALCONY UPGRADE + ADDITION DRAWING TITLE: SHADOWS 1

DATE: 21.01.21

DRAWN: B.BENCH

CHECKED: P+CHEAL

SCALE: 1:250

A. First issue, Town Planner for submission.

 B. Balconies amended (reduced) as per client preferred dimensions and budget, to engineers for engineering (26.3.21), issued to Town Planner for submission (dated 7.4.21).

C. Boundaries added to plans, site plan updates as per council request.

NORTH:

15.03.21

26.03.21

07.04.21

12.05.21

(C

DRAWING No: 11/13

REVISION:

BASIX Certificate

Building Sustainability Index www.basix.nsw.gov.au

Alterations and Additions

Certificate number: A377636

This certificate confirms that the proposed development will meet the NSW government's requirements for sustainability, if it is built in accordance with the commitments set out below. Terms used in this certificate, or in the commitments, have the meaning given by the document entitled "BASIX Alterations and Additions Definitions" dated 06/10/2017 published by the Department. This document is available at the way beging part of the property available at www.basix.nsw.gov.au

Date of issue: Tuesday, 16, March 2021
To be valid, this certificate must be lodged within 3 hin 3 months of the date of issue

Project name Heal Bayview roj 8 Jendi Avenue Bayview 2104 Street address Local Government Area 0 Plan type and number Deposited Plan 30728 Lot number ō Section number 0 Dwelling type Separate dwelling house pti Type of alteration and addition My renovation work is valued at \$50,000 or more. and does not include a pool (and/or spa) Number of bedroom after alterations or additions

page 1 / 7

Certificate Prepared by (please complete before submitting to Council or PCA) Name / Company Name: Design House + Drafting Studio ABN (if applicable): 58981334580

BASIX Certificate number: A377636

| Construction | | | Show on DA Plans | Show on CC/CDC Plans & specs | Certifier Check |
|--|--|---|---------------------|---------------------------------------|--------------------|
| nsulation requirements | | | | | |
| The applicant must construct the new or altered construction (floor(s), walls, and ceilings/roofs) in accordance with the specifications listed in the table below, except that a) additional insulation is not required where the area of new construction is less than 2m2, b) insulation specified is not required for parts of altered construction where insulation already exists. | | | V | ✓ | V |
| Construction | Additional insulation required (R-value) | Other specifications | | | |
| suspended floor with enclosed subfloor; framed (R0.7). | R0.60 (down) (or R1.30 including construction) | | | | |
| floor above existing dwelling or building. | nil | | | | |
| external wall: framed (weatherboard, fibro, metal clad) | R1.30 (or R1.70 including construction) | | | | |
| internal wall shared with garage: plasterboard (R0.36) | nil | | | | |
| flat ceiling, pitched roof | ceiling: R1.95 (up), roof: foil backed blanket (55 mm) | medium (solar absorptance 0.475 - 0.70) | | | |

Planning, Industry & Environment Building Sustainability Index www.basix.nsw.gov.au BASIX Certificate number: A377636 page 2 / 7 The applicant must install the following hot water system in the development: electric storage plus photovoltaic system The applicant must install a photovoltaic system with a capacity to generate at least 2.6 peak kilowatts of electricity as part of the development. The applicant must connect this system to the development's electrical system. 1 The applicant must ensure a minimum of 40% of new or altered light fixtures are fitted with fluorescent, compact fluorescent, or light-emitting-diode (LED) lamps. 1 1 The applicant must ensure new or altered showerheads have a flow rate no greater than 9 litres per minute or a 3 star water rating. The applicant must ensure new or altered toilets have a flow rate no greater than 4 litres per average flush or a minimum 3 star water rating. 1 1 The applicant must ensure new or altered taps have a flow rate no greater than 9 litres per minute or minimum 3 star water rating.

Planning, Industry & Environmer Building Sustainability Index www.basix.nsw.gov.ar

BASIX Certificate number: A377636

The applicant must install the windows, glazed doors and shading devices, in accordance with the specifications listed in the table below Relevant overshadowing specifications must be satisfied for each window and glazed door. The following requirements must also be satisfied in relation to each window and glazed door: Each window or glazed door with improved frames, or pyrolytic low-e glass, or clear/air gap/clear glazing, or toned/air gap/clear glazing must have a U-value and a Solar Heat Gain Coefficient (SHGC) no greater than that listed in the table below. Total system U-values and SHGCs must be calculated in accordance with National Fenestration Rating Council (NFRC) conditions. The description is provided for information only. Alternative systems with complying U-value and SHGC may be substituted. For projections described in millimetres, the leading edge of each eave, pergola, verandah, balcony or awning must be no more than 500 mm above the head of the window or glazed door and no more than 2400 mm above the sill. Pergolas with polycarbonate roof or similar translucent material must have a shading coefficient of less than 0.35 Pergolas with fixed battens must have battens parallel to the window or glazed door above which they are situated, unless the pergola also shades a perpendicular window. The spacing between battens must not be more than 50 mm. Overshadowing buildings or vegetation must be of the height and distance from the centre and the base of the window and glazed door, as specified in the 'overshadowing' column in the table below. Windows and glazed doors glazing requirements improved aluminium, single to (U-value: 6.39, SHGC: 0.56)

eave/verand GF2 0.6 eave/verandah/pergola/balcony >=450 mm improved aluminium, single toned, (U-value: 6.39, SHGC: 0.56) 4.2 eave/verandah/pergola/balcony >=900 mm improved aluminium, single toned, (U-value: 6.39, SHGC: 0.56) GF4 3.4 improved aluminium, single toned

Planning, Industry & Environment Building Sustainability Index www.basix.nsw.gov.au

BASIX

DESIGN HOUSE

BUILDING DESIGNERS ASSOCIATION OF AUSTRALIA

MEMBER OF:

CLIENT: PETER + CAROL HEAL

> ADDRESS: 8 JENDI AVENUE BAYVIEW

PROJECT: PROPOSED GROUND FLOOR + FIRST FLOOR MODIFICATIONS WITH **BALCONY UPGRADE + ADDITION** DRAWING TITLE: BASIX 1

Windows and glazed doors

DATE: 21.01.21 DRAWN: B.BENCH CHECKED: P + C HEAL SCALE:

DETAILS:

REVISIONS:

A. First issue, Town Planner for submission.

B. Balconies amended (reduced) as per client preferred dimensions and budget, to engineers for engineering (26.3.21), issued to Town Planner for submission (dated 7.4.21).

C. Boundaries added to plans, site plan updates as per council request.

NORTH: 15.03.21

26.03.21

07.04.21

12.05.21

NOTES:

DO NOT SCALE FROM DRAWINGS

DESIGN AND BUDGET REQUIREMENTS.

AND FINISHES AND NCC (BCA) COMPLIANCE.

REFER TO STAMPED APPROVED DRAWINGS FOR

COUNCIL DEVELOPMENT APPROVAL CONDITIONS.

SKETCHES AND BUDGET.

THESE DRAWINGS HAVE BEEN PREPARED FOR DEVELOPMENT APPLICATION (DA) SUBMISSION AND APPROVAL BASED ON CLIENT SUPPLIED DESIGN BRIEF

FINAL BALCONY DESIGNS AND SIZING AS PER CLIENT

REFER TO BUILDERS SPECIFICATION FOR ALL MATERIALS

ALL WORK TO BE CARRIED OUT IN ACCORDANCE WITH

LOCAL COUNCIL CODES, NATIONAL CONSTRUCTION CODE (NCC) BUILDING CODE OF AUSTRALIA

(BCA), AND ALL RELEVANT AUSTRALIAN STANDARDS.

STAIR DESIGN AND MANUFACTURE TO BE CARRIED

OUT IN ACCORDANCE WITH LOCAL COUNCIL CODES NATIONAL CONSTRUCTION CODE (NCC) BUILDING CODE OF AUSTRALIA (BCA), AND ALL RELEVANT AUSTRALIAN

BUILDER TO CHECK AND CONFIRM ALL DIMENSIONS ON SITE PRIOR TO ENGAGING CONSULTANTS AND ORDERING ANY MATERIALS, DOORS AND WINDOWS. REFER TO STRUCTURAL FIRE ENGINEERS SPECIFICATIONS

ALL SURVEY MARKS AND HEIGHTS SHOWN ARE FROM

ALL STRUCTURAL DESIGN INCLUDING ROOF, WALLS AND FLOORS AND FOUNDATIONS AS PER STRUCTURAL ENGINEERS DESIGN AND SPECIFICATION.

WINDOW SIZES TO BE CHECKED AND CONFIRMED ON SITE PRIOR TO PLACING ORDER, DIMENSIONS OF WINDOWS WITHIN BRICK EXTERNAL WALLS SHOWN

(ACTUAL BRICK OPENING TO BE CONFIRMED ON SITE)

STEP DOWNS AND THRESHOLDS TO COMPLY WITH NATIONAL CONSTRUCTION CODE (NCC - BCA) REFER TO ALL CONSULTING ENGINEERS SPECIFICATIONS STORMWATER, FIRE AND FLOOD RELATED DESIGN.

WIND RATING: ROOF AND WALL FRAMES: REFER TO FRAMING MANUFACTURERS DESIGN AND SPECIFICATION


FOR ALL FIRE RATING REQUIREMENTS.

CLIENT SUPPLIED SURVEY.

APPROXIMATE

REVISION: C₀

> DRAWING No: 12/13

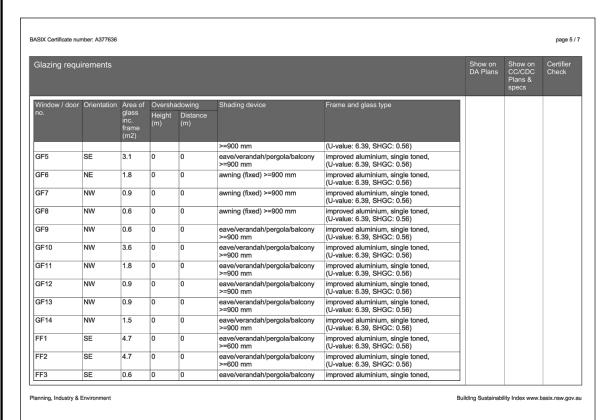

BASIX Certificate number: A377636 In these commitments, "applicant" means the person carrying out the development Commitments identified with a "V" in the "Show on DA plans" column must be shown on the plans accompanying the development application for the proposed development (if a evelopment application is to be lodged for the proposed development). Commitments identified with a "\times" in the "Show on CC/CDC plans & specs" column must be shown in the plans and specifications accompanying the application for a construction certificate / complying development certificate for the proposed development. Commitments identified with a "V" in the "Certifier check" column must be certified by a certifying authority as having been fulfilled, before a final occupation certificate for the development may be issued.

Planning, Industry & Environment Building Sustainability Index www.basix.nsw.gov.au







CLIENT: PETER + CAROL HEAL

ADDRESS: 8 JENDI AVENUE BAYVIEW

PROPOSED GROUND FLOOR + FIRST FLOOR MODIFICATIONS WITH **BALCONY UPGRADE + ADDITION** DRAWING TITLE: BASIX 2

BASIX Certificate number: A377636

FF5

FF10

FF11

Planning, Industry & Environment

10

1.5

3.8

3.8

>=600 mm

eave/verand >=450 mm

>=600 mm

>=600 mm

12.6

eave/verandah/pergola/balcony >=600 mm

eave/verandah/pergola/balcony >=600 mm

eave/verandah/pergola/bal->=600 mm

eave/verandah/pergola/balcony

(U-value: 6.39, SHGC: 0.56)

improved aluminium, single toned, (U-value: 6.39, SHGC: 0.56)

improved aluminium, toned/air gap/clear, (U-value: 4.09, SHGC: 0.47)

aluminium, single Lo-Tsol low-e, (U-value: 5.6, SHGC: 0.36)

eave/verandah/pergola/balcony improved aluminium, single toned, >=600 mm (U-value: 6.39, SHGC: 0.56)

DETAILS: DATE: 21.01.21 DRAWN: B.BENCH CHECKED: P + C HEAL SCALE:

A. First issue, Town Planner for submission.

B. Balconies amended (reduced) as per client preferred dimensions and budget, to engineers for engineering (26.3.21), issued to Town Planner for submission (dated 7.4.21).

C. Boundaries added to plans, site plan updates as per council request.

STAGE: DEVELOPMENT APPLICATION (DA)

NOTES:

page 6 / 7

DO NOT SCALE FROM DRAWINGS

THESE DRAWINGS HAVE BEEN PREPARED FOR DEVELOPMENT APPLICATION (DA) SUBMISSION AND APPROVAL BASED ON CLIENT SUPPLIED DESIGN BRIEF SKETCHES AND BUDGET.

FINAL BALCONY DESIGNS AND SIZING AS PER CLIENT DESIGN AND BUDGET REQUIREMENTS.

REFER TO BUILDERS SPECIFICATION FOR ALL MATERIALS AND FINISHES AND NCC (BCA) COMPLIANCE.

REFER TO STAMPED APPROVED DRAWINGS FOR COUNCIL DEVELOPMENT APPROVAL CONDITIONS.

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FOR ALL FIRE RATING REQUIREMENTS.

REFER TO STRUCTURAL FIRE ENGINEERS SPECIFICATIONS

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WINDOW SIZES TO BE CHECKED AND CONFIRMED ON SITE PRIOR TO PLACING ORDER, DIMENSIONS OF WINDOWS WITHIN BRICK EXTERNAL WALLS SHOWN APPROXIMATE

(ACTUAL BRICK OPENING TO BE CONFIRMED ON SITE)

STEP DOWNS AND THRESHOLDS TO COMPLY WITH NATIONAL CONSTRUCTION CODE (NCC - BCA)

REFER TO ALL CONSULTING ENGINEERS SPECIFICATIONS STORMWATER, FIRE AND FLOOD RELATED DESIGN.

WIND RATING: ROOF AND WALL FRAMES: REFER TO FRAMING MANUFACTURERS DESIGN AND SPECIFICATION

Building Sustainability Index www.basix.nsw.gov.au

15.03.21 26.03.21 07.04.21

12.05.21

NORTH:

REVISION:

DRAWING No: 13/13