## **Applicant and Project Details**

Complete this page and the relevant Sections that apply to your proposed development.

## Applicants' Details

Name: (must be the same as the DA form)	CA and RM Lee and RM Lee
Address: (must be the same as the DA form)	165 AND 165A SEAFORTH CRESCENT SEAFORTH 2092
Phone Number:	0447 005333
Email Address:	chris.rachel.lee@gmail.com

## **Property Details**

Lot No:	Lot 1 and 2	
Deposited Plan (DP) No: or Strata Plan (SP) No:	DP 747438	
Unit No:		
House No:	165 AND 165A	
Street:	SEAFORTH CRESCENT	
Suburb:	SEAFORTH	
Postcode:	2092	

## **Project Details**

Description of proposed development:	Convert Single garage into double garage and boundary re-alignment between 165 and 165A Seafork Crescent Seafork
Structures to be demolished:	SINGLE GARAGE BRICKWORK ABOVE Existing concrete slab.

## **Applicant Declaration**

#### I declare that:

- 1. This plan has been completed in accordance with the Waste Management Guidelines
- 2. To the best of my knowledge, the details on this form are accurate and correct

NORTHERN BEACHES COUNCIL Waste Management Plan Effective Date: 25 October 2016

#### I understand that:

- 1. All records demonstrating lawful disposal of waste will be retained and kept readily accessible for inspection by regulatory authorities such as Council, NSW Environment Protection Authority or WorkCover NSW.
- 2. A bond in accordance with Council's fees and charges may apply to this development and must be paid to Council prior to any works commencing.
- 3. The bond will only be refunded when Council is satisfied that all waste outlined in this plan has been managed as per the plan, and evidence such as photos, receipts and statutory declarations must be supplied where appropriate.

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///	' //.		•	10 10
Signature of Applicant:	ruller	Date:	19	1-12-19
Olgitatato of Applicanti		 		


## Section 1 - Demolition

This section must be completed in accordance with 'Chapter 1 – Demolition' of the Waste Management Guidelines


MATERIALS ON SITE	DESTINATION  Evidence such as weighbridge dockets and invoices for waste disposal or recycling must be retained on site for inspection						
	REUSE AND RECYCLING (MOST FAVOURABLE)					DISPOSAL (LEAST FAVOURABLE)	
Types of Waste Material	Estimated Volume (m³) or Weight (t)	Specify how material will (RO)		OFFSITE DISPOSAL  ✓ Specify landfill site (LS)  ✓ Specify Waste Transport Contractor (WTC)			
			WTC	RO	WTC	: LS	
Excavated Material	NIL	_			e e e e e e e e e e e e e e e e e e e		
Garden Organics	2 m3			Kimbrihi Vegetation			
Bricks	5m <sup>3</sup>			Kimbriki Crusher			
Tiles	NIL				OPTION N		
Concrete	NIL		-		AVAILABLE These mate be re-used	rials must	
Timber	50Hg	Formwork.	_		separated of site and ser recycling.	m or off	
Plasterboard	NIL	<u> </u>	_				
Metals	300 kg	-	_	Kimbritii Metal Ro			
Asbestos	NIL						
Other waste (please specify)	Glass Apple 20 Kg		-			Kimbrihi General Waste.	
Estimated Total % Recovered	99%		The second secon		AS SAL		

Refer to the estimation tables in 'Chapter 1 – Demolition' of the Guidelines for assistance in completing this table.


# MATERIALS STORAGE PLAN

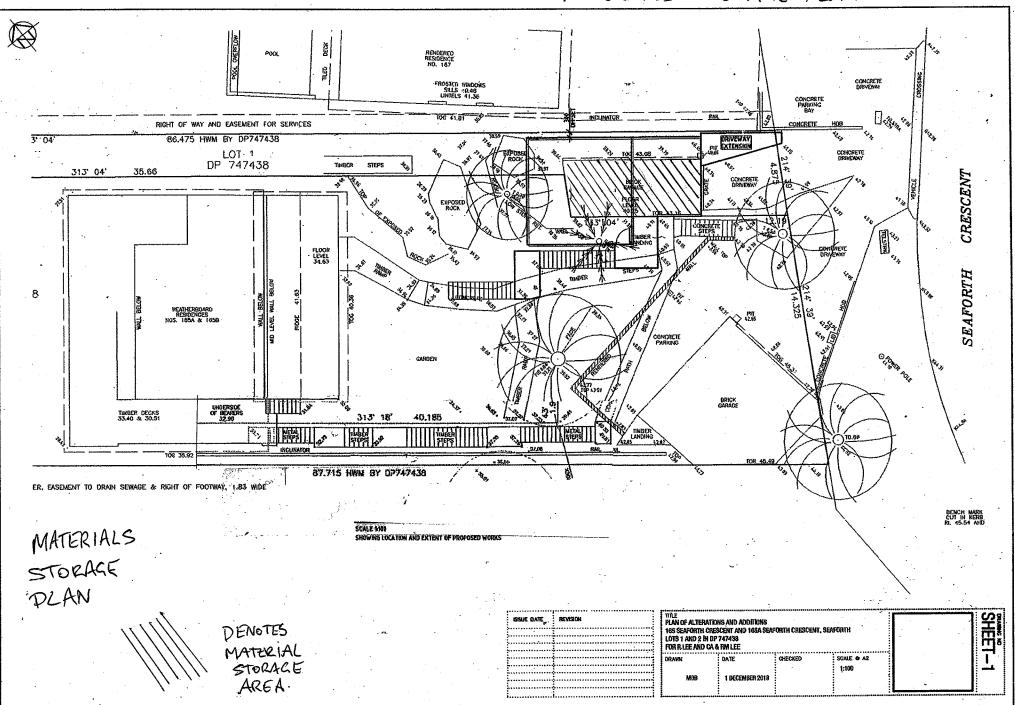


Denotes Devolution Areas.

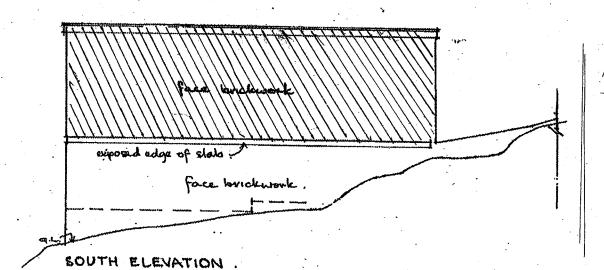

metal deck roofing set to fall to guitar.

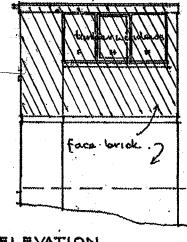

WEST ELEVATION .

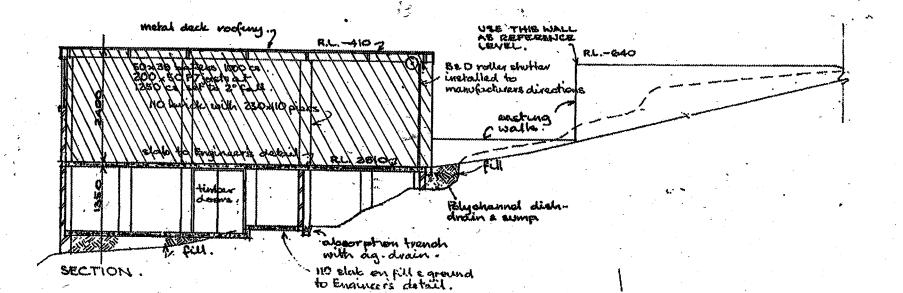

The applicant must submit a Site Plan showing the structures to be demolished and storage areas for waste and construction materials (if the development also includes construction).

## **WMP Checklist**

Have you included the following:	Applicant Tick
A site plan showing:	
The structures to be demolished.	
<ul> <li>Storage areas for waste to be reused, recycled, or disposed of.</li> </ul>	
Materials storage (if the development also includes construction)	+ ±
The table on the previous page, completed in accordance with 'Chapter 1 – Demolition' in the guidelines.	

## **Section 2 - Construction**

This section must be completed in accordance with 'Chapter 2 – Construction' of the Waste Management Guidelines

MATERIALS ON SITE	DESTINATION  Evidence such as weighbridge dockets and invoices for waste disposal or recyclir must be retained on site for inspection					·
		AND RECYCLING (M		RABLE)	DISPOSAL (LEAST FAVOURABLE)	
Types of Waste Material	Estimated Volume (m³) or Weight (t)	ONSITE RE-USE ✓ Specify how material will be reused on site	SITE RE-USE Specify how material will be reused on  OFFSITE RECYCLING  ✓ Specify recycling outlet (RO) ✓ Specify Waste		OFFSITE DISPOSAL  ✓ Specify landfill site (LS)  ✓ Specify Waste Transport Contractor (WTC)	
*Please specify			WTC	RO	WTC	LS
Excavated Material	0-8 m2	Londscape		_		•
Garden Organics		_			1.	
Bricks	100 Hg	_	Sun-	Kimbrihi Crusher.		
Tiles			~		OPTION N	ЭТ <sup>3</sup> 1 7
Concrete	-	-			AVAILABLE These mak	enal Sangst
Timber*	40 hg		untre	Kimbriki Vegetohon atca fimbar	be re-used separated of site and set	ni àir off
Plasterboard	-	•	_	•	recycling	
Metals*	20 kg			Kimbaki Metals.		
Asbestos	_			_		
Other waste*						//
Estimated Total % Recovered	100%		Capatrustion		delines for	

Refer to the estimation tables in 'Chapter 2 – Construction' of the Guidelines for assistance in completing this table.

The applicant must submit a Site Plan showing the structures to be demolished and storage areas for waste and construction materials (if the development also includes construction).

## WMP Checklist

Have you included the following:	Applicant Tick
A site plan showing:	100
The structures to be demolished.	
<ul> <li>Potential storage areas for waste to be reused, recycled, or disposed of.</li> </ul>	
Materials storage	
The table on the previous page, completed in accordance with 'Chapter 2 – Construction' in the guidelines.	Image: section of the

## Section 3 - On-going waste management for one or two dwellings

This section is to be completed in accordance with 'Chapter 3 - On-going waste management for one or two dwellings' of the Waste Management Guidelines.

Type of development: _	Residential	
Number of dwellings:	ONE	


#### **WMP Checklist**

Do your architectural and landscape plans include the following:	
Waste Storage Area design requirements (Chapter 3.2.)	
Waste Storage Area location requirements (Chapter 3.3.)	1

See attached sheet with waste area at rear of proposed garage.

Easy access to the street.

Out of sight of public.

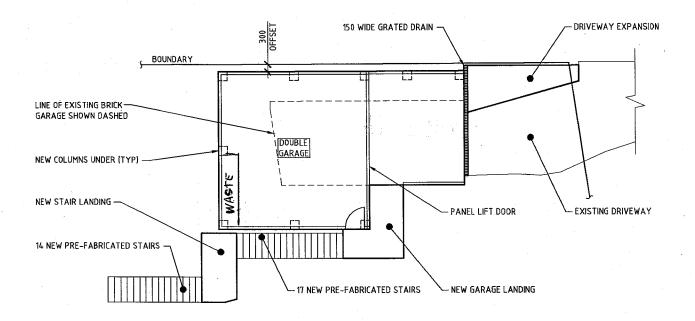

## PROPOSED GARAGE PLAN

SCALE 1:100

TITLE PLAN OF ALTERATIO 165 SEAFORTH CRE LOTS 1 AND 2 IN DP FOR R.LEE AND CA 8	SCENT AND 165A SEAF 747438	FORTH CRESCENT,	SEAFORTH	SHEET
DRAWN MDB	DATE 1 DECEMBER 2019	CHECKED	SCALE @ A3 1:100	_2

# WASTE MANAGEMENT PLAN. CONSTRUCTION AND DEMOLITION 165 & 165A Seaforth Crescent Seaforth 2092- Garage proposal

#### Demolition

The existing garage roof will be removed and taken to Kimbriki Recycling Centre and will be recycled by leaving the metal roof at metal area.

The brick walls will be removed and taken to the Kimbriki concrete /brick area for crushing and reuse as road base.

The aluminium window will be disassembled and taken to the recycling company in Dale Street Brookvale for aluminium scrap metal.

The glass from the window will be taken to Kimbriki for general waste and is not able to be recycled.

#### Construction

The formwork for the concrete slab will be reused by the formwork company.

Any broken bricks will be transported to the Kimbriki concrete/brick area for crushing and reuse as road base.

Any metal offcuts from the roofing will be recycled by Kimbriki metal area.

No timber will be used for construction as the garage will be constructed only using masonry and steel.

## WASTE MANAGEMENT PLAN- ON GOING

## 165 & 165A Seaforth Crescent Seaforth 2092 - Garage proposal

The existing 1x blue bin, 1x red bin, 1x yellow bin and 2x green bins provided by Northern Beaches Council will be stored inside at the Western End of the garage and will be collected on the allocated days.