CONTE	ENTS	WALLS PAINTED
DA1	PERSPECTIVES, MATERIALS & FINISHES	WHITE or similar
DA2	SURVEY	
DA3	SITE, SITE ANALYSIS & WASTE MANAGEMENT PLAN	
DA4	LOWER FLOOR PLAN	WINDOWS
DA5	GROUND FLOOR PLAN	BLACK
DA6	UPPER FLOOR PLAN	ALUMINIUM
DA7	ROOF PLAN	or similar
DA8	ELEVATIONS, N, S	
DA9 DA10	ELEVATIONS, E, W ELEVATIONS, N, S 1:200	ROOF
-	ELEVATIONS, N, S 1.200 ELEVATIONS, E (Streetscape), W 1:200	METAL
DA11 DA12	SECTIONS A-A, B-B	WINDSPRAY
DA12 DA13	SECTIONS C-C, D-D	or similar
DA14	SECTIONS B-B, C-C, D-D 1:200	
DA15	FLOOR SPACE RATIO PLAN	
DA16	SOLAR JUNE 21 - 9AM	ROOF
DA17	SOLAR JUNE 21 - 12PM	CONC.
DA18	SOLAR JUNE 21 - 3PM	or similar
DA19	LANDSCAPING PLAN	
DA20	ELEVATIONAL SHADOWS - EXISTING & PROPOSED	
DA21	ELEVATIONAL SHADOWS - FIRST FLOOR REMOVED AS COMPARISON	
DA22	BASIX	ROOF
DA23	BASIX	PEBBLES
		or similar


private residence


69 gordon st, clontarf

new dwelling development application





architectural perspectives

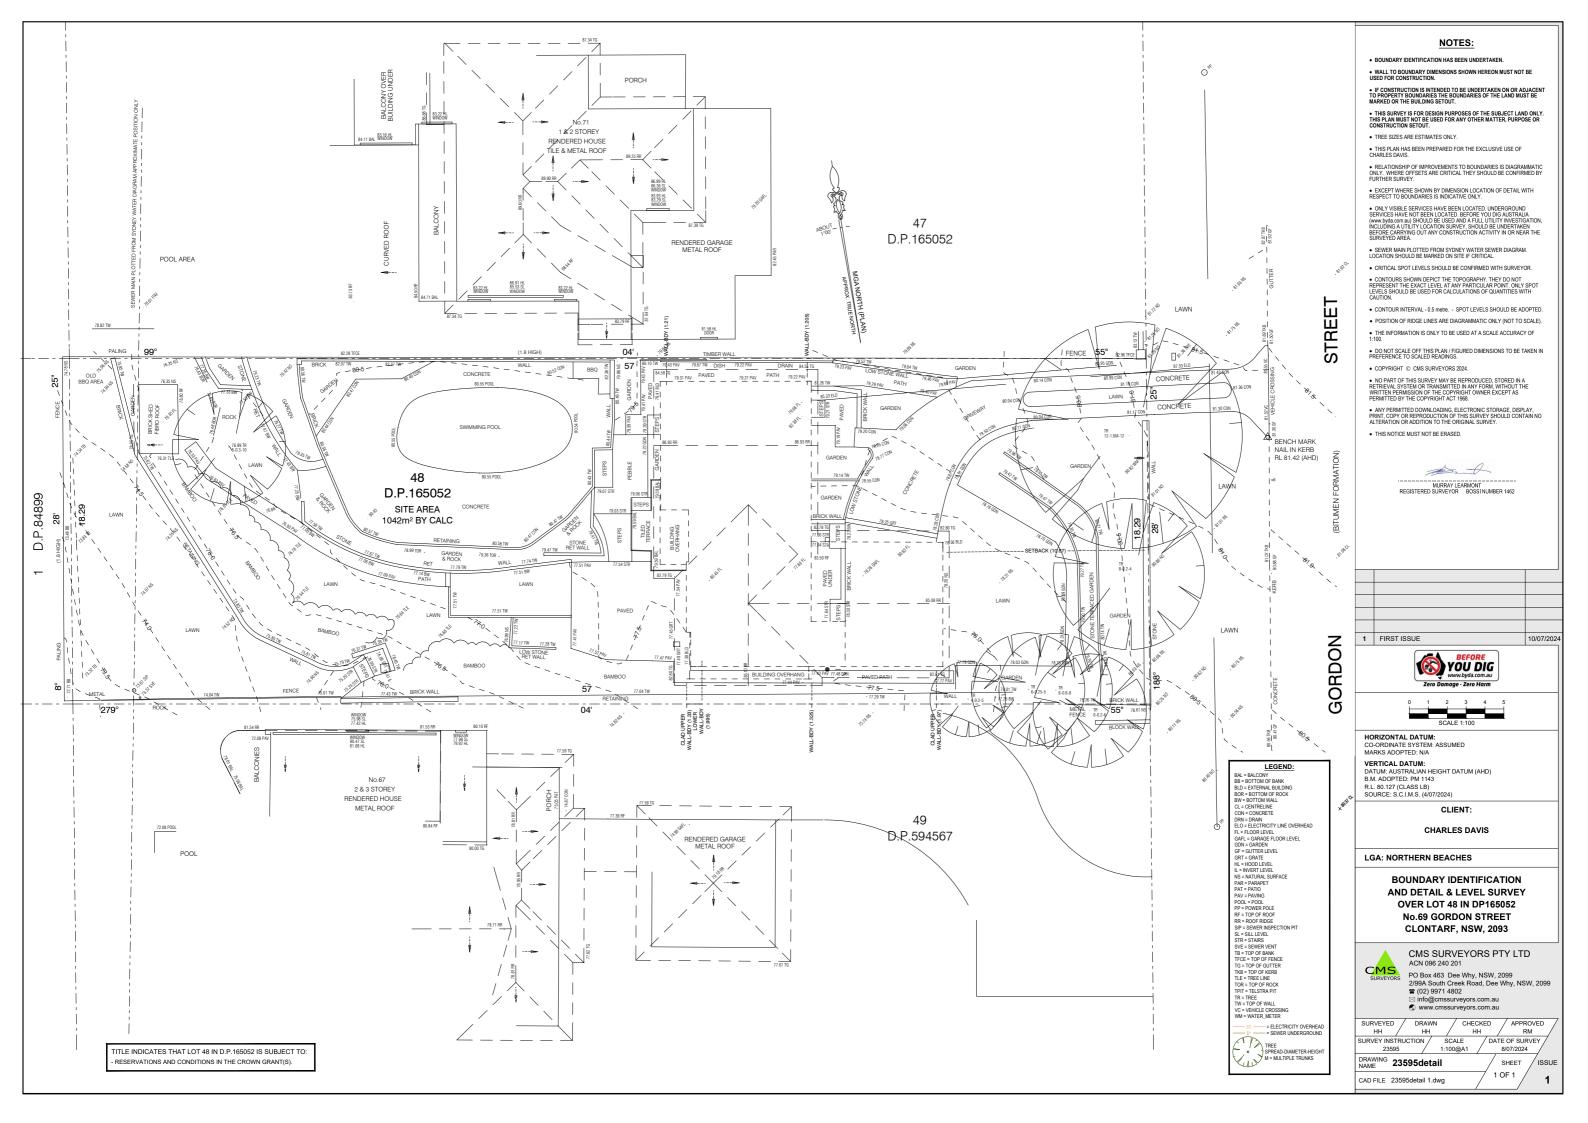


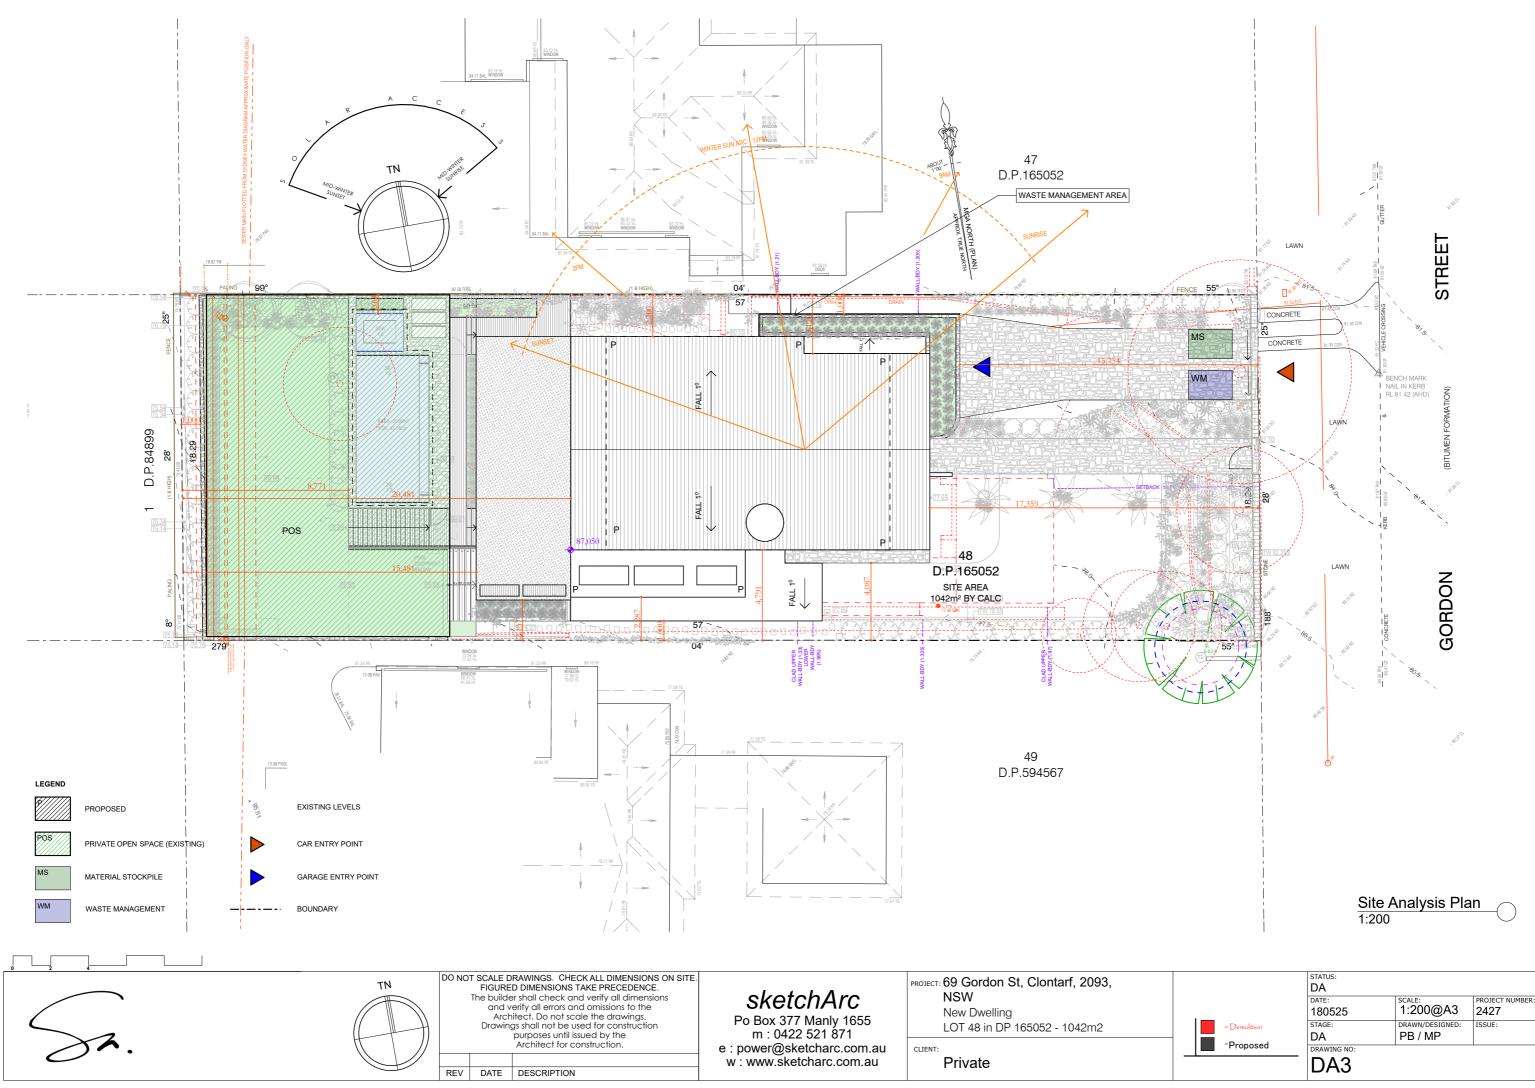



-Propose	d

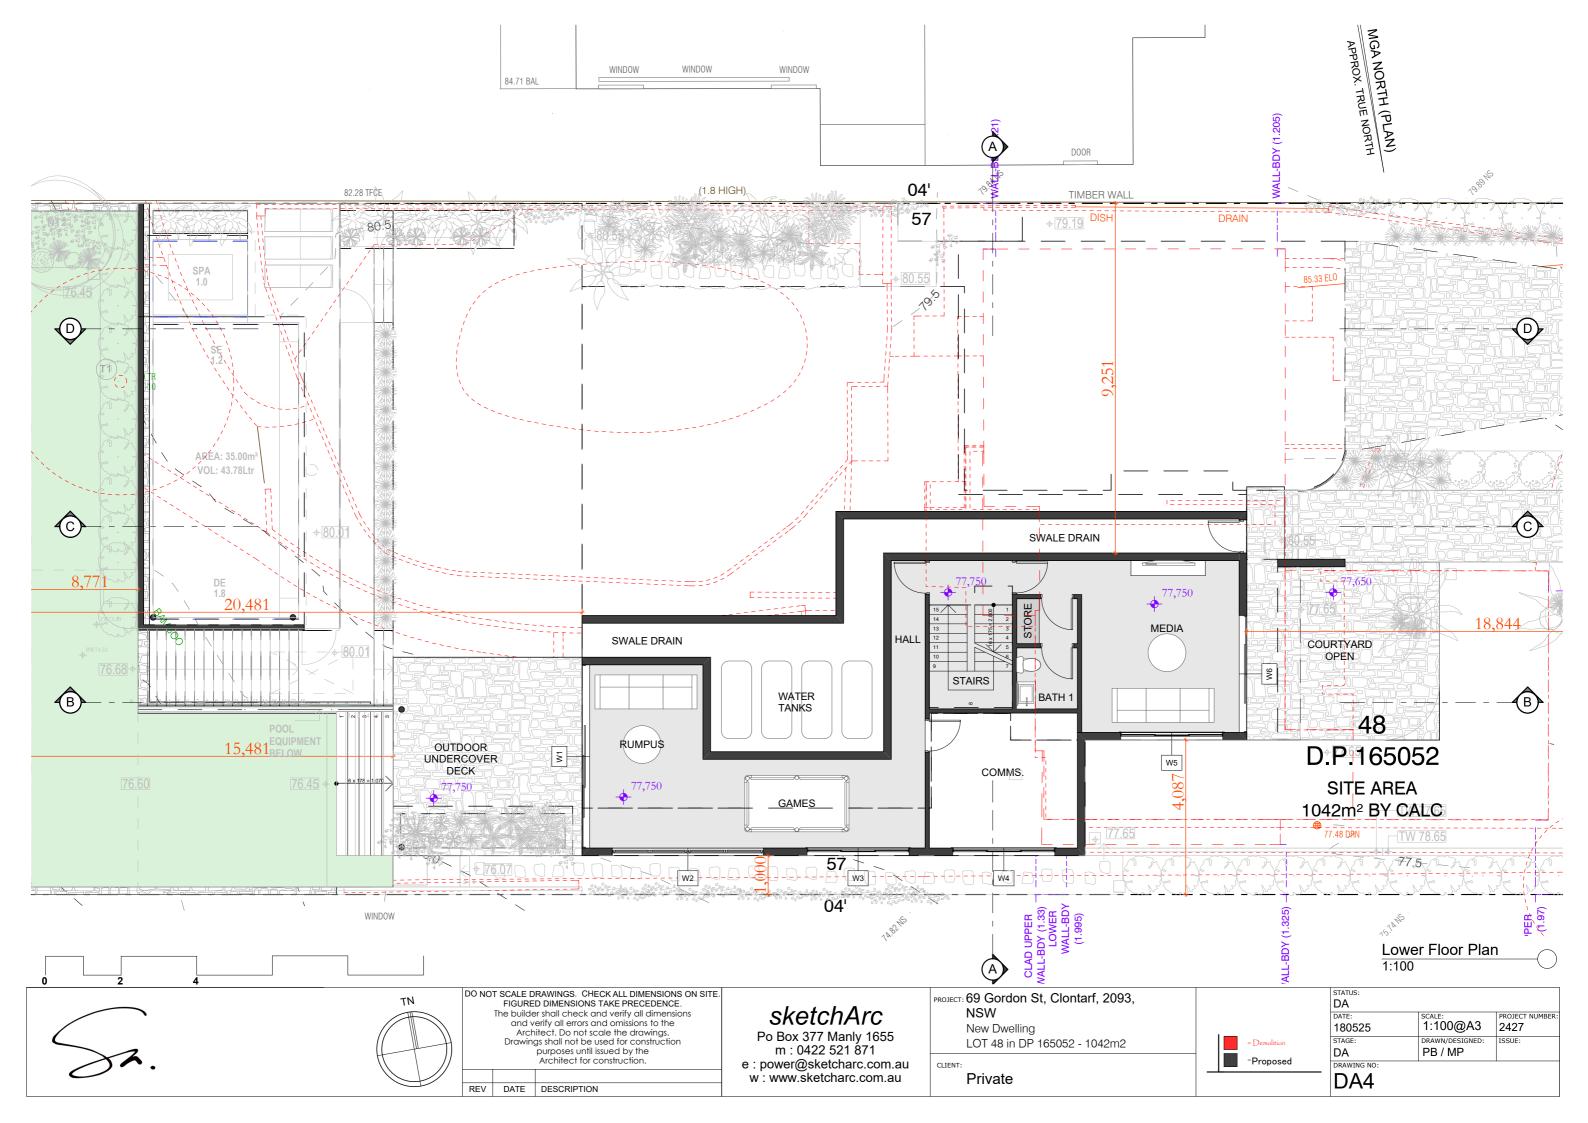


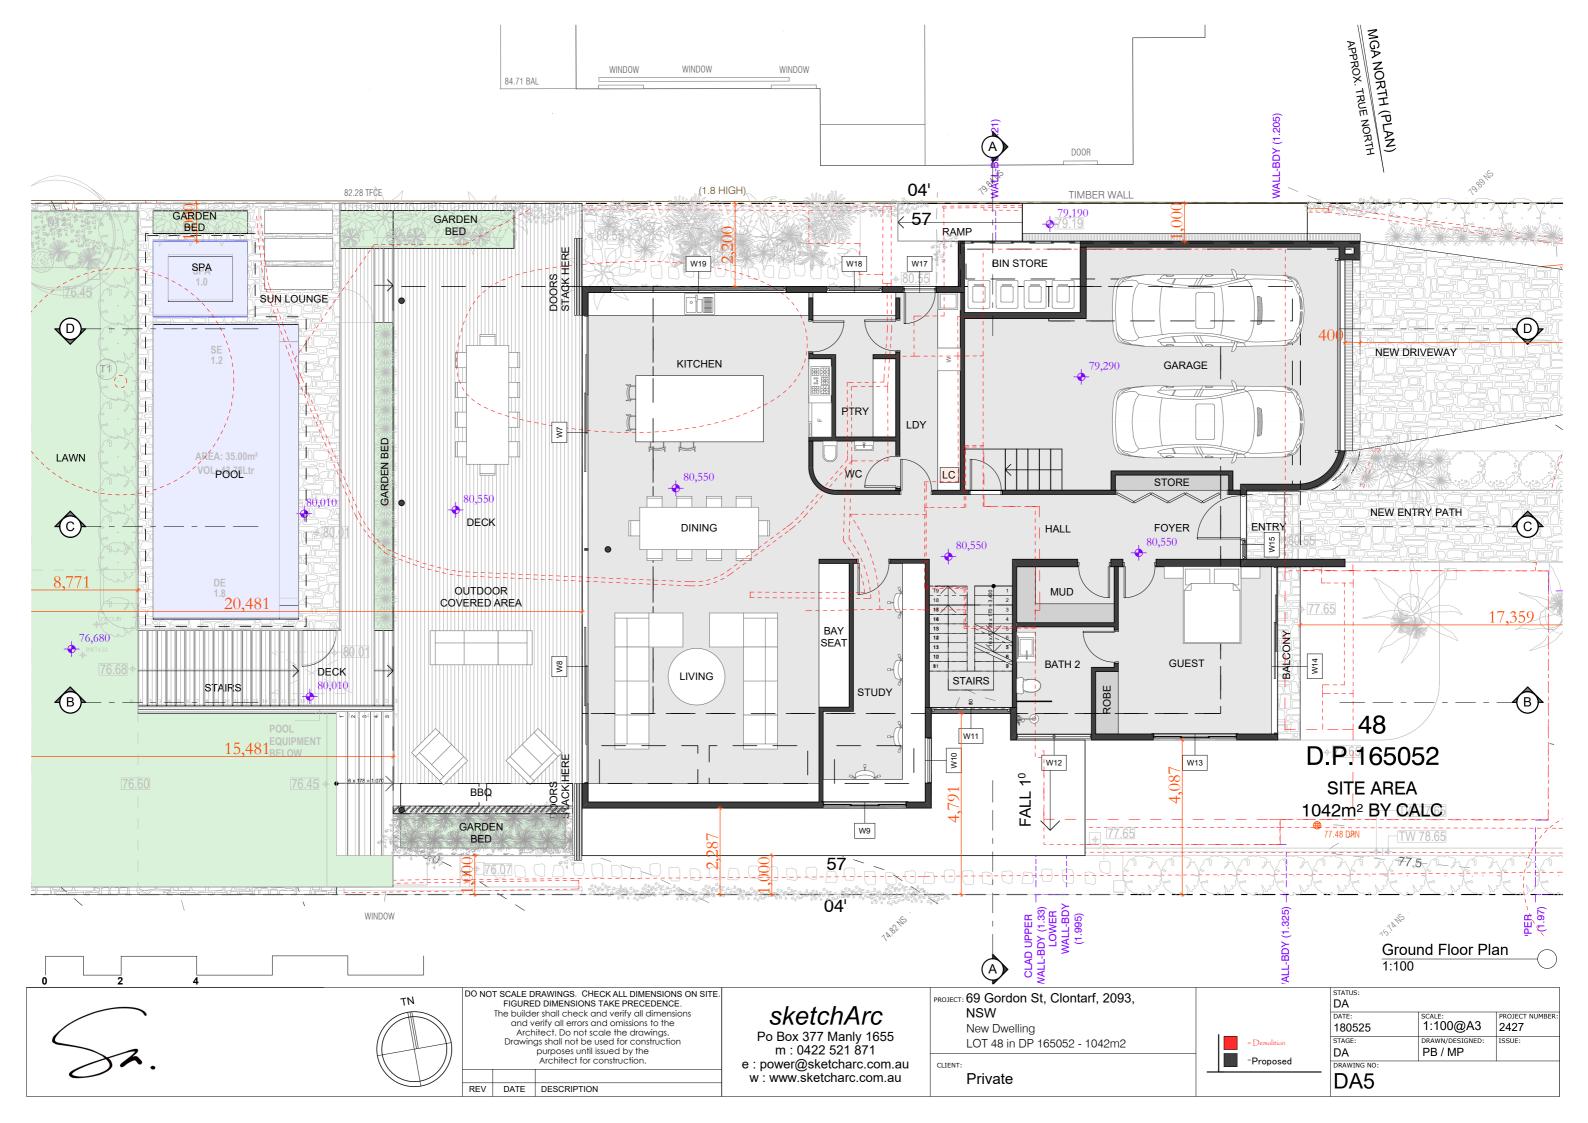

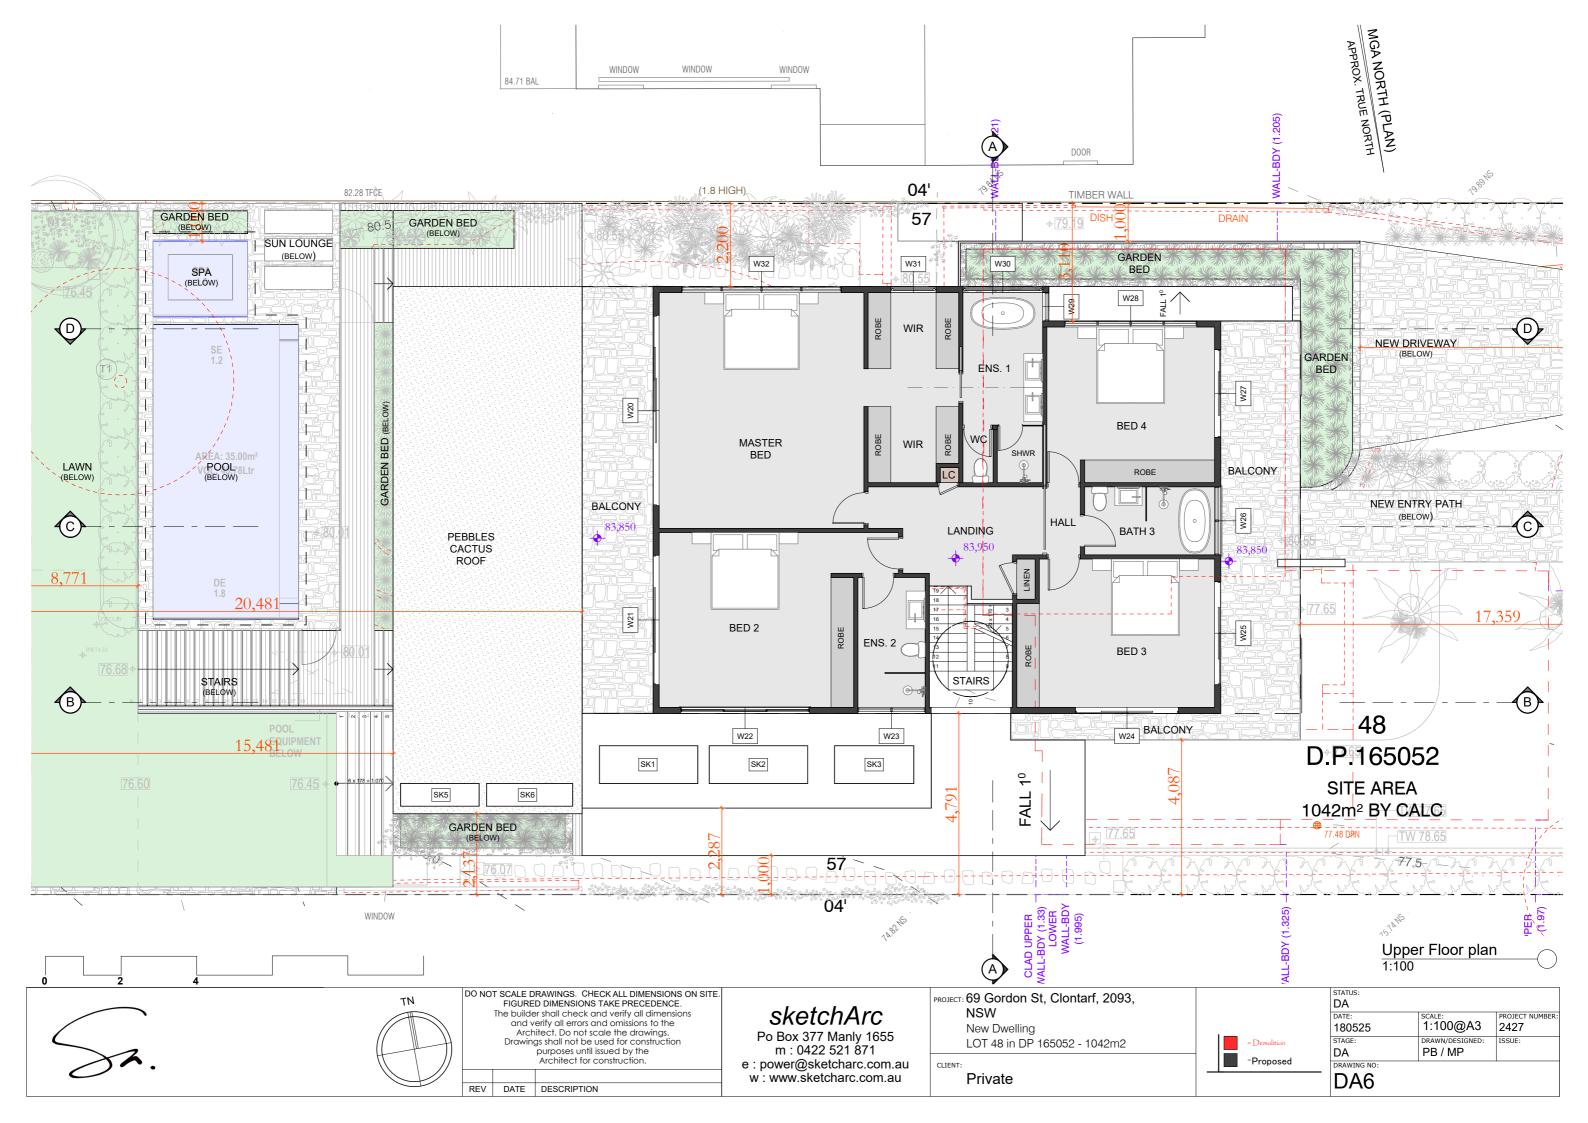

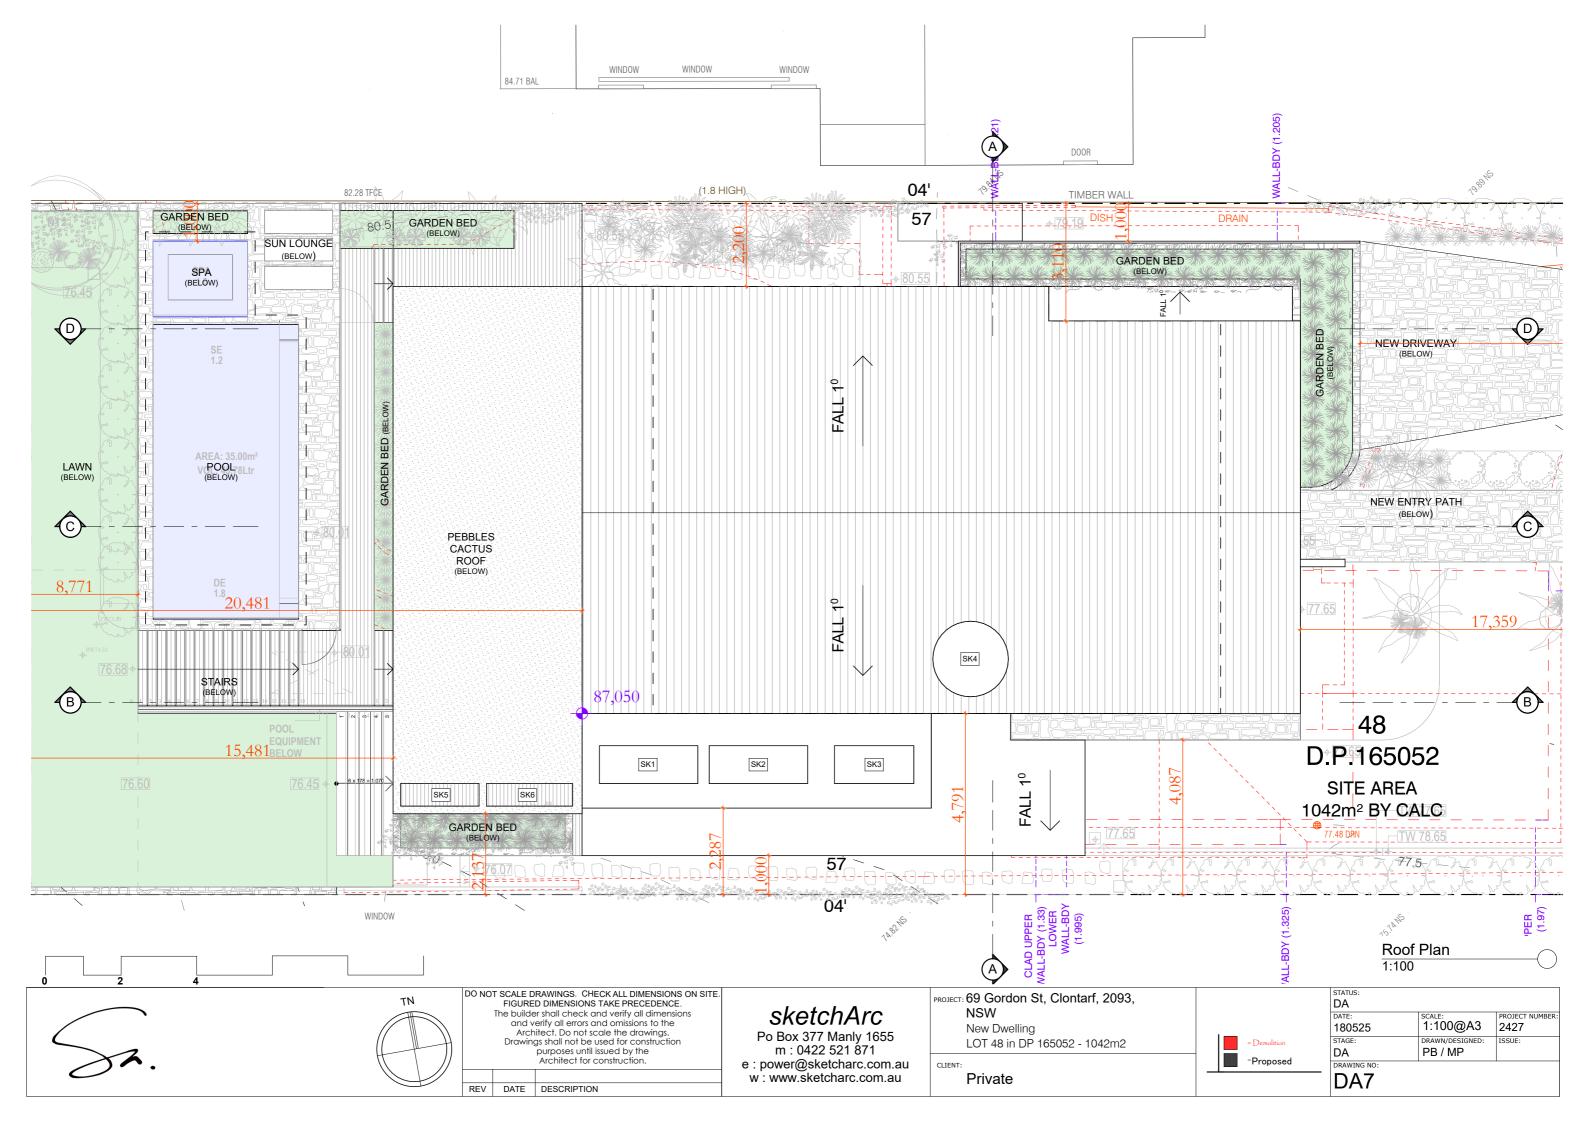


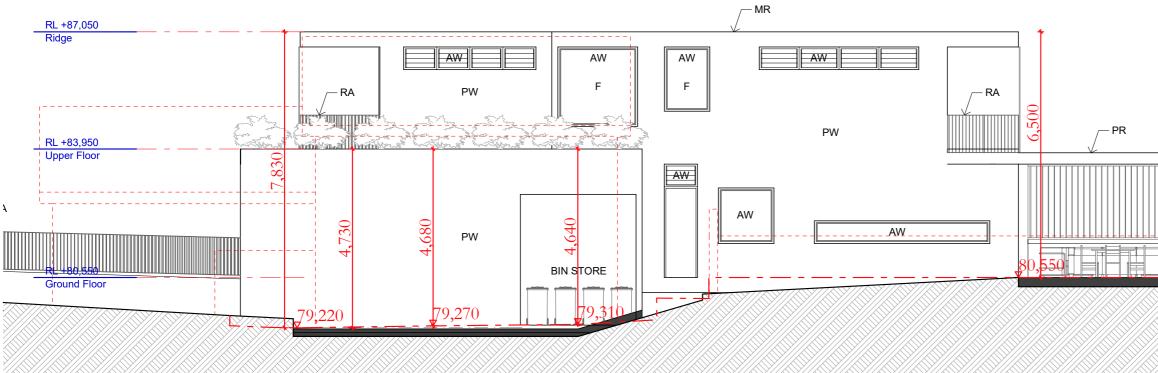


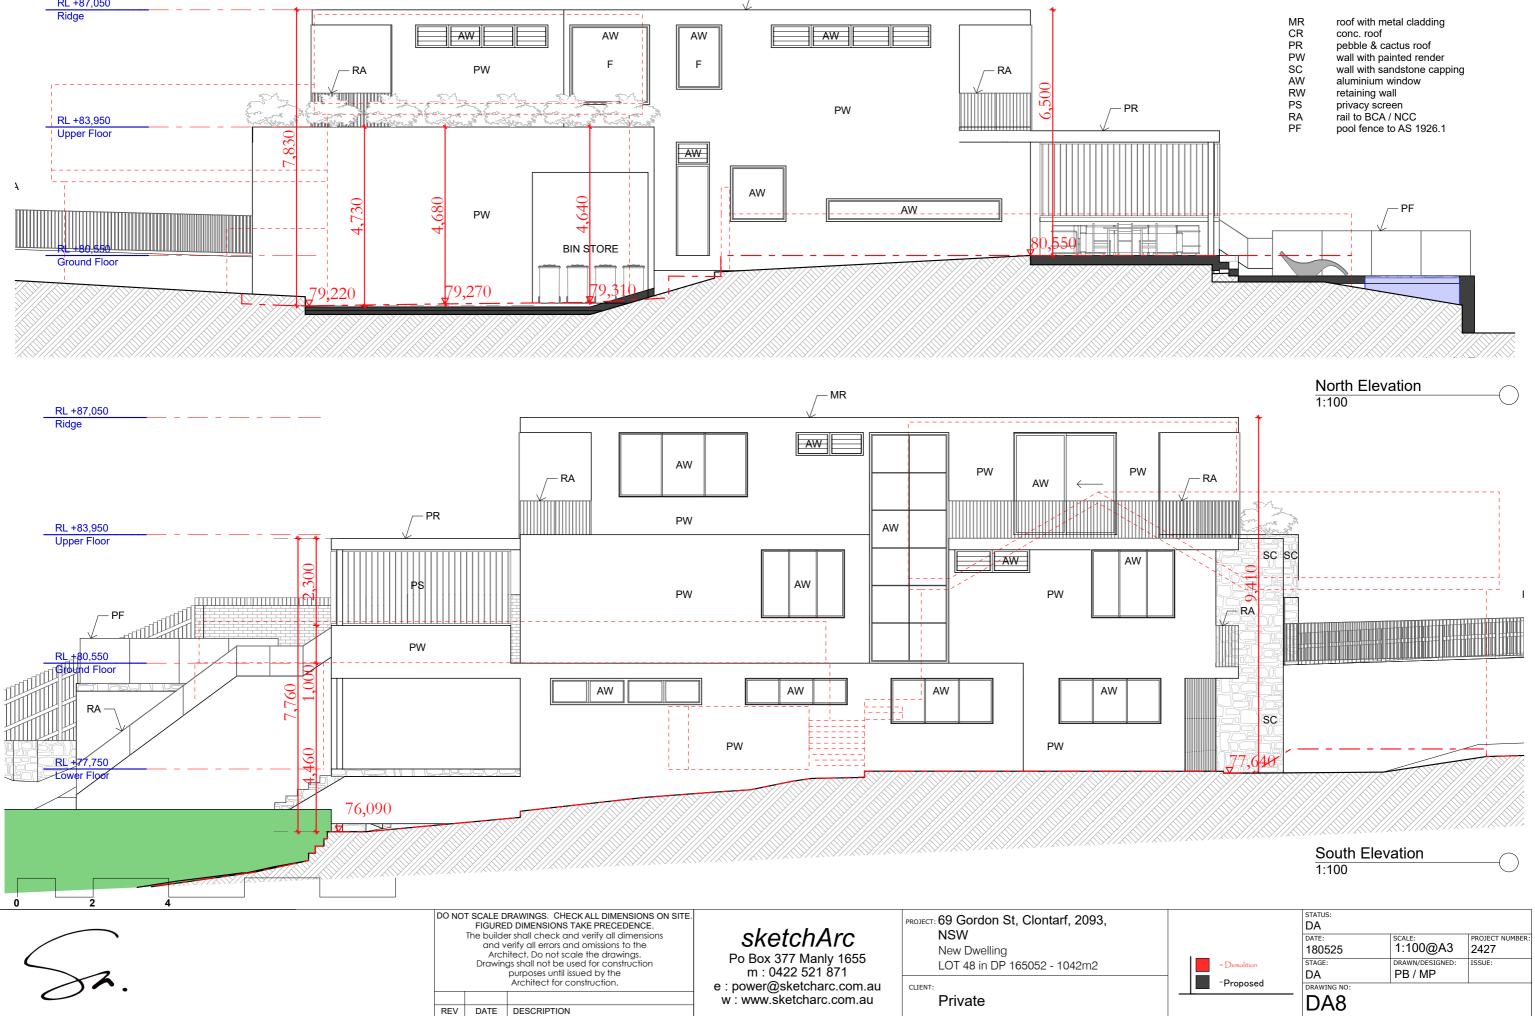


- roof with metal cladding
- conc. roof
- MR CR PW SC AW RW PS RA PF pebble & cactus roof
- wall with painted render wall with sandstone capping aluminium window
- retaining wall


- privacy screen rail to BCA / NCC pool fence to AS 1926.1

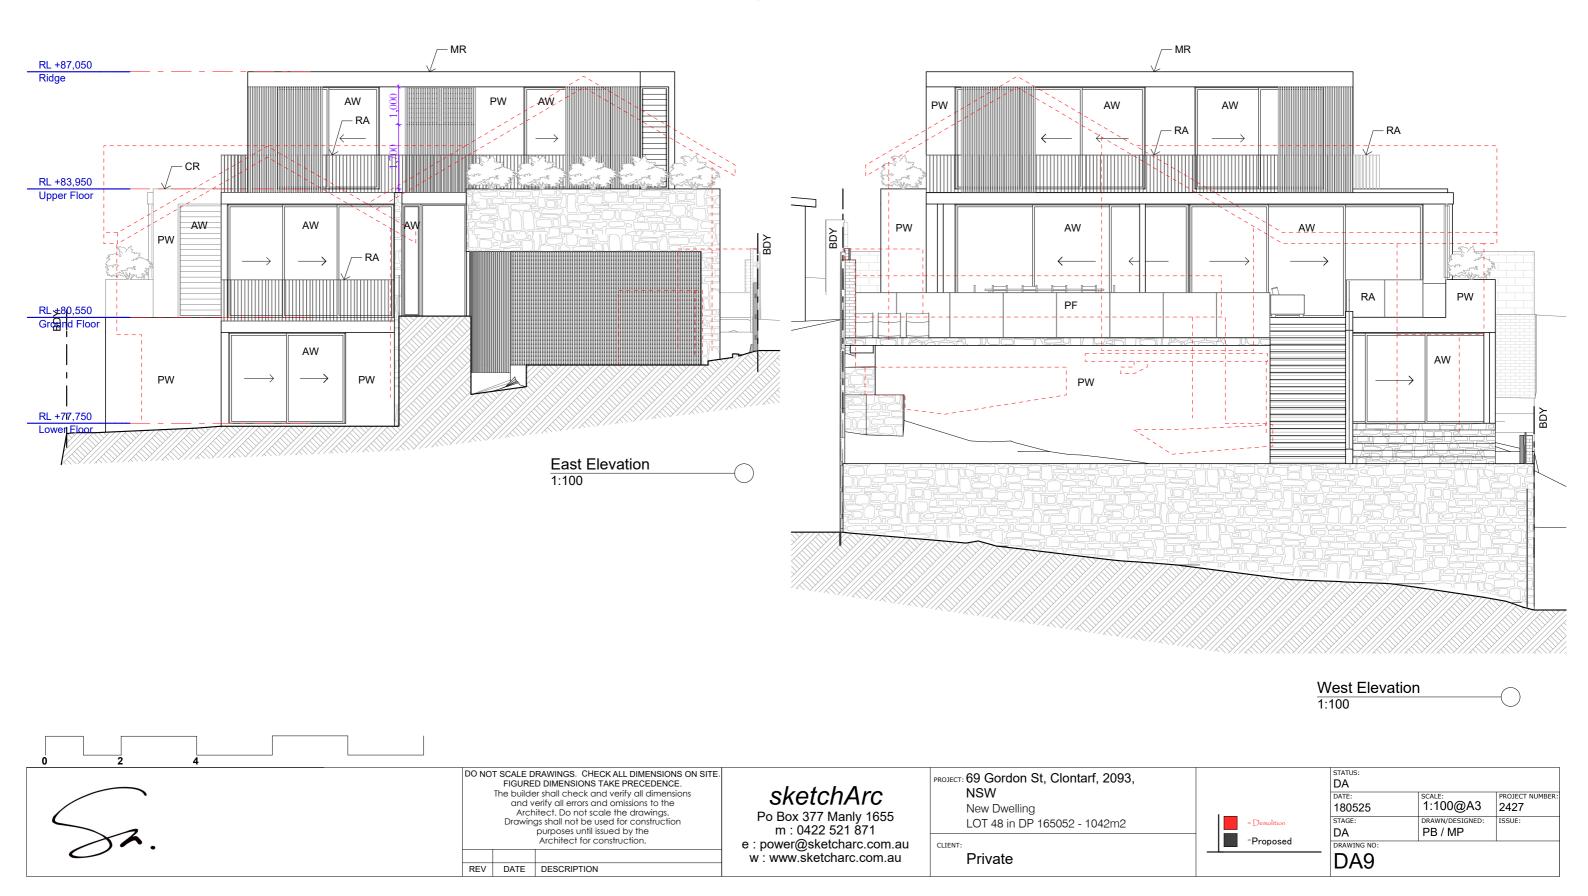


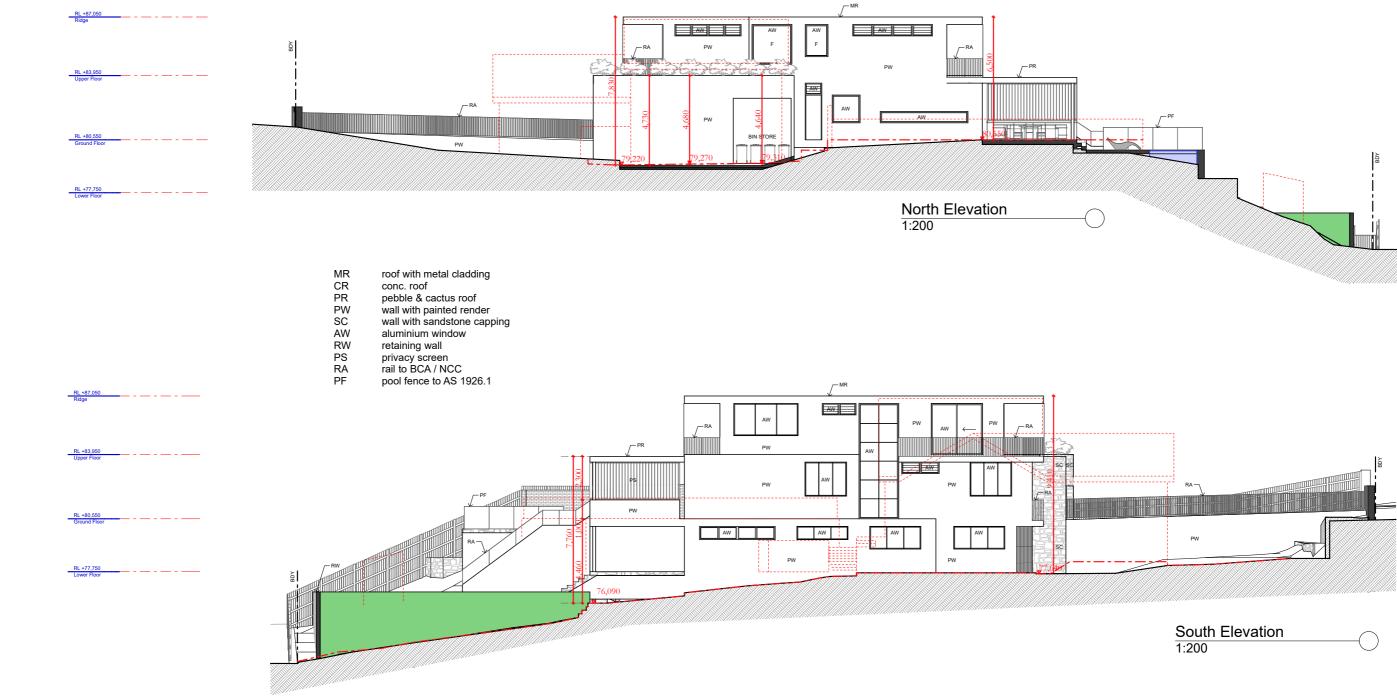


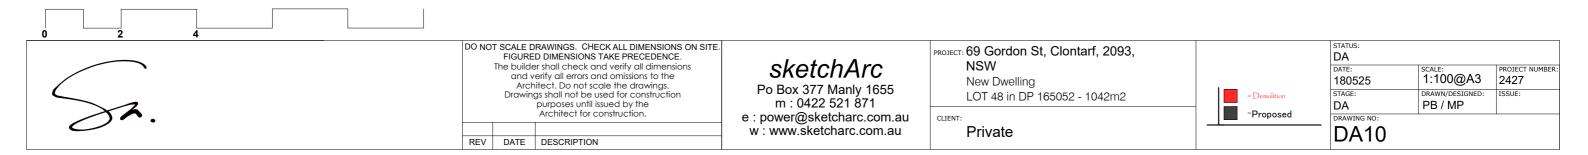


1:200	\bigcirc	

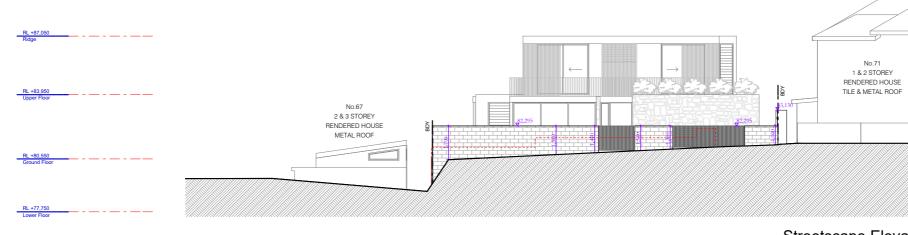


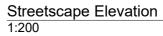

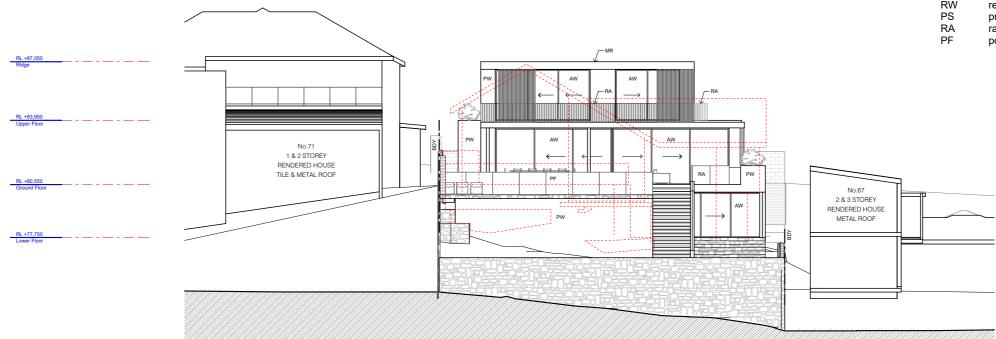



West Elevation

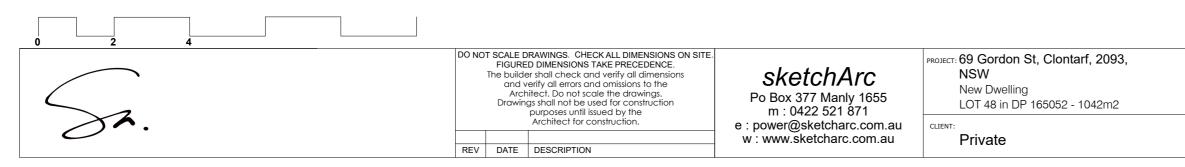


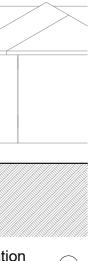



MR CR	roof with metal cladding conc. roof
PR	pebble & cactus roof
PW	wall with painted render
SC	wall with sandstone capping
AW	aluminium window
RW	retaining wall
PS	privacy screen
RA	rail to BCA / NCC
PF	pool fence to AS 1926.1

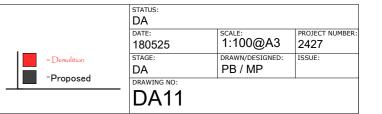

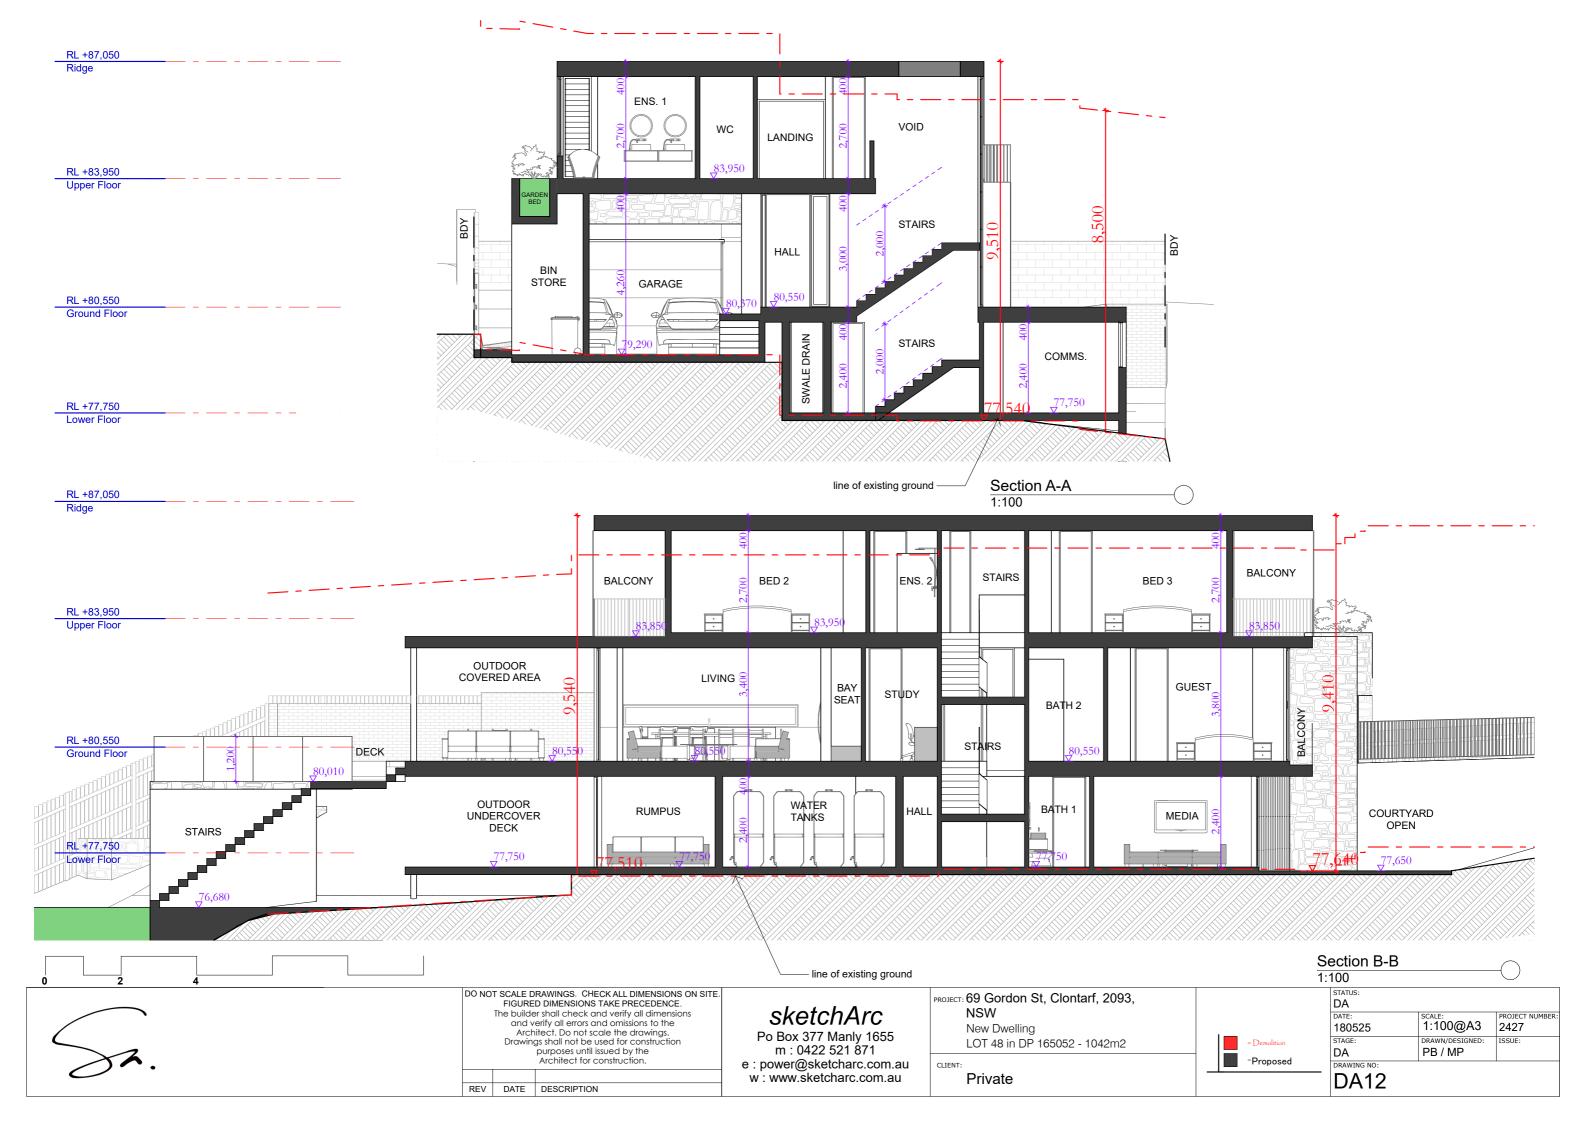

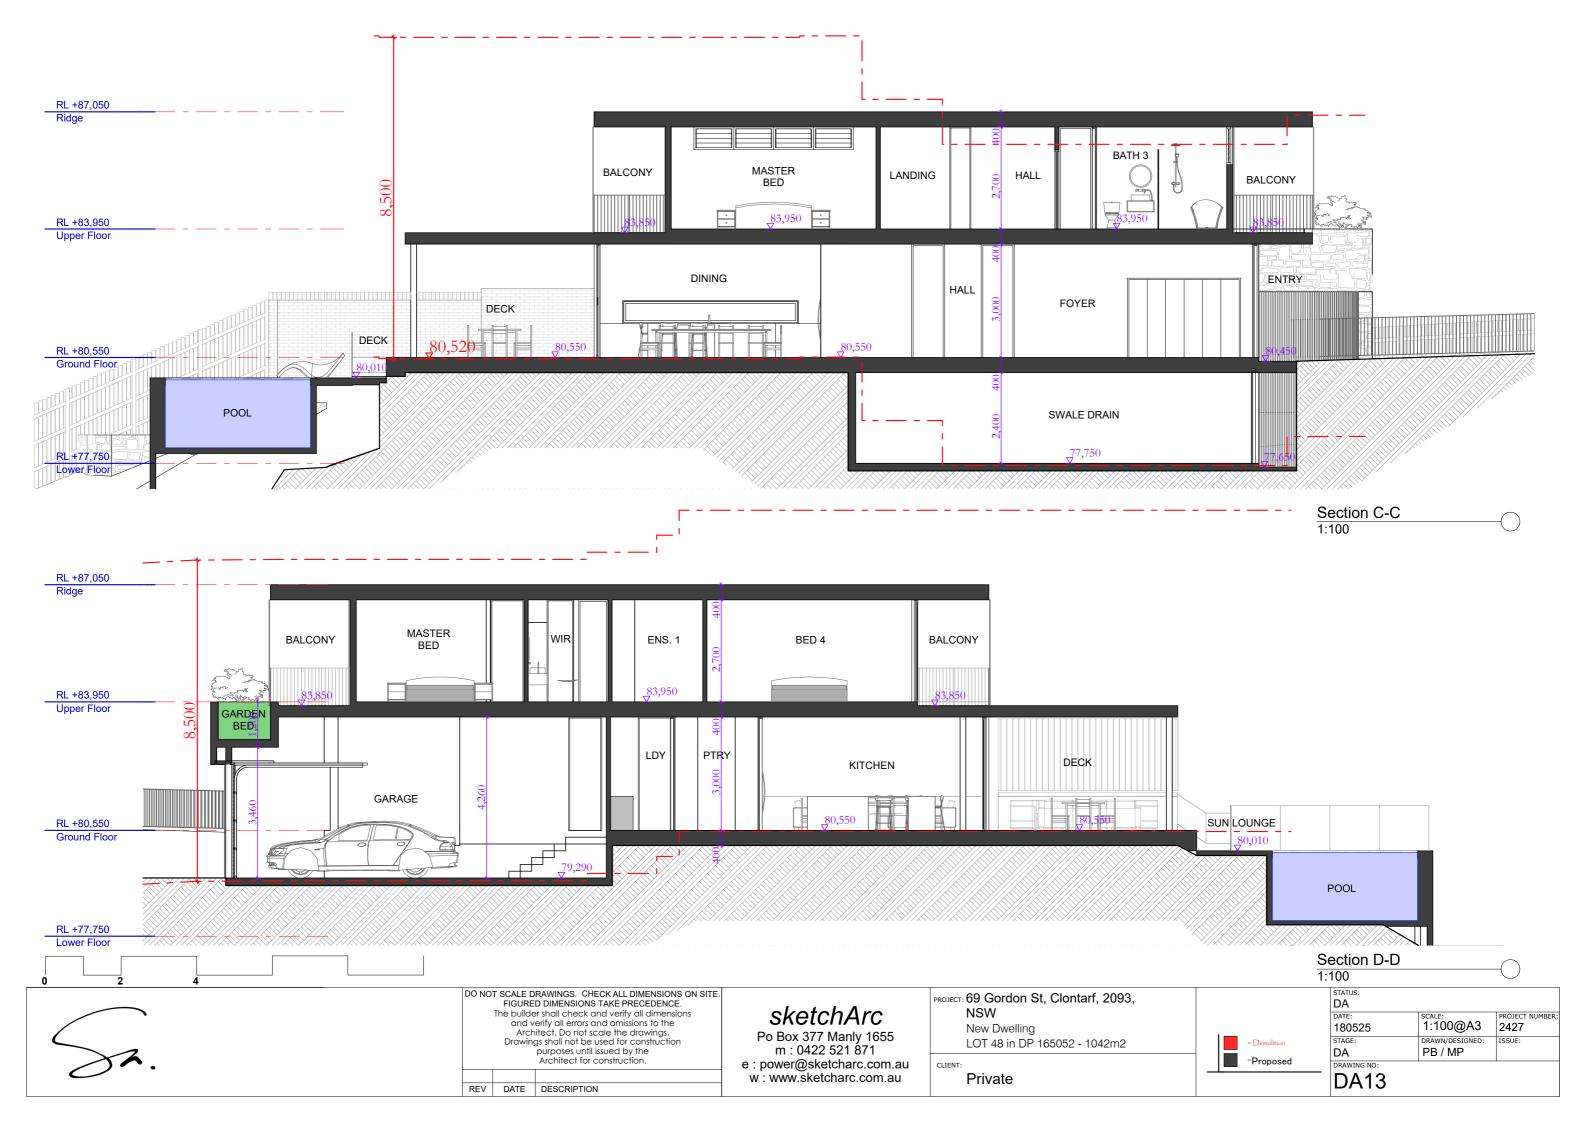

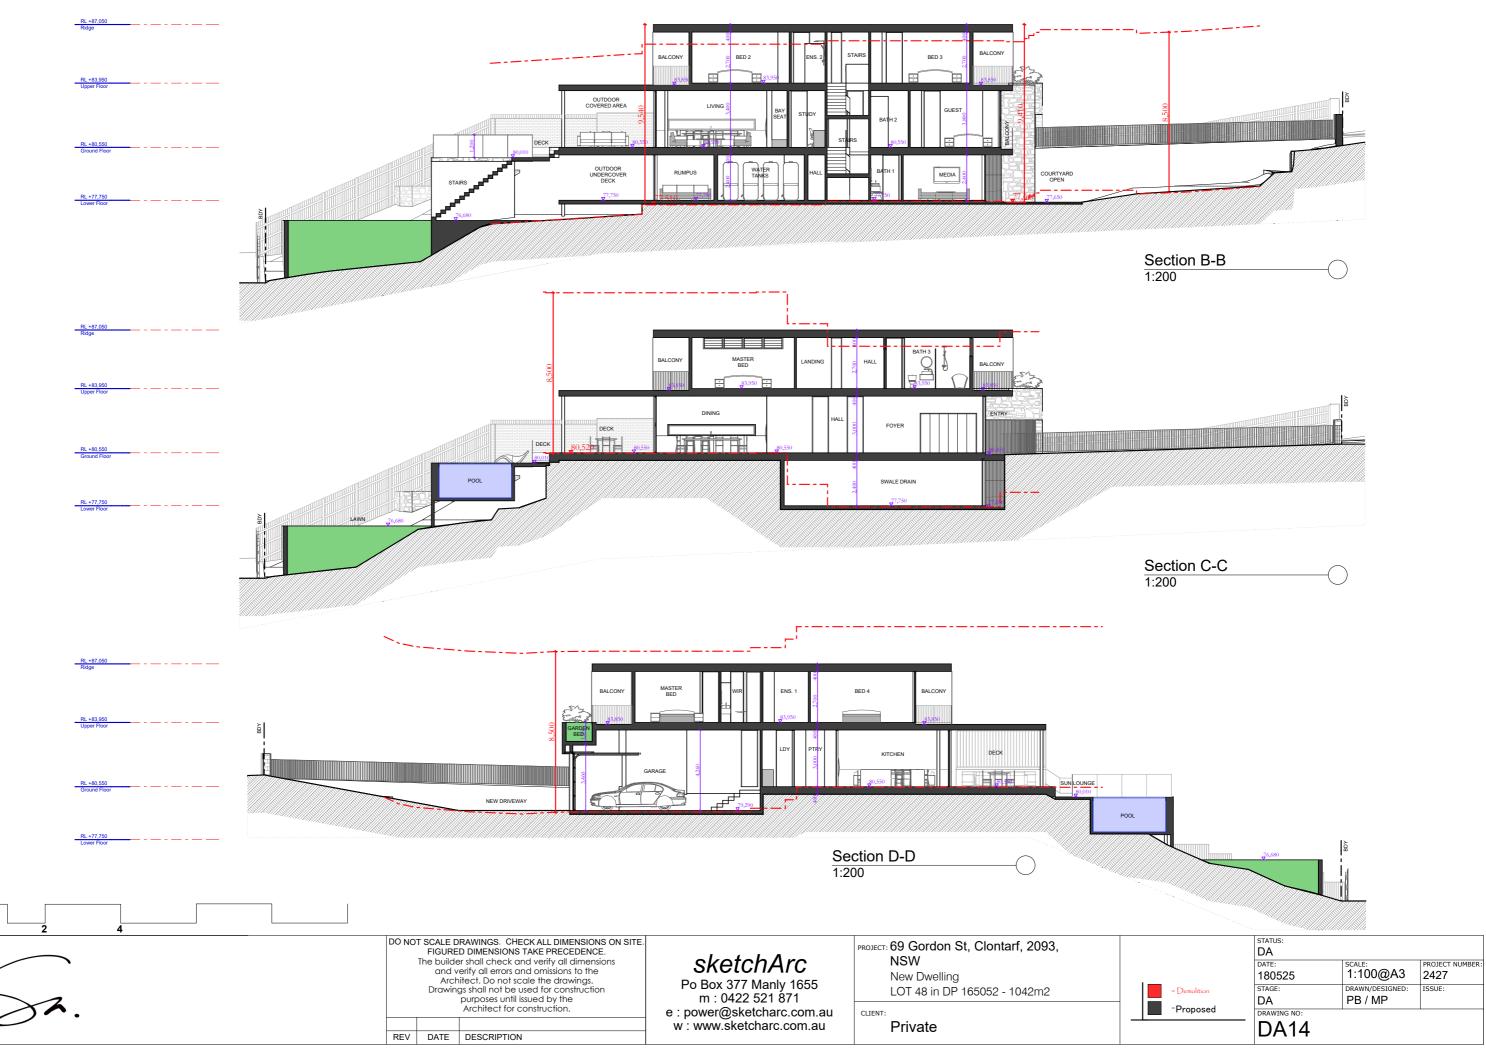

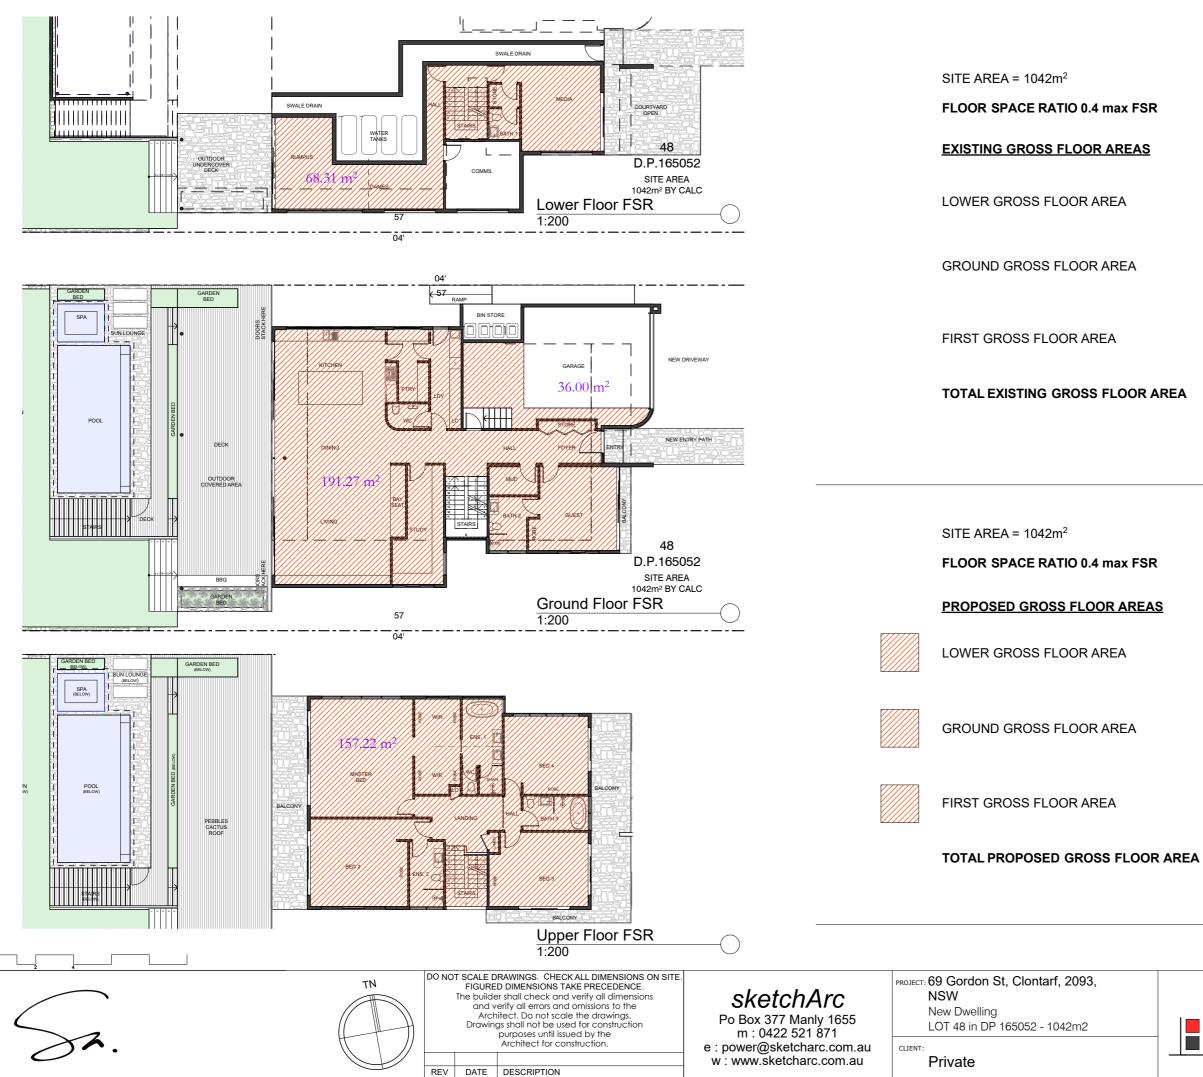

	STATUS:		
	DA		
	DATE:	SCALE:	PROJECT NUMBER:
	180525	1:200@A3	2427
= Demolition	STAGE:	DRAWN/DESIGNED:	ISSUE:
-Proposed	DA	PB / MP	
Froposed	DRAWING NO:		
	DA15		

AREA	= 416.8m ²
	= 157.22m ²
	= 191.27m ²
	= 68.31m ²
2	

= 416.8m²


= 143.72m²

= 48.91m²


= 416.8m²


 $= 54.81 \text{m}^2$


= 247.44m²

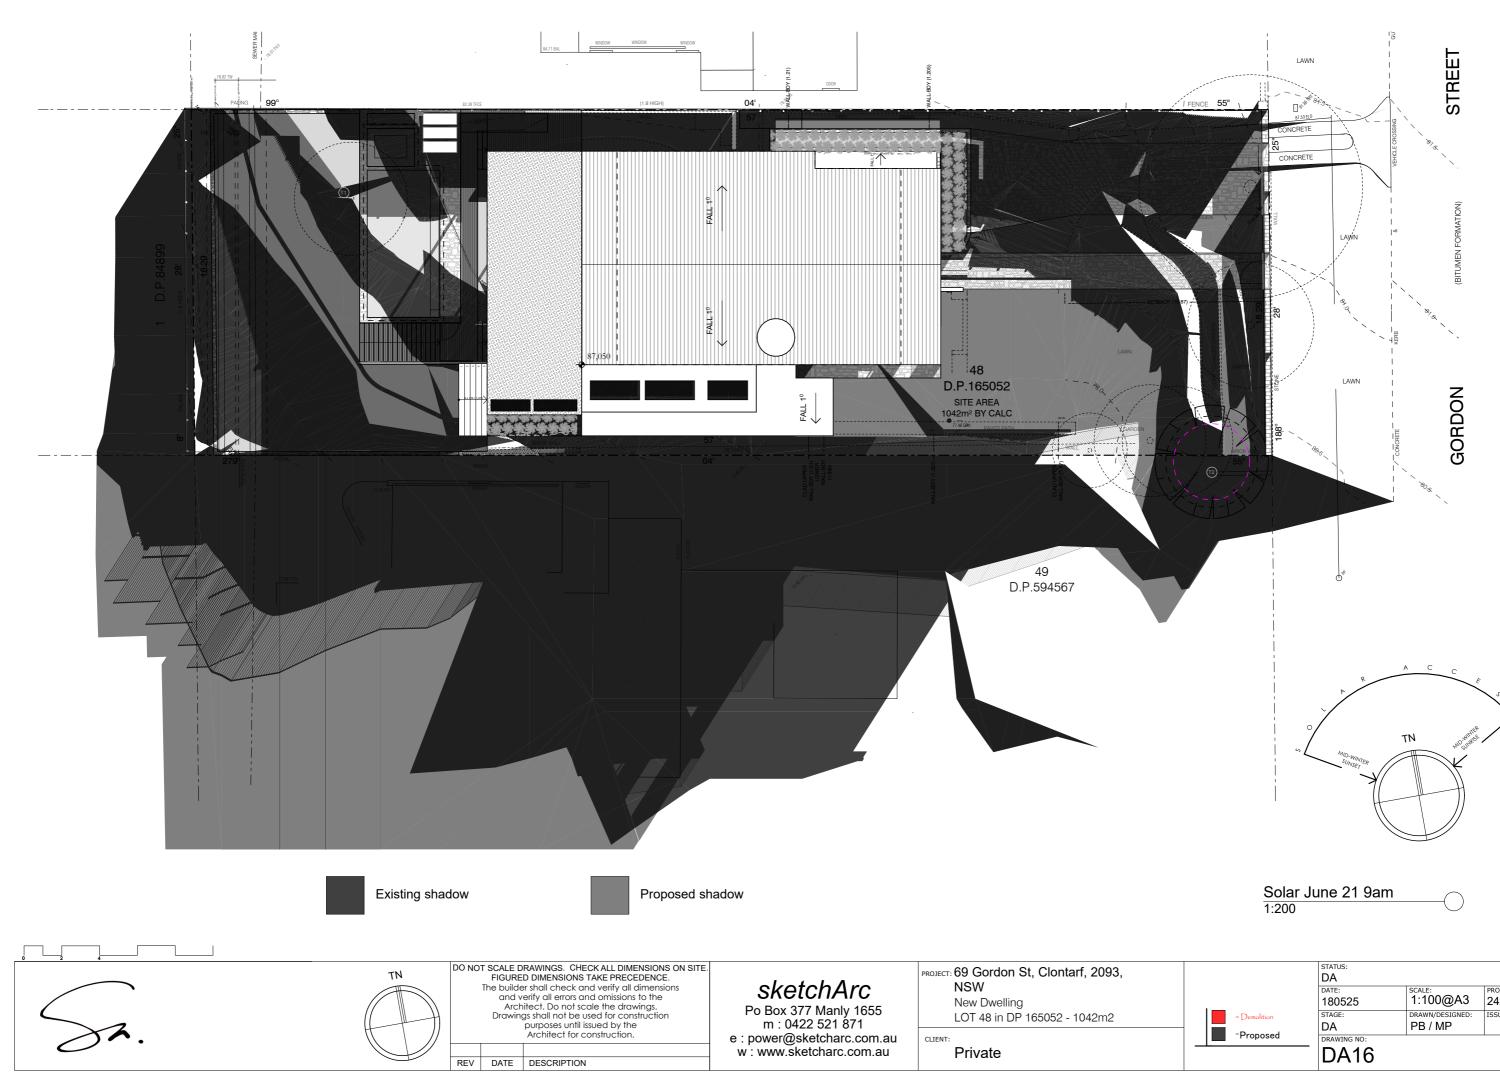

SCALE: PROJECT NUMBER: 2427 ISSUE

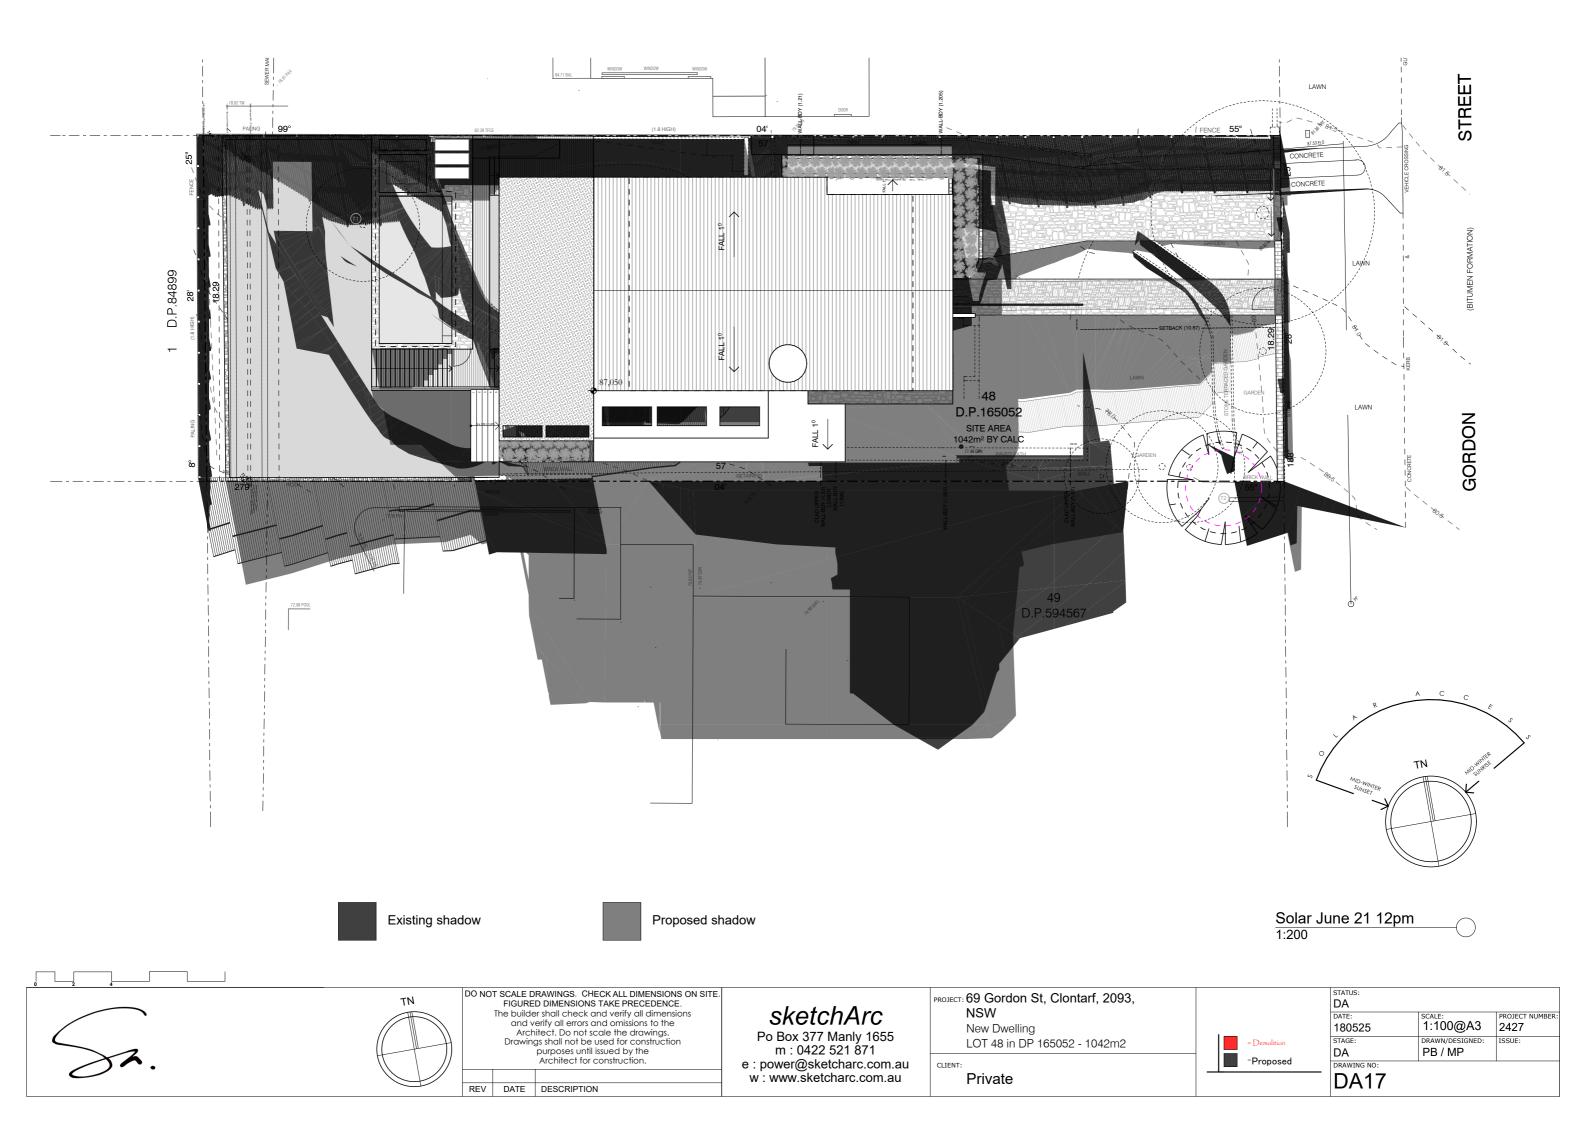

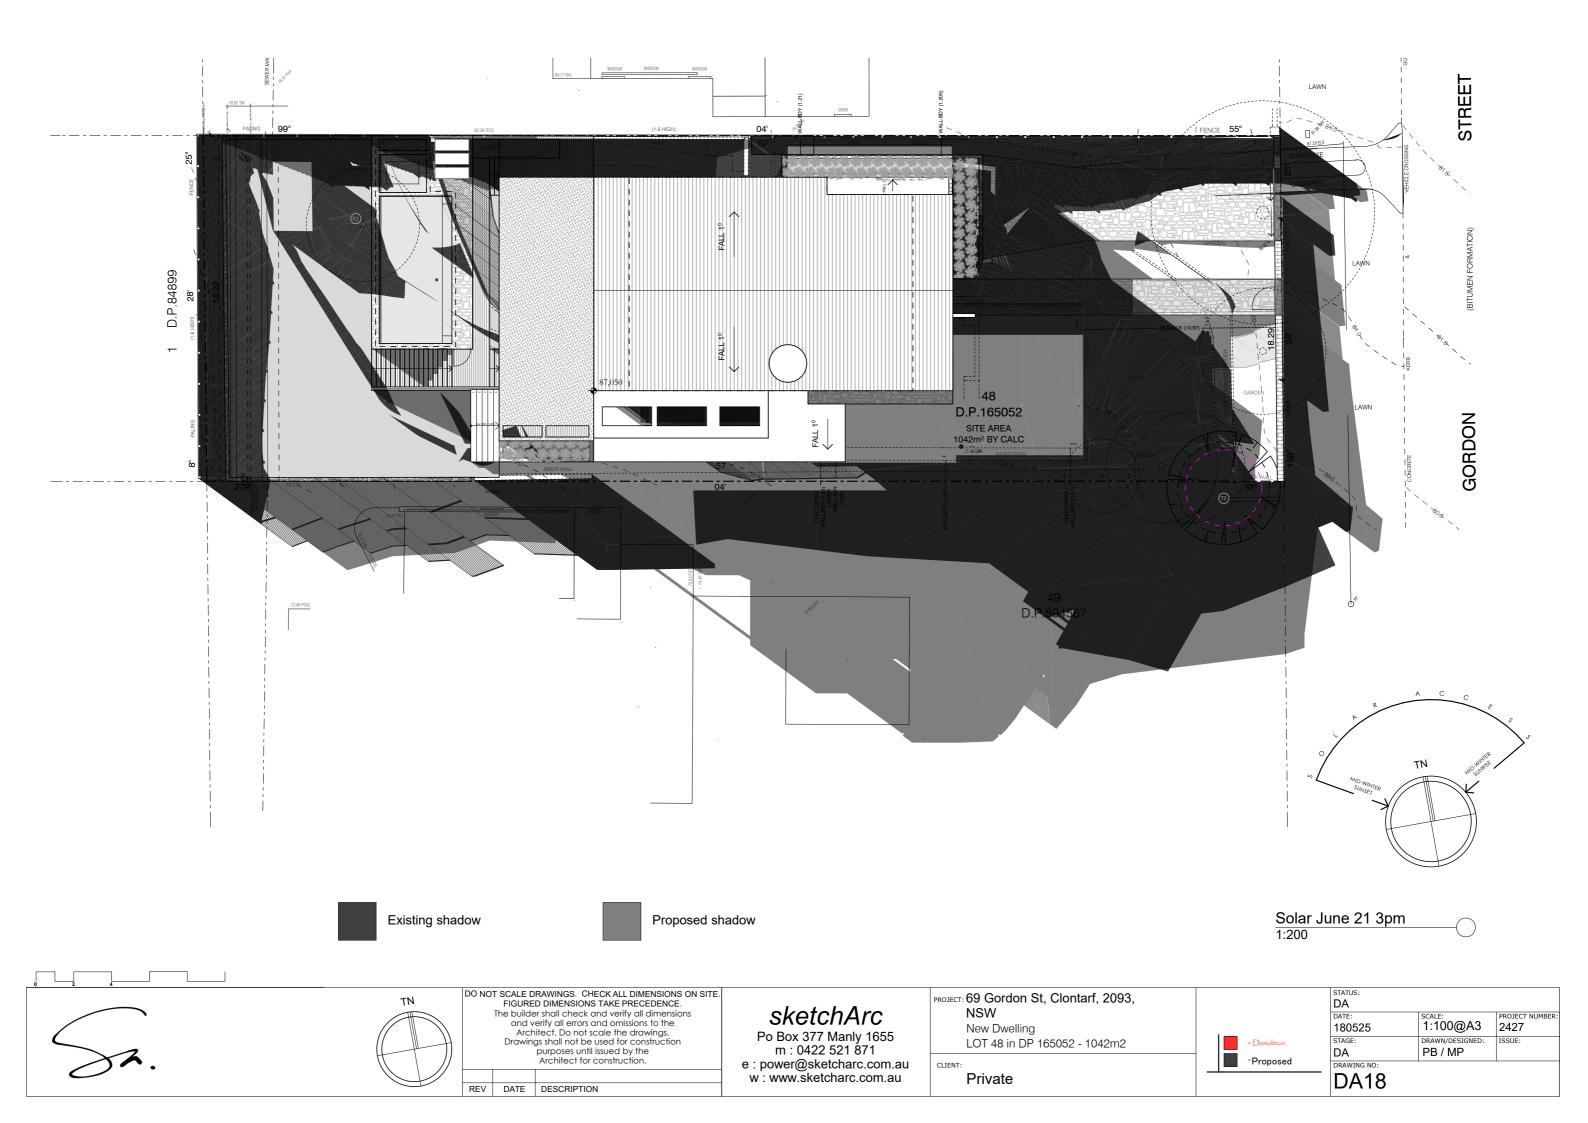

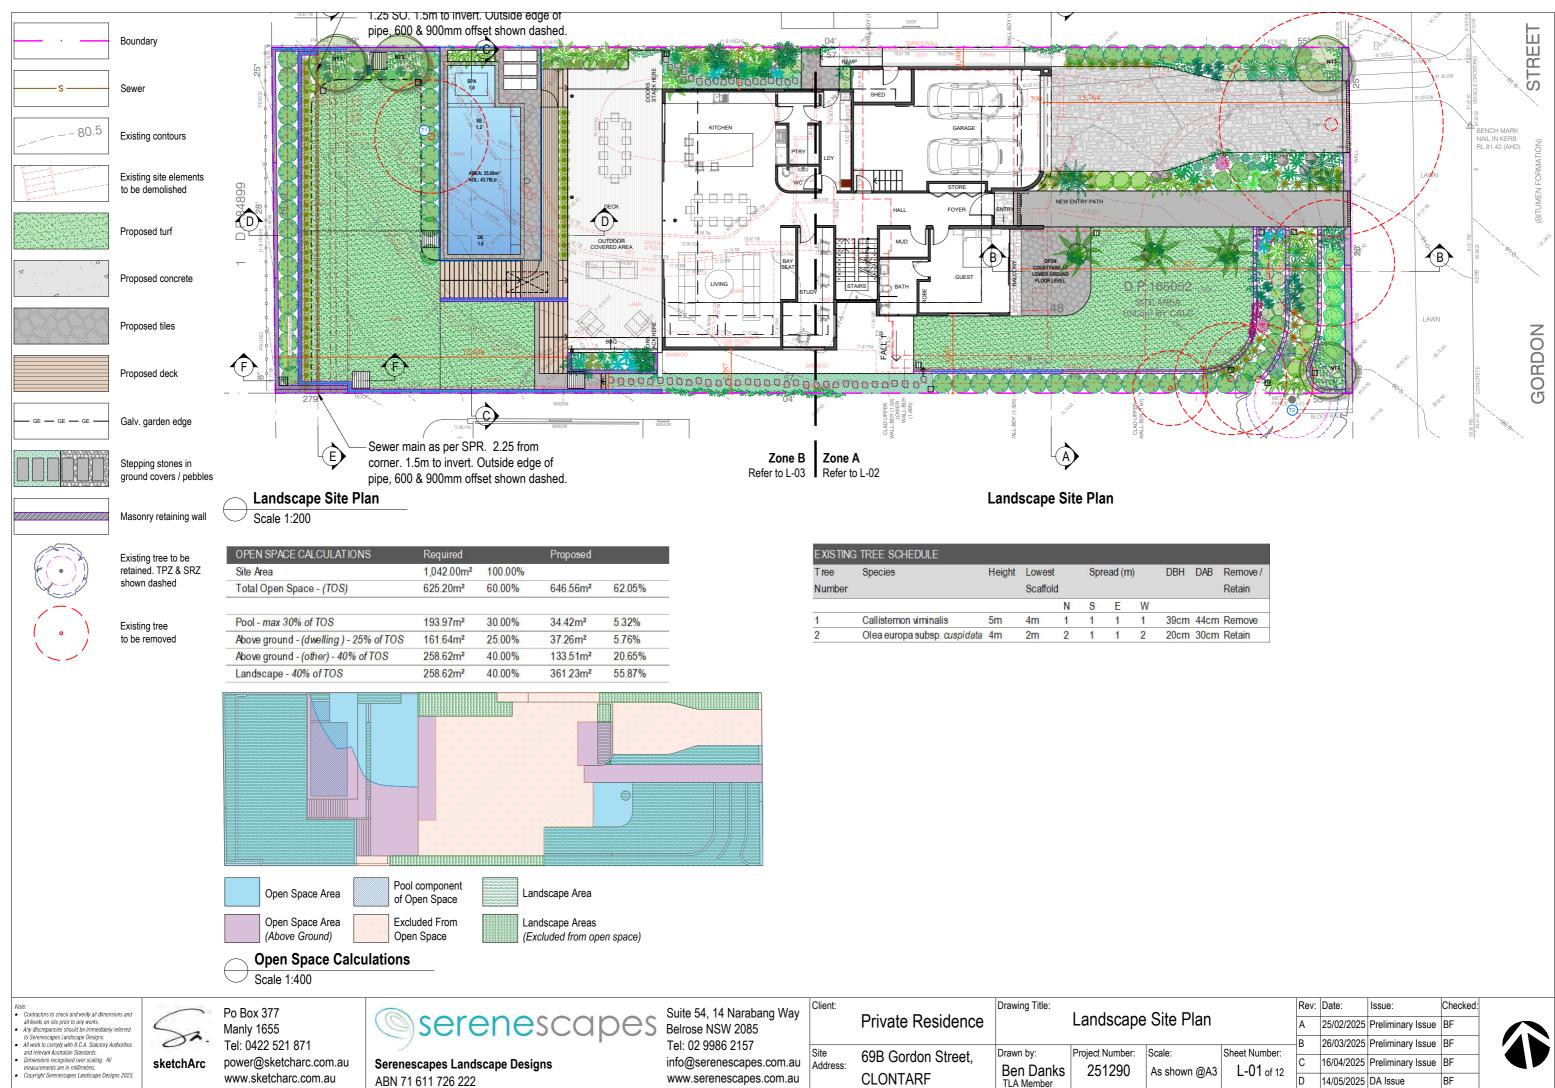

DAB	Remove /
	Retain
44cm	Remove
30cm	Retain

Plan		Rev:	Date:	Issue:	Checked:	
		A	25/02/2025	Preliminary Issue	BF	
	Sheet Number:	В	26/03/2025	Preliminary Issue	BF	
vn @A3	L-01 of 12	С	16/04/2025	Preliminary Issue	BF	
wi @AJ		D	14/05/2025	DA Issue	BF	



Existing ES June 21 - 9am



Existing ES June 21 - 12pm

ELEVATIONAL SHADOWS JUNE 21 9AM, 12PM, 3PM **EXISTING & PROPOSED**



Proposed ES June 21 - 9am



Proposed ES June 21 - 12pm





DO NOT SCALE DRAWINGS. CHECK ALL DIMENSIONS ON SITE. FIGURED DIMENSIONS TAKE PRECEDENCE. The builder shall check and verify all dimensions and verify all errors and omissions to the Architect. Do not scale the drawings. Drawings shall not be used for construction purposes until issued by the Architect for construction.

REV DATE DESCRIPTION

sketchArc Po Box 377 Manly 1655 m : 0422 521 871 e : power@sketcharc.com.au w : www.sketcharc.com.au

PROJECT: 69 Gordon St, Clontarf, 2093, NSW New Dwelling LOT 48 in DP 165052 - 1042m2

CLIENT: Private



Proposed ES June 21 - 3pm

	STATUS: DA		
	DATE: 180525	SCALE: 1:100@A3	PROJECT NUMBER: 2427
= Demolition	STAGE: DA	DRAWN/DESIGNED: PB / MP	ISSUE:
⁻ Proposed	- DRAWING NO:		



Proposed (No top floor) ES June 21 - 9am FAR



Proposed (No top floor) ES June 21 - 12pm FAR

ELEVATIONAL SHADOWS JUNE 21

9AM, 12PM, 3PM

Proposed - First Floor removed as comparison







Proposed ES June 21 - 9am FAR



Proposed ES June 21 - 12pm FAR





The builder shall check and verify all dimensions and verify all errors and omissions to the Architect. Do not scale the drawings. Drawings shall not be used for construction purposes until issued by the Architect for construction.

REV DATE DESCRIPTION

DO NOT SCALE DRAWINGS. CHECK ALL DIMENSIONS ON SITE. FIGURED DIMENSIONS TAKE PRECEDENCE.

sketchArc Po Box 377 Manly 1655 m : 0422 521 871 e : power@sketcharc.com.au w : www.sketcharc.com.au CLIENT:

PROJECT: 69 Gordon St, Clontarf, 2093, NSW New Dwelling LOT 48 in DP 165052 - 1042m2

Private

Proposed (No top floor) ES June 21 - 3pm FAR

	STATUS: DA		
	DATE: 180525	scale: 1:100@A3	PROJECT NUMBER: 2427
= Demolition	STAGE: DA	DRAWN/DESIGNED: PB / MP	ISSUE:
-Proposed	DRAWING NO:		

BASIX[™]Certificate

Building Sustainability Index www.planningportal.nsw.gov.au/development-and-assessment/basix

Single Dwelling

Certificate number: 1795799S

This certificate confirms that the proposed development will meet the NSW government's requirements for sustainability, if it is built in accordance with the commitments set out below. Terms used in this certificate, or in the commitments, have the meaning given by the document entitled "BASIX Definitions" dated 10/09/2020 published by the Department. This document is available at www.planningportal.nsw.gov.au/definitions

Secretary Date of issue: Friday, 16 May 2025 To be valid, this certificate must be submitted with a development application or lodged with a complying development certificate application within 3 months of the date of issue.



When submitting this BASIX certificate with a development application or complying development certificate application, it must be accompanied by NatHERS certificate H43KQ9S181.

Project summary		
Project name	69 Gordon Street Clontarf	
Street address	69 GORDON Street CLONT	ARF 2093
Local Government Area	Northern Beaches Council	-
Plan type and plan number	Deposited Plan DP165052	
Lot no.	48	-
Section no.	-	
Project type	dwelling house (detached)	-
No. of bedrooms	5	
Project score		
Water	V 40	Target 40
Thermal Performance	V Pass	Target Pass
Energy	78	Target 72
Materials	-100	Target n/a

Certificate Prepared by Name / Company Name: PAUL&DAVID CONSULTING PTY LTD. ABN (if applicable):

Description of project

Project address		
Project name	69 Gordon Street Clontarf	
Street address	69 GORDON Street CLONTARF 2093	
Local Government Area	Northern Beaches Council	
Plan type and plan number	Deposited Plan DP165052	
Lot no.	48	
Section no.	-	
Project type		
Project type	dwelling house (detached)	
No. of bedrooms	5	
Site details		
Site area (m ²)	1042	
Roof area (m ²)	208	
Conditioned floor area (m ²)	372.4	
Unconditioned floor area (m ²)	20.0	
Total area of garden and lawn (m ²)	392	
Roof area of the existing dwelling (m ²)	0	

NatHERS assessor number	101225	
NatHERS certificate number	H43KQ9S181	
Climate zone	56	
Area adjusted cooling load (MJ/ m ² .year)	11	
Area adjusted heating load (MJ/ m ² .year)	19	
Project score		
Water	✓ 40	Target 40
Thermal Performance	V Pass	Target Pass
Energy	78	Target 72
Materials	-100	Target n/a

Schedule of BASIX commitments

The commitments set out below regulate how the proposed development is to be carried out. It is a condition of any development consent granted, or complying development certificate issued, for the proposed development, that BASIX commitments be complied with.

Water Commitments	Show on DA plans	Show on CC/CDC plans & specs	Certifier check
Fixtures			
The applicant must install showerheads with a minimum rating of 4 star (> 4.5 but <= 6 L/min plus spray force and/or coverage tests) in all showers in the development.		~	~
The applicant must install a toilet flushing system with a minimum rating of 4 star in each toilet in the development.		 	~
The applicant must install taps with a minimum rating of 4 star in the kitchen in the development.		~	
The applicant must install basin taps with a minimum rating of 4 star in each bathroom in the development.		 	
Alternative water			
Rainwater tank			
The applicant must install a rainwater tank of at least 3000 litres on the site. This rainwater tank must meet, and be installed in accordance with, the requirements of all applicable regulatory authorities.	~	~	~
The applicant must configure the rainwater tank to collect rain runoff from at least 200 square metres of the roof area of the development (excluding the area of the roof which drains to any stormwater tank or private dam).		~	~
The applicant must connect the rainwater tank to:			
all toilets in the development		 Image: A second s	 ✓
		1	1
the cold water tap that supplies each clothes washer in the development		 ✓ 	 ✓
the cold water tap that supplies each clothes washer in the development at least one outdoor tap in the development (Note: NSW Health does not recommend that rainwater be used for human consumption in areas with potable water supply.)			

Water Commitments	Show on DA plans	Show on CC/CDC plans & specs	Certifier check
a tap that is located within 10 metres of the outdoor spa in the development		>	~
Swimming Pool			
The swimming pool must not have a volume greater than 42 kilolitres.	 	~	
The swimming pool must be outdoors.	 ✓ 	~	
Outdoor Spa			
The spa must not have a volume greater than 2 kilolitres.	 ✓ 	~	
The spa must have a spa cover.		×	

Thermal Performance and Materials commitments Simulation Method

Assessor details and thermal loads

The applicant must attach the certificate referred to under "Assessor Details" on the front page of this Certificate") to the development application and construction certificate application for the proposed applying for a complying development certificate for the proposed development, to that application. Assessor Certificate to the application for an occupation certificate for the proposed development. The Assessor Certificate must have been issued by an Accredited Assessor in accordance with the

The details of the proposed development on the Assessor Certificate must be consistent with the det certificate, including the Cooling and Heating loads shown on the front page of this certificate and th tables below.

The applicant must show on the plans accompanying the development application for the proposed d the Assessor Certificate requires to be shown on those plans. Those plans must bear a stamp of end Assessor to certify that this is the case. The applicant must show on the plans accompanying the app certificate (or complying development certificate, if applicatione), all thermal performance specification Certificate, and all aspects of the proposed development which were used to calculate those specific

The applicant must construct the development in accordance with all thermal performance specificati Certificate, and in accordance with those aspects of the development application or application for a which were used to calculate those specifications.

The applicant must show on the plans accompanying the development application for the proposed ceiling fans set out in the Assessor Certificate. The applicant must show on the plans accompanying certificate (or complying development certificate, if applicate), the locations of ceiling fans set out in

Thermal Performance and Materials commitments

Construction

The applicant must construct the floors, walls, roofs, ceilings and glazing of the dwelling in ac the tables below.

The applicant must show through receipts that the materials purchased for construction are consistent the tables below.

Construction	Area - m²	Insulation
floor - concrete slab on ground, conventional slab.	222.4	polyurethane
floor - suspended floor above garage, concrete - suspended; frame: no frame.	225.3	polyurethane
garage floor - concrete slab on ground.	55.3	polyurethane
external wall: cavity brick; frame: no frame.	all external walls	polyurethane
external garage wall: cavity brick; frame: no frame.	56	polyurethane
internal wall: single skin masonry; frame: no frame.	448	none
ceiling and roof - flat ceiling / flat roof, framed - metal roof, timber - H2 treated softwood.	208	ceiling: fibreglass batts or roll; roof: none.

Thermal Performance and Materials commitments Glazing The applicant must install windows, glazed doors and skylights as described in the table below, in ac listed in the table.

aluminium	178.9
timber	0
uPVC	0
steel	0
composite	0

Glazing	Maximu
single	35.39
double	143.6
triple	0

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REV DATE DESCRIPTION

sketchArc Po Box 377 Manly 1655 m : 0422 521 871

e : power@sketcharc.com.au w:www.sketcharc.com.au

PROJECT: 69 Gordon St, Clontarf, 2093, NSW New Dwelling LOT 48 in DP 165052 - 1042m2

Private

CLIENT:

	Show on DA plans	Show on CC/CDC plans & specs	Certifier check
			_
is BASIX certificate (the "Assessor I development (or, if the applicant is . The applicant must also attach the			
Thermal Comfort Protocol.			
tails shown in this BASIX ne "Construction" and "Glazing"			
development, all matters which dorsement from the Accredited pplication for a construction ns set out in the Assessor ications.	~	~	~
tions set out in the Assessor a complying development certificate		~	~
development, the locations of g the application for a construction n the Assessor Certificate.	~	~	~

	Show on DA plans	Show on CC/CDC plans & specs	Certifier check
nce with the specifications listed in	~	~	~
ent with the specifications listed in			~
	·		
Insulatio	n		

	Show on DA plans	Show on CC/CDC plans & specs	Certifier check
cordance with the specifications	×	>	•
num area - m2			
9			
num area - m2			

	STATUS: DA		
	DATE: 180525	scale: 1:100@A3	PROJECT NUMBER: 2427
- Demolition	STAGE: DA	DRAWN/DESIGNED: PB / MP	ISSUE:
-Proposed	DRAWING NO:	1.87.11	
	DA22		

Energy Commitments	Show on DA plans	Show on CC/CDC plans & specs	Certifier check
Hot water			
The applicant must install the following hot water system in the development, or a system with a higher energy rating: gas instantaneous with a performance of 6 stars.	~	~	~
Cooling system			
The applicant must install the following cooling system, or a system with a higher energy rating, in at least 1 living area: 1-phase airconditioning - non ducted; Energy rating: 2.5 star (average zone)		~	~
The applicant must install the following cooling system, or a system with a higher energy rating, in at least 1 bedroom: 1-phase airconditioning - non ducted; Energy rating: 2.5 star (average zone)		~	~
Heating system			
The applicant must install the following heating system, or a system with a higher energy rating, in at least 1 living area: 1-phase airconditioning - non ducted; Energy rating: 2.5 star (average zone)		~	~
The applicant must install the following heating system, or a system with a higher energy rating, in at least 1 bedroom: 1-phase airconditioning - non ducted; Energy rating: 2.5 star (average zone)		~	~
Ventilation			
The applicant must install the following exhaust systems in the development:			1
At least 1 Bathroom: individual fan, ducted to façade or roof; Operation control: manual switch on/off		 	 ✓
Kitchen: individual fan, ducted to façade or roof; Operation control: manual switch on/off		 	 ✓
Laundry: individual fan, ducted to façade or roof; Operation control: manual switch on/off		 Image: A set of the set of the	
Artificial lighting			
The applicant must ensure that a minimum of 80% of light fixtures are fitted with fluorescent, compact fluorescent, or light-emitting- diode (LED) lamps.		~	~
Natural lighting			
The applicant must install a window and/or skylight in the kitchen of the dwelling for natural lighting.	~	~	~

Energy Commitments	Show on DA plans	Show on CC/CDC plans & specs	Certifier check
The applicant must install a window and/or skylight in 4 bathroom(s)/toilet(s) in the development for natural lighting.	~	~	~
Swimming pool			
The applicant must install the following heating system for the swimming pool in the development (or alternatively must not install any heating system for the swimming pool): no heating		 ✓ 	
The applicant must install the following pump for the swimming pool in the development, or a pump with a higher energy rating: single speed with a performance of 5 stars.		~	
The applicant must install a timer for the swimming pool pump in the development.		~	
Outdoor spa			
The applicant must install the following heating system for the spa in the development (or alternatively must not install any heating system for the spa): no heating		~	
The applicant must install a timer for the spa pump in the development.		~	
Alternative energy			
The applicant must install a photovoltaic system as part of the development. The applicant must connect this system to the development's electrical system.	~	~	~
The photovolatic system must consist of:			
 photovolatic collectors with the capacity to generate at least 3 peak kilowatts of electricity, installed at an angle between 0 degrees and 10 degrees to the horizontal facing north 	~	 	~
Other			
The applicant must install a gas cooktop & electric oven in the kitchen of the dwelling.		~	
The applicant must install a fixed outdoor clothes drying line as part of the development.		 Image: A set of the set of the	
Legend			
In these commitments, "applicant" means the person carrying out the development.			
Commitments identified with a V in the "Show on DA plans" column must be shown on the plans accompanying the development appli development application is to be lodged for the proposed development).	cation for the p	proposed development	(if a
Commitments identified with a V in the "Show on CC/CDC plans and specs" column must be shown in the plans and specifications ac certificate / complying development certificate for the proposed development.	companying th	e application for a consi	truction

	DO NOT SCALE DRAWINGS. CHECK ALL DIMENSIONS ON SI FIGURED DIMENSIONS TAKE PRECEDENCE. The builder shall check and verify all dimensions and verify all errors and omissions to the Architect. Do not scale the drawings. Drawings shall not be used for construction purposes until issued by the	re. SketchArc Po Box 377 Manly 1655 m : 0422 521 871	PROJECT: 69 Gordon St, Clontarf, 2093, NSW New Dwelling LOT 48 in DP 165052 - 1042m2
\mathcal{S}^{\wedge} .	Architect for construction.	e : power@sketcharc.com.au w : www.sketcharc.com.au	CLIENT: Private
	REV DATE DESCRIPTION		I IIVale

	STATUS: DA				
	DATE: 180525	scale: 1:100@A3	PROJECT NUMBER: 2427		
= Demolition	STAGE:	DRAWN/DESIGNED:	ISSUE:		
-Proposed	DA	PB / MP			
Froposed	DRAWING NO:				
	DA23				

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