



AKUNA

ENGINEERING

20 December 2021

Group Architects
3.09/55 Miller Street
Pyrmont NSW 2009

Attention: Michael Munro

Dear Michael

1.0 Introduction

Akuna Engineering was engaged to assess the proposed Alterations and Additions at 95 Wimbledon Avenue, North Narrabeen in reference to potential risks and impacts connected with flooding. This report relies upon flooding information specific for the subject site provided by Council and uses architectural drawings to assess any impacts and risks.

1.1 Information Relied Upon

The following documentation has been used in the preparation of this overland flow assessment report:

- Survey and architectural drawings listed in Appendix A
- Council provided flood information in Appendix B

1.2 Description of the Site and Proposed Development

The subject site is located at 95 Wimbledon Avenue, North Narrabeen. The site (645m²) slopes to the West, away from Wimbledon Avenue and down to Narrabeen Lagoon.

The proposed works consist of the construction of a new in-ground pool towards the rear of the, refer attached architectural plans.

2.0 Flooding

Council flood information (Appendix B) for the site identifies the property as being flood affected during the 1% annual exceedance probability (AEP) storm event. Council supplied flood information was used to determine flooding extents, impacts, and assess the associated risks to the development.

The development site is located within the High-Risk precinct flood hazard zone as identified within Northern Beaches (Pittwater) Council's Flood Hazard Map (Appendix B). Therefore, the site requires a Flood Management Report to be completed in accordance with Pittwater 21 Development Control Plan B3.11 Flood Prone Land to support the development.

2.1 Assessment of Impacts

All aspects of the proposed development are categorised as concessional and located within the High-Risk precinct. In accordance with Pittwater Council 21DCP sB3.11, flood controls are applicable to the development.

Based on the flood information contained within Appendix B, the predicted flood levels are summarised below:

- 1% AEP: 3.05 mAHD (Appendix B, Flood Map B)
- FPL: 3.55 mAHD (1% AEP flood level + 500mm)
- PMF: 5.03 mAHD (Appendix B, Flood Map D)

Table 1. DCP flood controls, High flood risk precinct, Residential

#	Prescriptive controls	Compliance with controls			Relevant Controls
		NA	Yes	No	
A	Flood effects caused by development		✓		A1, A2
B	Building components and structural		✓		B1,B2,B3
C	Floor levels		✓		C1, C3, C4, C6
D	Car parking	✓			D1, D2, D3, D4, D5, D6
E	Emergency response		✓		E1
F	Fencing		✓		F1
G	Storage of goods		✓		G1
H	Pools		✓		H1

NA – Not applicable

3.0 Addressing the Controls

Control A - Flood effects caused by development

- A1. Complies - The development is not expected to adversely impact surrounding properties with regard to flood levels, velocities or hazard during 1% AEP event.

The proposed pool will be constructed to match the existing levels shown in the attached survey.

- A2. Complies – No net filling is proposed within the 1% AEP extent, refer Control H1.

Control B – Building components and structural

- B1. Complies - Pool will be below ground, fencing to comply with Control H1 and be constructed of flood compatible materials.
- B2. Achievable - All new structures impacted by 1% AEP flood levels (below 3.05 mAHD) must be designed and constructed to ensure structural integrity up to the 1% AEP Flood event, taking into account the forces of floodwater, wave action,

flowing water with debris, buoyancy and immersion. Certification from a structural engineer must be provided as part of the CC works.

- B3. Achievable - All new electrical equipment, power points, wiring, fuel lines, sewerage systems or any other service pipes and connections must be waterproofed and/or located above the FPL.

Control C – Floor Levels

- C1. Not applicable
- C3. Complies – Pool will be in ground with surrounding levels constructed to match existing surface levels shown in the attached survey.
- C4. Not applicable
- C6. Not applicable

Control D – Car Parking

Not applicable

Control E – Flood emergency response

- E1. In the event that floodwaters overtop the foreshore boundary at any point on the property, the recommended actions are:
- Emergency services shall be contacted stating the property's location; the situation faced, number of people on the property and any evacuation measures to be carried out.
 - The occupants of the property shall evacuate the site and proceed up Wimbledon Avenue to the Wakehurst Parkway/ Wimbledon Avenue intersection. This area is approximately 5m above the PMF level.

Control F – Fencing

- F1. Complies – A 1200mm high aluminium fence is propose to surround the pool. The proposed fence will be designed to have at least 50% openings from the natural ground level up to 1% AEP flood level (3.05 mAHD) to allow the passage of floodwater through the fence. Any openings will be a minimum of 75mm x 75mm.

Control G – Storage of goods

- G1. Complies – Refer control H1
- G2. Complies – Refer control H1

Control H – Pools

- H1. Complies – the proposed pool will be generally constructed with the pool coping and surround levels design to match the existing levels shown in the attached survey. A small area of the pool surround to the south will require some minor fill of 150 to 200mm, it is anticipated that this fill would be offset by the flood storage created by the pool due to the difference in the working water level of the pool and surrounding FFL (typically 100mm).

All electrical equipment associated with the pool (including pool pumps) is to be waterproofed and/or located at or above the Flood Planning Level.

All chemicals associated with the pool are to be stored at or above the Flood Planning Level.

4.0 Conclusion

Council's flood data predicts that during the 1% AEP rain event, the site will be completely inundated with floodwaters arising from Narrabeen Lagoon. The floodwaters on and surrounding the site are classified as High Hazard and Flood Storage (Map J & Map F respectively, refer to Appendix B).

The proposed development has been assessed against the relevant Council flood controls and provided that the recommendations contained within this report are adopted:

- The proposed development complies with the applicable flood controls outlined in sB3.11 of Northern Beaches Council's Development Control Plan (Pittwater21 DCP).
- No additional adverse flooding impacts are expected to occur to the neighbouring upstream and downstream properties as a result of the proposed development.
- The proposed development is consistent with the flood risk hazard of the land.


Please contact me if you have any questions.

Kind regards,

A handwritten signature in black ink, appearing to read 'Logan English-Smith'.

Logan English-Smith
Senior Engineer – Flooding & Stormwater

Appendix A – Survey and Architectural Plans

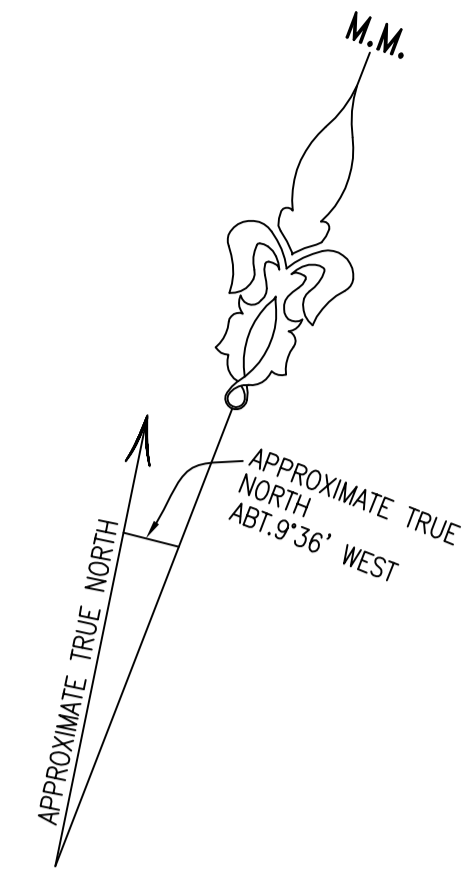

▲ BM DRILL HOLE IN CONCRETE DRIVE R.L. 2.37 A.H.D.

NOTE:

- LEVELS SHOWN THUS $+2.10$ ARE BASED ON AUSTRALIAN HEIGHT DATUM
- ORIGIN OF LEVELS - PM 10258 R.L. 1.8 A.H.D. LOCATED AT THE INTERSECTION OF WAKEHURST PARKWAY & WIMBLEDON AVENUE
- LEVELS SHOWN THUS ABT.10.3 HAVE BEEN DETERMINED BY REMOTE METHODS AND ARE ACCURATE TO ± 100 mm
- THE POSITION OF SURVEY MARKS PLACED THAT DEFINE PART OF THE BOUNDARIES OF THE SUBJECT LAND ARE AS SHOWN ON THE PLAN.
- DO NOT SCALE - USE FIGURED BEARINGS & DISTANCES ONLY
- BASIC LEVEL AND DETAIL SURVEY ONLY - UNLESS OTHERWISE SHOWN, THE POSITION OF IMPROVEMENTS ARE APPROXIMATE. THE INFORMATION SHOWN HEREON IS ONLY TO BE USED AT AN ACCURACY OF 1:100
- THE DIAMETER, SPREAD AND HEIGHT OF ALL TREES ARE ESTIMATES ONLY. IF THEY ARE CRITICAL TO DESIGN THEN A MORE ACCURATE SURVEY WOULD BE REQUIRED.
- FEATURES & LEVELS CRITICAL TO DESIGN SHOULD BE LOCATED BY A MORE ACCURATE SURVEY
- ALL SET OUT WITH REGARD TO LEVELS SHOULD BE REFERRED TO THE BENCH MARK
- NO SERVICES SEARCH HAS BEEN CARRIED OUT FOR THIS SURVEY
- EXISTING SERVICES MAY IMPACT ON DESIGN/CONSTRUCTION - IT IS ADVISED THAT A COMPREHENSIVE SERVICES SEARCH BE CARRIED OUT PRIOR TO COMMENCEMENT OF DESIGN/CONSTRUCTION REFER "DIAL BEFORE YOU DIG" DETAILS ON THIS PLAN
- ORIGIN OF THE NORTH POINT IS D.P. 17768. THE POSITION OF TRUE NORTH IS APPROXIMATE ONLY. A MORE ACCURATE SURVEY WOULD BE REQUIRED TO DETERMINE ITS EXACT POSITION.
- THE SUBJECT LAND IS AFFECTED BY A COVENANT CREATED BY THE REGISTRATION OF TRANSFER No.G408321.

- LEGEND**
- BL DENOTES GROUND FLOOR BALCONY LEVEL
 - EFL DENOTES GROUND FLOOR ENTRANCE LEVEL
 - GEFL DENOTES GARAGE FLOOR LEVEL
 - H DENOTES WINDOW HEAD AT GROUND FLOOR LEVEL
 - H1 DENOTES WINDOW HEAD AT FIRST FLOOR LEVEL
 - RFT DENOTES TOP OF ROOF
 - ROR DENOTES RIDGE OF ROOF
 - S DENOTES WINDOW SILL AT GROUND FLOOR LEVEL
 - S1 DENOTES WINDOW SILL AT FIRST FLOOR LEVEL
 - TA DENOTES TOP OF AWNING
 - TOG DENOTES TOP OF GUTTER
 - W DENOTES WINDOW




ISSUE	DESCRIPTION	DATE
A	INITIAL	16/12/18

BYRNE & ASSOCIATES PTY. LIMITED
CONSULTING SURVEYORS & ENGINEERS
 63 WATERLOO STREET
 NARRABEEN 2101
 Ph: (02) 9913 7110 Fax: (02) 9913 1583
 Email: survey@byrneandassociates.com.au

LEVEL & DETAIL SURVEY
OF LOT 7 IN D.P.17768
No.95 WIMBLEDON AVENUE,
NARRABEEN

Date of Survey	Prepared by	Date	Approved by	Date	R/R
21/11/18	PBB	16/12/18			1:100

File Name: 10939D.DWG Sheet: 1 of 1 Sheets Plan No. A1 - 10939D

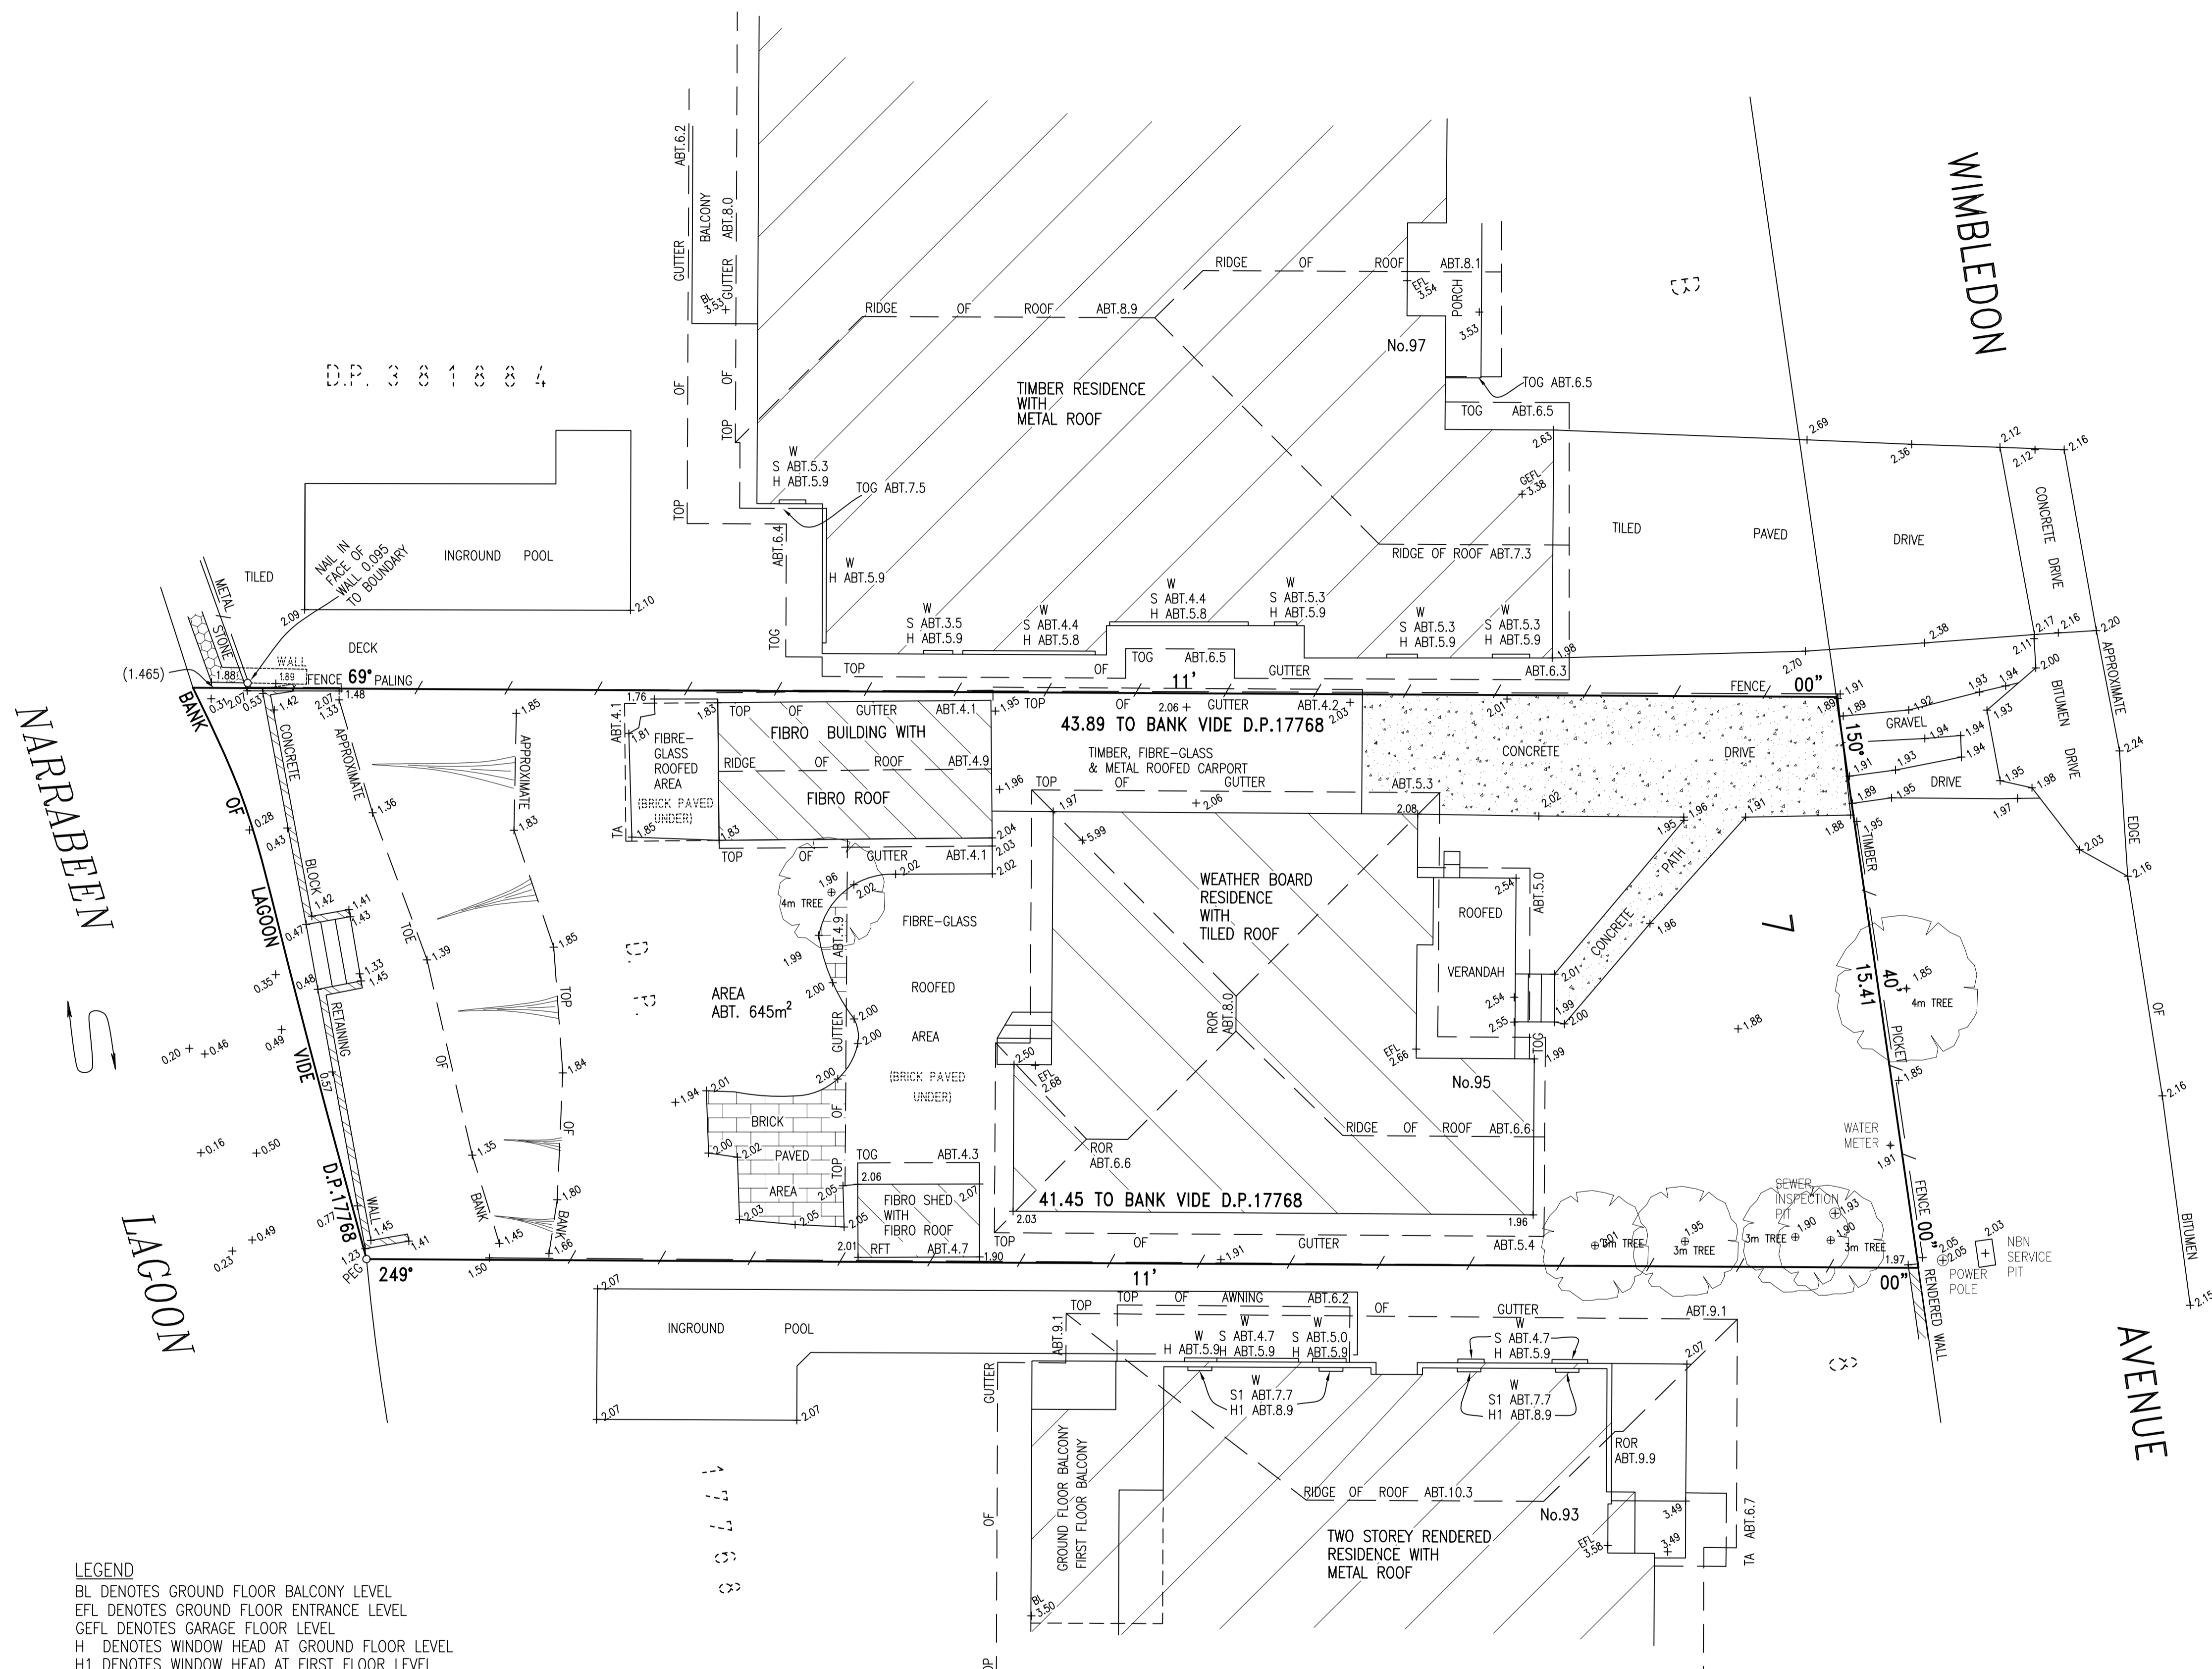

DA PLAN


95 WIMBLEDON AVE, NARRABEEN

LOT 7 / DP17768


ZONE E4: ENVIRONMENTAL LIVING



PROJECT LOCATION

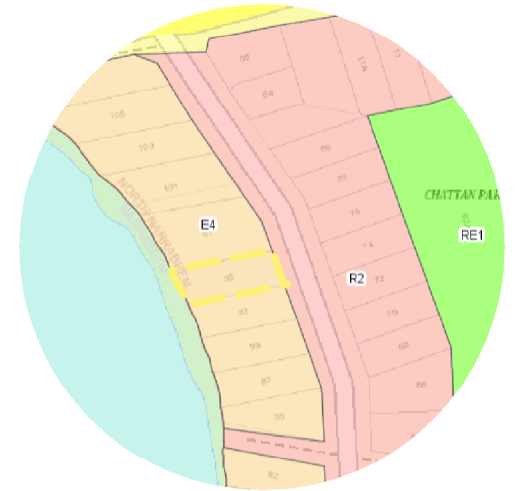

LAND ZONING

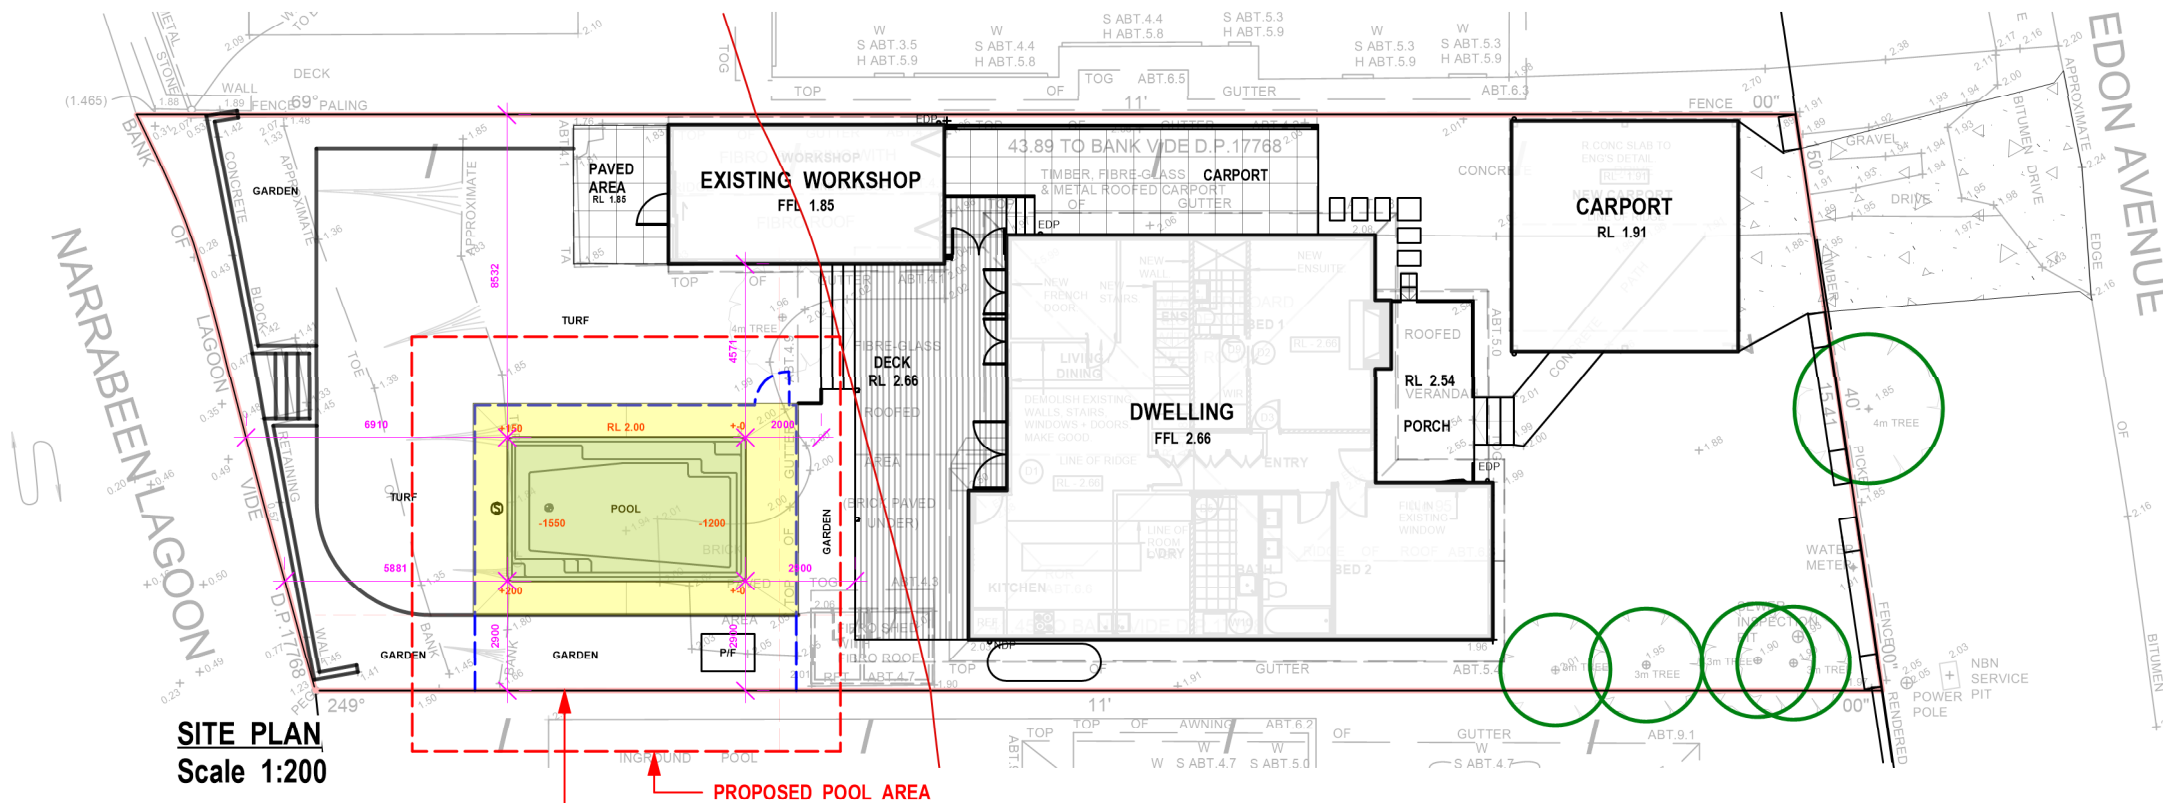

SITE PLAN
Scale 1:200

PROPOSED POOL AREA

2M GARDEN TO BE MAINTAINED BETWEEN
POOL COPING AND SOUTHERN BOUNDARY

WORKS REQUIRING APPROVAL



ISSUE	DATE	COMMENT
E	15/12/2021	COUNCIL REQUESTS
AMENDMENTS		

GENERAL NOTES
 All work to be carried out in accordance with the Building Code of Australia, all Local and State Government Ordinances, relevant Australian Standards, Local Authorities Regulations and all other relevant Authorities concerned.
 All structural work and site drainage to be subject to Engineer's details or certification where required by Council. This shall include r.c. slabs and footings, r.c. and steel beams & columns, wind bracing to AS 1170 and AS4055, anchor rods or bolts, tie downs, fixings etc., driveway slabs and drainage to Council's satisfaction. All timbers to be in accordance with SAA Timber Structure Code AS1720 and SAA Timber Framing Code AS 1684. All work to be carried out in a professional and workman-shiplike manner according to the plans and specification.
 NOTE:
 Do not scale off the drawings unless otherwise stated and use figured dimensions in preference.
 All dimensions are to be checked and verified on site before the commencement of any work, all dimensions and levels are subject to final survey and set-out.
 No responsibility will be accepted by SiteDesign for any variations in design, builder's method of construction or materials used, deviation from specification without permission or accepted work practices resulting in inferior construction. Locate and protect all services prior to construction.
 COPYRIGHT CLAUSE
 This drawing and design is the property of SiteDesign and should not be reproduced either in part or whole without the written consent of this firm.

**SITEDESIGN
+STUDIOS**

creating places to live in and enjoy


SYDNEY CITY STUDIO
 PO BOX 576
 DOUBLE BAY 1360
 p 1300 22 44 55
 info@sdstudios.com.au
 www.sdstudios.com.au

Project **WORTHINGTON RESIDENCE**
 Address **95 WIMBLEDON AVE NARRABEEN**
 Drawing Title **SITE PLAN**

Date **15/12/21**
 Scale **1:200@A3**

Drawing No. **7017**

Page
L-01

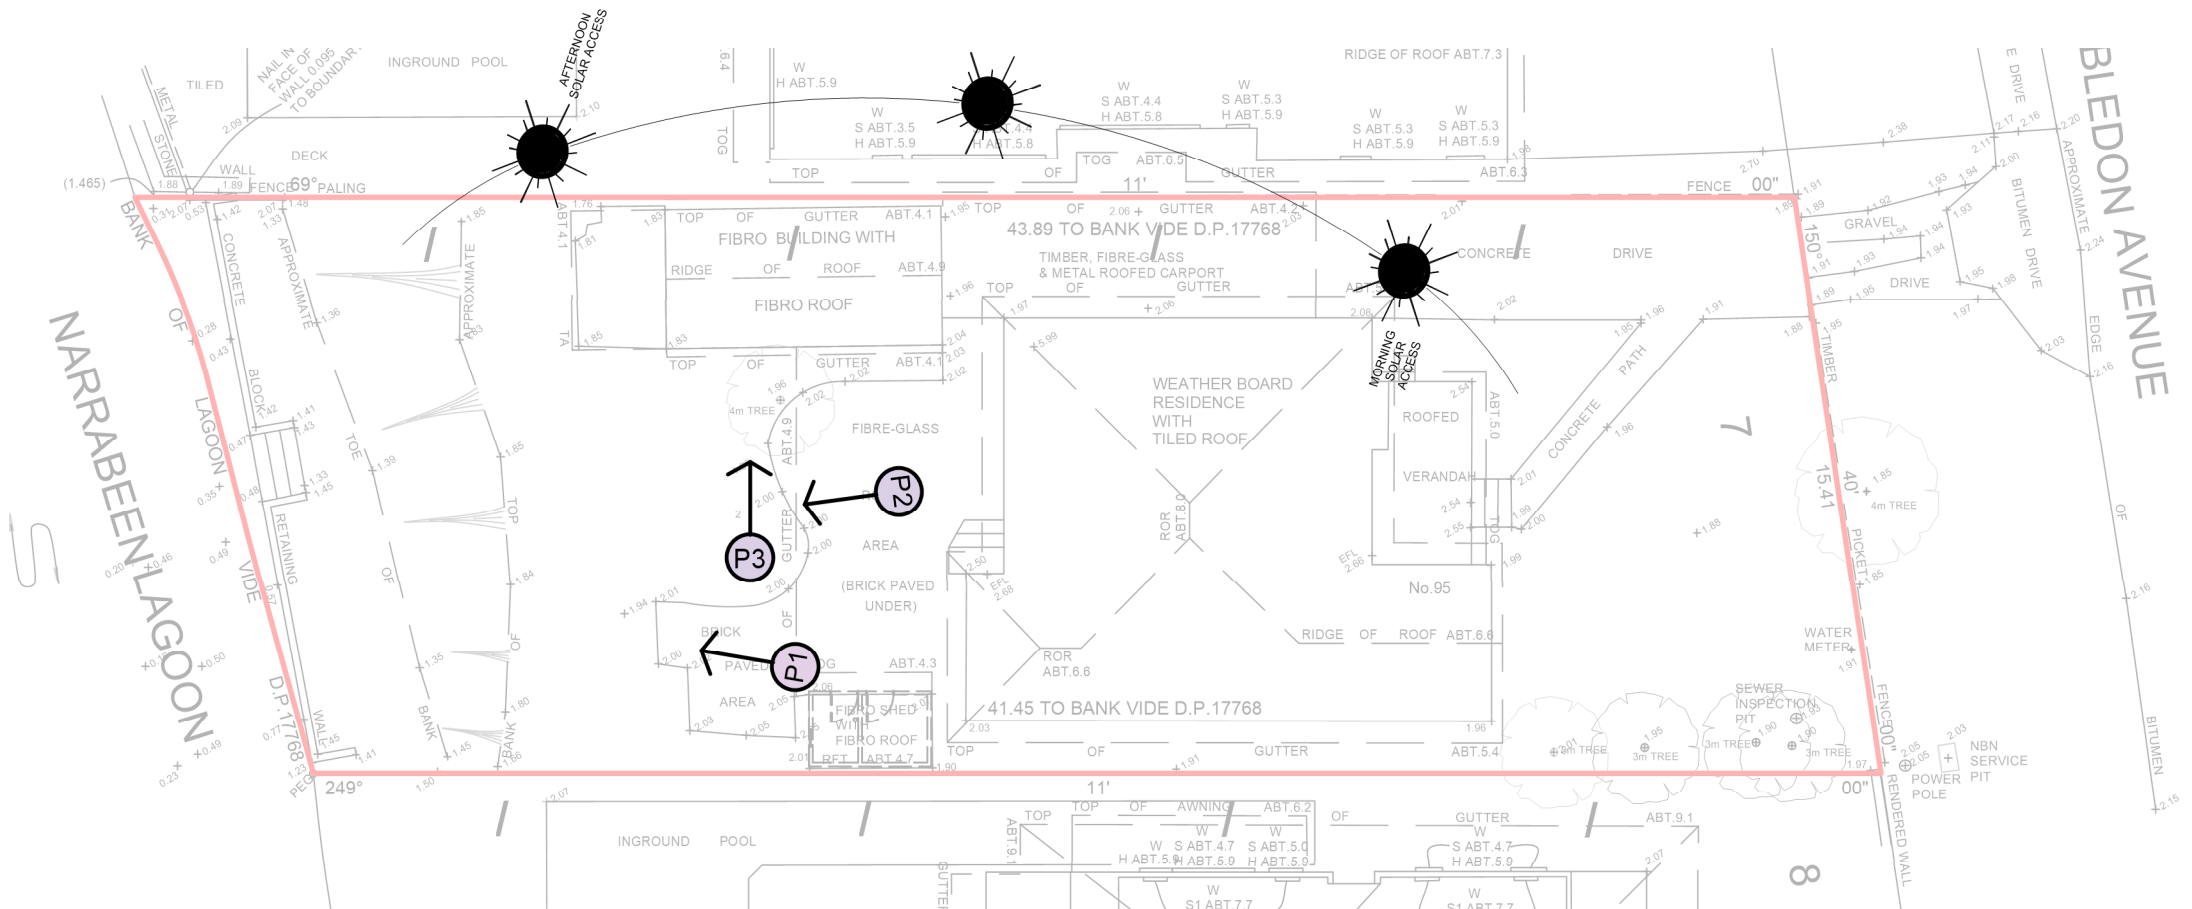

P1



P2



P3

ISSUE	DATE	COMMENT
E	15/12/2021	COUNCIL REQUESTS
AMENDMENTS		

GENERAL NOTES
 All work to be carried out in accordance with the Building Code of Australia, all Local and State Government Ordinances, relevant Australian Standards, Local Authorities Regulations and all other relevant Authorities concerned.
 All structural work and site drainage to be subject to Engineer's details or certification where required by Council. This shall include r.c. slabs and footings, r.c. and steel beams & columns, wind bracing to AS 1170 and AS4055, anchor rods or bolts, tie downs, fixings etc., driveway slabs and drainage to Council's satisfaction. All timbers to be in accordance with SAA Timber Structure Code AS1720 and SAA Timber Framing Code AS 1684. All work to be carried out in a professional and workman-ship-like manner according to the plans and specification.
 NOTE:
 Do not scale off the drawings unless otherwise stated and use figured dimensions in preference.
 All dimensions are to be checked and verified on site before the commencement of any work, all dimensions and levels are subject to final survey and set-out.
 No responsibility will be accepted by Sitedesign for any variations in design, builder's method of construction or materials used, deviation from specification without permission or accepted work practices resulting in inferior construction. Locate and protect all services prior to construction.
 COPYRIGHT CLAUSE
 This drawing and design is the property of Sitedesign and should not be reproduced either in part or whole without the written consent of this firm.

**SITEDESIGN
 +STUDIOS**

creating places to live in and enjoy


SYDNEY CITY STUDIO
 PO BOX 576
 DOUBLE BAY 1360
 p 1300 22 44 55
 info@sdstudios.com.au
 www.sdstudios.com.au

Project **WORTHINGTON RESIDENCE**
 Address **95 WIMBLEDON AVE NARRABEEN**
 Drawing Title **SITE ANALYSIS**

Date **15/12/21**
 Scale **1:200@A3**

Drawing No. **7017**


Page
L-02

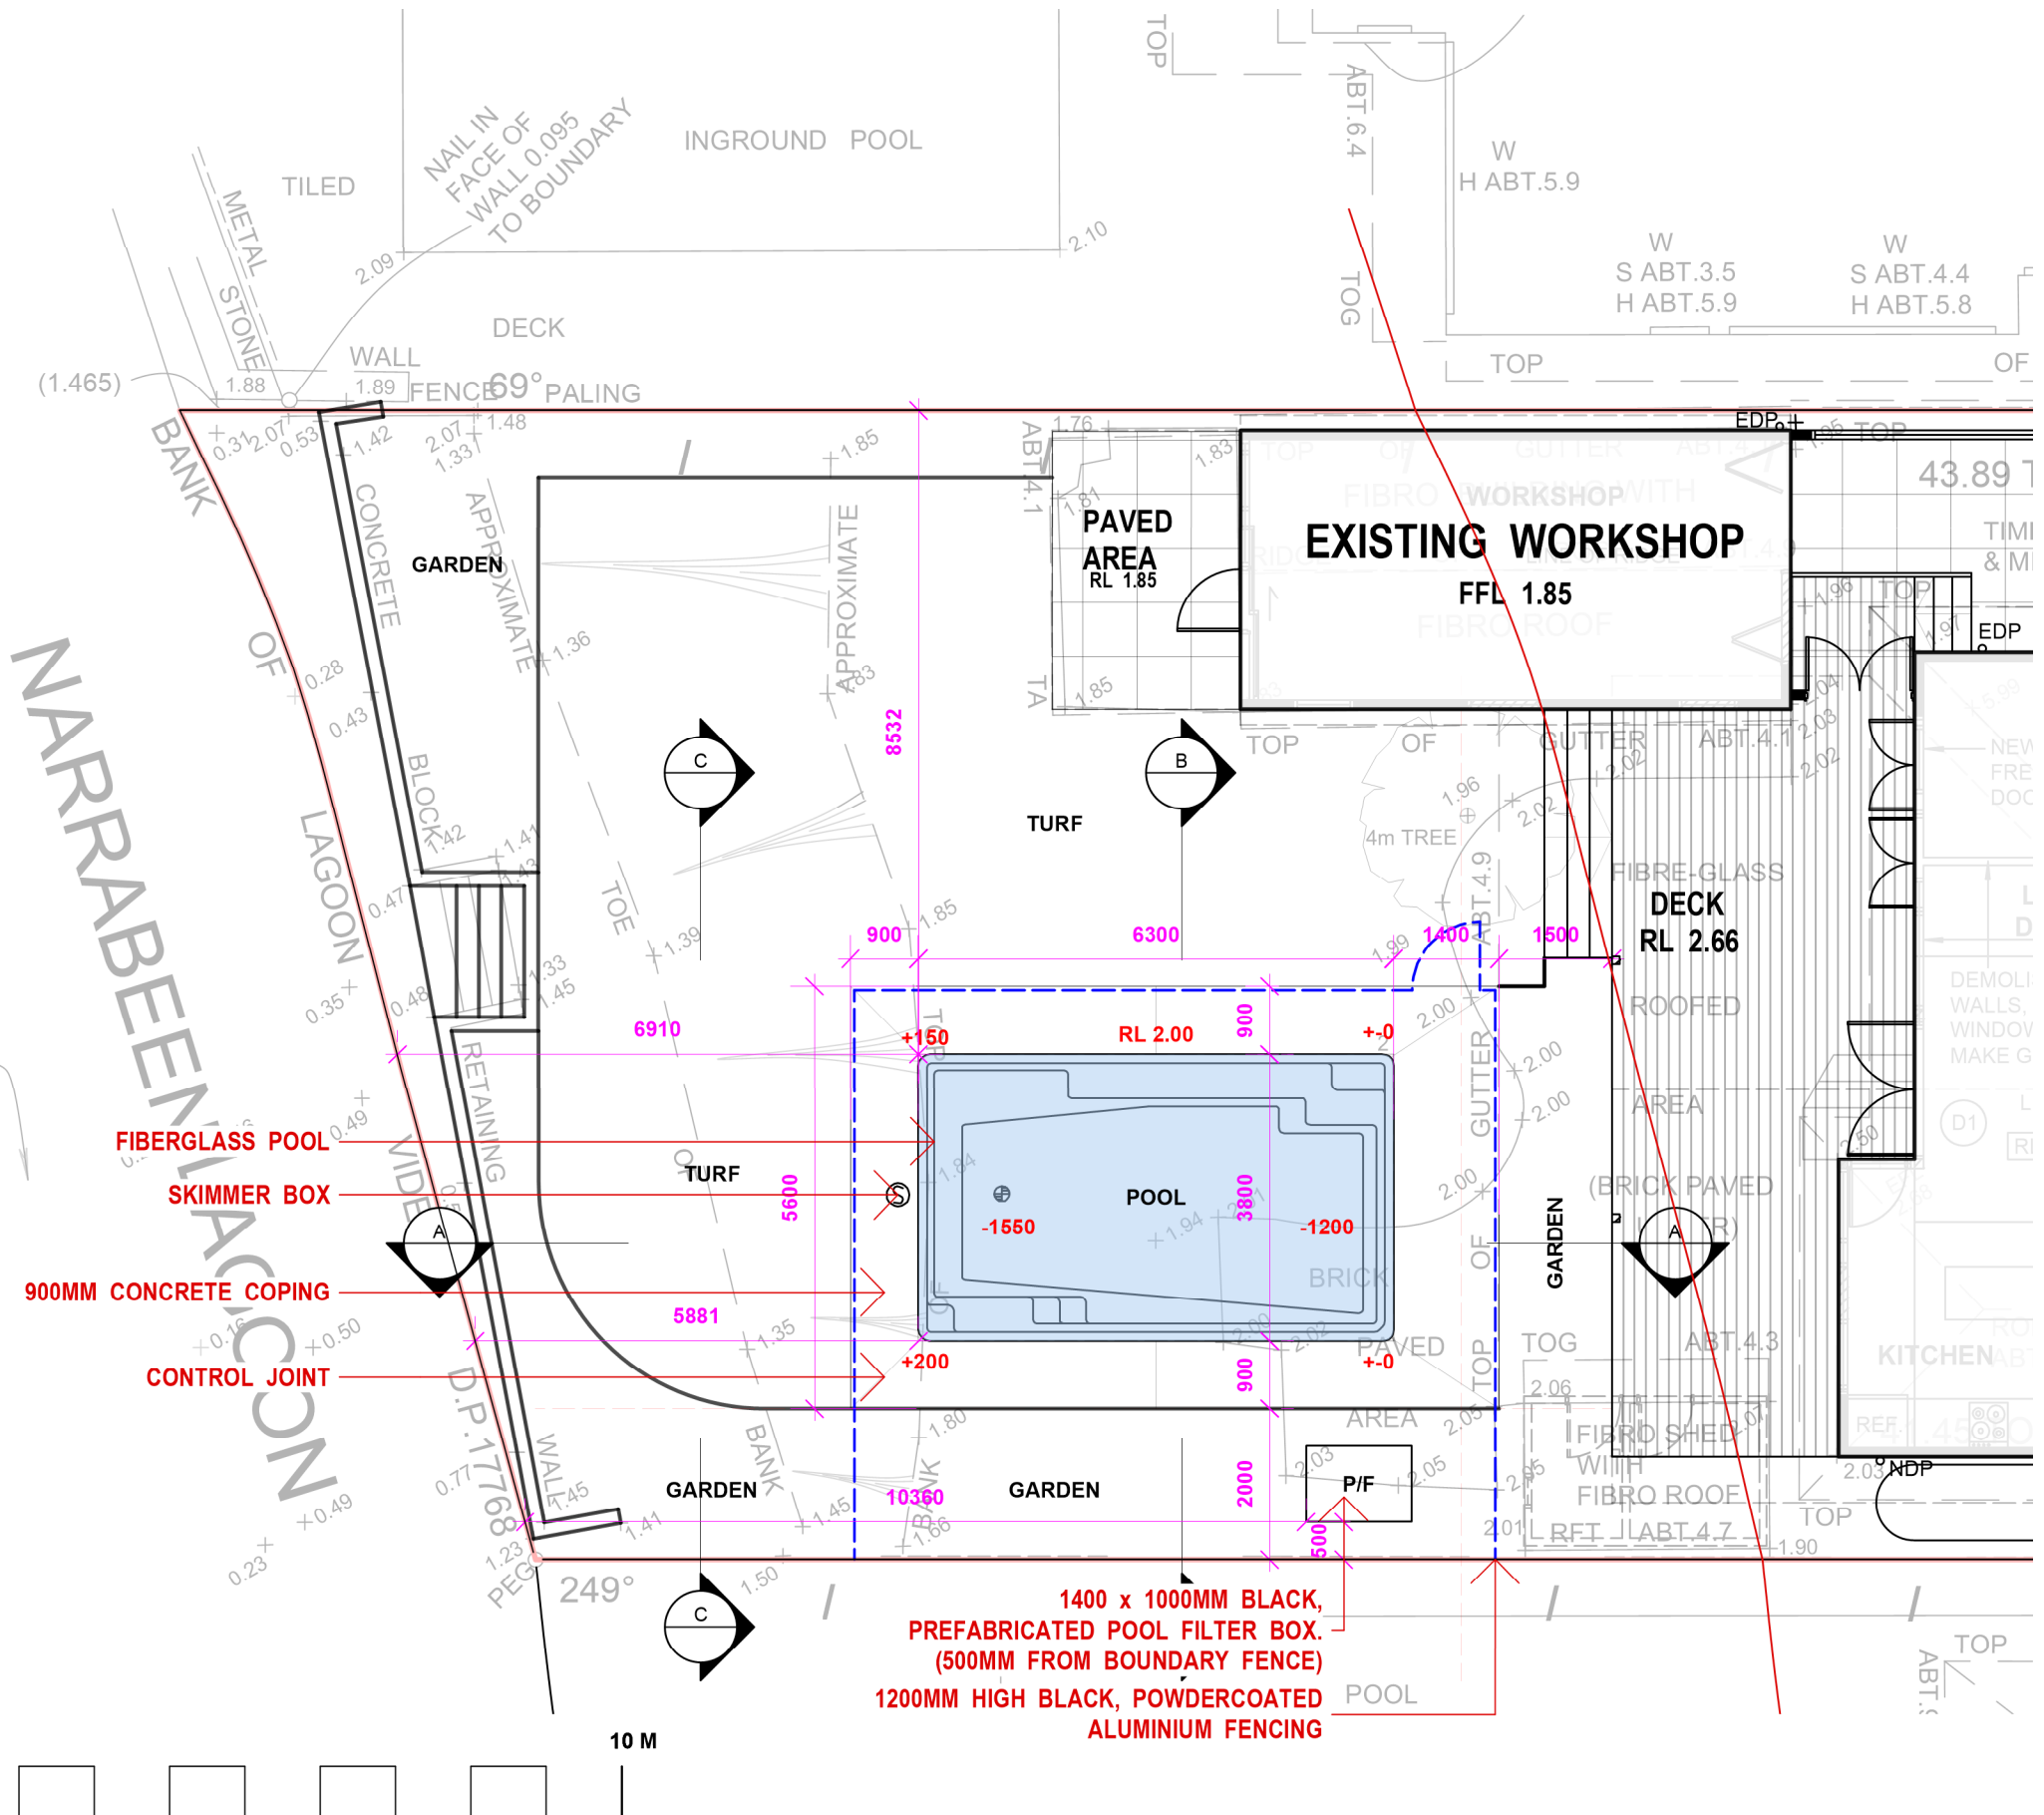

NARRABEEN LAGOON

- FIBERGLASS POOL
- SKIMMER BOX
- 900MM CONCRETE COPING
- CONTROL JOINT

**1400 x 1000MM BLACK,
PREFABRICATED POOL FILTER BOX.
(500MM FROM BOUNDARY FENCE)
1200MM HIGH BLACK, POWDERCOATED
ALUMINIUM FENCING**

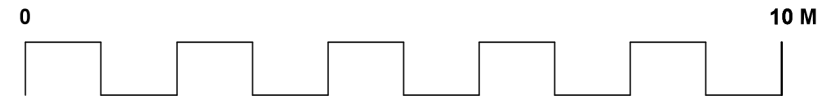

ISSUE	DATE	COMMENT
E	15/12/2021	COUNCIL REQUESTS

GENERAL NOTES
 All work to be carried out in accordance with the Building Code of Australia, all Local and State Government Ordinances, relevant Australian Standards, Local Authorities Regulations and all other relevant Authorities concerned.
 All structural work and site drainage to be subject to Engineer's details or certification where required by Council. This shall include r.c. slabs and footings, r.c. and steel beams & columns, wind bracing to AS 1170 and AS4055, anchor rods or bolts, tie downs, fixings etc., driveway slabs and drainage to Council's satisfaction. All timbers to be in accordance with SAA Timber Structure Code AS1720 and SAA Timber Framing Code AS 1684. All work to be carried out in a professional and workman-shiplike manner according to the plans and specification.
 NOTE:
 Do not scale off the drawings unless otherwise stated and use figured dimensions in preference.
 All dimensions are to be checked and verified on site before the commencement of any work, all dimensions and levels are subject to final survey and set-out.
 No responsibility will be accepted by Sitedesign for any variations in design, builder's method of construction or materials used, deviation from specification without permission or accepted work practices resulting in inferior construction. Locate and protect all services prior to construction.
 COPYRIGHT CLAUSE
 This drawing and design is the property of Sitedesign and should not be reproduced either in part or whole without the written consent of this firm.


**SITEDESIGN
+STUDIOS**
creating places to live in and enjoy

SYDNEY CITY STUDIO
 PO BOX 576
 DOUBLE BAY 1360
 p 1300 22 44 55
 info@sdstudios.com.au
 www.sdstudios.com.au


Project **WORTHINGTON RESIDENCE**
 Address **95 WIMBLEDON AVE NARRABEEN**
 Drawing Title **DETAILED PLAN**

Date **15/12/21**
 Scale **1:100@A3**


Drawing No. **7017**

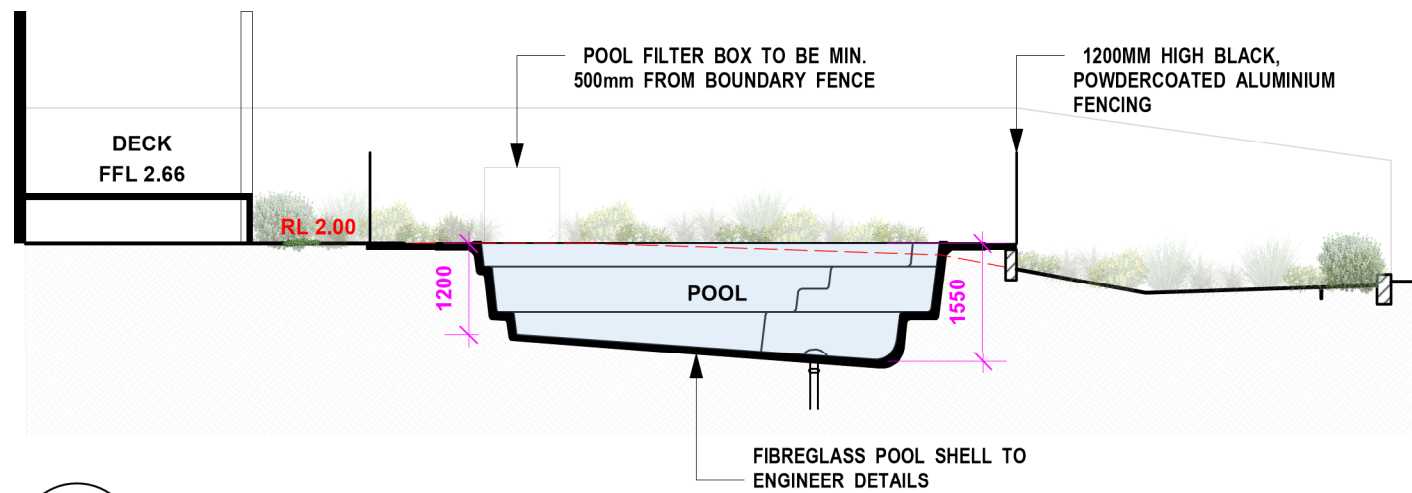

1 SECTION A
Scale: 1:100

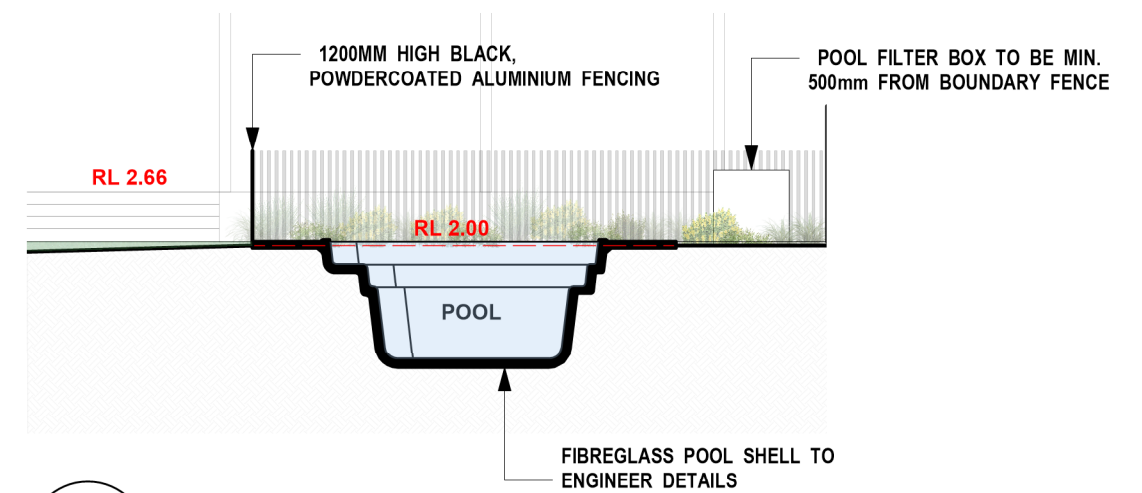

2 SECTION B
Scale: 1:100

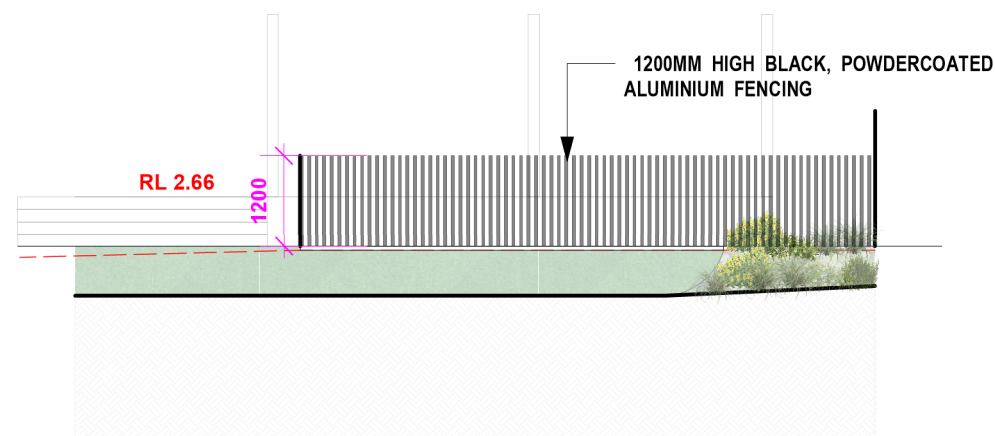

3 ELEVATION C
Scale: 1:100

ISSUE	DATE	COMMENT
E	15/12/2021	COUNCIL REQUESTS
AMENDMENTS		

GENERAL NOTES
 All work to be carried out in accordance with the Building Code of Australia, all Local and State Government Ordinances, relevant Australian Standards, Local Authorities Regulations and all other relevant Authorities concerned.
 All structural work and site drainage to be subject to Engineer's details or certification where required by Council. This shall include r.c. slabs and footings, r.c. and steel beams & columns, wind bracing to AS 1170 and AS4055, anchor rods or bolts, tie downs, fixings etc., driveway slabs and drainage to Council's satisfaction. All timbers to be in accordance with SAA Timber Structure Code AS1720 and SAA Timber Framing Code AS 1684. All work to be carried out in a professional and workman-shiplike manner according to the plans and specification.
 NOTE:
 Do not scale off the drawings unless otherwise stated and use figured dimensions in preference.
 All dimensions are to be checked and verified on site before the commencement of any work, all dimensions and levels are subject to final survey and set-out.
 No responsibility will be accepted by Sitedesign for any variations in design, builder's method of construction or materials used, deviation from specification without permission or accepted work practices resulting in inferior construction. Locate and protect all services prior to construction.
 COPYRIGHT CLAUSE
 This drawing and design is the property of Sitedesign and should not be reproduced either in part or whole without the written consent of this firm.

**SITEDESIGN
+STUDIOS**


creating places to live in and enjoy


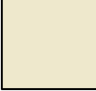


SYDNEY CITY STUDIO
 PO BOX 576
 DOUBLE BAY 1360
 p 1300 22 44 55
 info@sdstudios.com.au
 www.sdstudios.com.au


Project	WORTHINGTON RESIDENCE	
Address	95 WIMBLEDON AVE NARRABEEN	Date 15/12/21
Drawing Title	SECTIONS & ELEVATION	Scale 1:100@A3

Drawing No. 7017

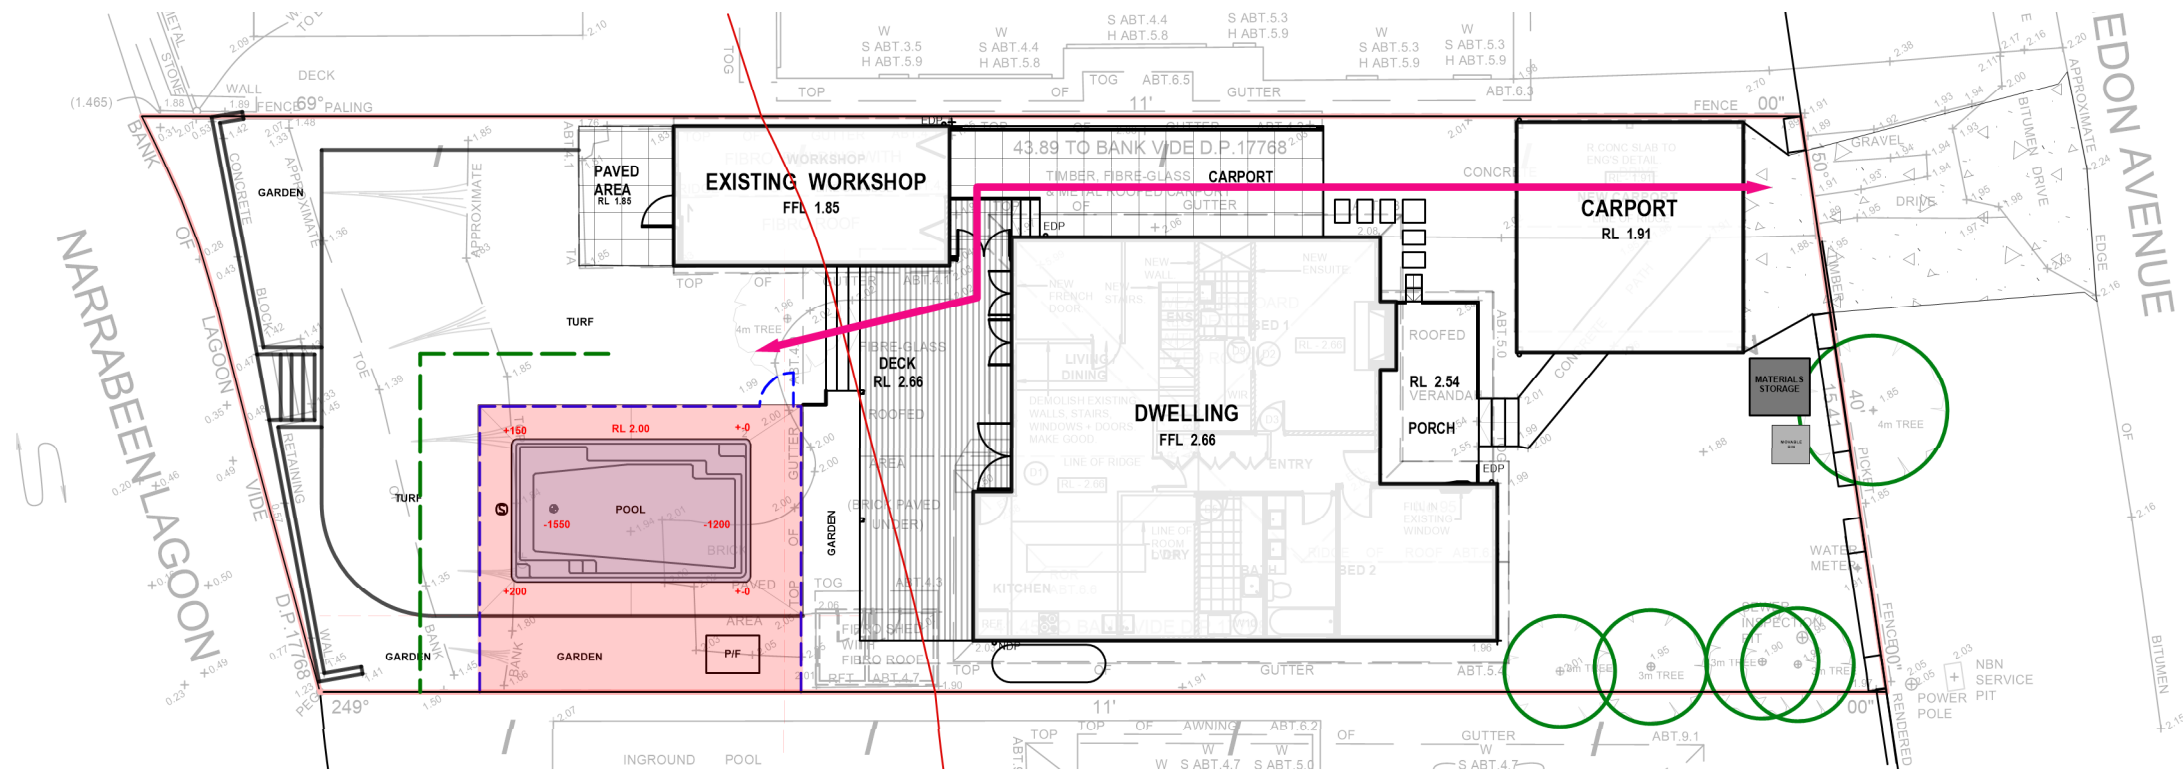Page
L-04



-  AREA OF WORKS
-  POOL EXCAVATED MATERIAL STORAGE AREA
-  GOOD ACCESS PRIOR TO HOUSE APPROVAL AND CONSTRUCTION
-  SEDIMENT FENCE

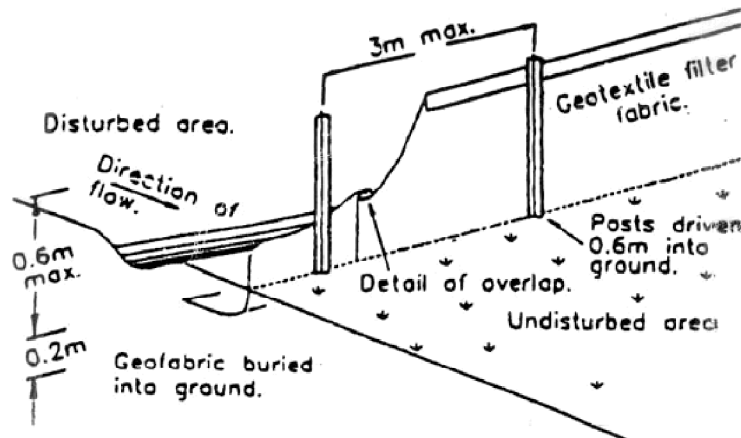

Sediment Fence

CONSTRUCTION MANAGEMENT NOTES

1. NO VEGETATION OR GRASS COVER IS TO BE REMOVED EXCEPT WITHIN AREAS OF NEW CONSTRUCTION.
2. INSTALL HAY BALES OR SEDIMENT CONTROL FENCING AS NECESSARY TO ENSURE THAT SILT FROM ANY DISTURBED AREAS IS TRAPPED ON-SITE.
3. PROVIDE BARRIERS AROUND ALL CONSTRUCTION WORK ON THE FOOTPATH AREA TO PROVIDE SAFE ALTERNATIVE ACCESS FOR PEDESTRIANS.
4. ALL WASTE MATERIALS ARE TO BE REMOVED FROM SITE OR STOCKPILED WITHIN THE SITE PRIOR TO REMOVAL.
5. ALL CONSTRUCTION MATERIALS & SITE SHEDS ARE TO BE KEPT WITHIN THE SITE AT ALL TIMES.

SOIL & WATER MANAGEMENT NOTES

1. WHEREVER POSSIBLE, EXISTING VEGETATION & GRASS COVER IS TO BE LEFT UNDISTURBED.
2. REMOVAL OR DISTURBANCE OF VEGETATION & TOP SOIL SHALL BE CONFINED TO WITHIN 3m OF THE APPROVED BUILDING AREA.
3. TEMPORARY SILT FENCE (AS SHOWN) TO BE INSTALLED PRIOR TO THE COMMENCEMENT OF ANY EARTHWORKS.
4. AND MAINTAINED THROUGHOUT THE CONSTRUCTION PERIOD, AND PARTICULAR AFTER STORM EVENTS.

ISSUE	DATE	COMMENT
E	15/12/2021	COUNCIL REQUESTS
AMENDMENTS		

GENERAL NOTES
 All work to be carried out in accordance with the Building Code of Australia, all Local and State Government Ordinances, relevant Australian Standards, Local Authorities Regulations and all other relevant Authorities concerned.
 All structural work and site drainage to be subject to Engineer's details or certification where required by Council. This shall include r.c. slabs and footings, r.c. and steel beams & columns, wind bracing to AS 1170 and AS4055, anchor rods or bolts, tie downs, fixings etc., driveway slabs and drainage to Council's satisfaction. All timbers to be in accordance with SAA Timber Structure Code AS1720 and SAA Timber Framing Code AS 1684. All work to be carried out in a professional and workman-like manner according to the plans and specification.
 NOTE:
 Do not scale off the drawings unless otherwise stated and use figured dimensions in preference.
 All dimensions are to be checked and verified on site before the commencement of any work, all dimensions and levels are subject to final survey and set-out.
 No responsibility will be accepted by Sitedesign for any variations in design, builder's method of construction or materials used, deviation from specification without permission or accepted work practices resulting in inferior construction. Locate and protect all services prior to construction.
 COPYRIGHT CLAUSE
 This drawing and design is the property of Sitedesign and should not be reproduced either in part or whole without the written consent of this firm.

**SITEDESIGN
 +STUDIOS**

creating places to live in and enjoy

SYDNEY CITY STUDIO
 PO BOX 576
 DOUBLE BAY 1360
 p 1300 22 44 55
 info@sdstudios.com.au
 www.sdstudios.com.au

Project **WORTHINGTON RESIDENCE**
 Address **95 WIMBLEDON AVE NARRABEEN**
 Drawing Title **CMP/DRAINAGE**

Date **15/12/21**

Scale **1:200@A3**

Drawing No. **7017**

Page
L-05

Appendix B – Council Flood Information



FLOOD INFORMATION REQUEST – COMPREHENSIVE

Property: 95 Wimbledon Avenue, Narrabeen

Lot DP: 7//17768

Issue Date: 26/11/2019

Flood Study Reference: Narrabeen Lagoon Flood Study 2013, BMT WBM

Flood Information for lot:

Flood Life Hazard Category – See Map A

1% AEP – See Flood Map B

1% AEP Maximum Water Level³: 3.05 m AHD

1% AEP Maximum Peak Depth from natural ground level³: 2.34 m

1% AEP Maximum Velocity: 0.54 m/s

1% AEP Provisional Flood Hazard: High **See Flood Map E**

1% AEP Hydraulic Categorisation: Flood storage **See Flood Map F**

Flood Planning Area – See Flood Map C

Flood Planning Level (FPL) ^{1, 2, 3 & 4}: 3.6 m AHD

Probable Maximum Flood (PMF) – See Flood Map D

PMF Maximum Water Level²: 5.03 m AHD

PMF Maximum Depth from natural ground level: 4.31 m

PMF Maximum Velocity: 0.66 m/s

PMF Flood Hazard: High **See Flood Map G**

PMF Hydraulic Categorisation: Floodway **See Flood Map H**

Flooding with Climate Change (See Flood Map I)

The following is for the 30% Rainfall intensity increase and 0.9m Sea Level Rise Scenario:

1% AEP Maximum Water Level with Climate change^{1&3}: 3.81 m AHD

1% AEP Maximum Depth with Climate Change³: 2.86 m

1% AEP Maximum Velocity with Climate Change³: N/A m/s

Flood Risk Precinct – See Map J

Indicative Ground Surface Spot Heights – See Map K

¹The flood information does not take into account any local overland flow issues nor private stormwater drainage systems.

²Overland flow/mainstream water levels may vary across a sloping site, resulting in variable minimum floor/flood planning levels across the site.

³Intensification of development in the former Pittwater LGA requires the consideration of climate change impacts which may result in higher minimum floor levels than those indicated on this flood advice.

⁴Vulnerable/critical developments require higher minimum floor levels using the higher of the PMF or Flood Planning Level

General Notes:

- All levels are based on Australian Height Datum (AHD) unless otherwise noted.
- This is currently the best available information on flooding; it may be subject to change in the future.
- Council recommends that you obtain a detailed survey of the above property and surrounds to AHD by a registered surveyor to determine any features that may influence the predicted extent or frequency of flooding. It is recommended you compare the flood level to the ground and floor levels to determine the level of risk the property may experience should flooding occur.
- Development approval is dependent on a range of issues, including compliance with all relevant provisions of Northern Beaches Council's Local Environmental Plans and Development Control Plans.
- Please note that the information contained within this letter is general advice only as a detail survey of the property as well as other information is not available. Council recommends that you engage a suitably experienced consultant to provide site specific flooding advice prior to making any decisions relating to the purchase or development of this property.
- The Flood Studies on which Council's flood information is based are available on Council's website.

FLOOD MAP A: FLOOD LIFE HAZARD CATEGORY



Notes:

- Refer to 'Flood Emergency Response Planning for Development in Pittwater Policy for additional information on the Flood Life Hazard Categories and Pittwater 21 DCP Control B3.12.
- Cadastre Lines (Source: NSW Government Land and Property Information), flood levels/extents (Source: Ingleside, Elanora and Warriewood Overland Flow Flood Study (2019), WMAwater, Narrabeen Lagoon Flood Study 2013, BMT WBM) and aerial photography (Source Near Map 2014) are indicative only.

FLOOD LEVEL POINTS



Note: Cadastre Lines (Source: NSW Government Land and Property Information), flood levels/extents (Source: Narrabeen Lagoon Flood Study 2013, BMT WBM) and aerial photography (Source: NearMap 2014) are indicative only.

Flood Levels

ID	5% AEP Max WL (m AHD)	5% AEP Max Depth (m)	1% AEP Max WL (m AHD)	1% AEP Max Depth (m)	1% AEP Max Velocity (m/s)	Flood Planning Level (m)	PMF Max WL (m AHD)	PMF Max Depth (m)	PMF Max Velocity (m/s)
1	2.71	0.81	3.05	1.15	0.04	3.6	5.02	3.07	0.05
2	2.71	0.72	3.05	1.06	0.04	3.6	4.98	3.01	0.09
3	2.71	0.81	3.05	1.15	0.03	3.6	4.98	3.07	0.19
4	2.71	1.17	3.05	1.51	0.04	3.6	5.02	3.06	0.03
5	2.71	0.61	3.05	1.00	0.40	3.6	4.99	2.88	0.27
6	2.71	0.75	3.05	1.08	0.03	3.6	4.98	3.01	0.18

WL – Water Level

PMF – Probable Maximum Flood

N/A = no peak water level/depth/velocity available in flood event

Climate Change Flood Levels (30% Rainfall intensity and 0.9m Sea Level Rise)

ID	CC 1% AEP Max WL (m AHD)	CC1 % AEP Max Depth (m)
1	3.81	2.86
2	3.81	2.86
3	3.81	2.86
4	3.81	2.86
5	3.81	2.86
6	3.81	2.86

A variable Flood Planning Level might apply - 0.5m above 1% AEP max water level (for Mainstream flooding) or 0.5m above the 1% AEP max water level flow path extent with depth greater than 0.3m and 0.3m above the 1% AEP max water level flow path with depth 0.3m and less (for overland flow)

WL – Water Level

PMF – Probable Maximum Flood

N/A = no peak water level/depth/velocity available in flood event.

FLOOD MAP B: FLOODING - 1% AEP EXTENT



Notes:

- Extent represents the 1% annual Exceedance Probability (AEP) flood event.
- Flood events exceeding the 1% AEP can occur on this site.
- Extent does not include climate change.
- Cadastre Lines (Source: NSW Government Land and Property Information), flood levels/extents (Source: Narrabeen Lagoon Flood Study 2013, BMT WBM) and aerial photography (Source Near Map 2014) are indicative only.

FLOOD MAP C: FLOOD PLANNING AREA EXTENT



Notes:

- Extent represents the 1% annual Exceedance Probability (AEP) flood event + freeboard.
- Extent does not include climate change.
- Cadastre Lines (Source: NSW Government Land and Property Information), flood levels/extents (Source: Narrabeen Lagoon Flood Study 2013, BMT WBM) and aerial photography (Source Near Map 2014) are indicative only.


FLOOD MAP D: PMF EXTENT MAP



Notes:

- Extent represents the Probable Maximum Flood (PMF) flood event
- Extent does not include climate change
- Cadastre Lines (Source: NSW Government Land and Property Information), flood levels/extents (Source: Narrabeen Lagoon Flood Study 2013, BMT WBM) and aerial photography (Source: NearMap 2014) are indicative only


FLOOD MAP E: 1% AEP FLOOD HAZARD EXTENT MAP

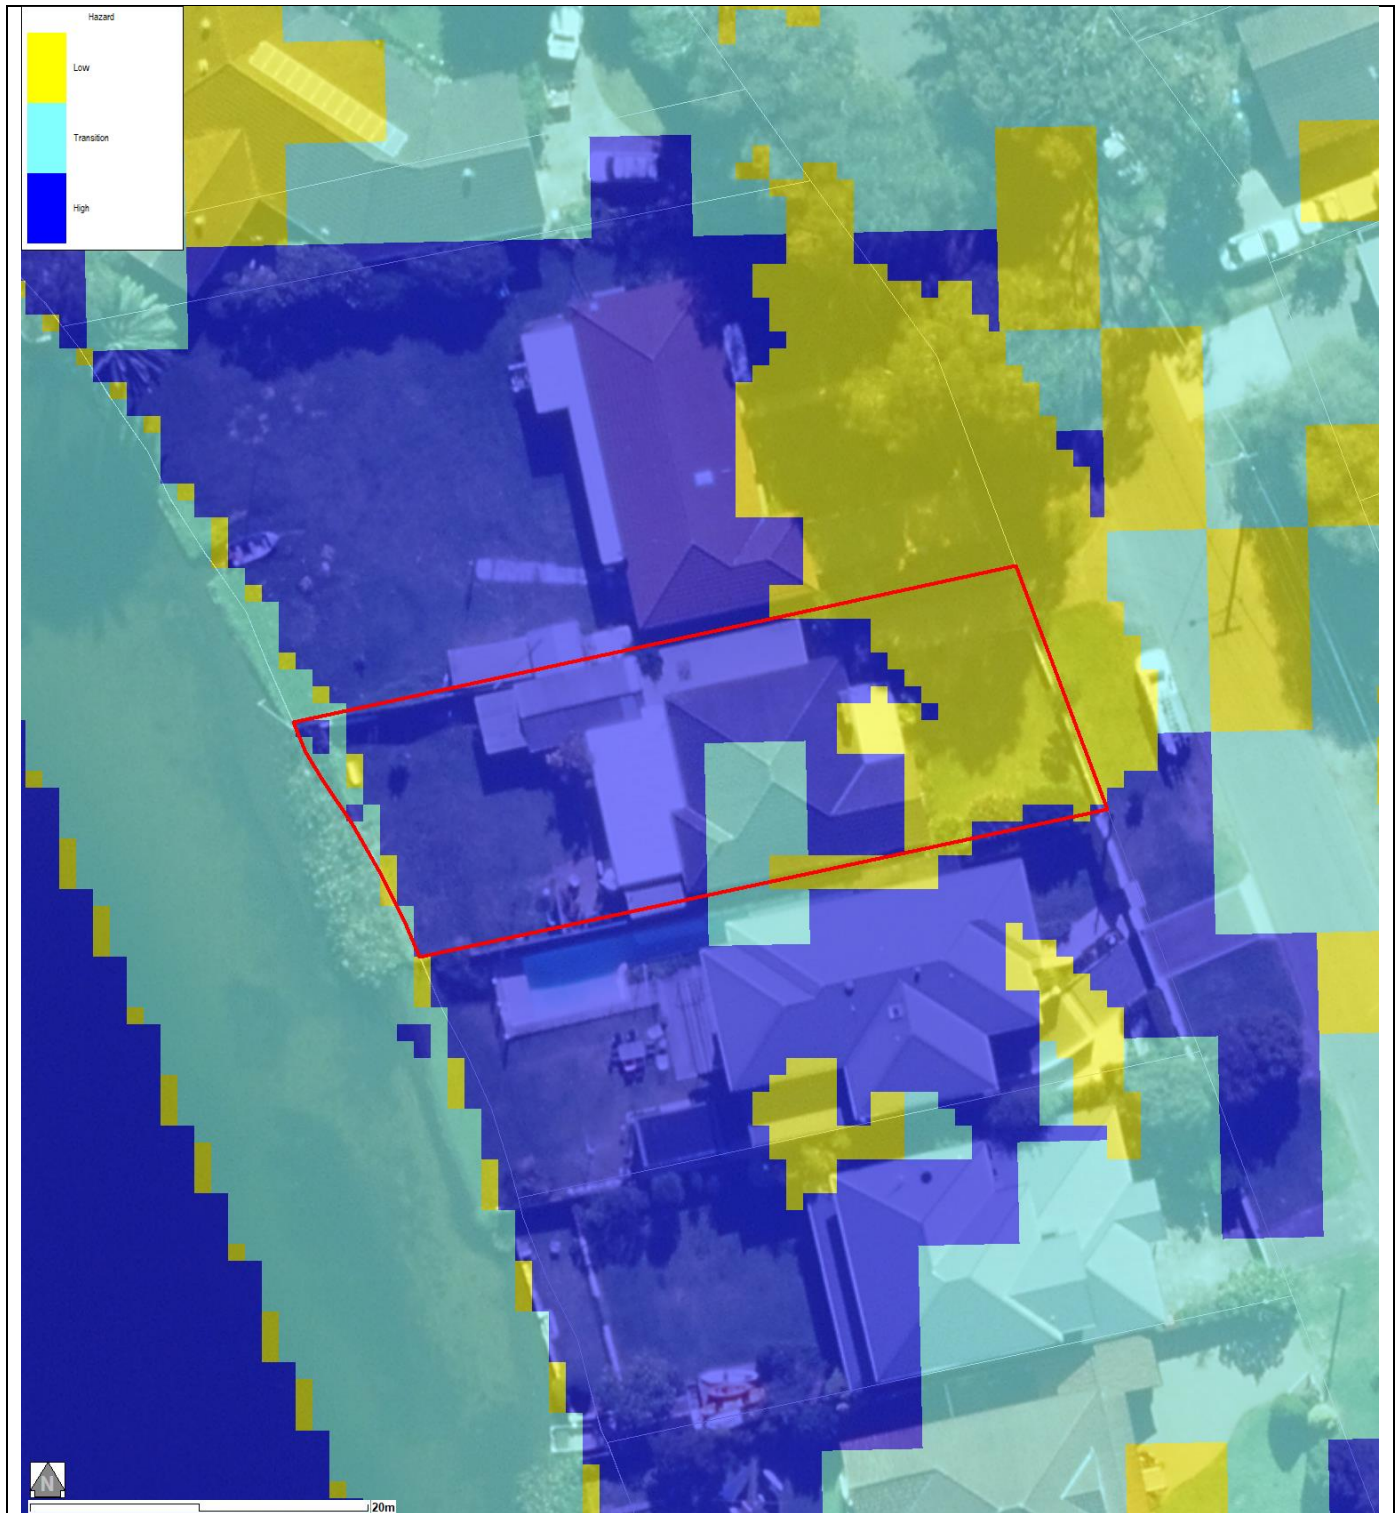

Notes:

- Extent represents the 1% annual Exceedance Probability (AEP) flood event
- Extent does not include climate change
- Cadastre Lines (Source: NSW Government Land and Property Information), flood levels/extents (Source: Narrabeen Lagoon Flood Study 2013, BMT WBM) and aerial photography (Source: NearMap 2014) are indicative only

FLOOD MAP F: 1% AEP FLOOD HYDRAULIC CATEGORY EXTENT MAP

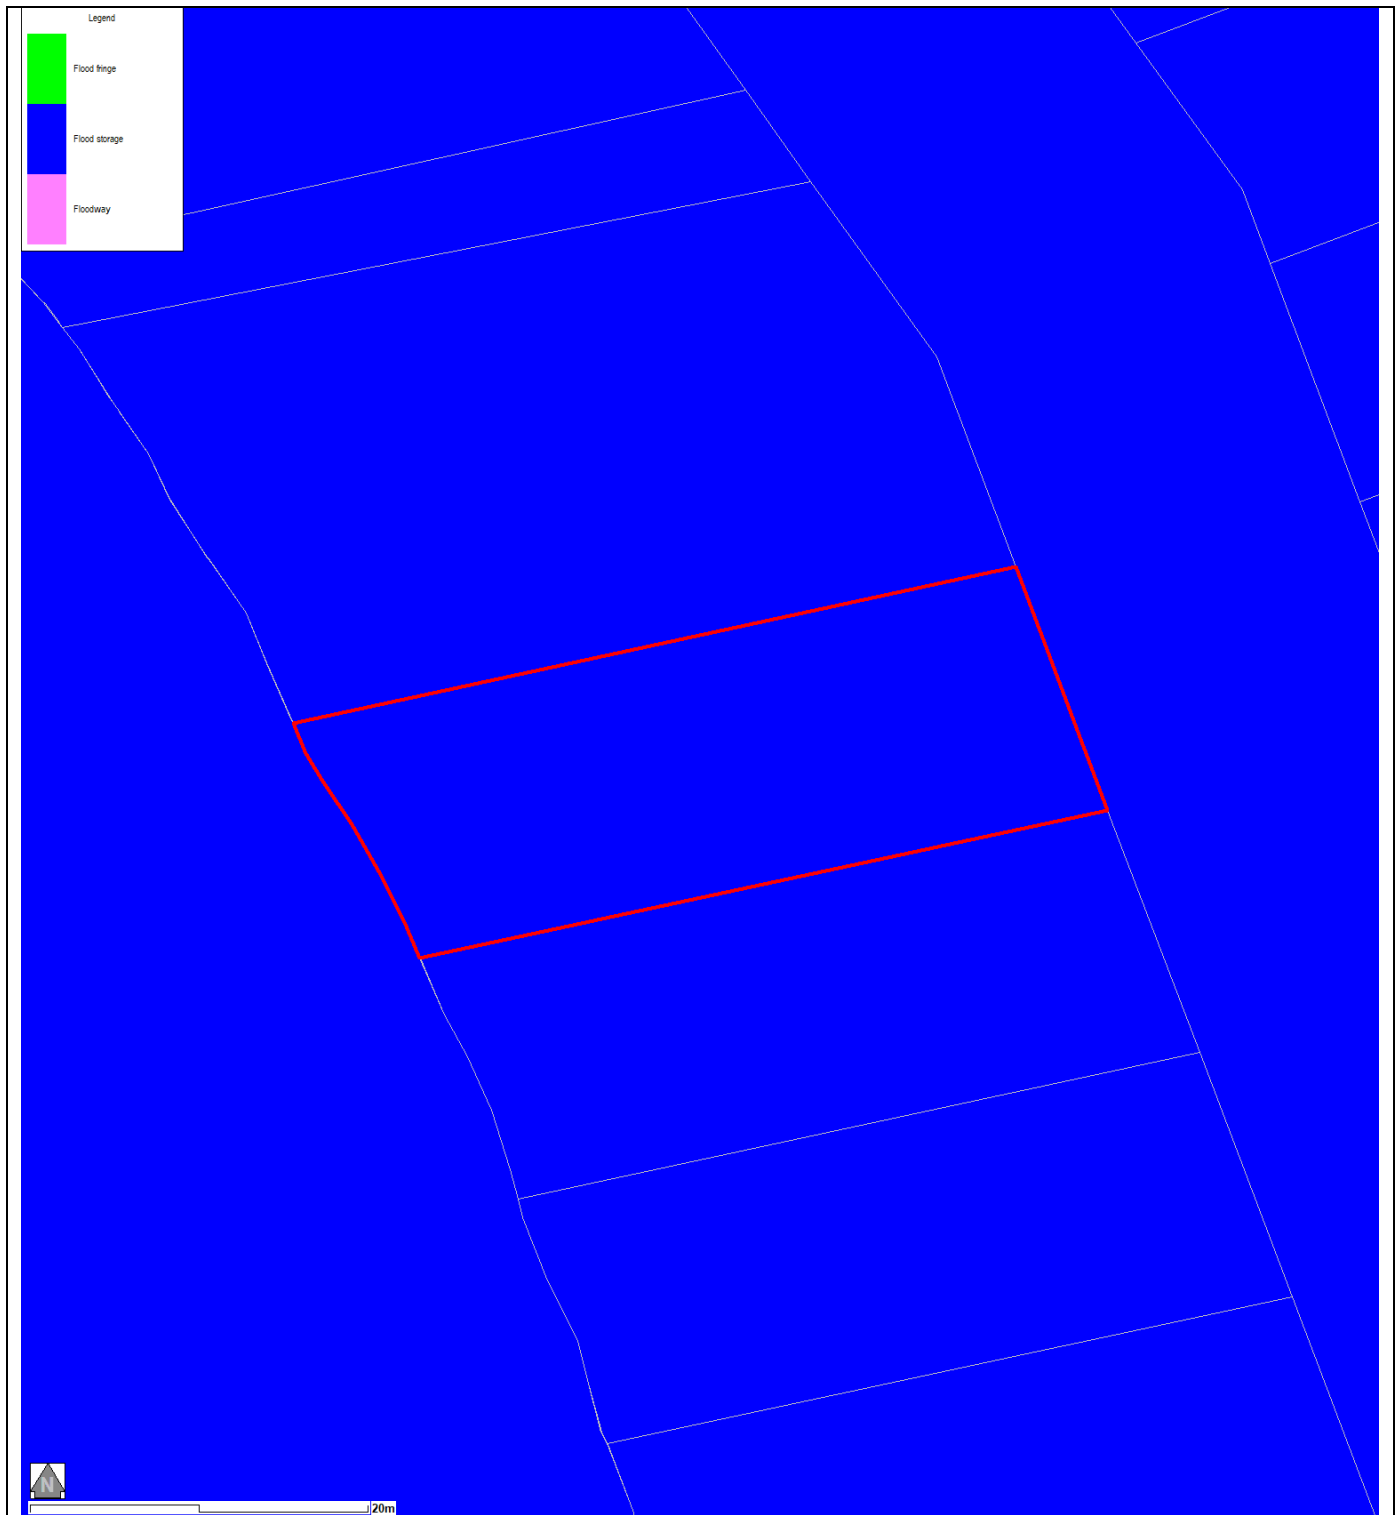

Notes:

- Extent represents the 1% annual Exceedance Probability (AEP) flood event
- Extent does not include climate change
- Cadastral Lines (Source: NSW Government Land and Property Information), flood levels/extents (Source: Narrabeen Lagoon Flood Study 2013, BMT WBM) and aerial photography (Source: NearMap 2014) are indicative only


FLOOD MAP G: PMF FLOOD HAZARD EXTENT MAP



Notes:

- Extent represents the 1% annual Exceedance Probability (AEP) flood event
- Extent represents the Probable Maximum Flood (PMF) event
- Extent does not include climate change
- Cadastre Lines (Source: NSW Government Land and Property Information), flood levels/extents (Source: Narrabeen Lagoon Flood Study 2013, BMT WBM) and aerial photography (Source: NearMap 2014) are indicative only

FLOOD MAP H: PMF FLOOD HYDRAULIC CATEGORY EXTENT MAP

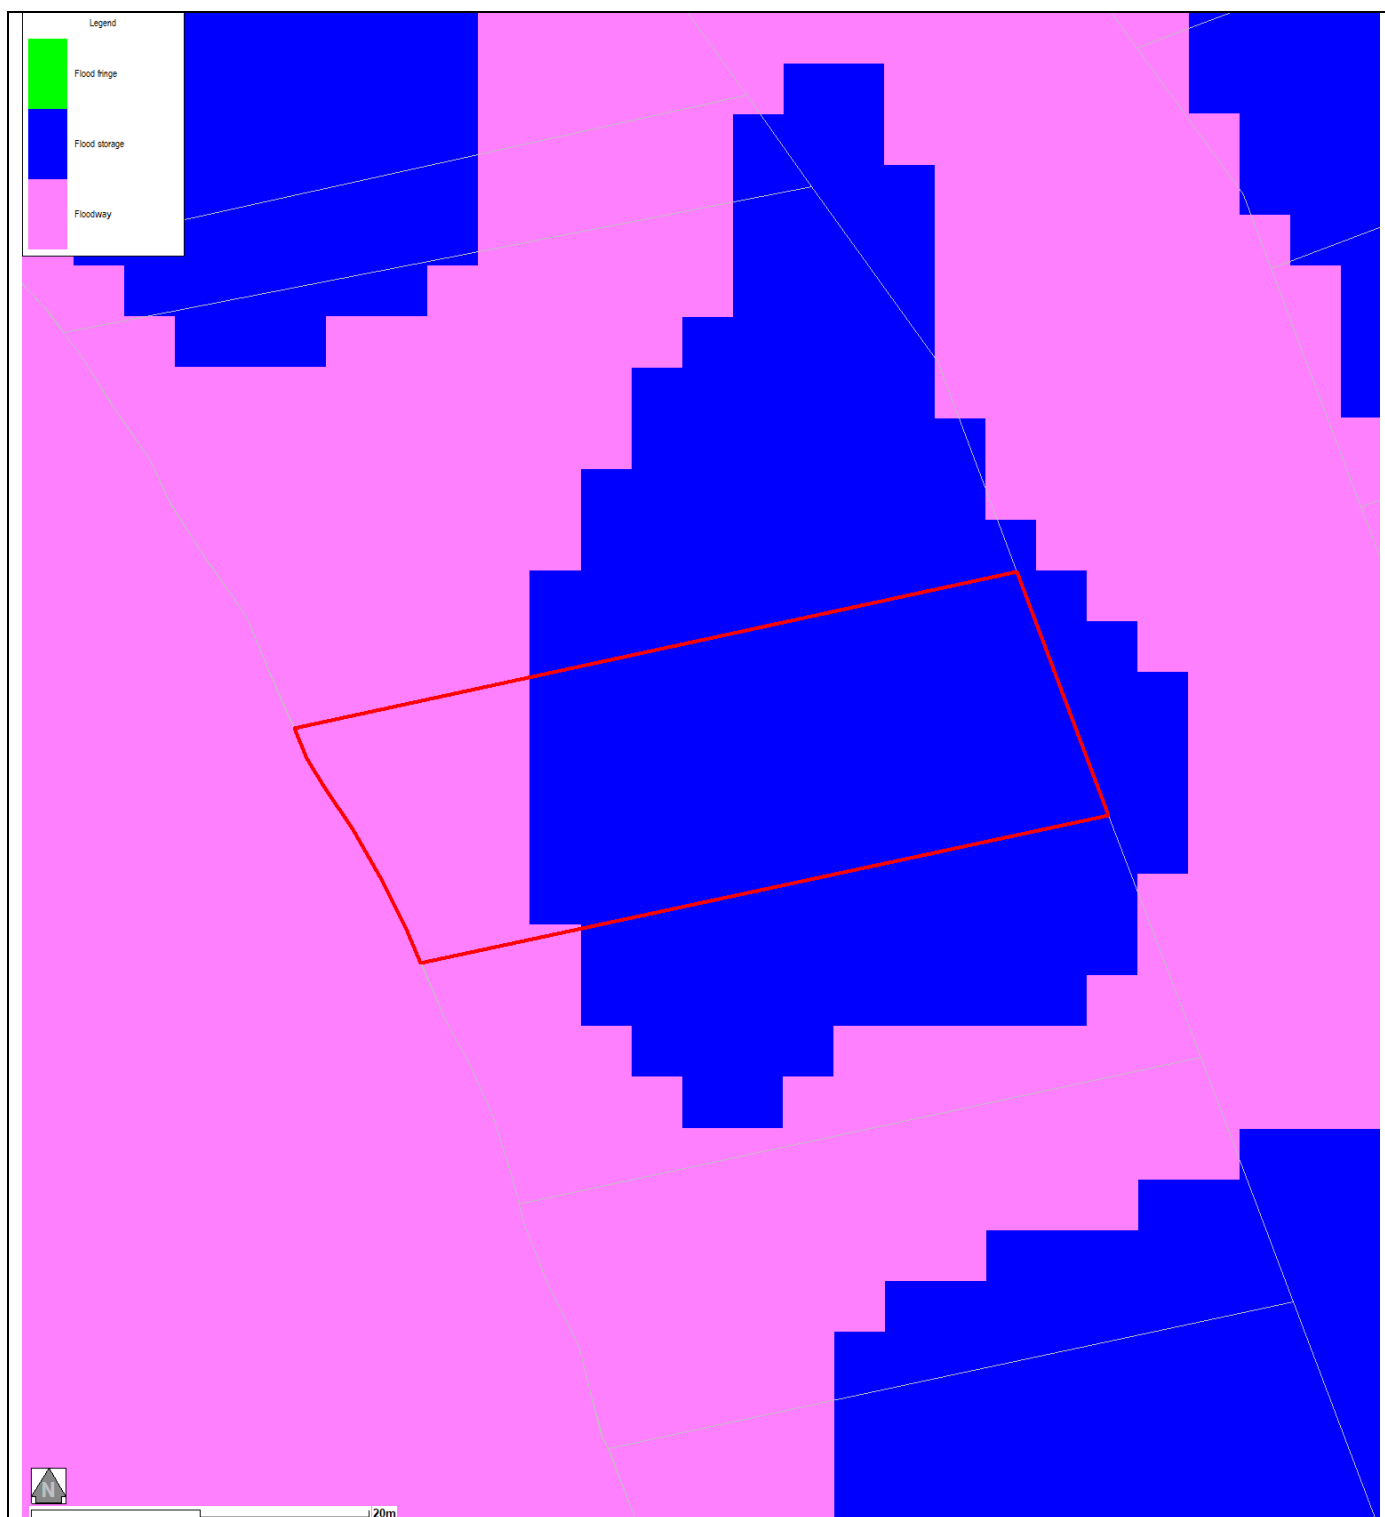

Notes:

- Extent represents the Probable Maximum Flood (PMF) event
- Extent does not include climate change
- Cadastre Lines (Source: NSW Government Land and Property Information), flood levels/extents (Source: Narrabeen Lagoon Flood Study 2013, BMT WBM) and aerial photography (Source: NearMap 2014) are indicative only


FLOOD MAP I: FLOODING – 1% AEP EXTENT PLUS CLIMATE CHANGE



Note:

- Extent represents the 1% annual Exceedance Probability (AEP) flood event including 30% rainfall intensity and 0.9m Sea Level Rise climate change scenario
- Flood events exceeding the 1% AEP can occur on this site.
- Cadastre Lines (Source: NSW Government Land and Property Information), flood levels/extents (Source: Narrabeen Lagoon Flood Study 2013, BMT WBM) and aerial photography (Source: NearMap 2014) are indicative only

FLOOD MAP J: FLOOD RISK PRECINCT MAP

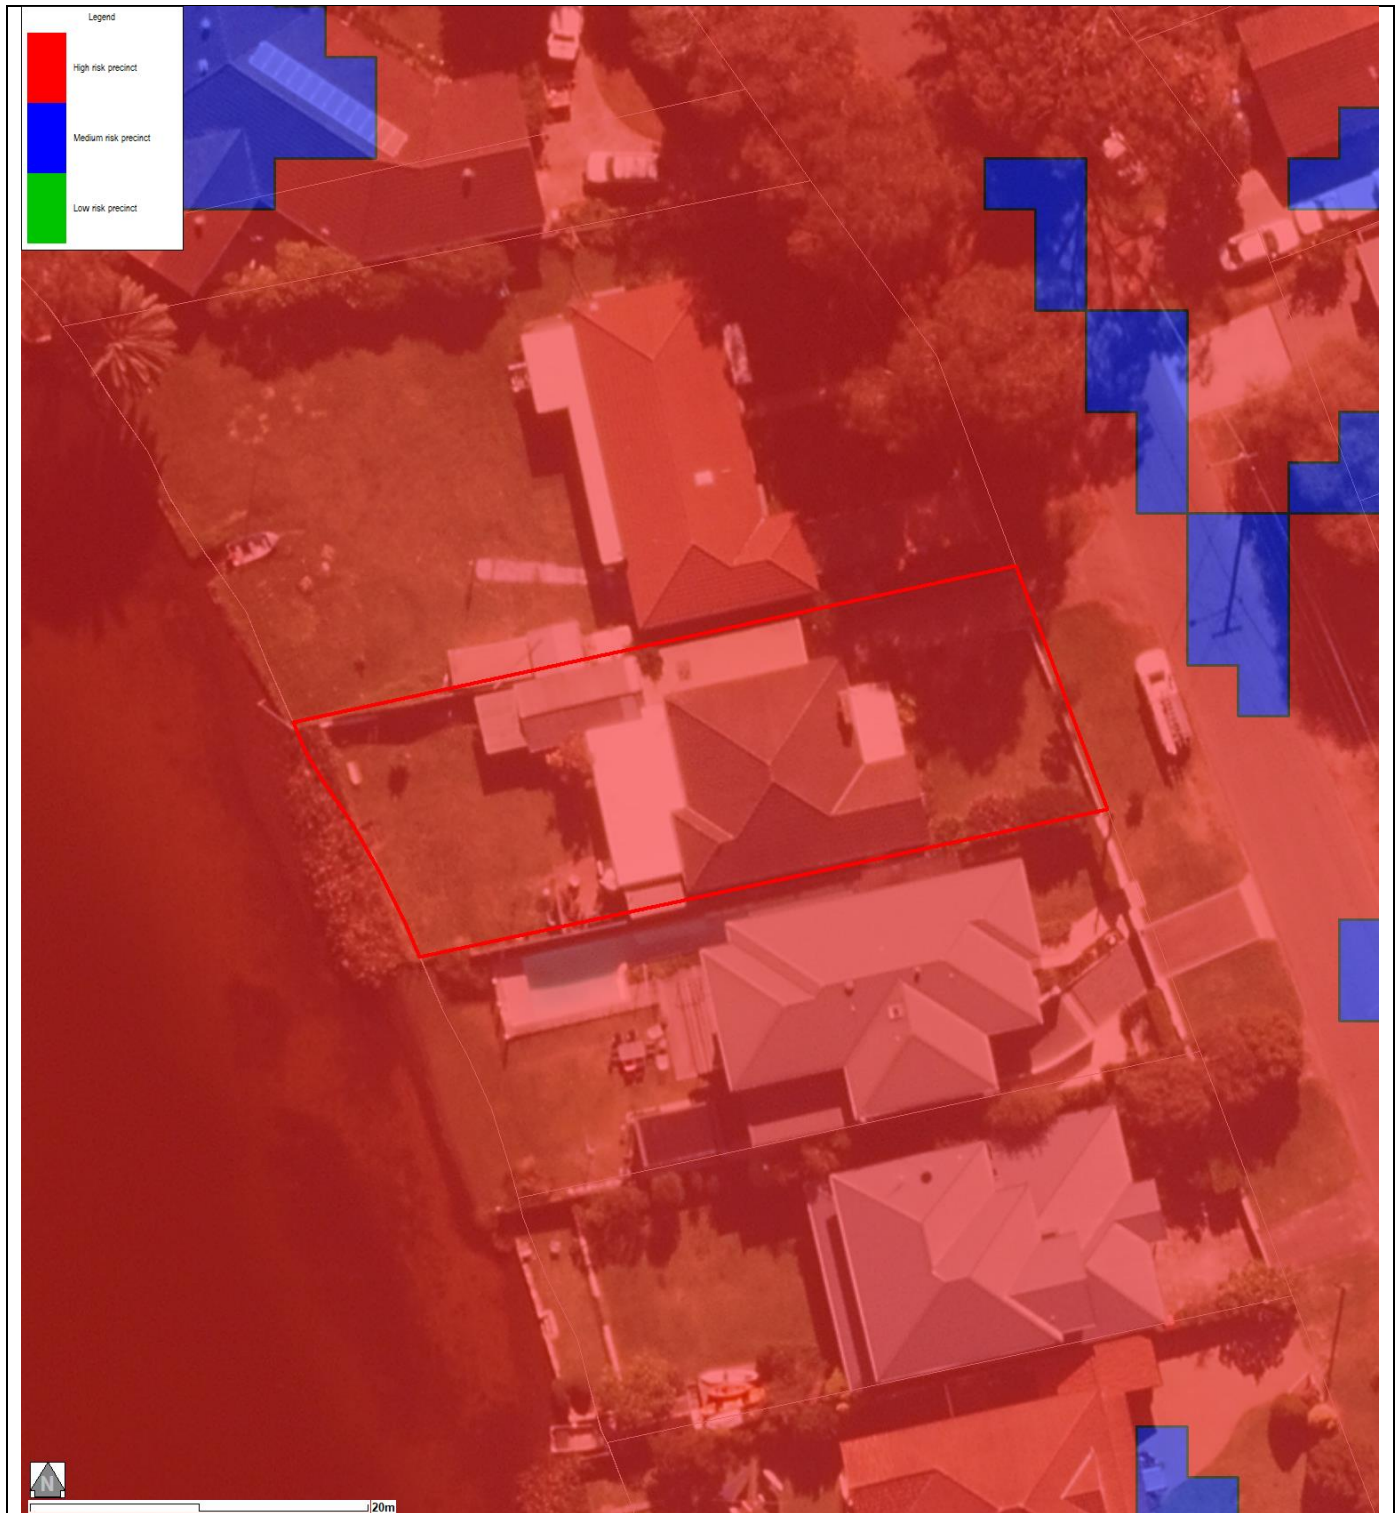

Notes:

- **Low Flood Risk precinct** means all flood prone land not identified within the High or Medium flood risk precincts.
- **Medium Flood Risk precinct** means all flood prone land that is (a) within the 1% AEP Flood Planning Area; and (b) is not within the high flood risk precinct.
- **High Flood Risk precinct** means all flood prone land (a) within the 1% AEP Flood Planning Area; and (b) is either subject to a high hydraulic hazard, within the floodway or subject to significant evacuation difficulties (H5 and or H6 Life Hazard Classification).
- Does not include climate change

MAP K: INDICATIVE GROUND SURFACE SPOT HEIGHTS



Notes:

- The surface spot heights shown on this map were derived from Airborne Laser Survey and are indicative only.
- Accuracy is generally within $\pm 0.2\text{m}$ vertically and $\pm 0.15\text{m}$ horizontally, and Northern Beaches Council does not warrant that the data does not contain errors.
- If accuracy is required, then survey should be undertaken by a registered surveyor.