# **DOUBLE STOREY DWELLING** #10,Raven circuit,Warriewood



#### General notes:

- All materials and work practices shall comply with all-relevant current Australian standards (as amended)
- referred to therein.

  These drawings shall be read in conjunction with all relevant structural and all other consultant's drawings/ details and with any other written instructions issued. Figured dimensions take precedence over scaled

- Figured dimensions take precedence over scaled dimensions.
  The builder shall take all steps necessary to ensure the stability and general water tightness of all new and/or existing structures during all works.
  The contractor/builder is responsible for setting out and checking all levels and measurements on site.
  All dimensions and levels are to be checked and verified by the Owner/builder and any discrepancies in the documents must be resolved before ordering commencement of any works.
  Window sizes nominated are nominal only. Actual size may vary according to manufacturer. Windows are to be flashed all around.
  Installation of all services shall comply with supply authority requirements.

- Installation of all services shall comply with supply authority requirements.

  The builder and subcontractor shall ensure that all stormwater drains, Sewer pipes and the like are located at a sufficient distance from any footing and/or slab edge beams so as to prevent general moisture penetration, dampness, weakening and under mining of any building and its footing system.

Page No.	Title
1	Coverpage
2	Basix Notes
3	Cut and Fill Plan
4	Site Plan
5	Ground Floor Plan
6	First Floor Plan
7	Roof Plan
8	Elevations & Section
9	Side Elevations
10	Door Schedule & SOF
11	Windows Schedule
12	Landscape Plan
13	Sediment Control Plan
14	Site Analysis
15	Shadow Analysis
16	Floor Finish







Cut and Fill is only under Slab. Cut and Fill on the site is minimal, Hence does not required Retaining wall.





Cut and Fill Plan 1:200

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В	27/03/2025	Changes as per Council Letter
Α	24/01/25	Issue for DA



DRAWING : Cut and Fill Plan						
CLIENT :	Skymark Luxury Living Pty Ltd					
PROJECT :	DOUBLE STOREY DWELLING					
	#10,Raven circuit,Warriewood					

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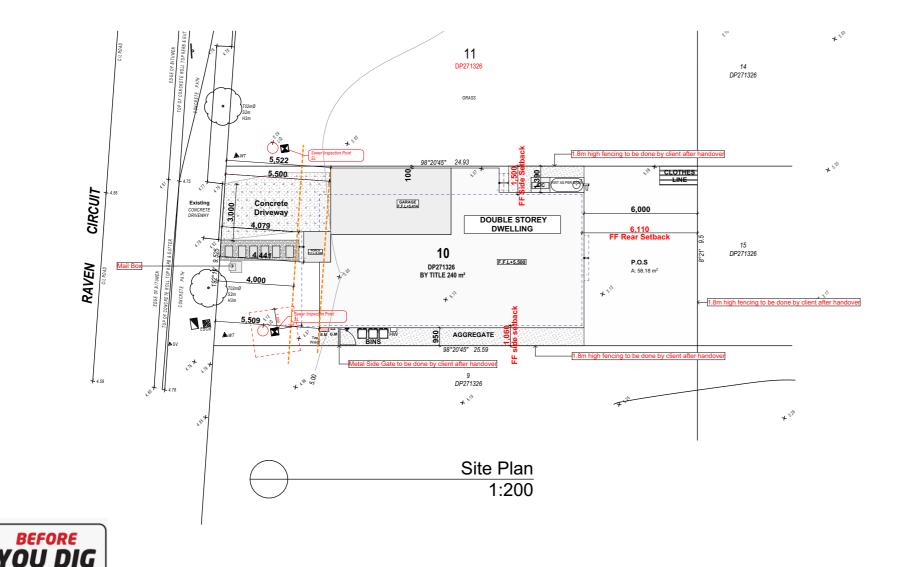
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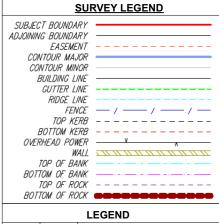
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CROSSOVER	Driveway	GARAGE
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1	11.3%	15 444
!	<u>-</u>	+5,414
<u>i</u>		624
+4,790		<del></del>
'	Driveway gradient	
	1:100	







LLGLIND					
Ref.img	Mark	Name			
9	S.A	Smoke Alarm (AS3786 Hard Wired to Mains)			
	R.W.T	Rain Water Tank			
	E.M	Electric Meter			
	A/C	Air Conditioner			
	HW	Wall Mounted Hot water System			
	P.O.S	Private Open Space			
	FW	Floor Waste			
$\boxtimes$	MV	Mechanical Ventilation (All vent to exhaust outside).			
$\searrow$	ME	Mechanical Ventilation (All yent to exhaust outside).			

4

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www.byda.com.au

Zero Damage - Zero Harm

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DRAWING : Site Plan					
CLIENT: Skymark Luxury Living Pty Ltd	_				
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#10,Raven circuit,Warriewood	F				

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SITE CALCUALTIONS

Name

Site Area

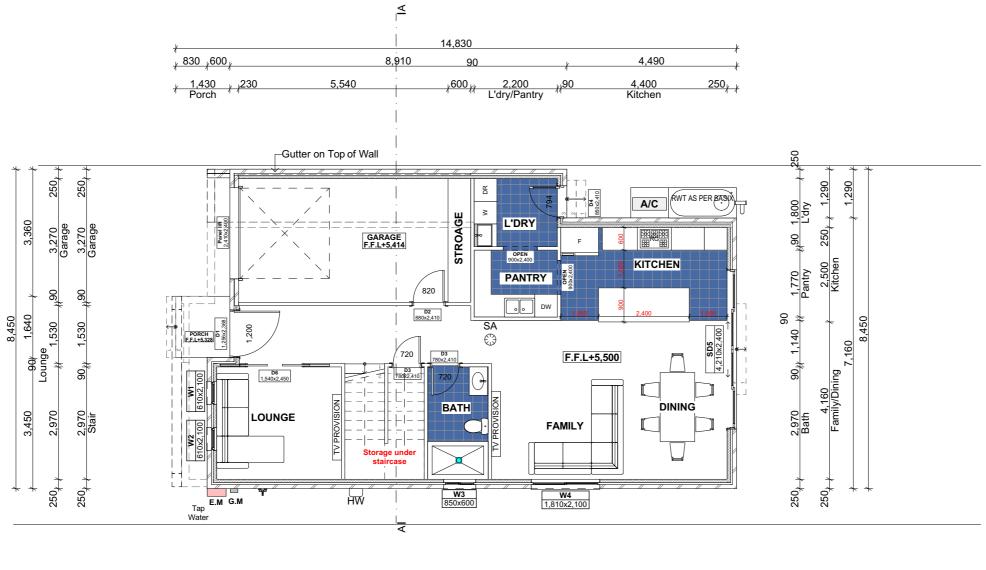
Landscape Area

Area SQM

240.00 86.18

No.

## External Walls with vapour permeable membrane as per manufacturer detail.



830 / 250	3,300 Lounge	90*	2,100 Stair	90/	1,600 Bath	∦90	6,230 Family/ Dining	250//
, 830 ,					14,0	00		k
1 /					14,830			1 k

		LEGEND
Ref.img	Mark	Name
0	S.A	Smoke Alarm (AS3786 Hard Wired to Mains)
	R.W.T	Rain Water Tank
	E.M	Electric Meter
	A/C	Air Conditioner
	HW	Wall Mounted Hot water System
	P.O.S	Private Open Space
	FW	Floor Waste
$\boxtimes$	MV	Mechanical Ventilation (All vent to exhaust outside).
	ME	Mechanical Ventilation (All vent to exhaust outside).
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Ground Floor 1:100

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DRAWING : Ground Floor Plan		
CLIENT :	Skymark Luxury Living Pty Ltd	
PROJECT :	DOUBLE STOREY DWELLING	
	#10.Raven circuit.Warriewood	

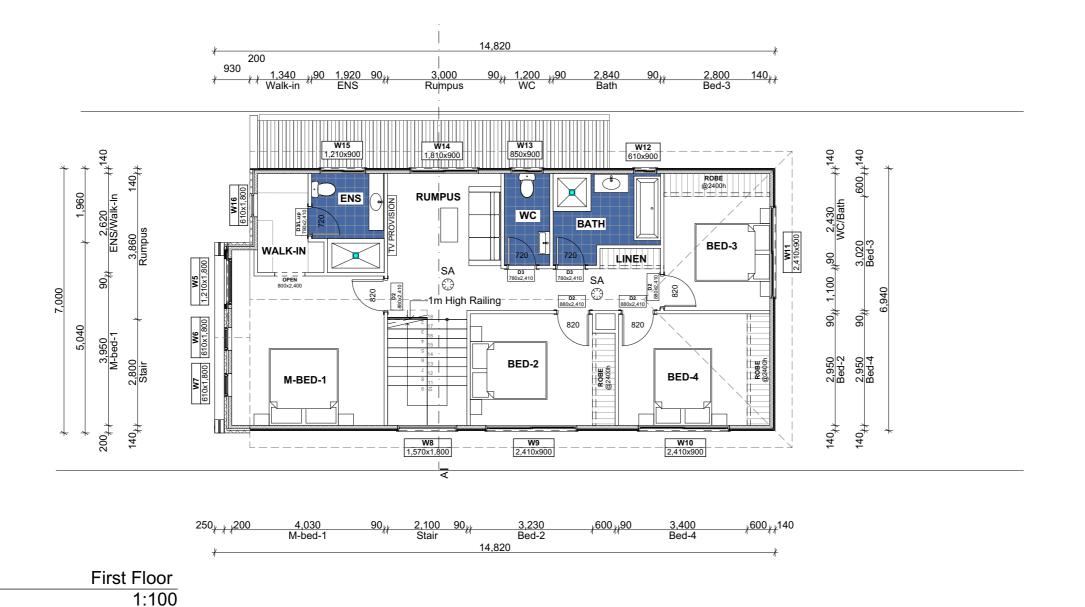
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Selected Cladding with vapour permeable membrane as per manufacturer detail.



LEGEND Ref.img Mark Name Smoke Alarm S.A AS3786 Hard Wired to Mains R.W.T Rain Water Tank E.M A/C Air Conditioner Wall Mounted HW Hot water System P.O.S Private Open Space FW Floor Waste Mechanical Ventilation MV (All vent to exhaust outside). Mechanical Ventilation ME (All vent to exhaust outside).



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DRAWING : First Floor Plan		
CLIENT:	Skymark Luxury Living Pty Ltd	
PROJECT :	DOUBLE STOREY DWELLING	
	#10,Raven circuit,Warriewood	

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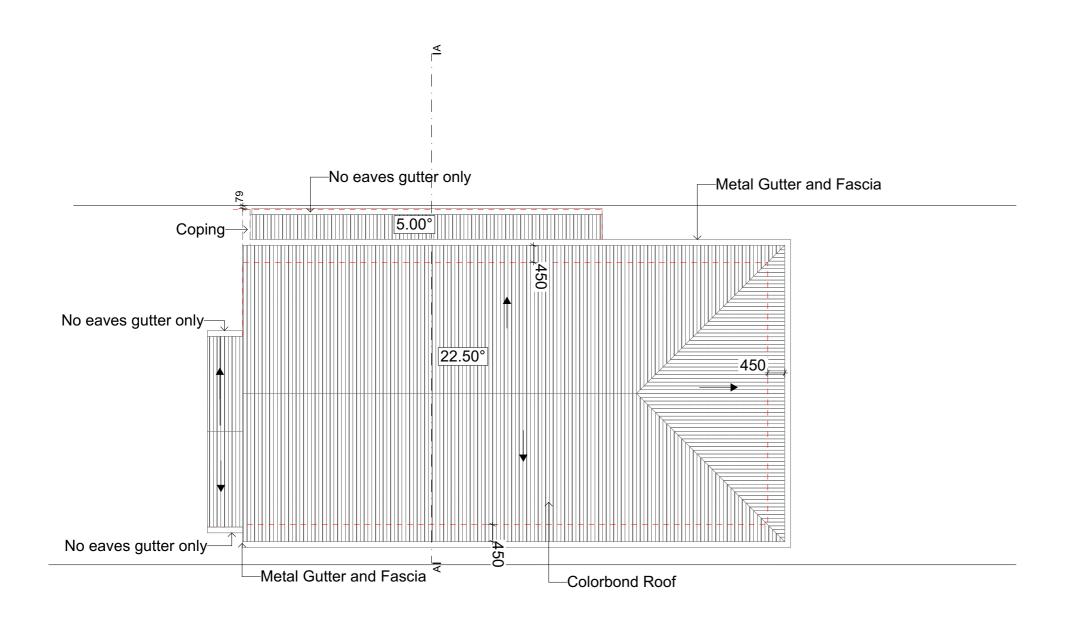
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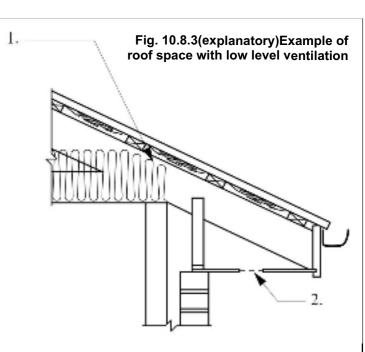
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#### Figure Notes

- 1. Min 20 mm gap maintained between insulation and sarking
- 2. Eave ventilation opening in accordance with Table 10.8.3.

Roof 1:100



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DRAWING : Roof Plan		
CLIENT :	Skymark Luxury Living Pty Ltd	_   _
PROJECT :	DOUBLE STOREY DWELLING	_   _
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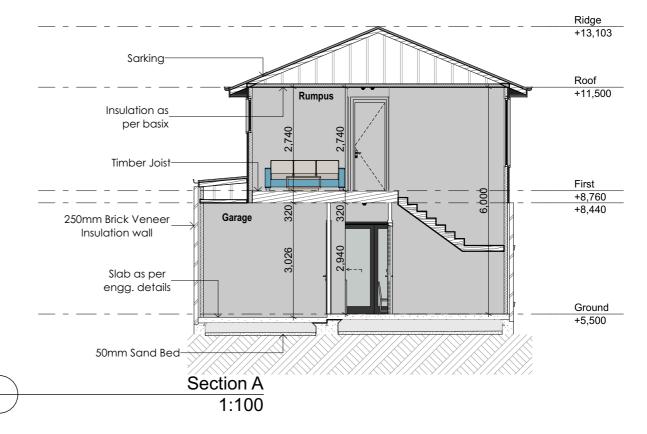
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1 West Elevation (Front ) 1:100





East Elevation (Rear) 1:100

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DRAWING : Elevations & Section	DRA
CLIENT : Skymark Luxury Living Pty Ltd	SC
PROJECT: DOUBLE STOREY DWELLING	1:
#10,Raven circuit,Warriewood	PAC

Lot-10 D.P 271326

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PROJECT NO. **2411 791**ISSUE

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8.5m (max building height) -Colorbond Roof Ridge +13,103 1,603 22.50° 22.50° Metal Gutter and Fascia No eaves gutter only Roof +11,500 -Aluminium Window -Selected Cladding Foam Rendered wall -Colorbond Roof -Gutter on Top of Wall First 8,096 Building height +8,760 -Face Brick Wall Ground +5,500 +5,110 Existing Ground +5,000

North Elevation (left Side)

8.5m (max building height)

Level



South Elevation (Right Side) 1:100

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Α	24/01/25	Issue for DA

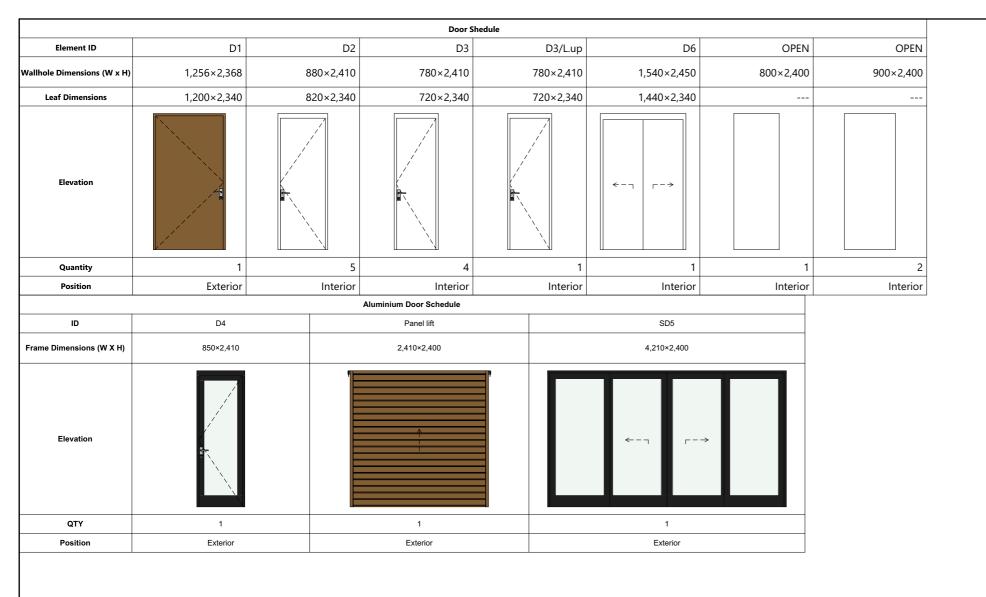
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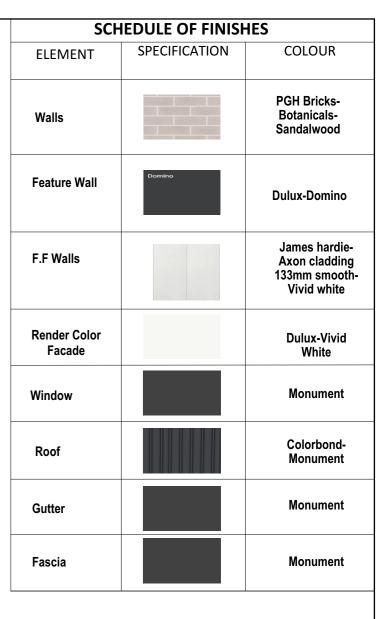
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μ	 27/02/2025	Changes as per Council Letter
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DRAWING : Door Schedule & SOF CLIENT: Skymark Luxury Living Pty Ltd

PROJECT: **DOUBLE STOREY DWELLING** #10,Raven circuit,Warriewood

Lot-10 D.P 271326

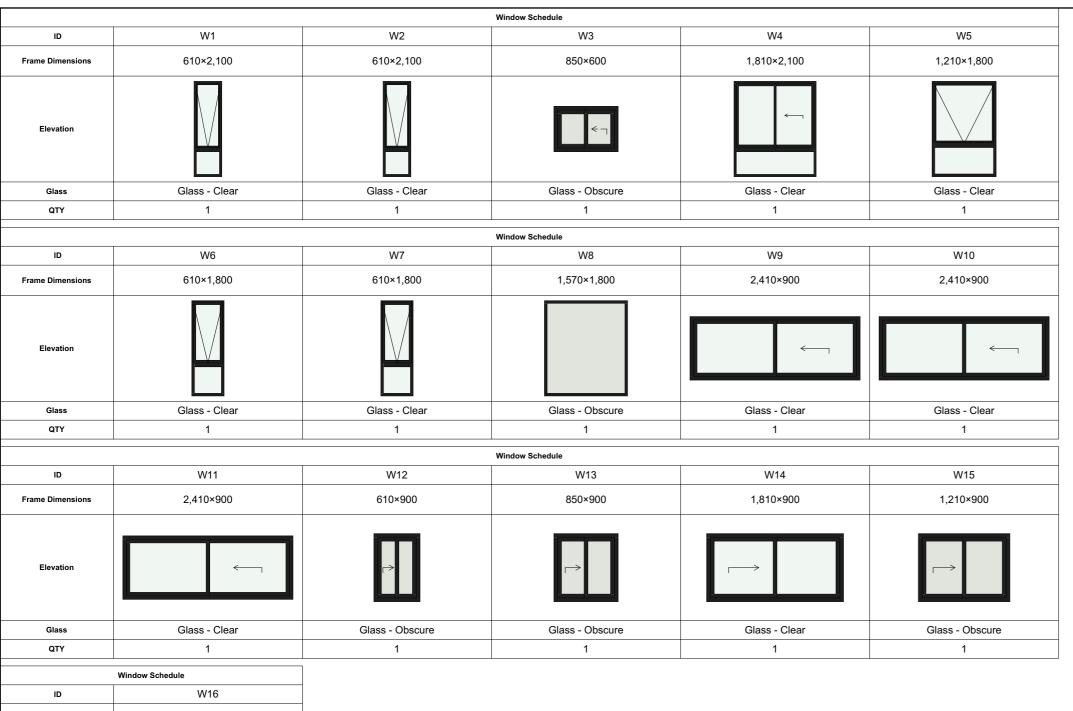
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	Window Schedule
ID	W16
Frame Dimensions	610×1,800
Elevation	
Glass	Glass - Obscure
QTY	1

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В	27/03/2025	Changes as per Council Letter
Α	24/01/25	Issue for DA

DRAWING : Windows Schedule CLIENT: Skymark Luxury Living Pty Ltd PROJECT: DOUBLE STOREY DWELLING

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PROJECT NO. 2411 791

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NOTIE:

TO BE CHECKED AND CONFIRMED BY BUILDER ON SITE BEFORE PLACING ORDER.

FALL PREVENTION FROM WINDOWS
WINDOWS TO BE MANUFACTURED IN ACCORDANCE WITH REQUIREMENTS OF BCA CLAUSE
3.9.2.5

.9.2.5
- If Opening withing 1700mm above the floor; and climable elements between 150 and 750 mN bove the floor, opening must be permanently restricted to 125mm; or fitted withn a non emovable robust screen.
- If opening between 865 and 1700mm above the floor; and no climable elements between 15 nd 760mm bove the floor, opening must be restricted to 125mm; or fitted with a removable observer or the floor.

bust screen.

If opening between 865 of the floor; and climable elements between 150 and 760mm above following within a non-removable robust screen.

If no opening within 1700mm of the floor. No restrictions apply.

Part 3.9.2.6 Protection of openable windows - bedrooms
(a) A window opening in a bedroom must be provided with protection, where the floor below the window is 2 m or more above the surface beneath.
(b) Where the lowest level of the window opening covered by (a) is less than 1.7 m above the floor, the window opening.

) Where the lowest level of the window opening covered by (a) is less than 1.7 m above to or, the window opening ust comply with the following:
The openable portion of the window must be protected withJa device capable of restricting the window opening; or
Ja screen with secure fittings, and the screen with secure fittings, and the screen with secure fittings, with the screen with secure fittings, and permit a 125 mm sphere to pass through the window opening or screen; and resist an outward horizontal action of 250 N against the a) window restrained by a device; or b) screen protecting the opening; and have a child resistant release mechanism if the screen or device is able to be removed, llocked or

rerridden. J Where a device or screen provided in accordance with (b)(i) is able to be removed, unlocked or rerridden, a barrier ith a height not less than 865 mm above the floor is required to the openable window in dition to window

otection.

(i) A barrier covered by (c) must notpermit a 125 mm sphere to pass through it; and
) have any horizontal or near horizontal elements between 150 mm and 760 mm above the floo

3.9.2.7 Protection of openable windows - rooms other than bedrooms
(a) A window opening in a room other than a bedroom must be provided with protection where
the floor below the window
is 4 m or more above the surface beneath.
(b) The openable part of the window covered by (a) must be protected with a barrier with a
height of not less than 865
ma above the floor.
(c) A barrier required by (b) must not(i) permit a 125 mm sphere to pass through it; and
(ii) have any horizontal or near horizontal elements between 150 mm and 760 mm above the floor
that facilitate
(limbing.

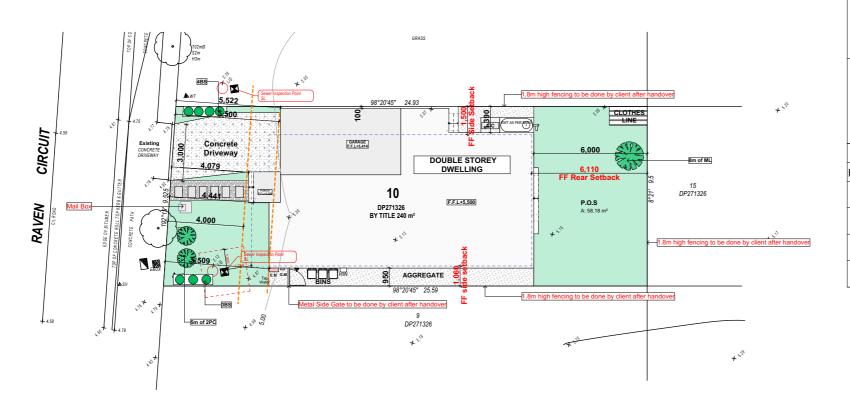
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# All Landscape to be done by owner.









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DRAWING : Landscape Plan	
CLIENT:	Skymark Luxury Living Pty Ltd
PROJECT :	DOUBLE STOREY DWELLING
	#10,Raven circuit,Warriewood

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POT.

SIZE

75LT.

45LT.

300mm

QUA.

1

2

7

HEIGHT

8-15m

5m

1-3m

TYPE

Tree

Tree

Grass

B

1:20 (BS) BANKSIA SPINULOSA Shrub

LEGEND

Ref.img

Name

Tree

Shrub

Grass
(Landscape Area)

Aggregate

GE:- GARDEN EDGING AS SELECTED
TREATED PINE SPLITS 90 MM 2.4 MT LENGTH,
FASTENED TO HARWOOD STAKES, MIMIMUM
DEPTH IN GROUND OF 300 MM WITH GALVANISED
TREATED PINE SCREWS(SIZE 75 MM X 8G)

LANDSCAPE SCHEDULE

NAME

MELALEUCA LINARIIFOLIA

PYRUS CALLERYANA (CHANTICLEER)

**BUFFALO GRASS** 

**AGGREGATE** 

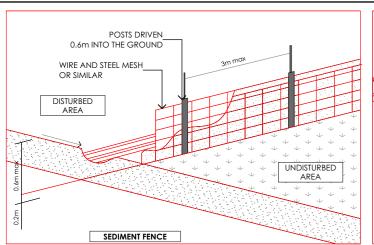
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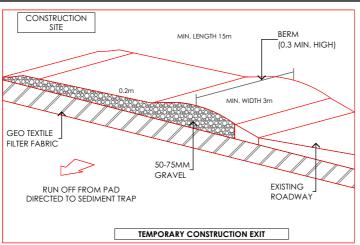
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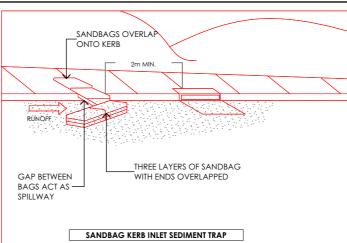
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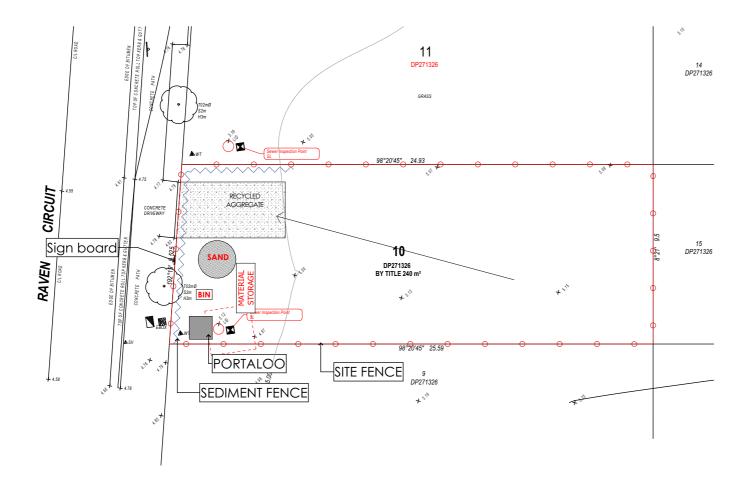
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LAWN:- BUFFALO WITH SHIRLEYS NO.17 FERTILISER
ALL PLANTS TO HAVE 35 MM OF BARK CHIP MULCH SPREAD
OVER TOP SOIL TURF TO BE WATERED MORNING AND
EVENING FOR A PERIOD OF TWO WEEKS OR AD NECESSARY.











- 1. ALL EROSION AND SEDIMENTATION CONTROL MEASURES, INCLUDING REVEGETATION AND STORAGE OF SOIL AND TOPSOIL, SHALL BE IMPLEMENTED TO THE STANDARDS OF THE SOIL CONSERVATION OF NSW.
- 2. ALL DRAINAGE WORKS SHALL BE CONSTRUCTED AND STABILIZED AS EARLY AS POSSIBLE DURING DEVELOPMENT.
- 3.SEDIMENT TRAPS SHALL BE CONSTRUCTED AROUND ALL INLET PITS, CONSISTING OF 300mm WIDE x 300mm DEEP TRENCH. 4. ALL SEDIMENT BASINS AND TRAPS SHALL BE CLEANED WHEN THE STRUCTURES
- AREA MAXIMUM OF 60% FULL OF SOIL MATERIALS, INCLUDING THE MAINTENANCE
- 5. ALL DISTURBED AREAS SHALL BE REVEGITATED AS SOON AS THE RELEVANT WORKS ARE COMPLETED.
- 6. SOIL AND TOPSOIL STOCKPILES SHALL BE LOCATED AWAY FROM DRAINAGE LINES
- AND AREA WHERE WATER MAY CONCENTRATE.
  7. FILTER SHALL BE CONSTRUCTED BY STRETCHING A FILTER FABRIC (PROPEX OR APPROVED EQUIVALENT BETWEEN POST AT 3.0m CENTRES. FABRIC SHALL BE BURIED 150mm ALONG ITS LOWER.

TOPSOIL SHALL BE STRIPPED AND STOCKPILED OUTSIDE HAZARD AREAS SUCH AS DRAINAGE LINES. THIS TOPSOIL IS TO BE RE-SPREAD LATER ON AREAS TO BE REVEGETATED AND STABILISED ONLY. (i.e ALL FOOT-PATHS, BATTERS, SITE, REGRADING AREAS, DRAINAGE RESERVES AND CHANNELS). TOP SOIL SHALL NOT BE SPREAD ON ANY OTHER AREAS SPECIFICALLY INSTRUCTED BY THE SUPERINTENDENT. IF THEY ARE TO REMAIN FOR LONGER THAN ONE MONTH STOCKPILES SHALL BE PROTECTED FROM EROSION BY COVERING THEM WITH A MULCH AND HYDROSEEDING AND, IF NECESSARY. BY LOCATING BANKS OR DRAINS UPSLOPE TO DIVERT THE RUNOFF AROUND THEM. IN SOME CIRCUMSTANCES IT MAY BE NECESSARY TO PLACE BANKS OR DRAINSDOWN STREAM OF A STOCKPILE TO RETARD SEDIMENT LADEN RUNOFF. THE CONTRACTOR SHALL REGULARLY MAINTAIN ALL SEDIMENT AND EROSION CONTROL DEVICES AND REMOVE ACCUMULATED SILT FROM SUCH DEVICES BEFORE NO MORE THAN 60% OF THEIR CAPACITY IS LOST. ALL THE SILT REMOVED SHALL BE DISPOSED OF AS DIRECTED BY THE SUPERINTENDENT. (NO SILT SHALL BE PLACED OUTSIDE THE LIMITS OF WORKS) THE PERIOD FOR MAINTAINING THESE DEVICES SHALL BE AT LEAST LINTIL ALL DISTLIBED AREAS ARE REVEGETATED AND FURTHER AS MAY BE DIRECTED BY THE SUPERINTENDENT OR COUNCIL

#### SEDIMENT NOTES

- 1. CONSTRUCT SEDIMENT FENCE AS CLOSE AS POSSIBLE AND PARALLEL TO THE CONTOURS OF THE SITE.
- 2. DRIVE 1.5 m LONG STAR PICKETS INTO GROUND Max 3 m Ctrs.
- 3. DIG A 150 mm DEEP TRENCH ALONG THE UPSLOPE LINE OF THE FENCE FOR THE BOTTOM OF THE FABRIC TO
- ENTRENCHED.
- 4. BACKELL TRENCH OVER BASE OF FABRIC.
- 5. FIX SELF SUPPORTING GEOTEXILE TO UPSLOPE SIDE OF POSTS WITH WIRE TIES OR AS RECOMMENDED BY GEOTEXILE MANUFACTURER.
- 6. JOIN SECTIONS OF FABRIC AT A SUPPORT POST WITH A Min LAP OF 150 mm.
- \*THIS DRAWING SHALL BE READ IN CONJUNCTION WITH THE FOLLOWING:
- 1-ARCHITECTURAL PLANS 2-CONTOUR AND DETAIL SURVEY



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NOTE
The Builder shall check all dimensions and levels on site prior to construction. Notify any errors, discrepancies or omissions to the building designer. Refer to written dimensions only. Do not scale drawings. Drawings shall not be used for construction purposes until issued for construction. This drawing reflects a design by Innovative Eco Designs and is to be used only for work when authorised in writing by Innovative Eco Designs.

All boundaries and contours are subject to survey drawing. All levels to Australian Height Data. It is the contractors responsibility to confirm all measurements on site d locations of any services prior to work on site.



1:200

Sediment Control Plan





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	27/03/2025	Changes as per Council Letter
Α	24/01/25	Issue for DA



DRAWING: Sediment Control Plan CLIENT: Skymark Luxury Living Pty Ltd PROJECT: DOUBLE STOREY DWELLING

Lot-10 D.P 271326

#10,Raven circuit,Warriewood

DRAWN BY: DATE: 27/03/2025 GS SCALE: 1:200 PAGE SIZE

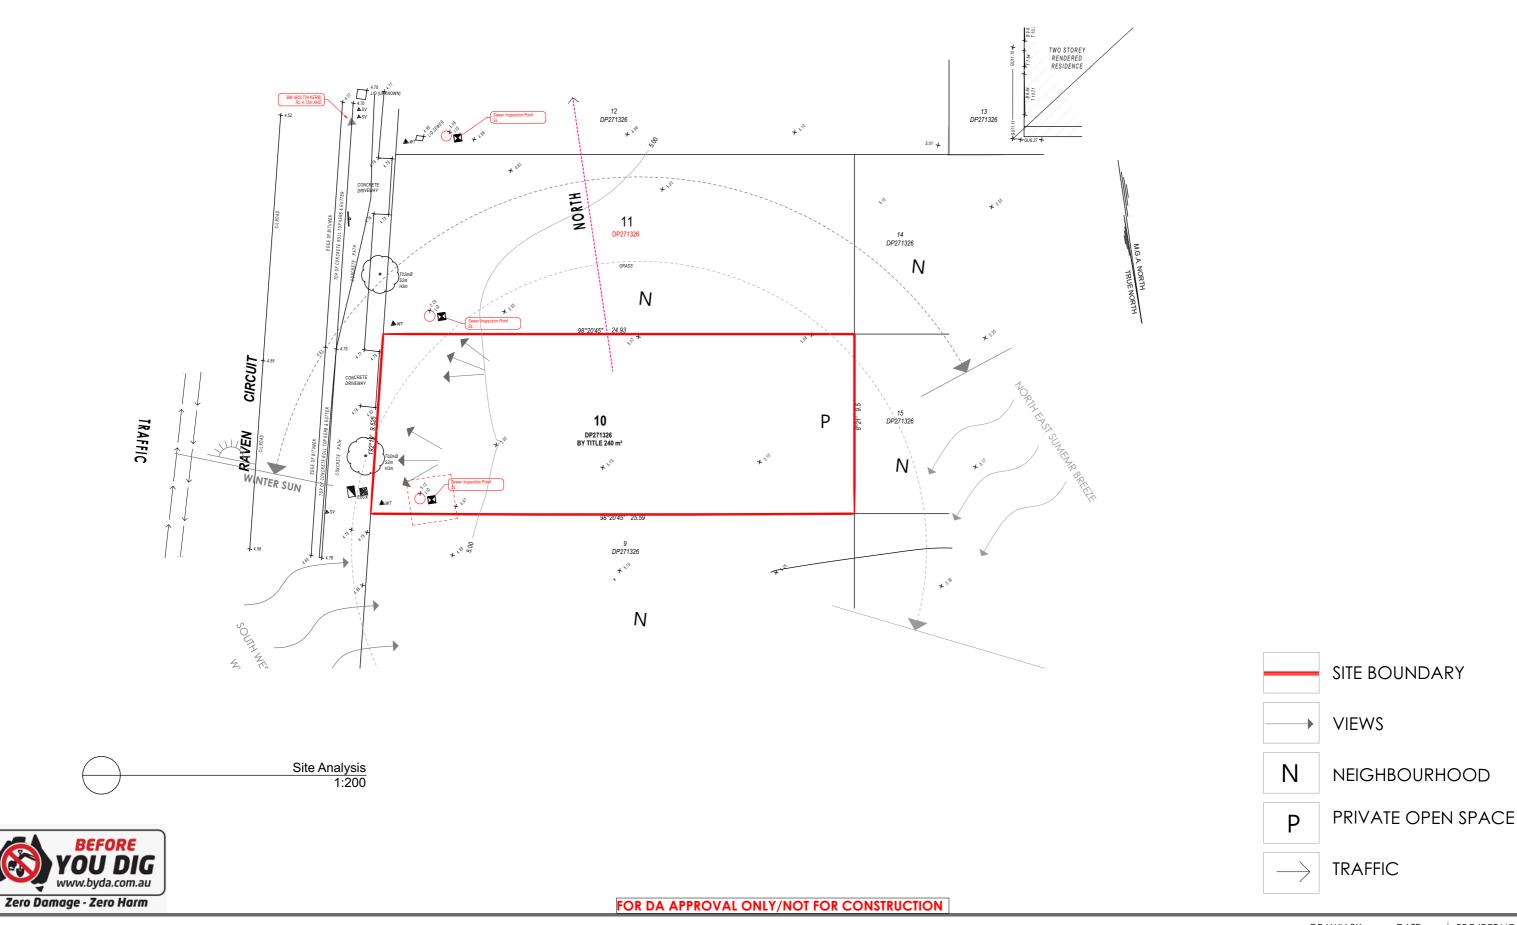
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PROJECT NO. 2411 791 **ISSUE** 

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APPLICATION DA PAGE NO:

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All boundaries and contours are subject to survey drawing. All levels to Australian Height Data. It is the contractors responsibility to confirm all measurements on site and locations of any services prior to work on site.



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ו	Α	24/01/25	Issue for DA
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DRAWING : Site Analysis

CLIENT: Skymark Luxury Living Pty Ltd PROJECT: DOUBLE STOREY DWELLING #10,Raven circuit,Warriewood

Lot-10 D.P 271326

DRAWN BY: GS SCALE: 1:200 PAGE SIZE

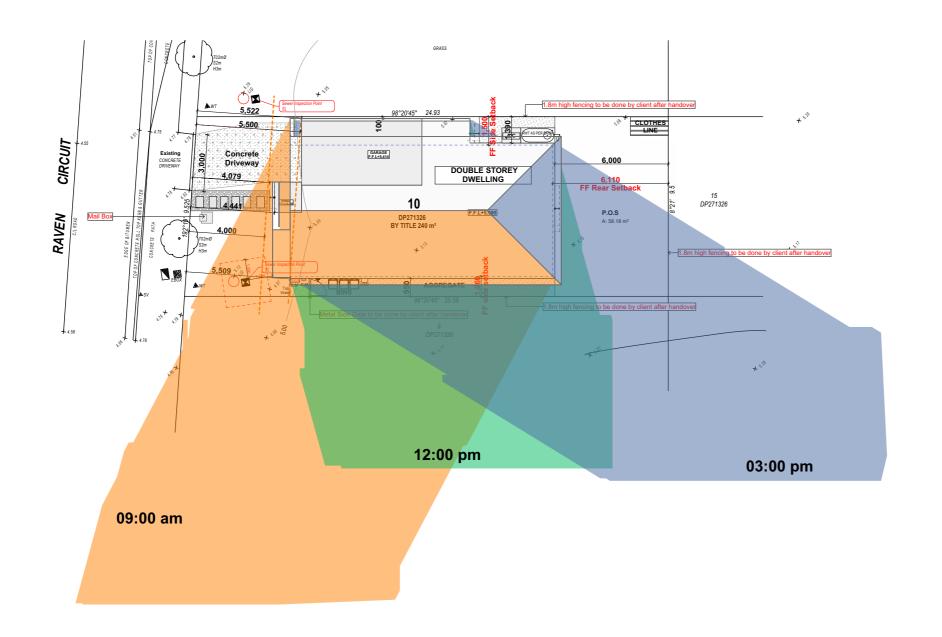
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DATE: PROJECT NO. 27/03/2025 2411 791 APPLICATION DA PAGE NO:

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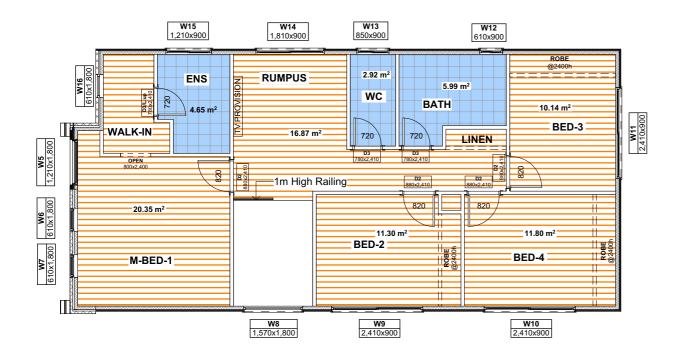
DRAWING	Shadow Analysis
CLIENT:	Skymark Luxury Living Pty Ltd
PROJECT :	DOUBLE STOREY DWELLING
	#10 Payen circuit Warriewood

Lot-10 D.P 271326

DRAWN BY:	DATE:	
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PROJECT NO. 2411 791

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Floor Finish- First Floor 1:100

3.96 m<sup>2</sup> 20.08 m<sup>2</sup> STROAGE L'DRY GARAGE F.F.L+5,414 OPEN 900x2,400 KITCHEN PANTRY 820 D2 880x2,410 67.95 m<sup>2</sup> 2.35 m<sup>2</sup> **SD5** 4,210x2,400 PORCH E 720 / DINING BATH LOUNGE 4.80 m<sup>2</sup> FAMILY **W4** 1,810x2,100 **W3** 850x600

Floor Flnish- Ground Floor 1:100



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A	24/01/25	Issue for DA



DRAWING : Floor Finish	DR
CLIENT: Skymark Luxury Living Pty Ltd	
PROJECT: DOUBLE STOREY DWELLING	1
#10,Raven circuit,Warriewood	PA

Lot-10 D.P 271326

DRAWN BY:	DATE:	Tile for wet area Timber finish PROJECT NO.
GS	27/03/2025	2411 791

Ref.img Name

| DATE : | PROJECT NO | PROJECT

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