

ACTION PLANS

m: 0426 957 518 e: operations@actionplans.com.au w: www.actionplans.com.au

DEVELOPMENT APPLICATION

These plans are for Development Approval only.

ITEM DETAILS	DEVELOPMENT APPLICATION									
ADDRESS	36 KARINA CRESCENT, BELROSE NSW 2085									
LOT & DP/SP	LOT 15 DP 221112									
COUNCIL	NORTHERN BEACHS COUNCIL (WARRINGAH)									
SITE AREA	696.8m ²									
FRONTAGE	18.29m									
CONTROLS	PERMISSIBLE / REQUIRED	EXISTING	PROPOSED	COMPLIANCE						
CONTROLS	m / m² / %	m / m² / %	m / m² / %							
<u>LEP</u>										
LAND ZONING	R2 – LOW DENSITY RESIDENTIAL	R2	R2	YES						
MINIMUM LOT SIZE	600m ²	696.8m ²	UNCHANGED	YES						
FLOOR SPACE RATIO	NOT IDENTIFEID	N/A	N/A	N/A						
MAXIMUM BUILDING HEIGHT	8.5m	7.740m	UNCHANGED	YES						
HAZARDS										
DEVELOPMENT ON SLOPING LAND	IDENTIFEID – AREA B FLANKING SLOPES 5° TO 25°	N/A	N/A	N/A						
BUSHFIRE PRONE LAND	IDENTIFEID – VEGATATION BUFFER	N/A	N/A	N/A						
DCP										
WALL HEIGHT	7.2m	5.8m	UNCHANGED	YES						
NUMBER OF STOREYS	2	2	UNCHANGED	YES						
SIDE BOUNDARY ENVELOPE	4m@45°	N/A	UNCHANGED	YES						
SIDE BOUNDARY SETBACKS	0.9m	N: 1.5m S: 1.36m	UNCHANGED	YES						
SIDE SETBACKS (DECK)	0.9m	S: 0.627m	S: 0.9m	YES						
FRONT BOUNDARY SETBACK	6.5m	9.683m	UNCHANGED	YES						
REAR BOUNDARY SETBACK	6.0m	14.97m	UNCHANGED	YES						
REAR SETBACK (POOL DECK)	N/A	N/A	5.295m	YES						
LANDSCAPE OPEN SPACE	40% (278.72m ²)	52.4% (365.23m ²)	47.5% (331.51m ²)	YES						


SHEET NUMBER	SH	EET NAME	DATE PUBLISHED
DA00	COVER		24/10/2019
DA01	SITE ANALYSIS		24/10/2019
DA02	SITE / ROOF / SEDIMENT EROSION / WASTE MANAGEMENT / STORMWATER CONC	EPT PLAN	24/10/2019
DA03	EXISTING GROUND FLOOR PLAN		24/10/2019
DA04	EXISTING FIRST FLOOR PLAN		24/10/2019
DA05	PROPOSED GROUND FLOOR PLAN		24/10/2019
DA06	PROPOSED FIRST FLOOR PLAN		24/10/2019
DA07	NORTH ELEVATION		24/10/2019
DA08	EAST ELEVATION		24/10/2019
DA09	SOUTH ELEVATION		24/10/2019
DA10	WEST ELEVATION		24/10/2019
DA11	CROSS SECTION		24/10/2019
DA12	LONG SECTION		24/10/2019
DA13	AREA CALCULATIONS / SAMPLE BOARD		24/10/2019
DA14	WINTER SOLSTICE 9 AM		24/10/2019
DA15	WINTER SOLSTICE 12 PM		24/10/2019
DA16	WINTER SOLSTICE 3 PM		24/10/2019
DA17	BASIX COMMITMENTS		24/10/2019

36 KARINA CRESCENT BELROSE NSW 2085





- EARTHWORKS: METHOD OF EXCAVATION AND FILL - PART 3.1.1 OF NCC - SURFACE SUBSOIL-STORMWATER DRAINAGE - PART 3.1.2 OF NCC - TERMITE-RISK MANAGEMENT - PART 3.1.3 OF NCC - FOOTINGS & SLAB - PART 3.2 OF NCC INCLUDING AS2870 - MASONRY CONSTRUCTION - PART 3.3 OF NCC INCLUDING AS3700 - SUB FLOOR VENTILATION - PART 3.4.1 OF NCC - FRAMING - PART 3.4 OF NCC - ROOF, WALL-CLADDING, GUTTERS & DOWNPIPES - PART 3.5 OF NCC - GLAZING - PART 3.6 OF NCC INCLUDING AS1288 - FIRE SEPARATION - PART 3.7.1 OF NCC - SMOKE ALARMS - PART 3.7.2 OF NCC - HEATING APPLIANCES - PART 3.7.3 OF NCC - WET AREAS-PROTECTION OF WALLS & FLOORS - PART 3.8.1 OF NCC - MINIMUM ROOF HEIGHTS - PART 3.8.3 OF NCC - FACILITIES REQUIRRED & SANITARY DOOR CONSTRUCTION - PART 3.8.3 OF NCC - LIGHT: NATURAL AND ARTIFICIAL - PART 3.8.4 OF NCC - VENTILATION & LOCATION OF TOILETS - PART 3.8.5 OF NCC - SOUND INSULATION - PART 3.8.6 OF NCC - STAIR CONSTRUCTION INCLUDING DIMENSIONS - PART 3.9.1 OF NCC - BALUSTRADES & OTHER BARRIERS - PART 3.9.2 OF NCC - FENCING & OTHER PROVISIONS - REGS & AS1926 - DEMOLITION WORKS - AS2601-1991 THE DEMOLITION OF STRUCTURES. - ALL WATERPROOF MEMBRANES TO COMPLY WITH WITH AS 3740-2004 - ALL PLUMBING & DRAINAGE WORK TO COMPLY WITH AS 3500 - SITE CLASSIFICATION AS TO AS 2870 - ALL PLASTERBOARD WORK TO COMPLY WITH AS 2588-1998 - ALL STRUCTURAL STEEL WORK TO COMPLY WITH AS 4100 & AS 1554 - ALL CONCRETE WORK TO COMPLY WITH AS 3600 - ALL ROOF SHEETING WORK TO COMPLY WITH AS 1562-1992 - ALL SKYLIGHTS TO COMPLY WITH WITH AS 4285-2007 - ALL CERAMIC TILING TO COMPLY WITH AS 3958.1-2007 & 3958.2-1992 - ALL GLAZING ASSEMBLIES TO COMPLY WITH AS2047 & 1288 - ALL TIMBER RETAINING WALLS ARE TO COMPLY WITH AS 1720.1-2010, AS 1720.2-2006, AS 1720.4-2006, AS 1170.1-1989 & AS 1170.4-1993 - ALL RETAINING WALLS ARE TO COMPLY WITH 3700 - 2011 & AS 3600 - 2001 - ALL CONSTRUCTION TO COMPLY TO AS3959- 1991

NCC & AS COMPLIANCES SPECIFICATIONS

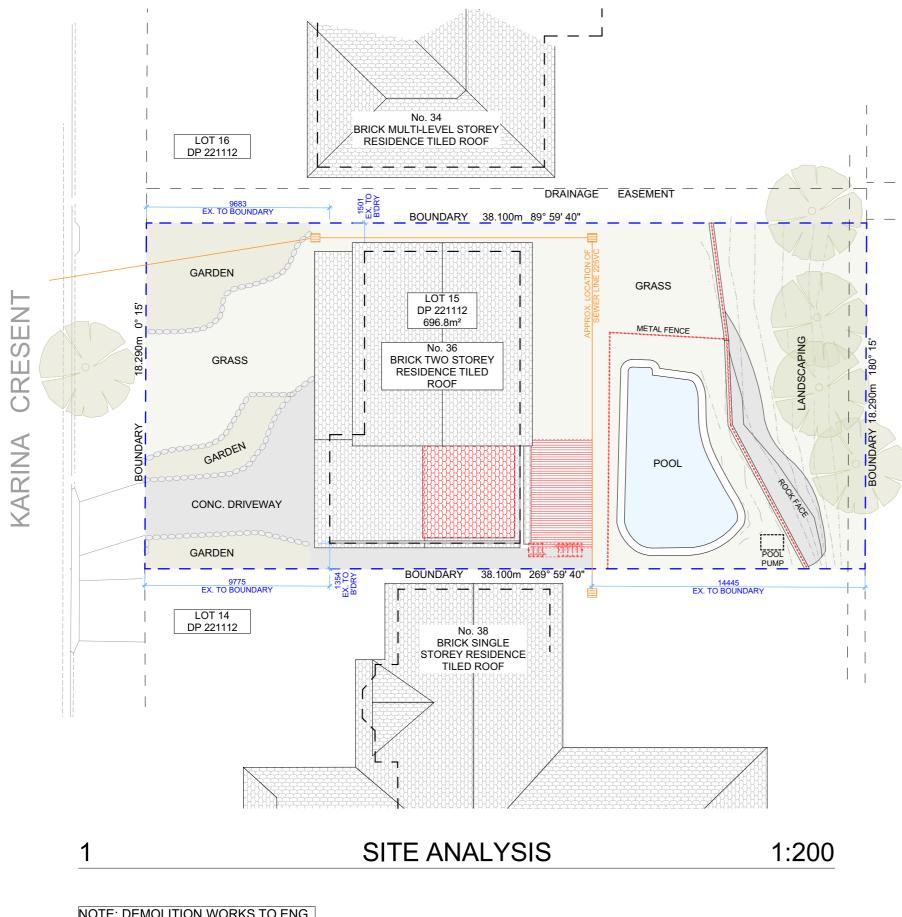



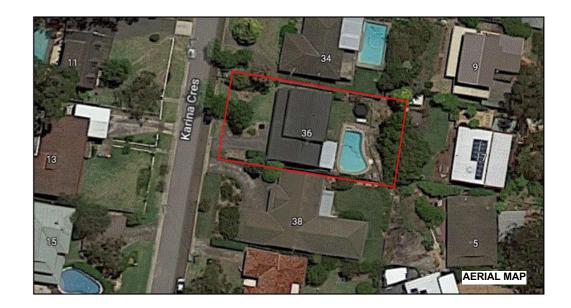

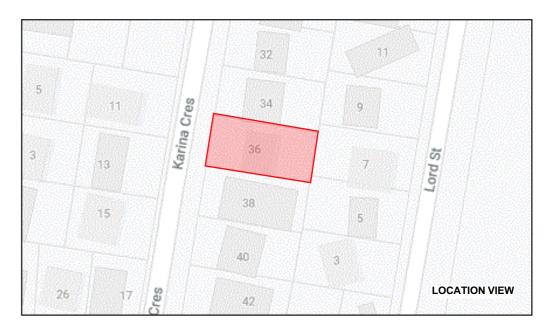


NOTE: DEMOLITION WORKS TO ENG. SPECIFICATIONS & AS 2601 - 2001

ACTION PLANS m: 0426 957 518 e:operations@actionplans.com.au w: www.actionplans.com.au	REV. DAT	E COMMENTS	DRWN	he copyright of Action Plans and not be	CLIENT	DRAWING NO
	A 05/06	19 INITIAL DESIGN PLAN	AM	ed or transmitted in any form or by any in whole with the written permission of EXISTING	NATALIE & MARJAN	DA01
	B 28/06	19 DESIGN AMENDMENT	AM	asure from drawings. Figured dimensions	NOVOTNI	DAUI
	C 30/08	19 DESIGN AMENDMENT	AM	ly. ractor shall check and verify all levels and DEMOLISHED	PROJECT ADDRESS	DATE
	D 24/09	19 DA DOCUMENTATION	JN	ite prior to commencement of any work, drawings, or fabrication of components.	36 KARINA CRESCENT	Thursday, 24 (
				omissions are to be verified by the r and referred to the designer prior to the	BELROSE NSW 2085	2019
	w: www.actionplans.com.au				omissions are to be verified by the	




ING NO.

DRAWING NAME SITE ANALYSIS

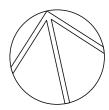

day, 24 October

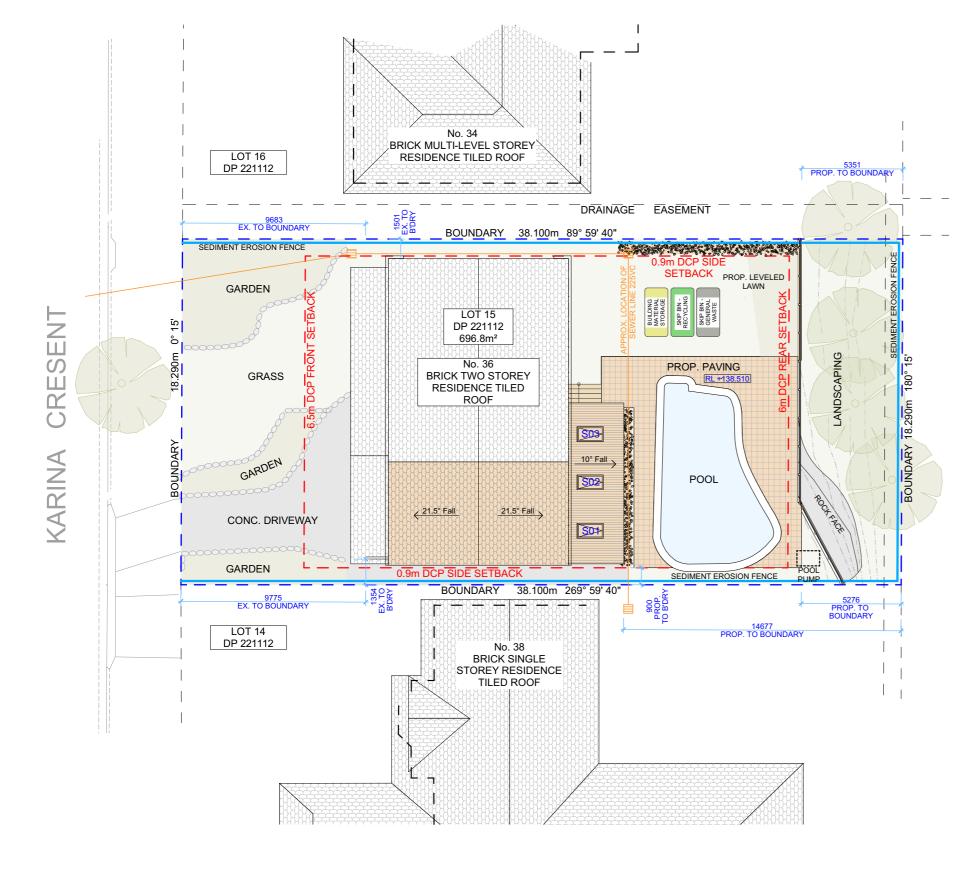

This is a **summary** of the **minimum** specifications in 'Planning for Bushfire Protection 2006' as amended in 2010 and 'AS 3959 2009 – Construction of buildings in bushfire-prone areas' which are recommended in this report. It is included as a courtesy, is a guide only, and may not be complete. In addition, the contents of the documents from which this information was extracted may have changed between the dates o preparation of this report, and its use or application. Specifications in other documents such as the Building Code of Australia (BCA) may apply. It is the user's responsibility to comply with all statutory conditions as well as those specified by the approving authority with particular reference to this report. The appropriate source documents should be consulted to determine the full specifications abbreviated in this table.

		E
Floor	Slab OK	
	Timber <400mm ag	
	Timber >400mm ag	
Floor posts		
External walls		
Windows	Frame	
	Screens	,
External doors	Sliding	Sa
	Screens	
	Timber frames	
	Garage	Lov
Vents etc	Mesh	
Roofs	Tiled	
	Sheeted Non	
	Rooflights	
Verandahs, decks etc	Enclosed	
	Unenclosed	
	<300mm to glass	30
Services	L L	
Ag Above ground	FRT Fire R	esistant


GUTTER PROTECTION :

PROVIDE PROTECTION TO DOWNHILL GR GUTTER BY MEANS OF SAND BAGS OR BI WRAPPED IN GEOTEXTILE FABRIC. WHEN SAND BUILDS UP AROUND THIS SEDIMEN THE MATERIAL SHOULD BE RELOCATED E SITE FOR DISPOSAL.

DUST CONTROL :

TO REDUCE DUST GENERATED BY WIND A REMOVAL OF THE TOP SOIL IS TO BE MINI PREVENT DUST GENERATION, WATERING THE SITE, ESPECIALLY DURING THE MOVE MACHINERY IS REQUIRED. WHERE EXCAN ROCK, KEEP THE SURFACE MOIST TO MIN CONSTRUCT A GRAVEL ENTRY/EXIT POINT METAL AND RESTRICT ALL VEHICLE MOVE WITHIN THE SITE TO A MINIMUM. ENSURE BREAKS, SUCH AS EXISTING FENCES ARE DURING THE CONSTRUCTION PHASE UNT LANDSCAPING IS PROVIDED OR REINSTA PREVENT DUST BY COVERING STOCKPILE

PROPOSED STORMWATER TO CO WITH EXISTING STORMWATER SY

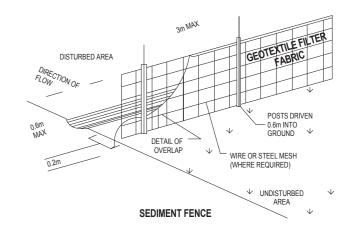

SITE / ROOF / SEDIMENT EROSION / WASTE MANAGEMENT PLAN 1:200

		REV.	DATE	COMMENTS	DRWN	NOTES This drawing is the copyright of Action Plans and not be	CLIENT	DRAWING
	ACTION PLANS m: 0426 957 518	А	05/06/19	INITIAL DESIGN PLAN		altered, reproduced or transmitted in any form or by any means in part or in whole with the written permission of EXISTING	NATALIE & MARJAN	DA02
		в	28/06/19	DESIGN AMENDMENT	AM	Action Plans. Do not scale measure from drawings. Figured dimensions PROPOSED PROPOSED	NOVOTNI	
		с	30/08/19	DESIGN AMENDMENT	AM	The Builder/Contractor shall check and verify all levels and	PROJECT ADDRESS	DATE
	e:operations@actionplans.com.au w: www.actionplans.com.au	D	24/09/19	DA DOCUMENTATION		dimensions on site prior to commencement of any work, creation of shop drawings, or fabrication of components.	36 KARINA CRESCENT	Thursday, 2
						All errors and omissions are to be verified by the Builder/Contractor and referred to the designer prior to the commencement of works.	BELROSE NSW 2085	2019

BAL-12.5	BAL-19	BAL-29	BAL-40					
	RT or lined or enclos	bes	Non-combustible or					
r	OK	seu	FRT or enclosed					
	FRT or enclosed		Enclosed or non-					
	TTT OF CHOIDSEU		combustible					
400mm FRT or non-	comhustible	FRT or non-combustible	Non-combustible					
	FRT or metal		Metal					
Al, Fe or Br mesh on		Fe or Br mesh on all	Fe or Br mesh on all.					
u, i o o. Di moon on		openable, 5mm toughened	6mm toughened glass,					
		glass, or shutters	or shutters					
afety glass	5mm toughened	6mm toughened glass or	6mm toughened glass					
	glass	full mesh	plus full mesh or shutter					
	Al, Fe or Br, if fitted		Fe or Br					
	FRT	-	Metal only					
ver 400mm FRT or n		FRT or non-combustible	Non-combustible					
	AI, Fe or Br mesh 2m		Fe or Br mesh 2mm					
		Flammability Index <5)						
		sarked (Flammability Index <5	5)					
Non-combust	ible sleeve/lining, 4n		FRL -/30/-					
		F or non-combustible	Any supports, unspaced					
,,			deck, non-combustible					
FRT or non-	-combustible, <3mm	spaced deck	All non-combustible,					
			unspaced deck					
0mm wide FRT or no	FRT or non-combustible	Non-combustible						
		er & gas pipes to metal						
Timber Al Al	uminium Fe	Stainless steel Br	Bronze					
ATE IN LUE METAL I SOIL OR T BARRIER, BACK TO THE MISED. TO DOWN OF EMENT OF VATING INTO	TO BE INSPE MANAGER. 2. MINIMISE I FROM EXCAV 3. ALL MATEF DRAINS, GUT SEDIMENT FI 4. DRAINAGE SOON AS PO FILTERED BE	 ALL EROSION AND SEDIMENT CONTROL MEASURES TO BE INSPECTED AND MAINTAINED DAILY BY THE SITI MANAGER. MINIMISE DISTURBED AREAS, REMOVE EXCESS SOI FROM EXCAVATEDAREA AS SOON AS POSSIBLE. ALL MATERIAL STOCKPILE TO BE CLEAR FROM DRAINS, GUTTERS AND FOOTPATHS, OR WITHIN SEDIMENT FENCE AREA. DRAINAGE TO BE CONNECTED TO STORMWATER AS SOON AS POSSIBLE. IF STORED ON SITE, IT MUST BE FILTERED BEFORE RELEASING INTO STORMWATER SYSTEM OR WATERWAYS. 						
NIMISE DUST. T USING BLUE	STOCKPILES	:						
EMENTS E WIND E MAINTAINED TIL NEW ITED. ES NNECT STEM	POSSIBLE. A FOOTPATHS PERMISSION ALL STOCKPI DRAINAGE LI TO LOCATE T SITE IF POSS OVER STOCK	LES ARE TO BE PLAC NES AND STREET GU THESE ON THE HIGHE BIBLE. PLACE WATERF (PILES. PROVIDE DIVERSION	ED ON THE REQUIRE COUNCIL'S ED AWAY FROM THE TTERS. IT IS BEST ST PART OF THE PROOF COVERING					
STEM	OVER STOCK	PILES. PROVIDE DIVERSION						

NG NO.

DRAWING NAME


)2


SITE / ROOF / SEDIMENT EROSION / WASTE MANAGEMENT / STORMWATER CONCEPT PLAN

ay, 24 October

SCALE

1:200, 1:1.63 @A3

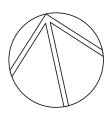

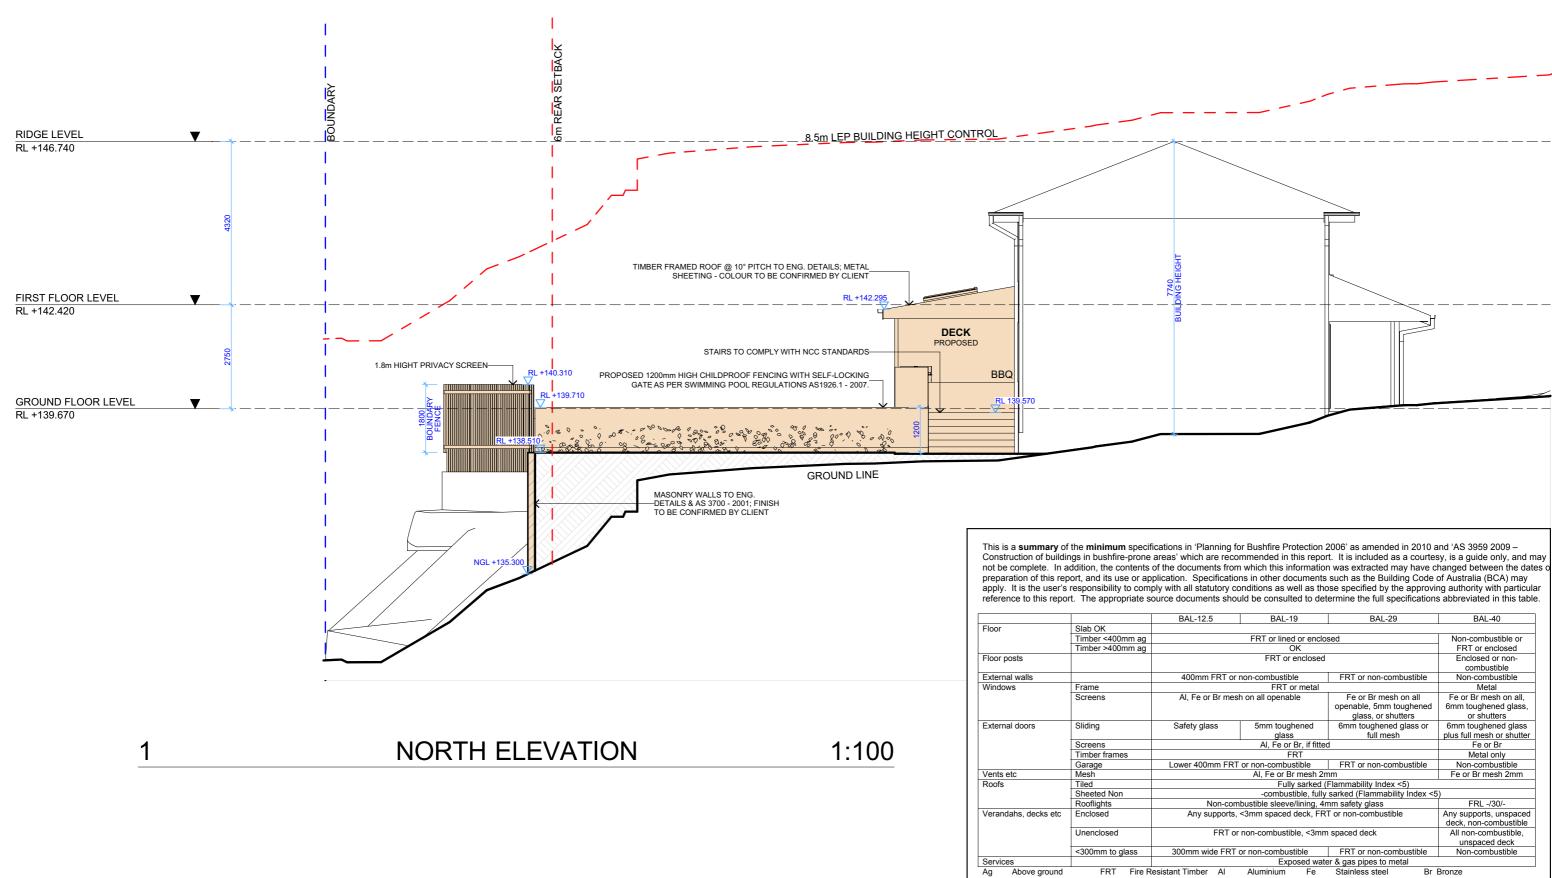

	REV.	DATE	COMMENTS	DRWN	NOTES This drawing is the copyright of Action Plans and not be	LEGEND	CLIENT	DRAWING NO
▲ ACTION PLANS	A	05/06/19	INITIAL DESIGN PLAN	AM	altered, reproduced or transmitted in any form or by any means in part or in whole with the written permission of	transmitted in any form or by any hole with the written permission of from drawings. Figured dimensions	NATALIE & MARJAN NOVOTNI	DA07
H .	В	28/06/19	DESIGN AMENDMENT	AM	Action Plans. Do not scale measure from drawings. Figured dimensions			
□■ m: 0426 957 518	С	30/08/19	DESIGN AMENDMENT	АМ	e to be used only. ne Builder/Contractor shall check and verify all levels and		PROJECT ADDRESS	DATE
e:operations@actionplans.com.au	J D	24/09/19	DA DOCUMENTATION	JN	dimensions on site prior to commencement of any work, creation of shop drawings, or fabrication of components.		36 KARINA CRESCENT	Thursday, 24 (
					All errors and omissions are to be verified by the Builder/Contractor and referred to the designer prior to the		BELROSE NSW 2085	2019

IG NO.


DRAWING NAME

NORTH ELEVATION

, 24 October

SCALE 1:100, 1:1.63 @A3

Br Bronze Aluminium Fe Stainless steel

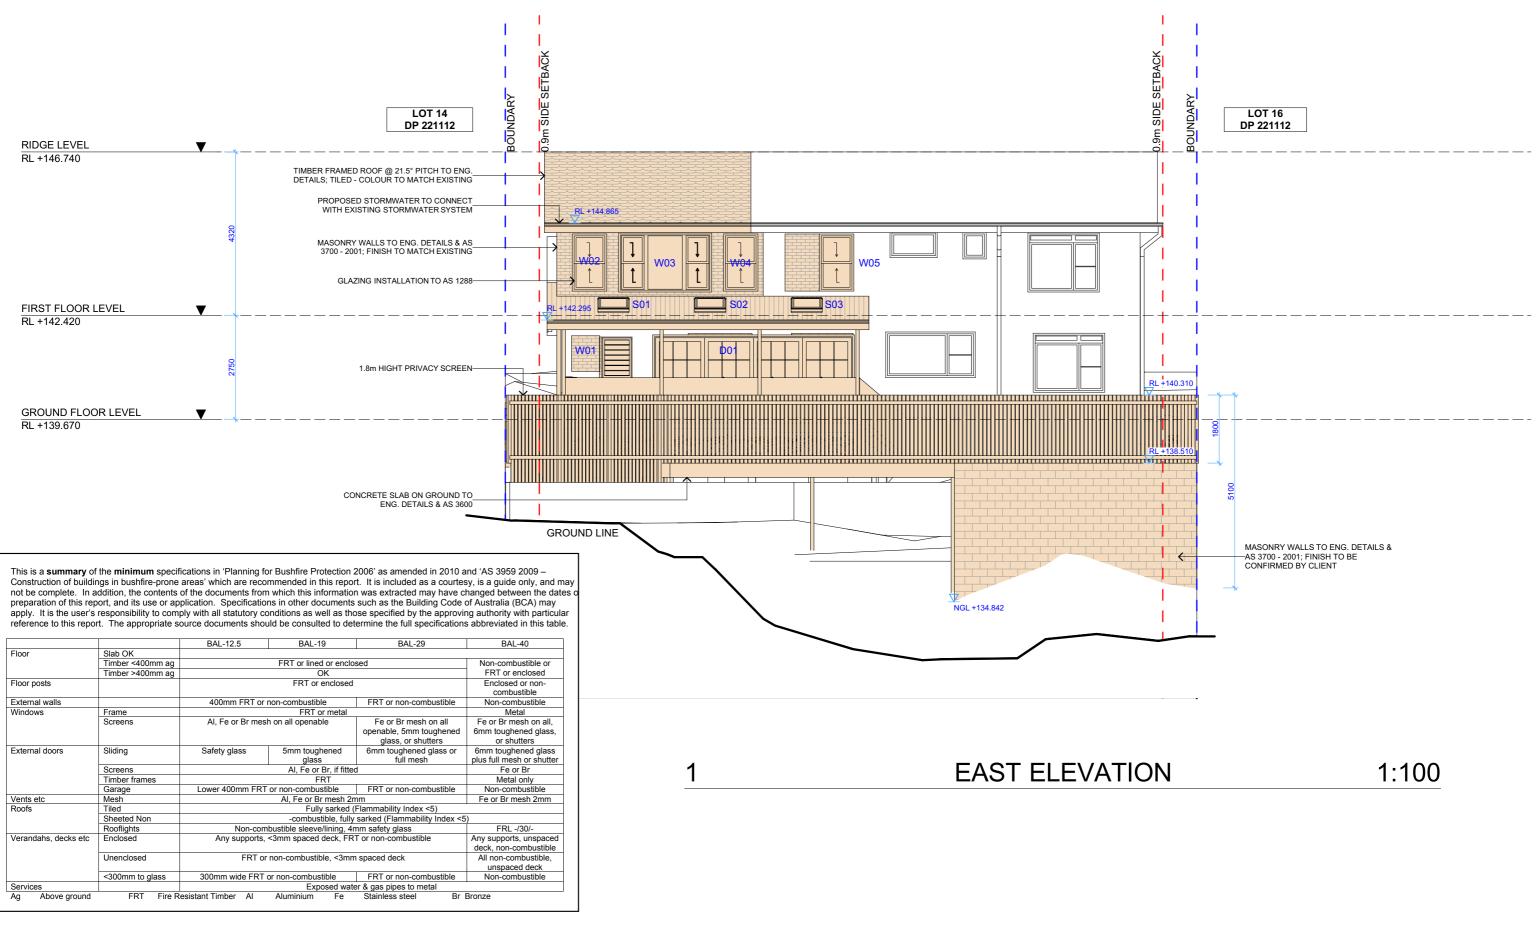


			REV.	DATE	COMMENTS	DRWN	NOTES This drawing is the copyright of Action Plans and not be	LEGEND	CLIENT	DRAWING NO
ACTION PL	ACTION PLANS	A	05/06/19	INITIAL DESIGN PLAN	AM	altered, reproduced or transmitted in any form or by any means in part or in whole with the written permission of		NATALIE & MARJAN	DA08	
t		· · · · · · · · · · · · · · · · · · ·	В	28/06/19	DESIGN AMENDMENT	AM	Action Plans. Do not scale measure from drawings. Figured dimensions	NO'	NOVOTNI	DAUO
□■ m: 0426 99 e:operation	m: 0426 957 518	с	30/08/19	DESIGN AMENDMENT	АМ	are to be used only. The Builder/Contractor shall check and verify all levels and		PROJECT ADDRESS	DATE	
	e:operations@actionplans.com.au w: www.actionplans.com.au	D	24/09/19	DA DOCUMENTATION	JN	dimensions on site prior to commencement of any work, creation of shop drawings, or fabrication of components.		36 KARINA CRESCENT	Thursday, 24 0	
		··· ····					All errors and omissions are to be verified by the Builder/Contractor and referred to the designer prior to the		BELROSE NSW 2085	2019
			•				commencement of works.			

WING NO.

DRAWING NAME EAST ELEVATION

rsday, 24 October

SCALE 1:100, 1:1.63 @A3

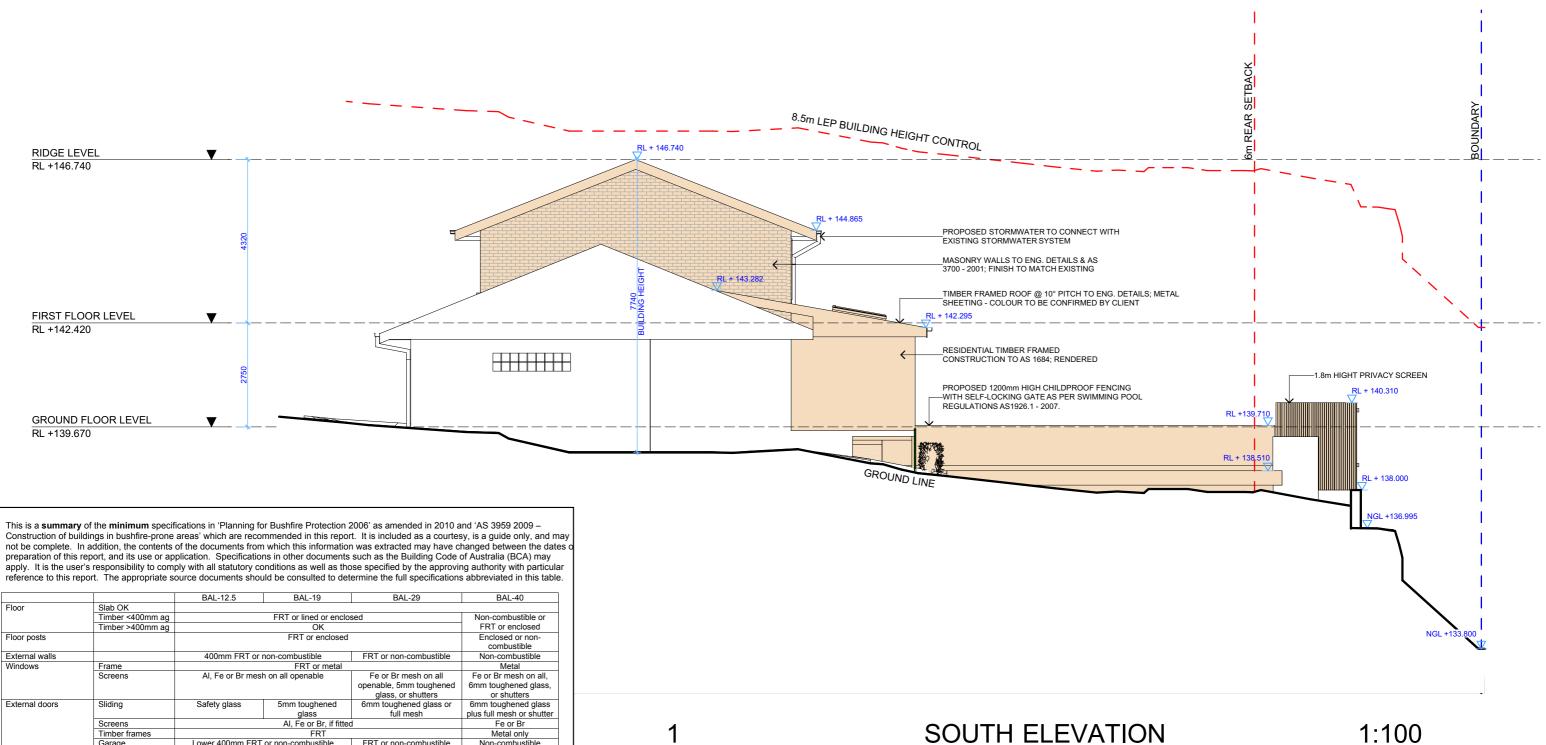

		DAL-12.0	DAL-13	DAL-23	DAL-40		
Floor	Slab OK		•	·	•		
	Timber <400mm ag		FRT or lined or enclo	osed	Non-combustible or		
	Timber >400mm ag		OK		FRT or enclosed		
Floor posts			FRT or enclosed				
External walls		400mm FRT or	non-combustible	FRT or non-combustible	Non-combustible		
Windows	Frame		FRT or metal	·	Metal		
	Screens	Al, Fe or Br mes	h on all openable	Fe or Br mesh on all openable, 5mm toughened glass, or shutters	Fe or Br mesh on all, 6mm toughened glass, or shutters		
External doors	Sliding	Safety glass	5mm toughened glass	6mm toughened glass or full mesh	6mm toughened glass plus full mesh or shutter		
	Screens		Al, Fe or Br, if fitte	d	Fe or Br		
	Timber frames		Metal only				
	Garage	Lower 400mm FRT	or non-combustible	FRT or non-combustible	Non-combustible		
Vents etc	Mesh		Al, Fe or Br mesh 2r	mm	Fe or Br mesh 2mm		
Roofs	Tiled		Fully sarked ((Flammability Index <5)			
	Sheeted Non		 -combustible, fully 	/ sarked (Flammability Index <5	i)		
	Rooflights	Non-com	bustible sleeve/lining, 4	mm safety glass	FRL -/30/-		
Verandahs, decks etc	Enclosed	Any supports,	<3mm spaced deck, FR	T or non-combustible	Any supports, unspaced deck, non-combustible		
	Unenclosed	FRT or	non-combustible, <3mn	n spaced deck	All non-combustible, unspaced deck		
	<300mm to glass	300mm wide FRT	or non-combustible	FRT or non-combustible	Non-combustible		
Services			Exposed wat	er & gas pipes to metal	·		
Ag Above ground	FRT Fire Re	sistant Timber Al	Aluminium Fe	Stainless steel Br	Bronze		


		REV.	DATE	COMMENTS		NOTES This drawing is the copyright of Action Plans and not be	LEGEND	CLIENT	DRAWING NO
ACTION PLANS m: 0426 957 518 e:operations@actionplans.com.au w: www.actionplans.com.au	ACTION PLANS	А	05/06/19	INITIAL DESIGN PLAN	AM	Hand advantig to use opprogram of related in any form or by any means in part or in whole with the written permission of Action Plans.	EXISTING NATAL NOVOT	NATALIE & MARJAN	DA09
		В	28/06/19	DESIGN AMENDMENT	AM			NOVOTNI	DAUS
		с	30/08/19	DESIGN AMENDMENT	AM	are to be used only. The Builder/Contractor shall check and verify all levels and	DEMOLISHED	PROJECT ADDRESS	DATE
	D	24/09/19	DA DOCUMENTATION		dimensions on site prior to commencement of any work, creation of shop drawings, or fabrication of components.		36 KARINA CRESCENT	Thursday, 24	
						All errors and omissions are to be verified by the Builder/Contractor and referred to the designer prior to the commencement of works.		BELROSE NSW 2085	2019

ING NO.

DRAWING NAME SOUTH ELEVATION

day, 24 October

SCALE 1:100, 1:1.63 @A3

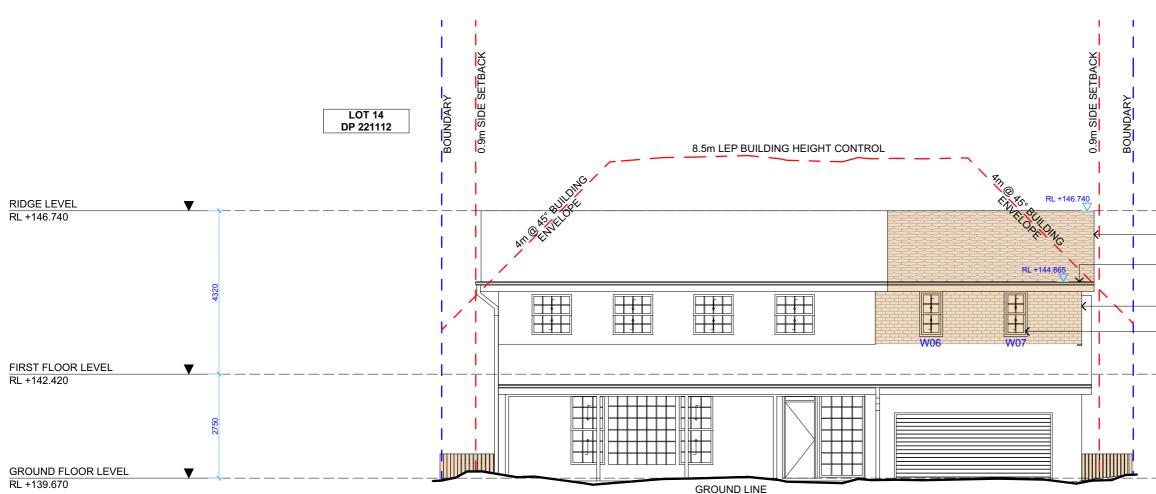

This is a summary of the minimum specifications in 'Planning for Bushfire Protection 2006' as amended in 2010 and 'AS 3959 2009 -Construction of buildings in bushfire-prone areas' which are recommended in this report. It is included as a courtesy, is a guide only, and may not be complete. In addition, the contents of the documents from which this information was extracted may have changed between the dates of preparation of this report, and its use or application. Specifications in other documents such as the Building Code of Australia (BCA) may apply. It is the user's responsibility to comply with all statutory conditions as well as those specified by the approving authority with particular reference to this report. The appropriate source documents should be consulted to determine the full specifications abbreviated in this table.

		BAL-12.5	BAL-19	BAL-29	BAL-40
Floor	Slab OK		•		•
	Timber <400mm ag		FRT or lined or enclo	osed	Non-combustible or
	Timber >400mm ag		FRT or enclosed		
Floor posts			FRT or enclosed		Enclosed or non-
					combustible
External walls		400mm FRT or	non-combustible	FRT or non-combustible	Non-combustible
Windows	Frame		FRT or metal		Metal
	Screens	Al, Fe or Br mes	h on all openable	Fe or Br mesh on all	Fe or Br mesh on all,
				openable, 5mm toughened	6mm toughened glass
				glass, or shutters	or shutters
External doors	Sliding	Safety glass	5mm toughened	6mm toughened glass or	6mm toughened glass
			glass	full mesh	plus full mesh or shutte
	Screens		Al, Fe or Br, if fitte	d	Fe or Br
	Timber frames		Metal only		
	Garage	Lower 400mm FRT or non-combustible FRT or non-combustible			Non-combustible
Vents etc	Mesh		Al, Fe or Br mesh 2	mm	Fe or Br mesh 2mm
Roofs	Tiled		Fully sarked	(Flammability Index <5)	
	Sheeted Non)		
	Rooflights	Non-corr	bustible sleeve/lining, 4	mm safety glass	FRL -/30/-
Verandahs, decks etc	Enclosed	Any supports,	<3mm spaced deck, FR	T or non-combustible	Any supports, unspace
					deck, non-combustible
	Unenclosed	FRT or	non-combustible, <3mr	n spaced deck	All non-combustible,
				-	unspaced deck
	<300mm to glass	300mm wide FRT	or non-combustible	FRT or non-combustible	Non-combustible
Services			Exposed wat	er & gas pipes to metal	•
Ag Above ground	FRT Fire Re	sistant Timber Al	Aluminium Fe	Stainless steel Br	Bronze



	REV.	DATE	COMMENTS		NOTES This drawing is the copyright of Action Plans and not be	LEGEND	CLIENT	DRAWING NO
ACTION PLANS	А	05/06/19	INITIAL DESIGN PLAN	AM	altered, reproduced or transmitted in any form or by any means in part or in whole with the written permission of		NATALIE & MARJAN NOVOTNI	DA10
m: 0426 957 518 e:operations@actionplans.com.au w: www.actionplans.com.au	в	28/06/19	DESIGN AMENDMENT	AM	Action Plans. Do not scale measure from drawings. Figured dimensions			
	С	30/08/19	DESIGN AMENDMENT	AM	are to be used only. The Builder/Contractor shall check and verify all levels and		PROJECT ADDRESS	DATE
	D	24/09/19	DA DOCUMENTATION		dimensions on site prior to commencement of any work, creation of shop drawings, or fabrication of components.		36 KARINA CRESCENT	Thursday, 24 (
					Il errors and omissions are to be verified by the uilder/Contractor and referred to the designer prior to the promencement of works		BELROSE NSW 2085	2019

1

	LOT 16 DP 221112
	IBER FRAMED ROOF @ 21.5° PITCH TO ENG. TAILS; TILED - COLOUR TO MATCH EXISTING
	OPOSED STORMWATER TO CONNECT TH EXISTING STORMWATER SYSTEM
	SONRY WALLS TO ENG. DETAILS & AS 30 - 2001; FINISH TO MATCH EXISTING
—-GI	AZING INSTALLATION TO AS 1288

1:100

ING NO.

DRAWING NAME WEST ELEVATION

day, 24 October

SCALE 1:100, 1:1.63 @A3








(1) - GLASS POOL FENCING




(3) - TIMBER DECKING - COLOUR TO BE CONFIRMED BY CLIENT

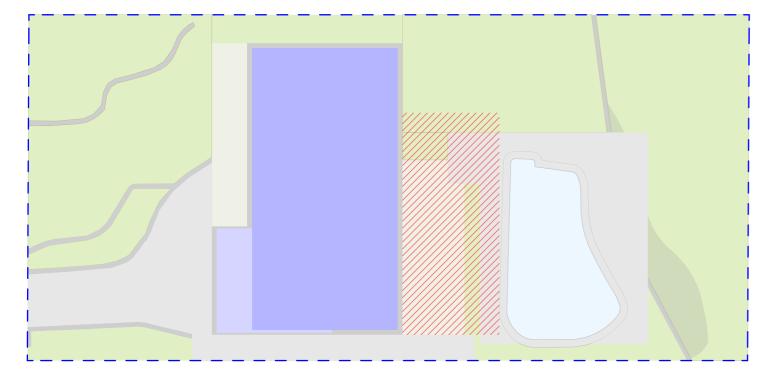

AREA CALCULATION TABLE

SITE AREA : 696.8m ²	REQUIRED	EXISTING	PROPOSED
LANDSCAPED AREA	40% (278.72m ²)	52.4% (365.23m²)	47.5% (331.51m²)
PRIVATE OPEN SPACE	60m ²	60m²	UNCHANGED

		REV.	DATE	COMMENTS	DRWN	NOTES This drawing is the copyright of Action Plans and not be	LEGEND	CLIENT	DRAWING
	ACTION PLANS m: 0426 957 518 e:operations@actionplans.com.au w: www.actionplans.com.au	A	05/06/19	INITIAL DESIGN PLAN	AM	altered, reproduced or transmitted in any form or by any means in part or in whole with the written permission of		NATALIE & MARJAN	DA13
		В	28/06/19	DESIGN AMENDMENT	AM	Action Plans. Do not scale measure from drawings. Figured dimensions	NOVOTNI PROJECT ADDRES	NOVOTNI	DAIJ
		с	30/08/19	DESIGN AMENDMENT	АМ	are to be used only. The Builder/Contractor shall check and verify all levels and		PROJECT ADDRESS	DATE
		D	24/09/19	DA DOCUMENTATION	JN	dimensions on site prior to commencement of any work, creation of shop drawings, or fabrication of components.		36 KARINA CRESCENT	Thursday,
						All errors and omissions are to be verified by the Builder/Contractor and referred to the designer prior to the		BELROSE NSW 2085	2019
						commencement of works.			

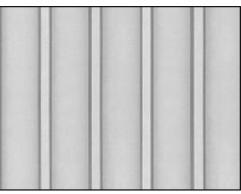

(2) - METAL COLOURBOND ROOFING -COLOUR TO BE CONFIRMED BY CLIENT



(4) - BRICKWORK - COLOUR TO MATCH EXISTING


ING NO. 3


DRAWING NAME

AREA CALCULATIONS / SAMPLE BOARD



1:200 @A3

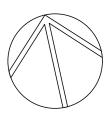

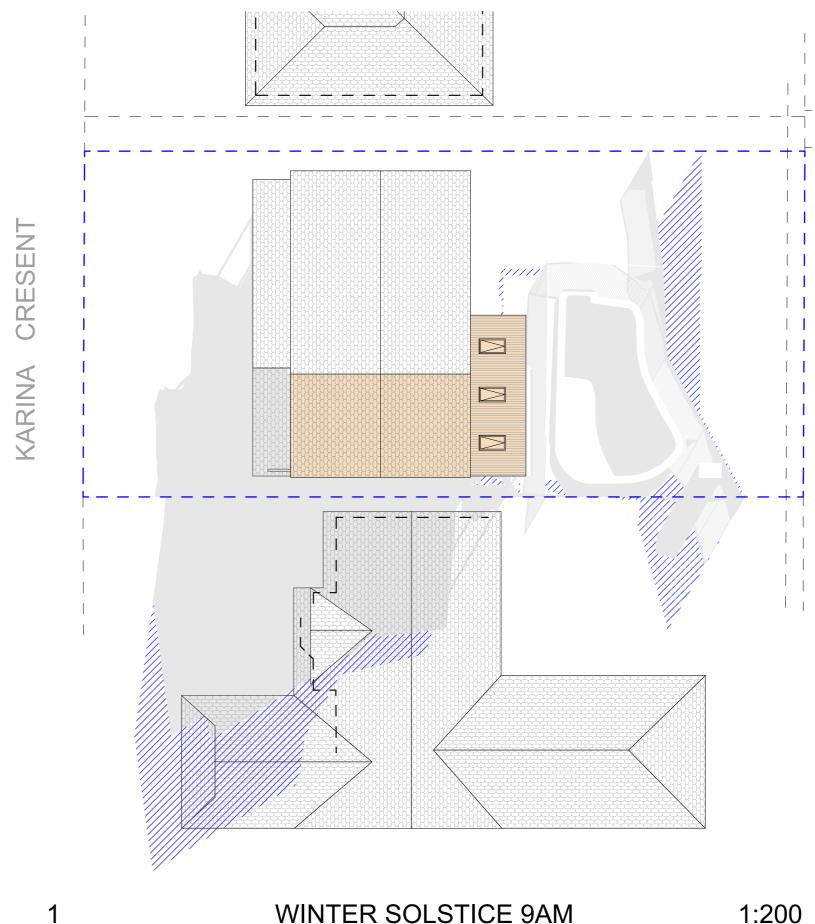

WINTER SOLSTICE 9AM


1:200


		REV.	DATE	COMMENTS	DRWN	NOTES This drawing is the copyright of Action Plans and not be	LEGEND	CLIENT	DRAWING NO
	ACTION PLANS	A	05/06/19	INITIAL DESIGN PLAN	AM	altered, reproduced or transmitted in any form or by any means in part or in whole with the written permission of	EXISTING SHADOWS	NATALIE & MARJAN	DA14
		в	28/06/19	DESIGN AMENDMENT	AM	Action Plans. Do not scale measure from drawings. Figured dimensions	PROPOSED SHADOWS	ΝΟΥΟΤΝΙ	DA14
	m: 0426 957 518	С	30/08/19	DESIGN AMENDMENT	AM	are to be used only. The Builder/Contractor shall check and verify all levels and		PROJECT ADDRESS	DATE
┼╘═╪	e:operations@actionplans.com.au w: www.actionplans.com.au	D	24/09/19	DA DOCUMENTATION	JN	dimensions on site prior to commencement of any work, creation of shop drawings, or fabrication of components.		36 KARINA CRESCENT	Thursday, 24 C
						All errors and omissions are to be verified by the Builder/Contractor and referred to the designer prior to the commencement of works.		BELROSE NSW 2085	2019

AWING NO.

DRAWING NAME WINTER SOLSTICE 9 AM




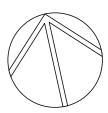

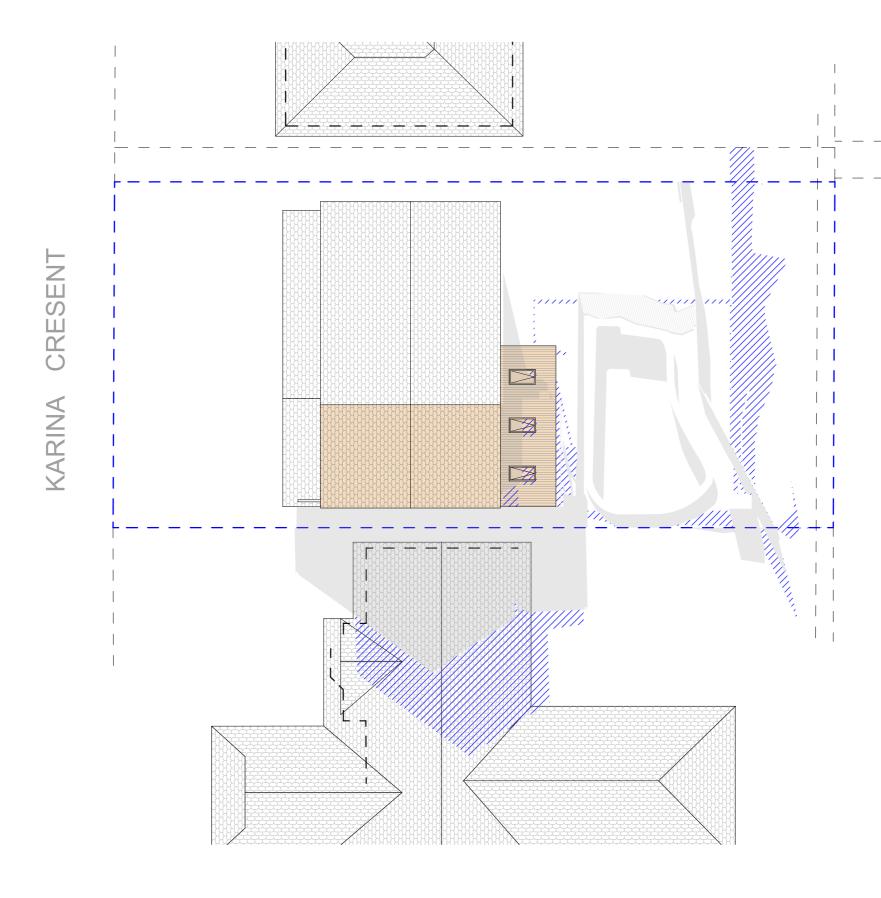

WINTER SOLSTICE 12PM

1:200

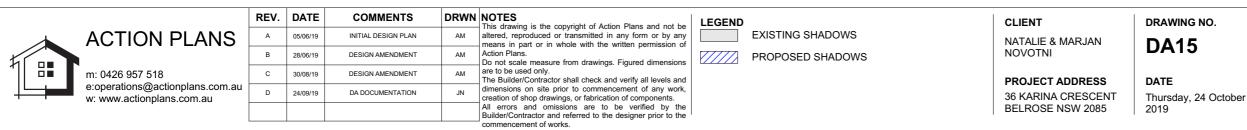


1

DRAWING NAME WINTER SOLSTICE 12 PM





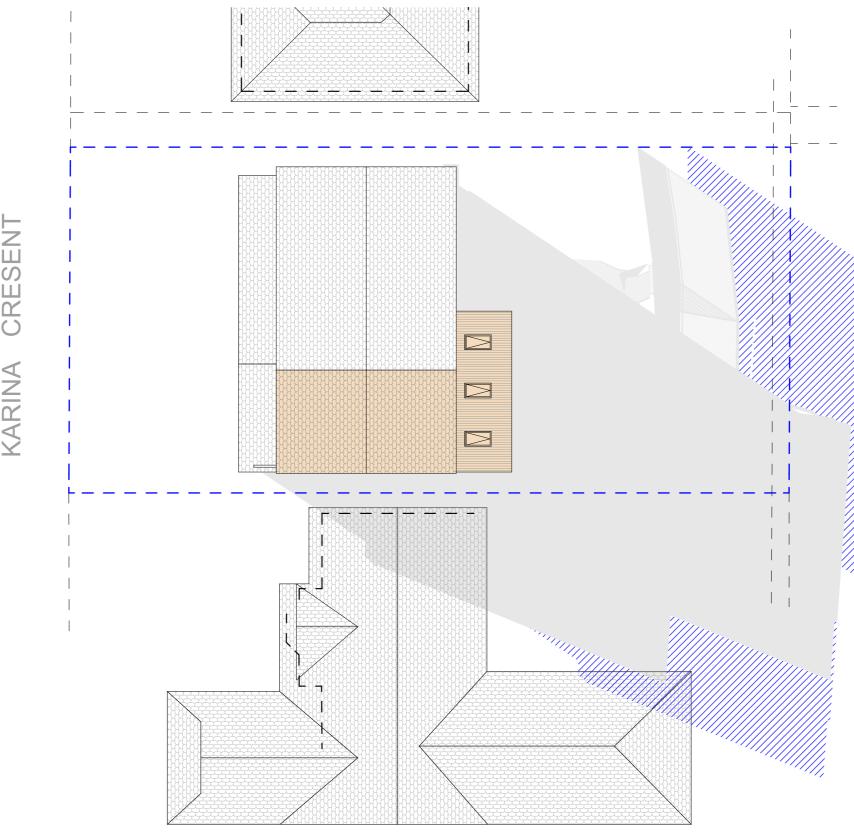

KARINA CRESENT

1

WINTER SOLSTICE 3PM

1:200


		REV.	DATE	COMMENTS	DRWN	NOTES This drawing is the copyright of Action Plans and not be	LEGEND		CLIENT	DRAWI
	ACTION PLANS	A	05/06/19	INITIAL DESIGN PLAN	AM	altered, reproduced or transmitted in any form or by any means in part or in whole with the written permission of	EXISTING SHADOWS	EXISTING SHADOWS	NATALIE & MARJAN	DA1
		в	28/06/19	DESIGN AMENDMENT	AM	Action Plans. Do not scale measure from drawings. Figured dimensions		PROPOSED SHADOWS	NOVOTNI	
	m: 0426 957 518 e:operations@actionplans.com.au w: www.actionplans.com.au	с	30/08/19	DESIGN AMENDMENT	AM	are to be used only. The Builder/Contractor shall check and verify all levels and			PROJECT ADDRESS	DATE
		D	24/09/19	DA DOCUMENTATION	JN	dimensions on site prior to commencement of any work, creation of shop drawings, or fabrication of components.			36 KARINA CRESCENT	Thursda
						All errors and omissions are to be verified by the Builder/Contractor and referred to the designer prior to the commencement of works.			BELROSE NSW 2085	2019



WING NO. 416

DRAWING NAME WINTER SOLSTICE 3 PM



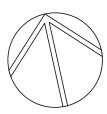

BASIX Certificate

Building Sustainability Index www.basix.nsw.gov.au

Alterations and Additions

Certificate number: A359219

Planning &

Environment

-(Y)-

NSW

This certificate confirms that the proposed development will meet the NSW government's requirements for sustainability, if it is built in accordance with the commitments set out below. Terms used in this certificate, or in the commitments, have the meaning given by the document entitled "BASIX Alterations and Additions Definitions" dated 06/10/2017 published by the Department. This document is available at www.basix.nsw.gov.au

Secretary Date of issue: Tuesday, 24, September 2019 To be valid, this certificate must be lodged within 3 months of the date of issue.

	5	Street address	36 Karina Crescent Belrose 2085
	ž	Local Government Area	Northern Beaches Council
	D	Plan type and number	Deposited Plan 221112
	u	Lot number	15
	Ö	Section number	
	2	Project type	
	<u>9</u>	Dwelling type	Separate dwelling house
i, ns	ript	Type of alteration and addition	My renovation work is valued at \$50,000 or more, and does not include a pool (and/or spa).
	Ö		
	S		
	U		

36 Karina CresBelrose NSW 2085

Certificate Prepared by (please complete before submitting to Council or PCA) Name / Company Name: Action Plans

ABN (if applicable): 17118297587

Project address

Project name

ū

Ō

Fixtures and systems	Show on DA Plans	Show on CC/CDC Plans & specs	Certifier Check
Lighting			
The applicant must ensure a minimum of 40% of new or altered light fixtures are fitted with fluorescent, compact fluorescent, or light-emitting-diode (LED) lamps.		~	~
Fixtures	1		
The applicant must ensure new or altered showerheads have a flow rate no greater than 9 litres per minute or a 3 star water rating.		\checkmark	\checkmark
The applicant must ensure new or altered toilets have a flow rate no greater than 4 litres per average flush or a minimum 3 star water rating.		\checkmark	\checkmark
The applicant must ensure new or altered taps have a flow rate no greater than 9 litres per minute or minimum 3 star water rating.		\checkmark	

Construction	Show on DA Plans	Show on CC/CDC Plans & specs	Certifier Check									
Insulation requirements	Insulation requirements											
The applicant must construct the new or altere the table below, except that a) additional insula is not required for parts of altered construction	~	~	~									
Construction	Additional insulation required (R-value)	Other specifications										
suspended floor above garage: framed (R0.7).												
external wall: brick veneer												
flat ceiling, pitched roof	ceiling: R2.50 (up), roof: foil/sarking	dark (solar absorptance > 0.70)										

Glazing requirements

Windows and glazed doors

The applicant must install the windows, glazed doors and shading devices, in accordance with Relevant overshadowing specifications must be satisfied for each window and glazed door.

The following requirements must also be satisfied in relation to each window and glazed door

Each window or glazed door with standard aluminium or timber frames and single clear or tone have a U-value and a Solar Heat Gain Coefficient (SHGC) no greater than that listed in the tab must be calculated in accordance with National Fenestration Rating Council (NFRC) condition

Each window or glazed door with improved frames, or pyrolytic low-e glass, or clear/air gap/cle have a U-value and a Solar Heat Gain Coefficient (SHGC) no greater than that listed in the tab must be calculated in accordance with National Fenestration Rating Council (NFRC) condition only. Alternative systems with complying U-value and SHGC may be substituted.

For projections described in millimetres, the leading edge of each eave, pergola, verandah, ba above the head of the window or glazed door and no more than 2400 mm above the sill.

Pergolas with polycarbonate roof or similar translucent material must have a shading coefficient

Pergolas with fixed battens must have battens parallel to the window or glazed door above whether a second shades a perpendicular window. The spacing between battens must not be more than 50 mm.

Overshadowing buildings or vegetation must be of the height and distance from the centre and specified in the 'overshadowing' column in the table below.

Windows an	Nindows and glazed doors glazing requirements											
Window / door	Orientation	Area of	Oversha	dowing	Shading device							
no.		glass inc. frame (m2)	Height (m)	Distance (m)	_							
W1	E	0.88	0	0	eave/verandah/pergola/balcony >=900 mm							
W2	E	1.37	0.03	0.799	eave/verandah/pergola/balcony >=750 mm							

Glazing requi	irements						Show on DA Plans	Show on CC/CDC Plans & specs	Certifier Check
Window / door	Orientation	Area of	Oversha	dowing	Shading device	Frame and glass type			
no.		glass inc. frame (m2)	Height (m)	Distance (m)					
W3	E	3.64	0.03	0.799	eave/verandah/pergola/balcony >=750 mm	standard aluminium, single pyrolytic low-e, (U-value: 5.7, SHGC: 0.47)			
W4	E	1.37	0.03	0.799	eave/verandah/pergola/balcony >=750 mm	standard aluminium, single pyrolytic low-e, (U-value: 5.7, SHGC: 0.47)			
W5	E	1.37	0.03	0.799	eave/verandah/pergola/balcony >=750 mm	standard aluminium, single pyrolytic low-e, (U-value: 5.7, SHGC: 0.47)			
W6	W	0.73	0	0	eave/verandah/pergola/balcony >=750 mm	standard aluminium, single clear, (or U-value: 7.63, SHGC: 0.75)			
W7	W	0.73	0	0	eave/verandah/pergola/balcony >=750 mm	standard aluminium, single clear, (or U-value: 7.63, SHGC: 0.75)			
D1	E	11.55	0	0	eave/verandah/pergola/balcony >=900 mm	standard aluminium, single clear, (or U-value: 7.63, SHGC: 0.75)			

Legend

In these commitments, "applicant" means the person carrying out the development.

Commitments identified with a "v" in the "Show on DA plans" column must be shown on the plans accompanying the development application for the proposed development (if a development application is to be lodged for the proposed development).

Commitments identified with a "v" in the "Show on CC/CDC plans & specs" column must be shown in the plans and specifications accompanying the application for a construction certificate / complying development certificate for the proposed development.

Commitments identified with a "
"
"
in the "Certifier check" column must be certified by a certifying authority as having been fulfilled, before a final occupation certificate for the development may be issued

			REV.	DATE	COMMENTS	DRWN	NOTES This drawing is the copyright of Action Plans and not be altered, reproduced or transmitted in any form or by any means in part or in	CLIENT	DRAWING NO
		ACTION PLANS	A	05/06/19	INITIAL DESIGN PLAN	AM	whole with the written permission of Action Plans. Do not scale measure from drawings. Figured dimensions are to be used only. NATALIE & MARJ	NATALIE & MARJAN	DA17
	1	В	28/06/19	DESIGN AMENDMENT	AM	e Builder/Contractor shall check and verify all levels and dimensions on site prior to commencement of any work, creation of shop awings, or fabrication of components.	NOVOTNI	DAT	
1		m: 0426 957 518	С	30/08/19	DESIGN AMENDMENT	AM	errors and omissions are to be verified by the Builder/Contractor and referred to the designer prior to the commencement of works. window & door dimensions, orientation, glazing materials, opening types, frame types are to be confirmed by a suitably qualified	PROJECT ADDRESS	DATE
╷└──╞━━┛	e:operations@actionplans.com.au w: www.actionplans.com.au	D	24/09/19	DA DOCUMENTATION	JN	person prior to the ordering of any such materials are to take place. U value takes precedence over glazing type/colour in all cases.	36 KARINA CRESCENT	Thursday, 24	
							all new glazing must meet the BASIX specified frame and glass type, <u><i>QR</i></u> meet the ecified U value and SHGC value.	BELROSE NSW 2085	2019

	Show on DA Plans	Show on CC/CDC Plans & specs	Certifier Check
the specifications listed in the table below.	\checkmark	\checkmark	\checkmark
		\checkmark	~
ed glass may either match the description, or, ble below. Total system U-values and SHGCs is.		~	~
ear glazing, or toned/air gap/clear glazing must ble below. Total system U-values and SHGCs is. The description is provided for information		~	~
alcony or awning must be no more than 500 mm	\checkmark	\checkmark	\checkmark
nt of less than 0.35.		\checkmark	\checkmark
ich they are situated, unless the pergola also		\checkmark	\checkmark
d the base of the window and glazed door, as	\checkmark	\checkmark	~
Frame and glass type standard aluminium, single clear, (or U-value: 7.63, SHGC: 0.75)			
standard aluminium, single pyrolytic low-e, (U-value: 5.7, SHGC: 0.47)			

ING NO.

DRAWING NAME BASIX COMMITMENTS