

NOTES

THE BUILDER IS TO CHECK AND CONFIRM ALL NECESSARY
DIMENSIONS AND LEVELS ON SITE PRIOR TO ORDERING MATERIALS
AND COMMENCING CONSTRUCTION DO NOT SCALE OFF THE DRAWING.
SHOULD AND DEVELOPMENT OR CONSTRUCTION OCCUR ON OR NEAR

SHOULD ANY DEVELOPMENT OR CONSTRUCTION OCCUR ON OR NEAR BOUNDARIES, THE BOUNDARIES SHOULD BE CLEARLY MARKED ON SITE BY THE REGISTERED LAND SURVEYORS.

1 Builder to check or	nd confirm all ne	cessary dimension	on eite prior to	construction. Do not	scale the drawing.
2 All dimensions that	relate to site b	oundaries and ease	ements ore subject	to verification by o	site survey.
7 40					

All timber construction to be in occordance with the "TIMBER FRAMING" code.

Any detailing in addition to what is supplied shall be resolved between the owner and the builder to the owner's approval, except for one structural details or design, which is to be supposed by a Structural Facilities.

6 Roof water & sub-soil drainage to be disposed of in the approved monner or as directed by local council in 7 All electrical power & light outlets to be determined by owner.
8 Make good and repair all existing finishes damaged by new work. Reuse existing materials where possible. COPYRIGHT
ALL PLANS AND DRAWINGS ARE SUBJECT OF
COPYRIGHT AND ANY ATTEMPT OR ACTUAL
INFRINGEMENT BY USING, REPRODUCING OR
COPYING SAME, WHOLLY OR IN PART, WITHOUT
PRIOR WRITTEN PERMISSION WILL RESULT IN
LEGAL PROCEEDINGS.
J.D. SYANG and COMPANY PTY. LTD.
BUILDING DEBRIC COMPLATAR TY.

A DEVISIONNENT CAVS ANENDED 13-3,
NO. AMENDMENT DATE



#### J.D. EVANS and COMPANY

SITE AREA

**FLOOR** 

ROOF

DECK

SHED

DRIVEWAY

SWIMMING POOL

SD VERANDAH

SECONDARY DWELLING

**TOTAL HARD SURFACE** 

**PAVING** 

CARPORT

DESCRIPTION

**VERANDAH & STAIRS** 

PROJECT
PROPOSED ALTERATIONS/ADDITIONS,
SWIMMING POOL & SECONDARY DWELLING
5 IRRUBEL ROAD N. S. W. 2106

669.60 SQUARE METRES

**EXISTING SQM** 

154.52

105.48

36.00

18.00

33.50

11.04

8.96

3.16

grange

216.14 (32.29%)

5 IRRUBEL ROAD N.S.W. 2106 CLIENT PIET POELMANN DATE 18 /11 /2019 | SCALE | 1:200 | CHECKED |

256.37 (38,29%)

PROPOSED SQM

154.52

105.48

40.20

18.00

33.50

4.76

12.00


25.65

16.78


#### NOTES:

- LIGHTING OF BATHROOM AND WC TO BE IN ACCORDANCE WITH PART 3.8.4 OF THE BUILDING CODE OF AUSTRALIA AND AS / NZS 1680.0.
- 2. VENTILATION OF BATHROOM AND WC TO BE IN ACCORDANCE WITH PART 3.8.3.3 OF THE BUILDING CODE OF AUSTRALIA AND AS / NZS 1680.2.
- 3. THE DOOR TO THE BATHROOM IS REQUIRED TO COMPLY WITH AND IN ACCORDANCE WITH THE BUILDING CODE OF AUSTRALIA AMENDMENT 3, PART 3.8.3.3 (TO EITHER OPEN OUTWARDS, SLIDE OR BE READILY REMOVABLE FROM THE OUTSIDE OF THE COMPARTMENT).
- 4. SMOKE ALARMS TO BE IN ACCORDANCE
  WITH PART 3.7.2 OF THE BUILDING CODE OF AUSTRALIA
  AND AS / NZS 3786 / 1993.
- 5. TERMITE RISK MANAGEMENT TO BE IN ACCORDANCE WITH PART 3.1.3 OF THE BUILDING CODE OF AUSTRALIA.
- 6. SOUND INSULATION TO BE IN ACCORDANCE.
  WITH PART 3.8.6 OF THE BUILDING CODE OF AUSTRALIA.
- 7. ALL EXTERNAL GLAZING TO HAVE A MAXIMUM
  REFLECTIVITY INDEX OF 25%.
- ALL GLAZED ASSEMBLIES TO COMPLY WITH AS. 2047 AND AS. 1288.
- WATERPROOFING OF ALL WET AREAS TO COMPLY WITH AS 3740-2004.
- 10. AN APPROVED NON-VENTILATED COVER OR SHEILD WHICH ALLOWS FOR THE INSULATION TO BE CLOSELY INSTALLED TO THE SIDES & TOP TO ALL DOWNLIGHTS.



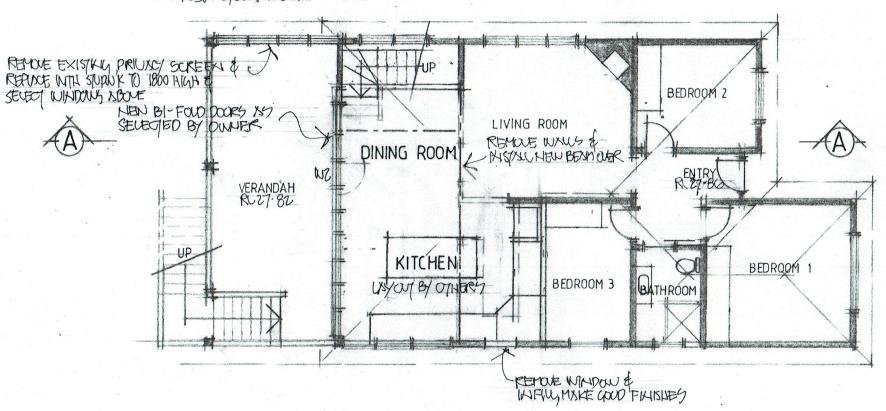

## UPPER FLOOR PLAN

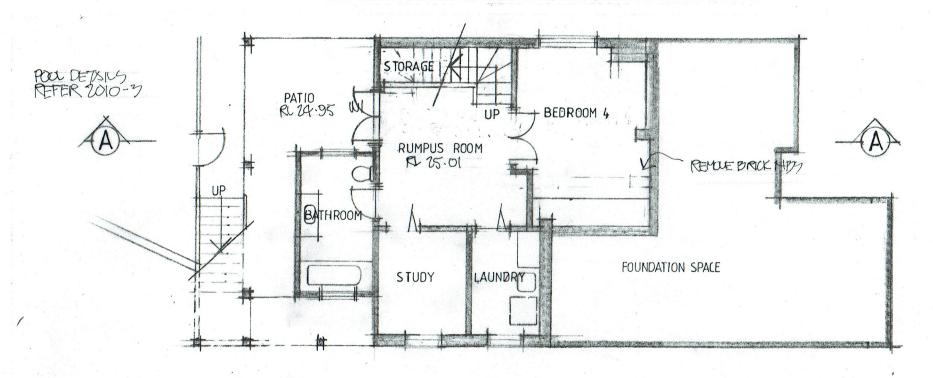

# Sharing the state of the state



THE BUILDER IS TO CHECK AND CONFIRM ALL NECESSARY
DIMENSIONS AND LEVELS ON SITE PRIOR TO ORDERING MATERIALS
AND COMMENCING CONSTRUCTION DO NOT SCALE OFF THE DRAWING.
SHOULD ANY DEVELOPMENT OR CONSTRUCTION OCCUR ON OR NEAR

BOUNDARIES, THE BOUNDARIES SHOULD BE CLEARLY MARKED ON SITE

## LOWER FLOOR PLAN

Builder to check and confirm all necessary dimensions on site prior to construction. Do not scale the drawing.

BY THE REGISTERED LAND SURVEYORS.

- 2 All dimensions that relate to site boundaries and sosements are subject to verification by a site survey.
- All work to be in accordance with BUILDING CODE of AUSTRALIA & to the satisfaction of local council requirements & other authorities.

  All timber construction to be in accordance with the "TIMBER FRAMING" code.
- Any detailing in addition to what is supplied shall be resolved between the owner and the builder to the owner's approval, except to
- 6 Roof water & sub-soil strainage to be disposed of in the approved manner or as directed by local council inspectors
- 7 All electrical power & light outlets to be determined by owner.

  8 Make good and repair all existing flateness demonst by new work. Reuse existing materials where possible.
- COPYRIGHT
  ALL PLANS AND DRAWINGS ARE SUBJECT OF
  COPYRIGHT AND ANY ATTEMPT OR ACTUAL
  INFRINGEMENT BY USING, REPRODUCING OR
  COPYING SAME, WHOLLY OR IN PART, WITHOUT
  PRIOR WRITTEN PERMISSION WILL RESULT IN
  LEGAL PROCEEDINGS.
  JD. BYANS 486 COMPANY PTY, LTD.
  BUILDING DESIGN CONSULTANTS

SAME, WHOLLY OR IN PART, WITHOUT ITTEN PERMISSION WILL RESULT IN OCCEDINGS.

BASE COMPANY PTY. LTD.

NO. AMENDMENT



#### J.D. EVANS and COMPANY

DESIGN AND BUILDING CONSULTANTS
UNIT 7, 6 JUBILEE AVENUE, WARRIEWOOD 2102
PHONE 9999 4566
Www.jdeco.com.au


Mobile 0418 976 596
email info@jdeco.com.au


PROJECT
PROPOSED ALTERATIONS/ADDITIONS,
SWIMMING POOL & SECONDARY DWELLING
5 IRRUBEL ROAD N. S. W. 2106

PIET POELMANN


DRAWING No. ISSUE

2010 - 2

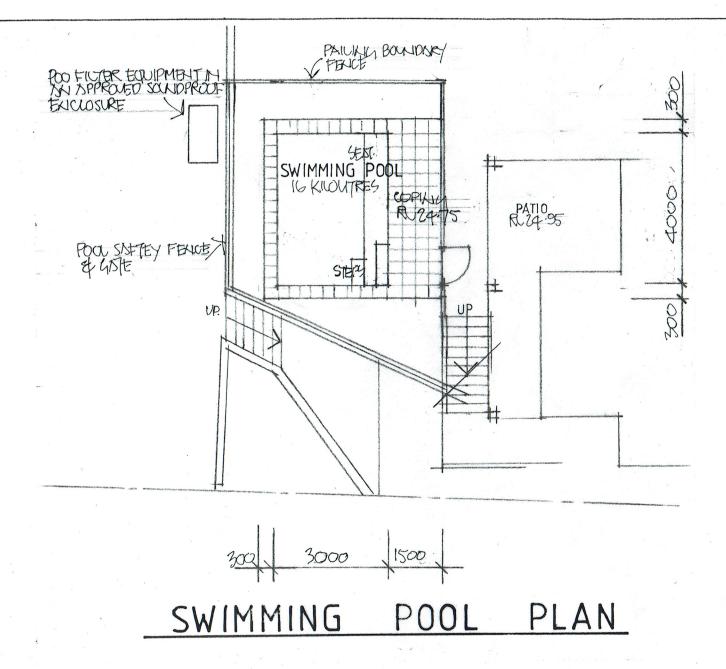

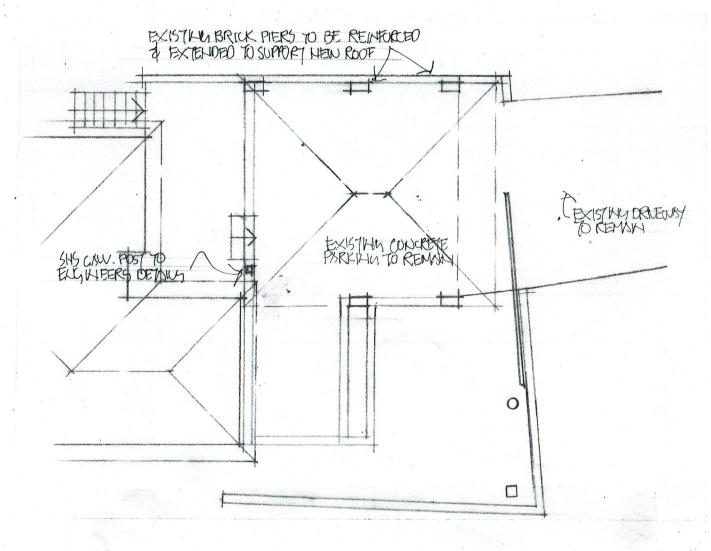

**FLOOR** CARPORT PLAN

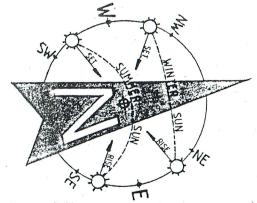

- THE BUILDER IS TO CHECK AND CONFIRM ALL NECESSARY DIMENSIONS AND LEVELS ON SITE PRIOR TO ORDERING MATERIALS AND COMMENCING CONSTRUCTION DO NOT SCALE OFF THE DRAWING. SHOULD ANY DEVELOPMENT OR CONSTRUCTION OCCUR ON OR NEAR
- BOUNDARIES, THE BOUNDARIES SHOULD BE CLEARLY MARKED ON SITE BY THE REGISTERED LAND SURVEYORS.

- POOL FENCING IS TO BE DESIGNED, LOCATED AND MAINTAINED IN ACCORDANCE WITH THE SWIMMING POOL ACT 1992 AS AMENDED.
  - AS 1926.1 2007 LOCATION OF SAFTEY BARRIER FENCING FOR PRIVATE SWIMMING POOLS. A RESUSCITATION AND EXTERNAL CARDIAC COMPRESSION CHART
- TO BE AFFIXED AND MAINTAINED IN A PROMINENT
- LOCATION ADJACENT TO POOL AREA.
- ALL POOL OVERFLOW WATER AND WASTE WATER FROM THE FILTRATION PROCESS IS TO BE DIRECTED TO THE SEWER.

COPYRIGHT
ALL PLANS AND DRAWINGS ARE SUBJECT OF COPYRIGHT AND ANY ATTEMPT OR ACTUAL INFRINGEMENT BY USING, REPRODUCING OR COPYING SAME, WHOLLY OR IN PART, WITHOUT PRIOR WRITTEN PERMISSION WILL RESULT IN LEGAL PROCEEDINGS.

J.D. SYANB ASS COMPANY PTY. LTD.
BUILDING DESIGN CONSULTANTS




#### J.D. EVANS and COMPANY


DESIGN AND BUILDING CONSULTANTS UNIT 7, 6 JUBILEE AVENUE, WARRIEWOOD 2102
PHONE 9999 4566
www.jdeco.com.au

WOBILE 0418 976 596
www.jdeco.com.au PROJECT
PROPOSED ALTERATIONS/ADDITIONS,
SWIMMING POOL & SECONDARY DWELLIN 5 IRRUBEL ROAD N. S. W. 2106

PIET POELMANN


	DATE 18/11/2019 DRAWN JDE.	SCALE 1:100,
IC	DRAWING No. 201(	) - 3

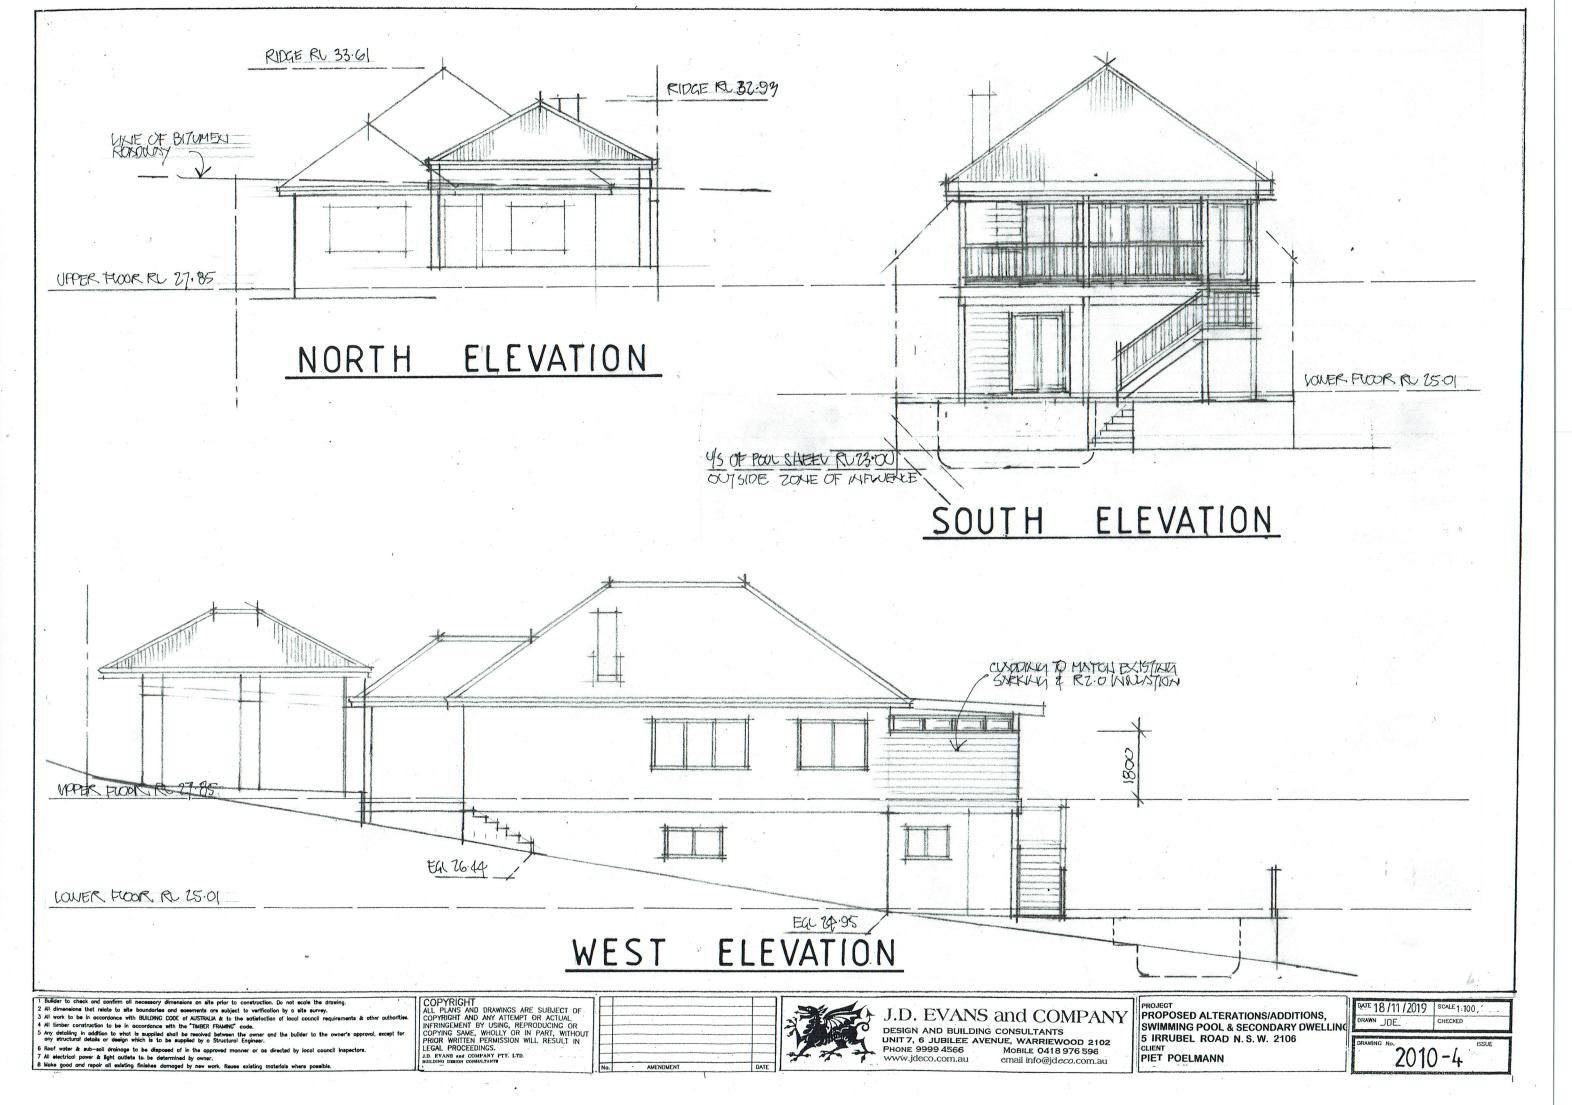


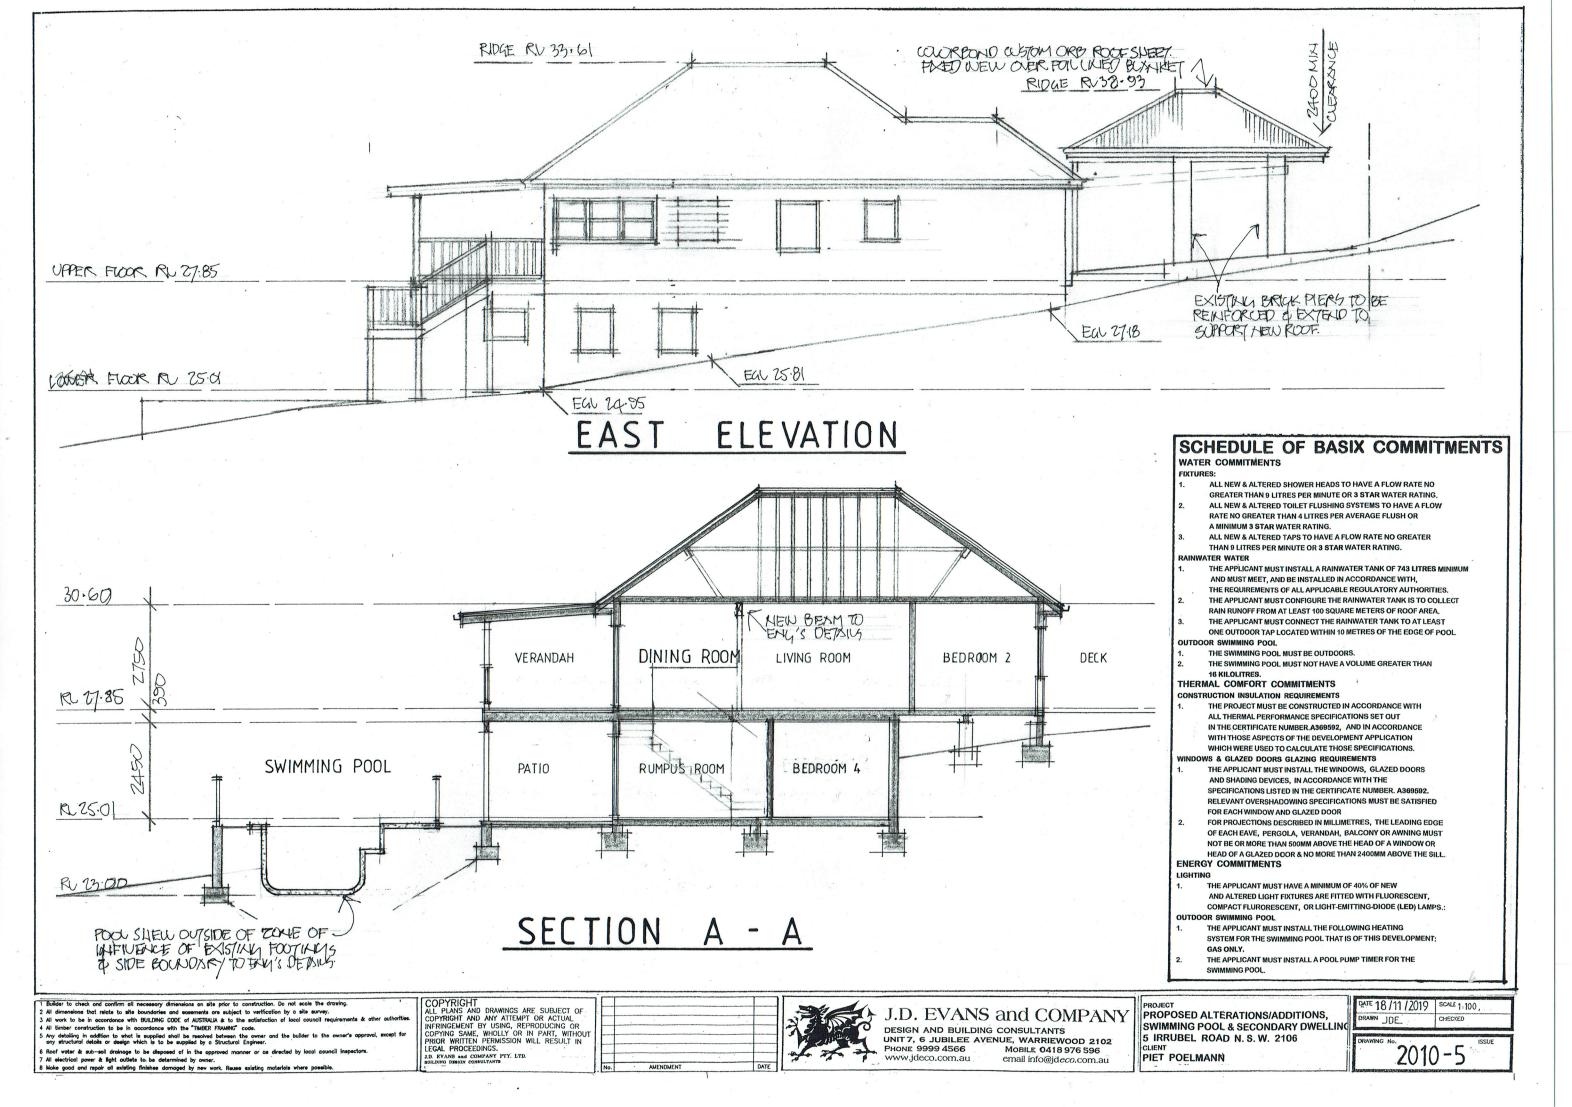

#### NOTES:


- LIGHTING OF BATHROOM AND WC TO BE IN ACCORDANCE WITH PART 3.8.4 OF THE BUILDING CODE OF AUSTRALIA AND AS / NZS 1680.0.
- VENTILATION OF BATHROOM AND WC TO BE IN ACCORDANCE WITH PART 3.8.3.3 OF THE BUILDING CODE OF AUSTRALIA AND AS / NZS 1680.2.
- THE DOOR TO THE BATHROOM IS REQUIRED TO COMPLY WITH AND IN ACCORDANCE WITH , THE BUILDING CODE OF AUSTRALIA AMENDMENT 3, PART 3.8.3.3 (TO EITHER OPEN OUTWARDS, SLIDE OR BE READILY REMOVABLE FROM THE OUTSIDE OF THE COMPARTMENT).
- SMOKE ALARMS TO BE IN ACCORDANCE WITH PART 3.7.2 OF THE BUILDING CODE OF AUSTRALIA AND AS / NZS 3786 / 1993.
- TERMITE RISK MANAGEMENT TO BE IN ACCORDANCE WITH PART 3.1.3 OF THE BUILDING CODE OF AUSTRALIA.
- SOUND INSULATION TO BE IN ACCORDANCE. WITH PART 3.8.6 OF THE BUILDING CODE OF AUSTRALIA.
- ALL EXTERNAL GLAZING TO HAVE A MAXIMUM REFLECTIVITY INDEX OF 25%.
- ALL GLAZED ASSEMBLIES TO COMPLY WITH AS. 2047 AND AS. 1288.
- WATERPROOFING OF ALL WET AREAS TO COMPLY
- AN APPROVED NON-VENTILATED COVER OR SHEILD WHICH ALLOWS FOR THE INSULATION TO BE CLOSELY INSTALLED TO THE SIDES & TOP TO ALL DOWNLIGHTS.

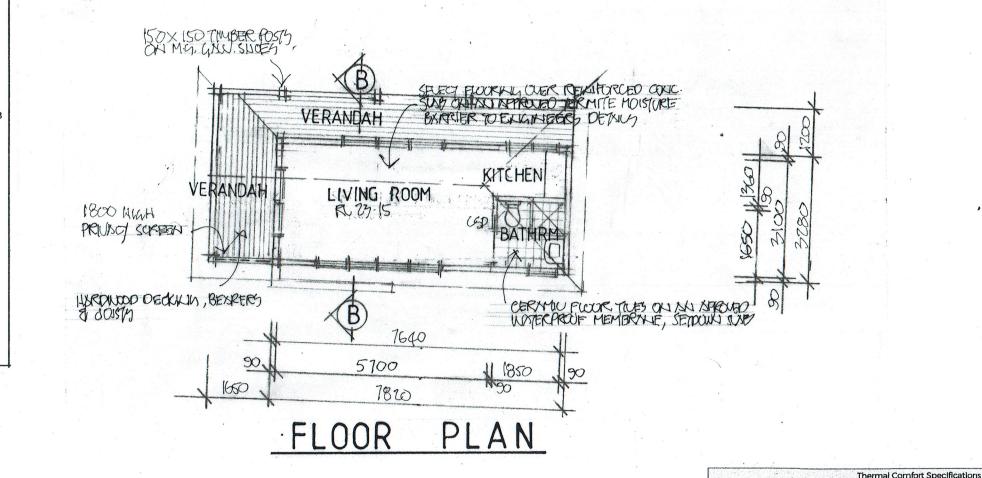

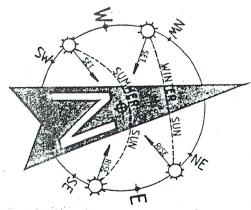

- THE BUILDER IS TO CHECK AND CONFIRM ALL NECESSARY DIMENSIONS AND LEVELS ON SITE PRIOR TO ORDERING MATERIALS AND COMMENCING CONSTRUCTION DO NOT SCALE OFF THE DRAWING.
- SHOULD ANY DEVELOPMENT OR CONSTRUCTION OCCUR ON OR NEAR BOUNDARIES, THE BOUNDARIES SHOULD BE CLEARLY MARKED ON SITE BY THE REGISTERED LAND SURVEYORS.


# SECONDARY DWELLING PROPOSED ALTERATIONS/ADDITIONS,

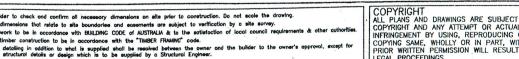

6 Roof water & sub-soil strainage to be disposed of in the approved manner or as directed by local 7 All electrical power & light outlets to be determined by owner.

8 Make good and repair oil existing finishes damaged by new work. Reuse existing materials where p

COPYRIGHT
ALL PLANS AND DRAWINGS ARE SUBJECT OF
COPYRIGHT AND ANY ATTEMPT OR ACTUAL
INFRINGEMENT BY USING, REPRODUCING OR
COPYING SAME, WHOLLY OR IN PART, WITHOUT
PRIOR WRITTEN PERMISSION WILL RESULT IN
LEGAL PROCEEDINGS.
JD. EVAND and COMPANY PTY, LTD.
BIOLIDING DESIRED COMBULTANT

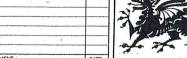

#### J.D. EVANS and COMPANY

DESIGN AND BUILDING CONSULTANTS UNIT 7, 6 JUBILEE AVENUE, WARRIEWOOD 2102 PHONE 9999 4566 MOBILE 0418 976 596 vww.ideco.com.au email info@ideco.com au

SWIMMING POOL & SECONDARY DWELLING 5 IRRUBEL ROAD N. S. W. 2106 CLIENT
PIET POELMANN

Clazing Aluminium framed double glazing throughout:

Doors/windows/cl- U-Value: 2.50 (equal to or lower than) SHGC: 0.25 (±10%)

Metal roof with a foil/sarking (Ru1.3 and Rd1.3). External Colour: Medium colour (0.475<SA<0.7)

Medium colour modelled (0.475<SA<0.7)

Covered Porch and Alfresco, Eaves as per stamped plans Adjustable external blinds to the west-facing sliding door BASIX Water Commitments Fixtures Install showerheads minimum rating of 4 stars-Mid flow (>6 and <= 7.5 Litres/min) Install toilet flushing system with a minimum rating of 4 stars in each toilet

Install tap with minimum rating of 5 stars in the kitchen Install taps with minimum rating of 5 stars in each bathroom

area and tank connected to the garden & lawn, toilets & laundry **BASIX Energy Commitments** 

Plasterboard on studs

Gas Instantaneous - 6 Stars

No active heating system

Other | Electric cooktop & electric oven

Outdoor clothes drying line

Alternative Energy | Solar Photovoltaic system minimum of 1.0 peak KW

Ceiling fans only

Internal walls

Alternative Water

Hot water System

Cooling system

Heating system

Floors

liven values are AFRC, total window system values (glass and frame)


lasterboard ceiling with R4.0 insulation (insulation value only) where roof is above Note: All ceiling penetrations have been modelled in accordance with Nati-IERS protocols, all downlights are assume sealed LED downlights, one every 5m<sup>2</sup> Lightweight weatherboard with R2.0 insulation (insulation only value)


Suspended concrete slab on ground with R1.2 insulation (insulation only value) Floor coverings: tiles to bathrooms and timber elsewhere

Install rainwater tank, minimum 3,200L capacity collected from min. 40m2 of roof


Kitchen-Individual fan, externally ducted to roof or façade, manual on/off switch Bathrooms- Individual fan, externally ducted to roof or facade, manual on/off switch Laundry- Individual fan, externally ducted to roof or façade, manual on/off switch

> ENTE 18/11/2019 SCALE 1:100, JOE WAS 2010-6

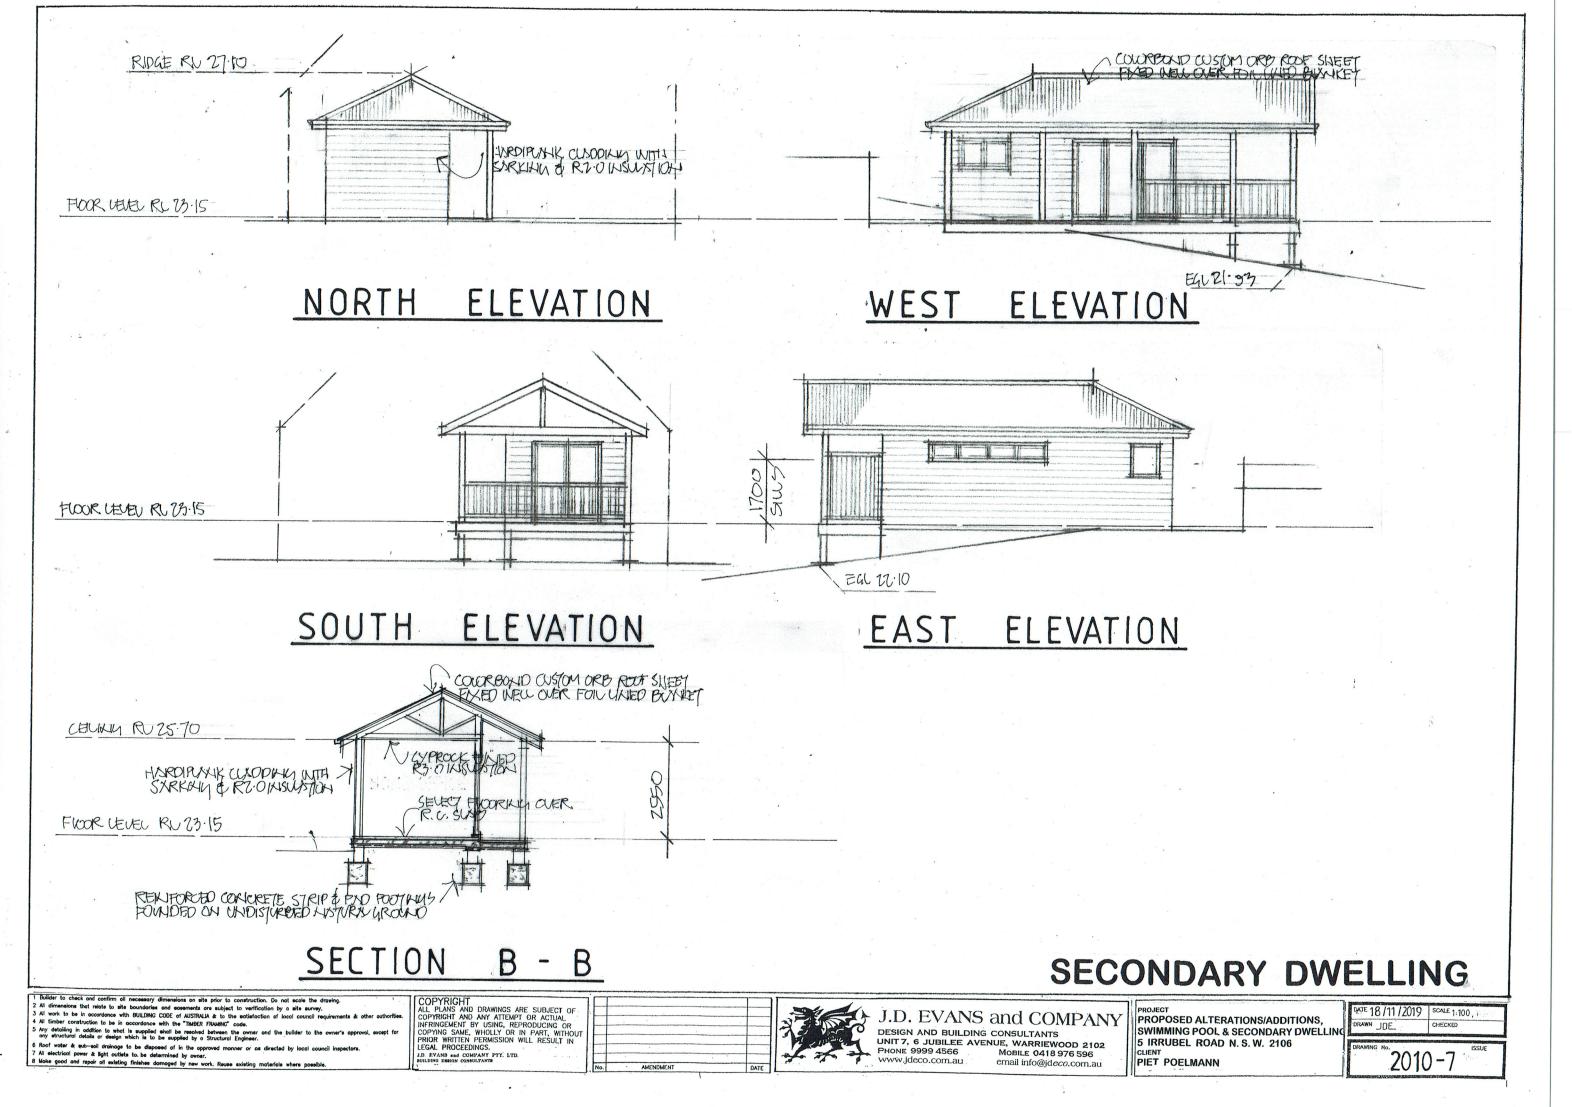

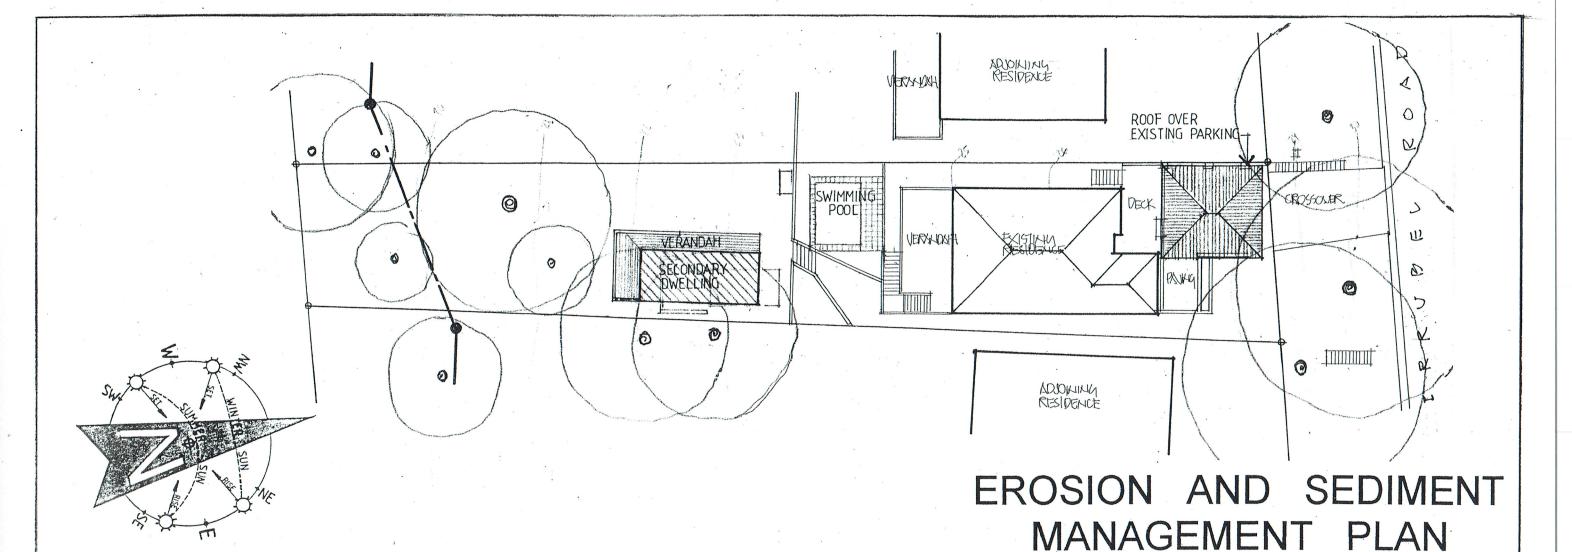



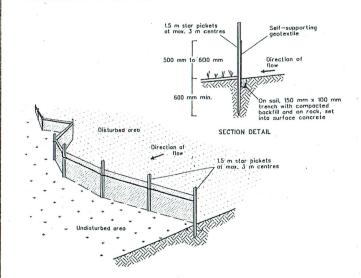


#### CONSTRUCTION NOTES

- 1. CONSTRUCT SEDIMENT FENCE AS CLOSE AS POSSIBLE TO PARALLEL. TO THE
- CONTOURS OF THE SITE.

  2. DRIVE 1.5 METRE LONG STAR PICKETS INTO GROUND, 3.0 METRES APART. 3. DIG A 150MM DEEP TRENCH ALONG THE UPSLOPE LINE OF THE FENCE.
- FOR THE BOTTOM OF THE FABRIC TO BE ENTRENCHED.

  4. BACKFILL TRENCH OVER BASE OF FABRIC.
- 5. FIX SELF-SUPPORTING GEOTEXTILE TO UPSLOPE SIDE OF POSTS WITH WIRE TIES OR AS RECOMMENDED BY GEOTEXTILE MANUFACTURER.
- 6. JOIN SECTIONS OF FABRIC AT A SUPPORT POST WITH A 150MM OVERLAP

#### MESH AND GRAVEL INLET FILTER

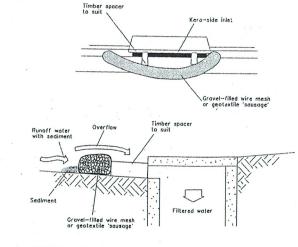

NOTE: This practice only to be used where specified in an approved SWMP/ESCP.


#### CONSTRUCTION NOTES

- 1. FABRICATE A SLEVE MADE FROM GEOTEXTILE OR WIRE MESH LONGER
- THAN THE LENGTH OF THE INLET PIT.
- 2. FILL THE SLEVE WITH 25MM TO 50MM GRAVEL.
  3. FORM AN ELLIPTICAL CROSS-SECTION ABOUT 150MM HIGH X 400MM WIDE.
  4. PLACE THE FILTER AT THE OPENING OF THR KERB INLET LEAVING A
- 100MM GAP AT THE TOP TO ACT AS AN EMERGENCY SPILLWAY. 5. MAINTAIN THE OPENING WITH SPACER BLOCKS.
- 6. FORM A SEAL WITH THE KERBING AND PREVENT SEDIMENT BYPASSING THE FILTER.
- 7. FIT TO ALL KERB INLETS AT SAG POINTS

COPYRIGHT
ALL PLANS AND DRAWINGS ARE SUBJECT OF
COPYRIGHT AND ANY ATTEMPT OR ACTUAL
INFRINGEMENT BY USING, REPRODUCING OR
COPYING SAME, WHOLLY OR IN PART, WITHOUT
PRIOR WRITTEN PERMISSION WILL RESULT IN
LEGAL PROCEEDINGS.

D. EVANS and COMPANY PTY. LTD.

#### STABILISED SITE ACCESS

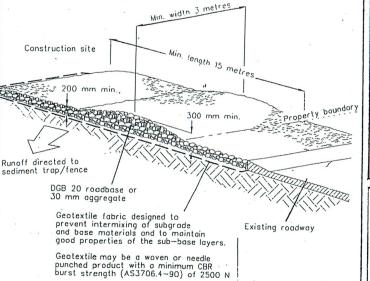


#### **CONSTRUCTION NOTES**

- 1. STRIP TOPSOIL AND LEVEL SITE.
- 2.COMPACT SUBGRADE.
- 3. COVER AREA WITH NEEDLE-PUNCHED GEOTEXTILE.
- 4. CONSTRUCT 200MM THICK PAD OVER GEOTEXTILE USING ROADBASE OR 30MM AGGREGATE. MINMIMUM LENGTH 15 METRES OR TO BUILDING ALIGNMENT. MINIMUM WIDTH 3 METRES.
- 5. CONSTRUCT HUMP IMMEDIATELY WITHIN THE BOUNDARY TO DIRVERT WATER TO A SEDIMENT FENCE OF OTHER SEDIMENT TRAP.

#### BUILDING MATERIAL STOCKPILES DETAIL Waterproof Earth bank to prevent Covering scour of stockpile Sediment Fence Stockpile CERTIFICATION

- I JOHN EVANS MEMBER No. 365-96 OF THE BUILDING DESIGNERS ASSOCIATION OF N. S. W. INC, HEREBY CERTIFY THAT THIS DRAWING HAS BEEN DESIGNED IN WITH THE REQUIREMENTS OF THE N.S.W. DEPARTMENT OF
- LAND AND WATER CONSERVATION'S
- "URBAN EROSION AND SEIMENT CONTROL" MANUAL.

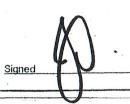

J.D. EVANS and COMPANY DESIGN AND BUILDING CONSULTANTS UNIT 7, 6 JUBILEE AVENUE, WARRIEWOOD 2102 PHONE 9999 4566 MOBILE 0418 976 596


email info@jdeco.com.au

PROPOSED ALTERATIONS/ADDITIONS. SWIMMING POOL & SECONDARY DWELLING 5 IRRUBEL ROAD N. S. W. 2106 PIET POELMANN

MTE 18/11/2019 SCALE NTS



www.jdeco.com.au

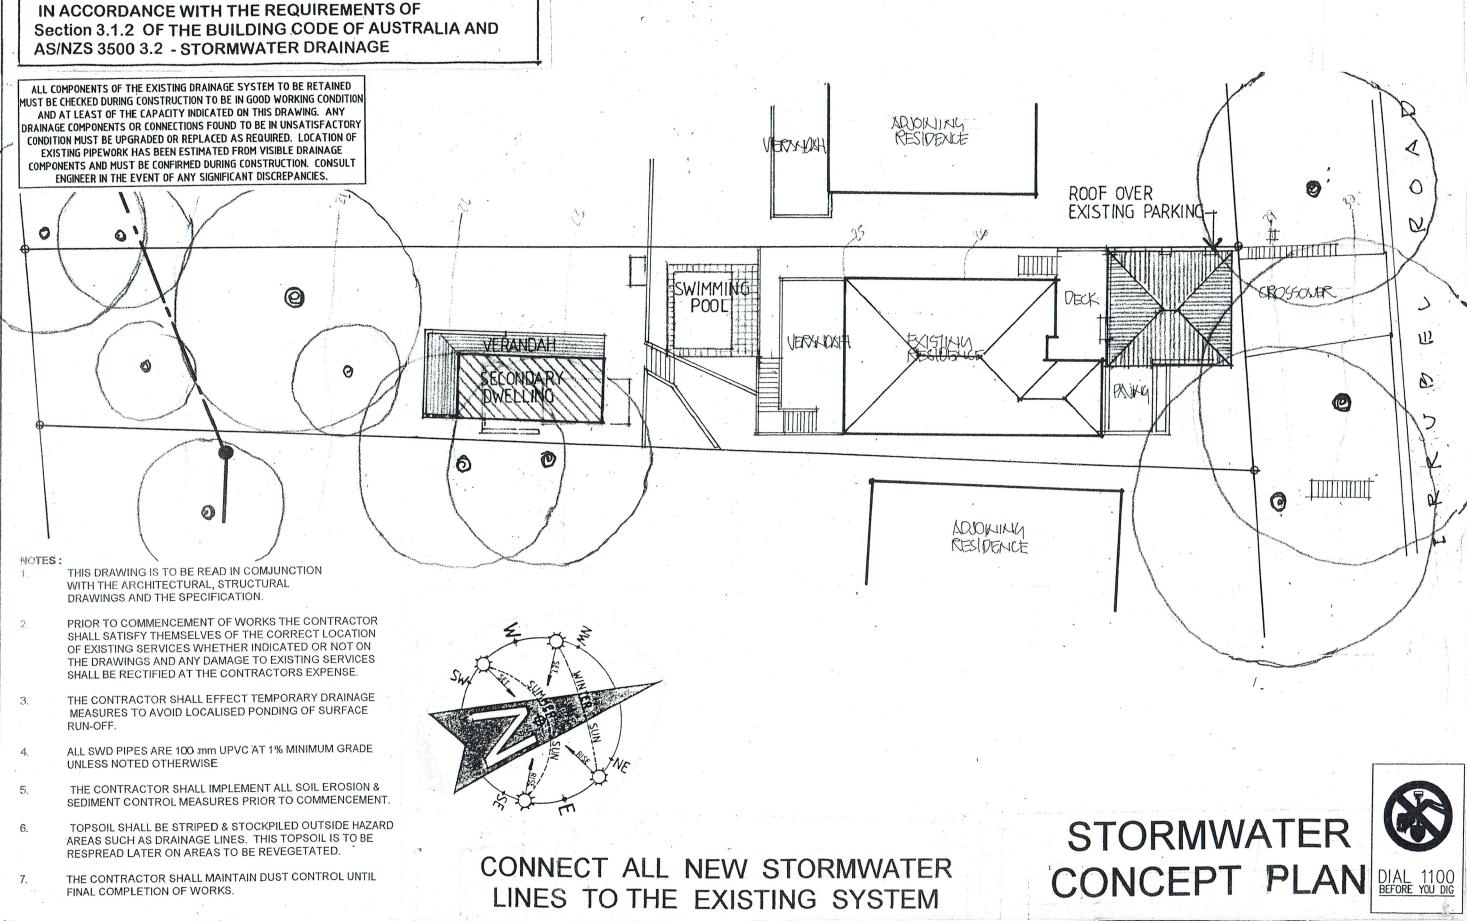

NOTE:

ALL DRAINAGE WORKS TO BE DESIGNED AND IMPLEMENTED

COPYRIGHT
ALL PLANS AND DRAWINGS ARE SUBJECT OF
COPYRIGHT AND ANY ATTEMPT OR ACTUAL
INFRINGEMENT BY USING, REPRODUCING OR
COPYING SAME, WHOLLY OR IN PART, WITHOUT
PRIOR WRITTEN PERMISSION WILL RESULT IN
LEGAL PROCEEDINGS.
J.D. EVANS AND COMPTANY PTY. LTD.
BUILDING DEBAIN COMMUTANY?






#### J.D. EVANS and COMPANY


DESIGN AND BUILDING CONSULTANTS UNIT 7, 6 JUBILEE AVENUE, WARRIEWOOD 2102 PHONE 9999 4566 MOBILE 0418 976 596

PROPOSED ALTERATIONS/ADDITIONS, SWIMMING POOL & SECONDARY DWELLING 5 IRRUBEL ROAD N. S. W. 2106

PIET POELMANN


ATE 18/11/2019 | SCALE . , 1: 200 WN JOE

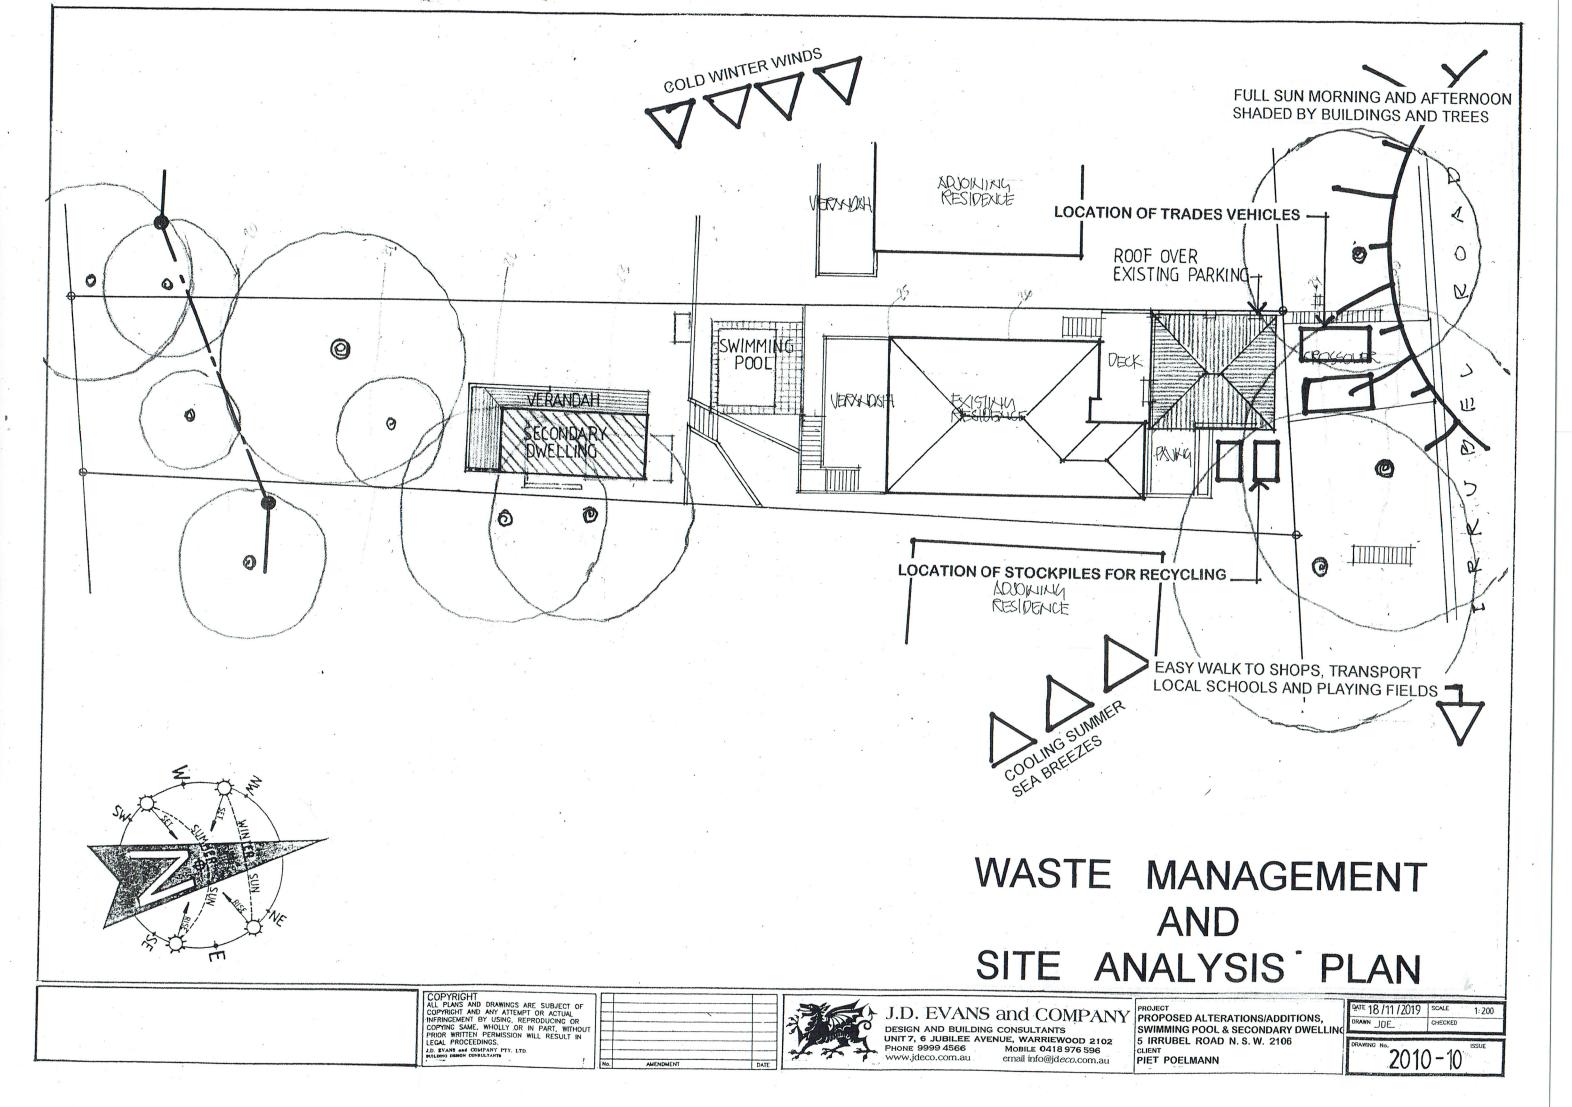

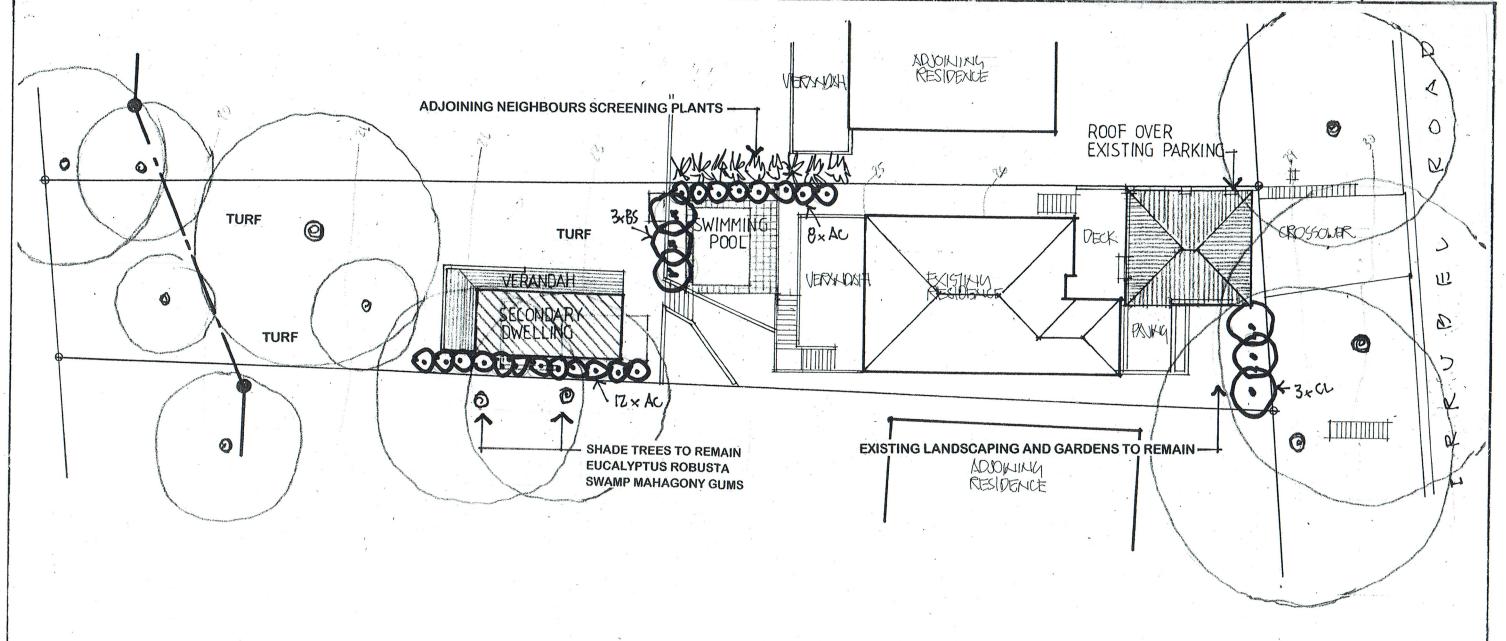

# PLANTING SCHEDULE FOR ROLLING HILLS & LOWER SLOPES

SYMBOL	BOTANICAL NAME	COMMON NAME	POT SIZE	NO. OFF	HEIGHT	SPREAD			
SCREENING				·	The state of the s				
AC	ACMENA SMITHII	LILLI-PILLI	5Ltr	20	23	1.0			
SHRUBS		1		The second secon	,				
BS	BANKSIA SPINULOSA	HAIRPIN BANKSIA	5Ltr	3	2-3	2-3			
CL	CALLISTEMON LINEARIFOLIUM	NARROW LEAVED BOTTLEBRUSH	5Ltr	3	2-3	2.5			
GROUND CO	VERS / SCRAMBLERS		eten titaling et elektronisten entre en	entere e en en en entere no en	menter that the construction of the constructi	manage of the second			
KR KENNEDIA RUBICUNDA		DUSKY CORAL PEA							

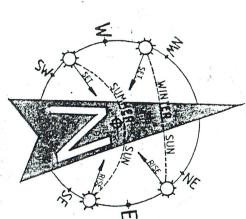

LANDSCAPE CONCEPT PLAN

ALL CIVIL STRUCTURAL AND HYDRAULIC WORKS ASSOCIATED WITH THIS PROJECT SHALL BE TO THE RELEVANT ENGINEER'S DETAILS. FIGURED DIMENSIONS TO BE TAKEN IN PREFERENCE TO SCALING. ALL DIMENSIONS & LEVELS TO BE VERIFIED BY THE CONTRACTOR ON SITE.

**VIOLA HEDERACEA** 

NATIVE VIOLET

VH



#### J.D. EVANS and COMPANY

DESIGN AND BUILDING CONSULTANTS
UNIT7, 6 JUBILEE AVENUE, WARRIEWOOD 2102
PHONE 9999 4566 MOBILE 0418 976 598
www.jdeco.com.au email info@ideco.com.au

PROJECT
PROPOSED ALTERATIONS/ADDITIONS,
SWIMMING POOL & SECONDARY DWELLING
5 IRRUBEL ROAD N. S. W. 2106
CLIENT
PIET POELMANN

DATE 18 /11 /2019 SCALE 1:200
DRAWN JDE... CHECKED

DRAWING No. ISSUE

2010 -11

