


Amended: Pool depth Excavation area

	CLIENT	SCALE
T PLAN	BRUNETTE	1:50 @ A3
ODMENT	DATE	PLAN NO.
OPMENT: CRETE SWIMMING POOL	APRIL 2019	2019JW07.1 (A)
ROAD, BILGOLA PLATEAU	Drawn by:	
DP 16902	71.10	

JWConcepts&Desígn

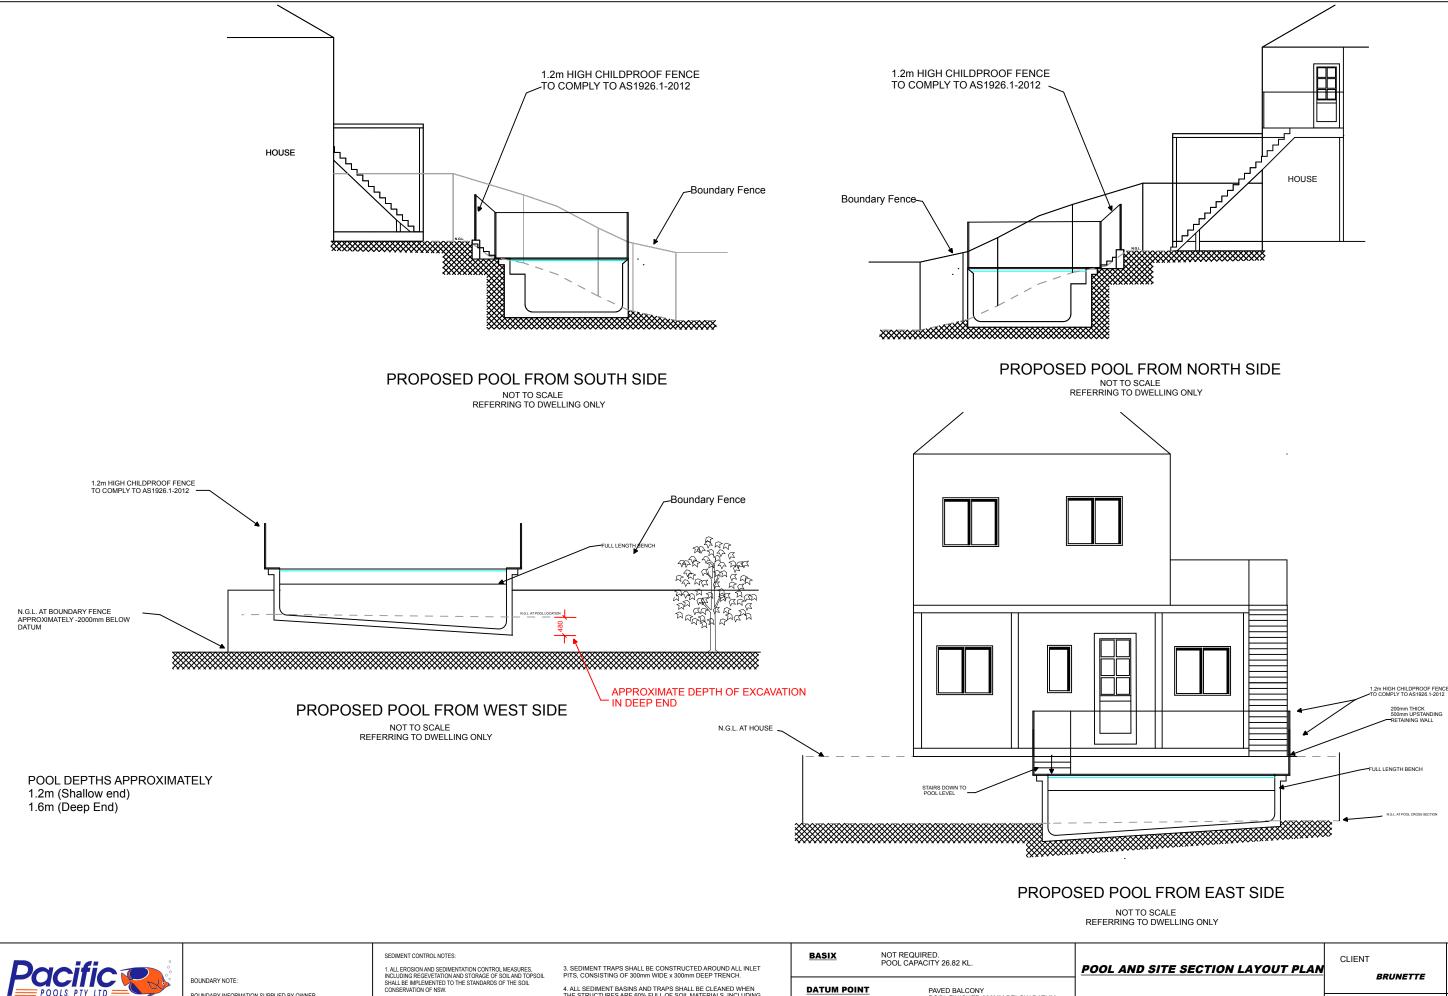

PACIFIC POOLS P/L

84 Third road, Berkshire Park License no. 62686C Ph 9897 5566

BOUNDARY INFORMATION SUPPLIED BY OWNER. CONFIRM ALL BOUNDARY INFORMATION PRIOR TO COMMENCEMENT OF WORK.

COUNCIL NOTES: - NO EXISTING STORMWATER ON ALLOTMENT. - NO WATERWAYS, WATERCOURSES OR EXISTING DRAINAGE PROBLEMS. - EASMENTS SHOWN ON SITE PLAN.
 - SEDIMENT DISPOSED OF TO COUNCIL'S REQUIRMENTS. CONCRETE SLAB IN ACCORDANCE WITH CODE OF AUSTRALIA 2. ALL DRAINAGE WORKS SHALL BE CONSTRUCTED AND STABILISED AS EARLY AS POSSIBLE DURING DEVELOPEMENT.

GEOTEXTILE FILTER FAI WRE OR STE Direction o POSTS DRIVE 4. ALL SEDIMENT BASINS AND TRAPS SHALL BE CLEANED WHEN THE STRUCTURES ARE 60% FULL OF SOIL MATERIALS, INCLUDING THE MAINTENANCE PERIOD. 5. ALL DISTURBED AREAS SHALL BE REVEGETATED AS SOON AS THE RELEVAANT WORKS SRE COMPLETED.


6. SOIL AND TOPSOIL STOCKPILES SHALL BE LOCATED AWAY FROM DRAINAGE LINES AND AREAS WHERE WATER MAY CONCENTRATE.

7. FILTERS SHALL BE CONSTRUCTED BY STRETCHING A FILTER FABRIC (PROPEX OR APPROVED EQUIVALENT) BETWEEN POSTS AT 3m CENTRES. FABRIC SHALL BE BURIED 150mm ALONG ITS LOWER

SITE AREA BLOCK WIDTH PROPOSED POOL TOTAL LIVING ARE EXISTING HARD S LANDSCAPED ARI MIN. LANDSCAPEI

POOL CAPACITY 26.82 KL.		POOL AND SITE SE
DATUM POINT	PAVED BALCONY POOL FINISHED 820MM BELOW DATUM	PROPOSED DEVELO REINFORCED CONC
SITE DETAILS:]
SITE AREA BLOCK WIDTH PROPOSED POOL TOTAL LIVING AREA EXISTING HARD SURFACES LANDSCAPED AREA MIN LANDSCAPED DECUIIDED	551.8 SQ. M. 13.715 M. 233.94 SQ. M. 26.63 SQ. M. 291.23 SQ. M. 110.2 SQ. M.	No. 107 PLATEAU RO Lot 286

ECTION LAYOUT PLAN	CLIENT	SCALE	
	BRUNETTE	1:100 @ A3	
OPMENT: CRETE SWIMMING POOL	DATE	PLAN NO.	
ROAD, BILGOLA PLATEAU	APRIL 2019	2019 JW 07.2	
DP 16902	Drawn by:		
	JWConcepts&Design		

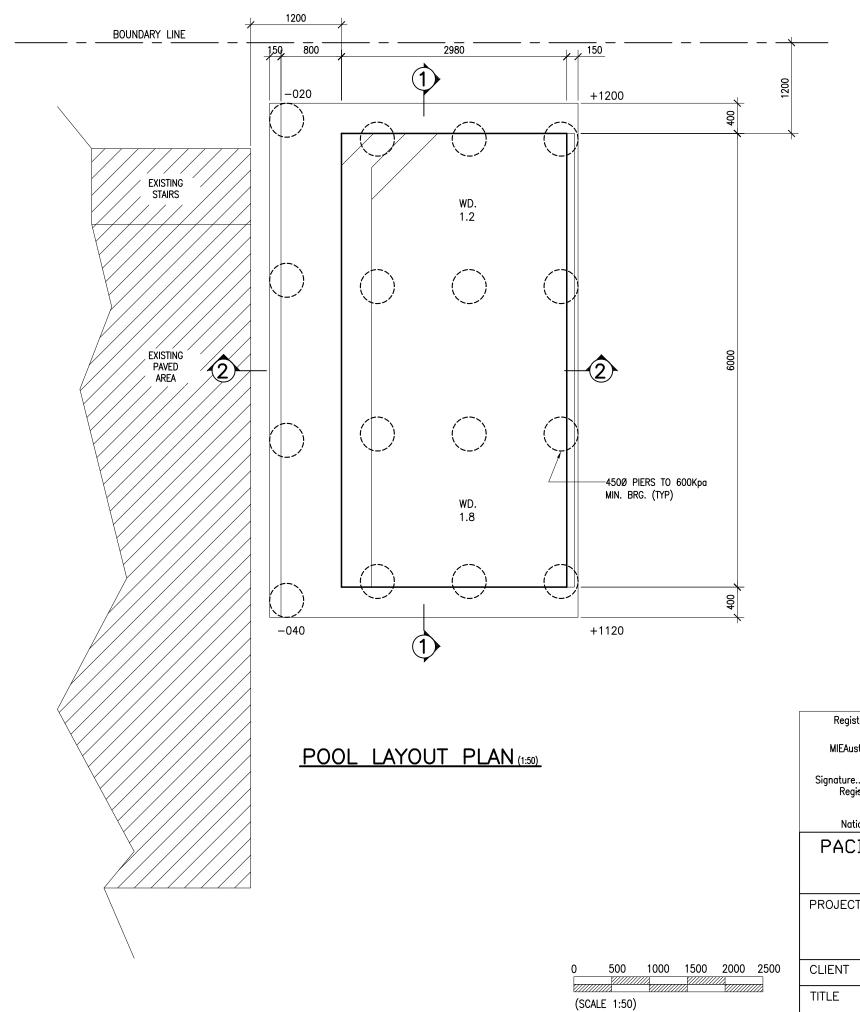

CONSTRUCTION NOTES:

- General G1
- G2 G3
- G4 G5 G6 G7

- G10 Sections 1-1 & 2-2 take preference over notes.
- G11 These details are primarily for structural details. All other ancillary information has been given by others and so we take no responsibility.

Foundation

- and details modified. F5 Foundation material to be approved by engineers prior to pouring of shell.

Concrete

C1	All workmanship	o and mo	iterials to be in	accordance w
C2	Concrete qualit	у.	Max. Agg.	Exp
	Element	Slump	Size	Class
	Pool	80	10	A
				-8
				В
				c.

- C3 Cement content ≮ 280 kg/m³
- C4 Clear concrete cover to reo.
- Exposure
 - Formed face of insitu concrete Exposed face of pneumatically a
 - Concrete placed in contact with Faces exposed in gaaresive wate
- C5 Sizes of concrete do not include applied finishes.
 C6 Construction joints located to the approval of the Eng
 C7 Contractor to notify Engineer 24hrs prior to any concrete

- **Reo** R1 All reinforcement shall comply with AS1304. R2 Reinforcement to be supported on approved chairs sp[.] R3 Min Lap S12 bars 450mm


	MIEAust C Signature Register	Ar John Cavasinni PENG (Civil / Structural) red on the NPER in the category of Civil / Structural I Professional Engineers Register			
		IC POOLS P/L (ACN 067 579 195) 84 THIRD RD, BERKSHIRE PARK 2765 Licence No 62686C Ph 9897 5566	JOHN CAVASINNI & CIVIL & STRUCTURAL ENGINEERING CO ACN 000 906 936		P/L E Aust
	PROJECT	PROPOSED REINFORCED CONCRETE POOL 107 PLATEAU ROAD BILGOLA PLATEAU		Mobile: 0418 2	5 8645 igpond.com
2500	CLIENT	BRUNETTE	Approved:	Date: MAY 20	19
2	TITLE	SWIMMING POOL PLAN	Drawing No. 2019PF	२१४००	1/2


These specification are to be read in conjunction with the Architectural drawings. Do not scale off any of the details use written dimensions only. Structure to be kept in a stable condition and no part is to be overstressed. All workmanship and materials to be in accordance with the relevant codes and ordinances. G5 Pool not designed for surcharge loading from other structures.
G6 Builder to note that records must be kept as outlined in clause 6.4 of AS2783.
G7 Wall thicknesses shown have no negative tolerances.
G8 Pool must not be emptied until ground water pressures have been removed from pool base and wall.
G9 Pool construction to conform with AS2783.


Foundation
F1 Pool is to be founded on approved natural ground with a bearing capacity of at least 100 kpa.
F2 Pool wall can project a maximum of 600mm out of natural ground with that wall having bearing on at least 100 kpa. If > 600mm protrusion engineer to be notified and revised details given.
F3 Excavation to be kept free of water. If surface deteriorates loose or soft material is to be removed.
F4 Pool suitable for site Classed A, S or M as per AS2870 any other condition, engineer is to be notified


		schedule	
e with AS3600. Exposure	A\$3600	Coping width CW	Reo required
Hassification At B1 B2 Soline soils	Fc (Mpa) 25 25 32 32 40	200 350 400 800 900	2S12 3S12 4S12 8S12 9S12
	-		


Cover 40	Internal Finish ; <u>As R</u> eq'd
applied concrete 50 ground 60	Pool Data Maximum depth <u>1.8 M</u>
er 70	Maximum length <u>6.0</u> M
ngineer. Icrete being poured.	Relief value as per details Design details comply with: AS1170 Pt 1 SAA Loading Code
spaced 1000 max.	AS3600 SAA Concrete Structures Code AS2783 SAA Concrete Pool Code AS2610 Pt 2 SAA Pool Part 2 Private Spas

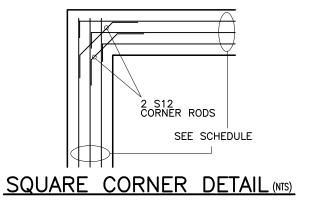


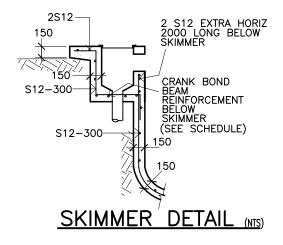

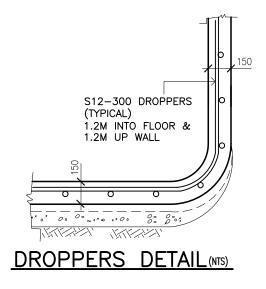

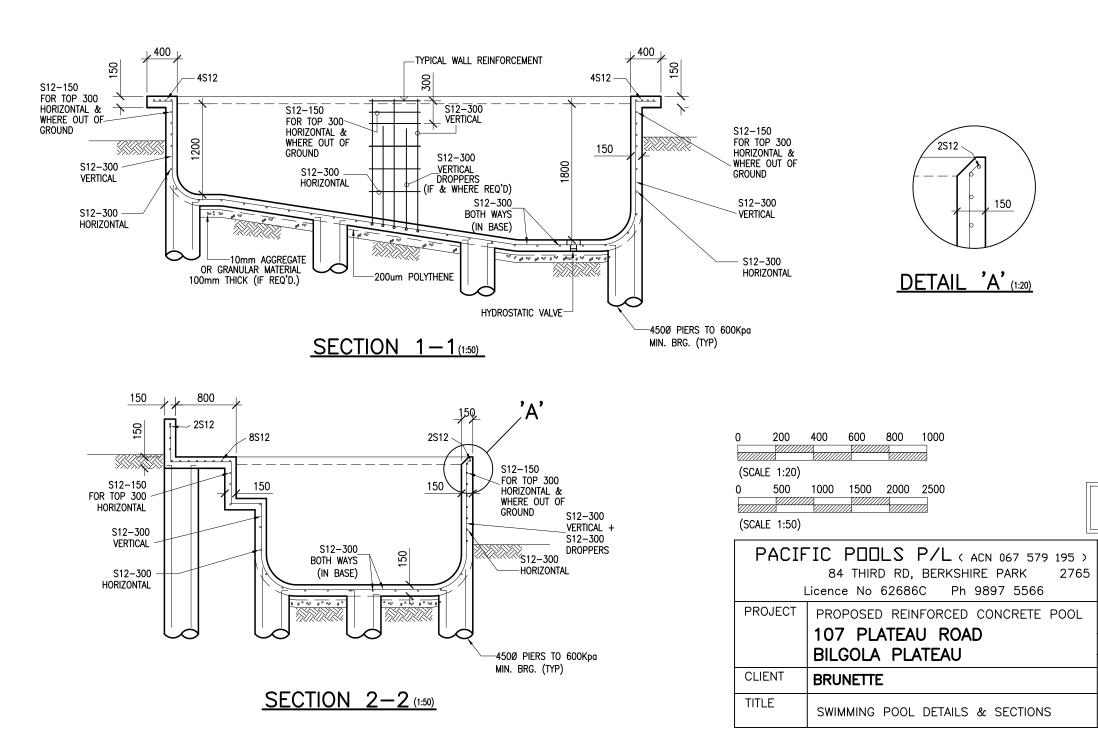

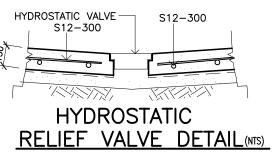

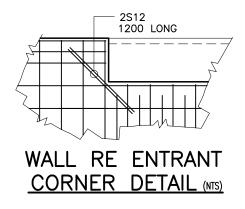

NOTE: SECTIONS 1-1 & 2-2 TAKE PREFERENCE OVER	STANDARD DE	TAILS		
J□HN CA∨ASINNI &		۶/۲		
CIVIL & STRUCTURAL ENGINEERING CO ACN 000 906 936	Phi 0620 1161	Aust		
P O BOX 22 HORSLEY PARK 2175 Mobile: 0418 25 8645 9 GIBSON LANE, HORSLEY PARK email: caveng@bigpond.com				
Drawn: MP	Scale: As noted			
Approved:	Date: MAY 2019	9		
Drawing No. 2019PF	R1400 2	2/2		

