

ACTION PLANS


m: 0426 957 518 e: operations@actionplans.com.au w: www.actionplans.com.au

DEVELOPMENT APPLICATION

SHEET NUMBER	SHEET NAME	DATE PUBLISHED
DA00	COVER	28/06/2021
DA01	SITE ANALYSIS	28/06/2021
DA02	SITE / ROOF / SEDIMENT EROSION / WASTE MANAGEMENT / STORMWATER CONCEPT PLAN	28/06/2021
DA03	EXISTING GROUND FLOOR PLAN	28/06/2021
DA04	EXISTING FIRST FLOOR PLAN	28/06/2021
DA05	PROPOSED GROUND FLOOR PLAN	28/06/2021
DA06	PROPOSED FIRST FLOOR PLAN	28/06/2021
DA07	WEST (STREET) / NORTH ELEVATION	28/06/2021
DA08	EAST / SOUTH ELEVATION	28/06/2021
DA09	LONG / CROSS SECTION	28/06/2021
DA10	DRIVEWAY PLAN & LONG SECTION	28/06/2021
DA11	POOL PLAN & LONG SECTION	28/06/2021
DA12	AREA CALCULATIONS	28/06/2021
DA13	SAMPLE BOARD	28/06/2021
DA14	FLOOR SPACE RATIO CALCULATIONS	28/06/2021
DA15	WINTER SOLSTICE 9 AM	28/06/2021
DA16	WINTER SOLSTICE 12 PM	28/06/2021
DA17	WINTER SOLSTICE 3 PM	28/06/2021
DA18	BASIX COMMITMENTS	28/06/2021
DA19	BASIX COMMITMENTS	28/06/2021

ITEM DETAILS	DEVELOPMENT APPLICATION									
ADDRESS	116 BEATRICE STREET, BALGOWLAH HEIGHTS	2093								
LOT & DP/SP	LOT 18 SEC B DP 2044									
COUNCIL	NORTHERN BEACHS COUNCIL (MANLY)									
SITE AREA	687m ²									
FRONTAGE	15.24m									
CONTROLS	PERMISSIBLE / REQUIRED	EXISTING	PROPOSED	COMPLIANCE						
CONTROLS	m / m² / %	m / m² / %	m / m² / %							
LEP										
LAND ZONING	R2 – GENERAL RESIDENTIAL	R2	R2	YES						
MINIMUM LOT SIZE	500m ²	687m ²	UNCHANGED	YES						
FLOOR SPACE RATIO	0:45: 1 (309.15m ²)	0.34: 1 (231.6m ²)	0.43: 1 (295.46m ²)	YES						
MAXIMUM BUILDING HEIGHT	8.5m	8.204m	8.433m	YES						
HAZARDS										
DCP										
RESIDENTIAL OPEN SPACE	AREA OS3									
TOTAL OPEN SPACE (TOS)	55% (377.85m²)	53.8% (369.93m ²)	57.3% (393.8m ²)	YES						
LANDSCAPE AREA	35% OF TOS (55%): 132.24m ²	76% (287.3m²)	59% (223.08m²)	YES						
PRINCIPAL PRIVATE OPEN SPACE	18m ²	37.11m ²	67.55m²	YES						
FRONT SETBACK	PREVALING BULDING LINE: 6.392m	10.795m	10.195m	YES						
REAR SETBACK	8.0m	8.672m	UNCHANGED	YES						
SIDE SETBACKS – GROUND FLOOR	0.9m	N: 0.177m S: 1.174m	N: 0.317m S: UNCHANGED	NO						
	1/3 OF WALL HEIGHT =									
SIDE SETBACKS – FIRST FLOOR	N: 2.351m	N: 8.205m	N: 2.628m	YES						
	S: 2.3m	S: 1.197m	S: 1.182m	NO						
CAR PARKING SPACES	Required: 1	1	2	YES						

116 BEATRICE STREET, BALGOWLAH HEIGHTS 2093

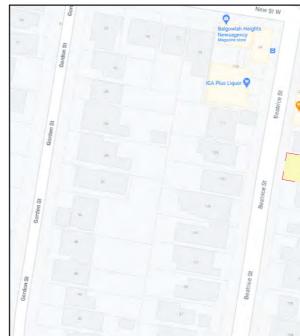


NCC & AS COMPLIANCES SPECIFICATIONS

- EARTHWORKS - PAR - EARTH RETAINING S - DRAINAGE - PART 3. - TERMITE-RISK MAN - FOOTINGS & SLAB - - MASONRY - PART 3.3 - FRAMING - PART 3.4 - SUB FLOOR VENTIL	6T 1. 40 P 3 (
- ROOF CLADDING AN	
- GLAZING - PART 3.6	
- FIRE SAFETY - PART	3
- FIRE SEPARATION O	F
- FIRE PROTECTION C	
- SMOKE ALARMS - PA	
- WET AREAS AND EX - ROOM HEIGHTS - PA	
- FACILITIES - PART 3.	
- LIGHT - PART 3.8.4 O	
- VENTILATION - PART	
- SOUND INSULATION	
- STAIRWAYAND RAM	
- BARRIERS AND HAN	
- SWIMMING POOLS -	
- CONSTRUCTION IN E - FENCING & OTHER F	
- DEMOLITION WORKS	
- WATERPROOFING O	
- ALL PLUMBING & DR	
- ALL PLASTERBOARD	
- ALL STRUCTURAL ST	TF
- ALL CONCRETE WOR	٦ł
- ALL CONCRETE WOR - ALL ROOF SHEETING - ALL SKYLIGHTS TO (3
- ALL SKYLIGHTS TO (20
- ALL CERAMIC TILING - ALL GLAZING ASSEM	
- ALL GLAZING ASSEN	
AS 1720.2-2006, AS 1	
- ALL RETAINING WAL	

New St W

3.1.1 OF NCC RUCTURES - PART 3.1.2 OF NCC .3 OF NCC GEMENT - PART 3.1.4 OF NCC PART 3.2 OF NCC INCLUDING AS 2870-2011 OF NCC INCLUDING AS 3700:2018 OF NCC TION - PART 3.4.1 OF NCC WALL-CLADDING - PART 3.5 OF NCC OF NCC INCLUDING AS 1288 3.7 OF NCC EXTERNAL WALLS - PART 3.7.2 OF NCC F SEPARATING WALLS AND FLOORS- PART 3.7.3 OF NCC RT 3.7.5 OF NCC ERNAL WATERPROOFING - PART 3.8.1 OF NCC RT 3.8.2 OF NCC .3 OF NCC NCC 3.8.5 OF NCC PART 3.8.6 OF NCC **CONSTRUCTION - PART 3.9.1 OF NCC** RAILS - PART 3.9.2 OF NCC PART 3.10.1 OF NCC USHFIRE PRONE AREAS - PART 3.10.5 OF NCC ROVISIONS - REGS & AS1926.1 2012 - AS2601-2001 THE DEMOLITION OF STRUCTURES. WET AREAS TO COMPLY WITH AS 3740-2010 AINAGE WORK TO COMPLY WITH AS 3500:2018 WORK TO COMPLY WITH AS 2588:2018 EEL WORK TO COMPLY WITH AS 4100-1992 & AS 1554 K TO COMPLY WITH AS 3600:2018 WORK TO COMPLY WITH AS 1562.1-2018 OMPLY WITH AS 4285-2019 TO COMPLY WITH AS 3958.1-2007 & 3958.2-1992 BLIES TO COMPLY WITH AS 2047-2014 & 1288 NG WALLS ARE TO COMPLY WITH AS 1720.1-2010, 20.4-2006, AS 1170.1-2002 & AS 1170.4-2007 S ARE TO COMPLY WITH 3700:2018 & AS 3600:2018 - ALL CONSTRUCTION TO COMPLY WITH AS 3959:2018

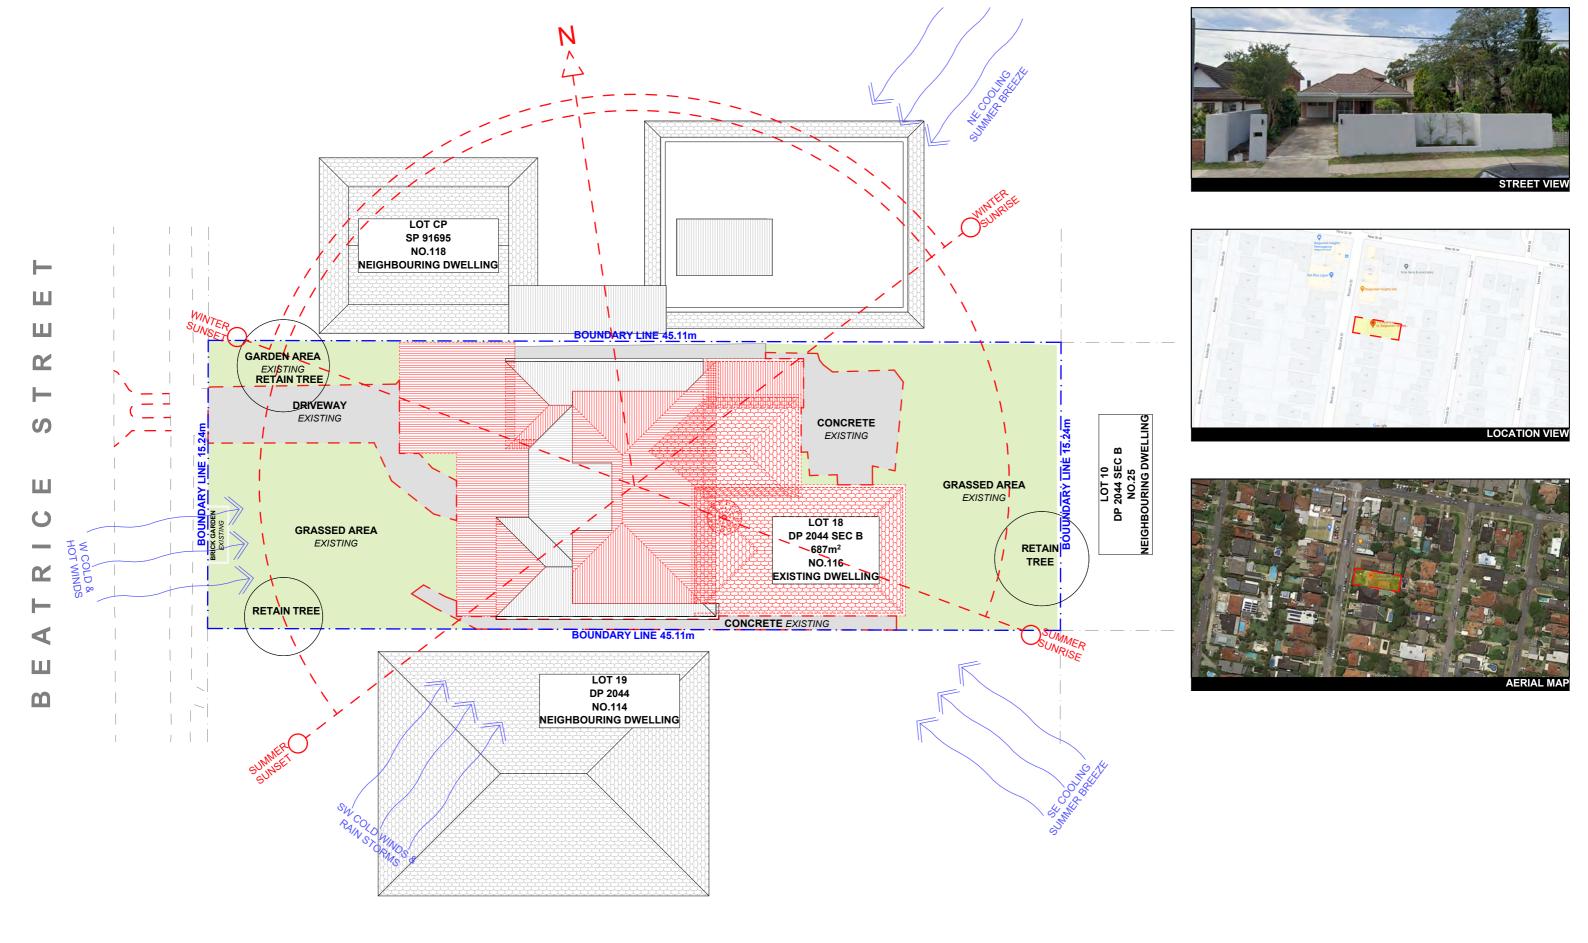

1	:	SITE		YSIS		1:200		N	OTE: ALL DEMO
		REV.	DATE	COMMENTS	DRWN	NOTES This drawing is the copyright of Action Plans and not be	LEGEND	CLIENT	DRAWING NO
	ACTION PLANS m: 0426 957 518 e:operations@actionplans.com.au w: www.actionplans.com.au	A	23.06.2021	DA	DLR	altered, reproduced or transmitted in any form or by any means in part or in whole with the written permission of Action Plans. Do not scale measure from drawings. Figured dimensions are to be used only. The Builder/Contractor shall check and verify all levels and dimensions on site prior to commencement of any work, creation of shop drawings, or fabrication of components.	DEMOLISHED GRASSED AREA	KLARA & DAVE ELLETT PROJECT ADDRESS 116 BEATRICE STREET,	DA01 DATE Monday, 28 Ju
	·					All errors and omissions are to be verified by the Builder/Contractor and referred to the designer prior to the commencement of works.	1	BALGOWLAH HEIGHTS 2093	

DEMOLISHED ELEMENTS TO ENG. SPECIFICATIONS AND AS. 2601 - 2001


ING NO.

DRAWING NAME SITE ANALYSIS




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1:200 @A3

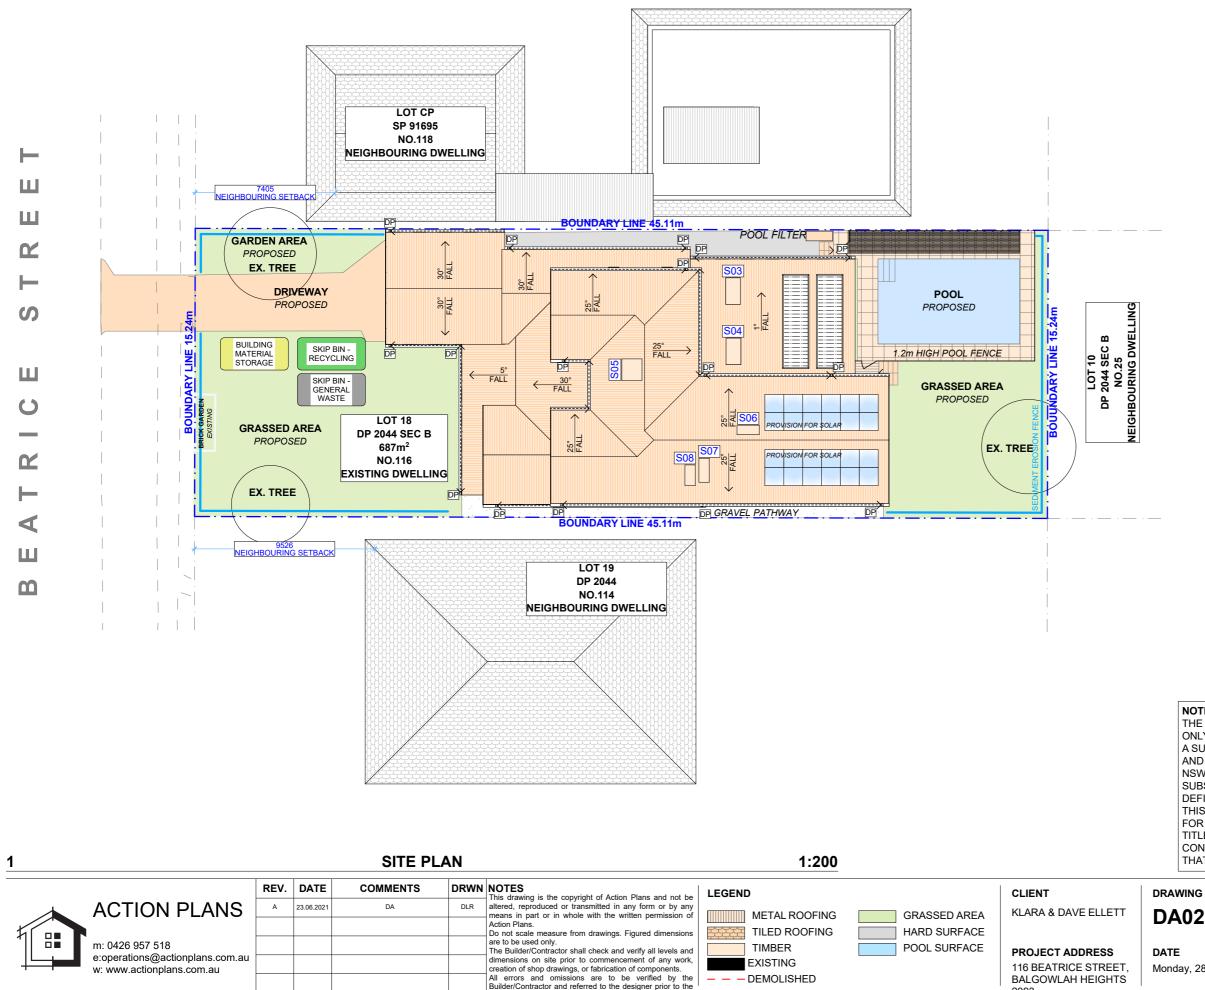

mencement of works.

THE INFORMATION SHOWN ON THIS PLAN IS FOR DESIGN PURPOSES ONLY. THE POSITION OF BOUNDARY LINES HAVE BEEN ESTABLISHED BY A SURVEY TO MEET THE IDENTIFICATION REQUIREMENTS FOR COUNCIL AND NOT FOR REGISTRATION WITH THE LAND REGISTRATION SERVICES NSW NOR MAY THIS PLAN BE USED FOR ANY OTHER PURPOSE. SUBSEQUENT REGISTERED OR OTHER SURVEYS MAY AFFECT THE DEFINED BOUNDARY POSITIONS IN THIS AREA. ANY DIFFERENCES OF THIS NATURE ARE BEYOND THE PURPOSES OF THIS PLAN. THIS PLAN IS FOR THE ABOVE STATED PURPOSES ONLY. RESTRICTIONS ON THE TITLE HAVE NOT BEEN INVESTIGATED. IF FURTHER DEVELOPMENT IS CONTEMPLATED OR CONSTRUCTION INTENDED THEN IT IS IMPORTANT THAT A SURVEY SET OUT IS CARRIED OUT.

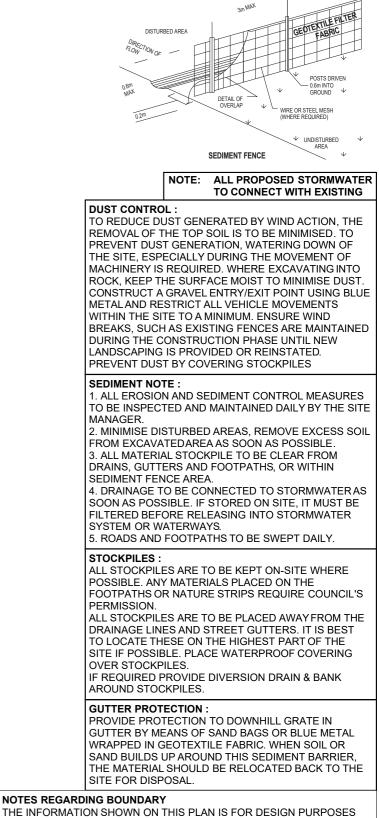

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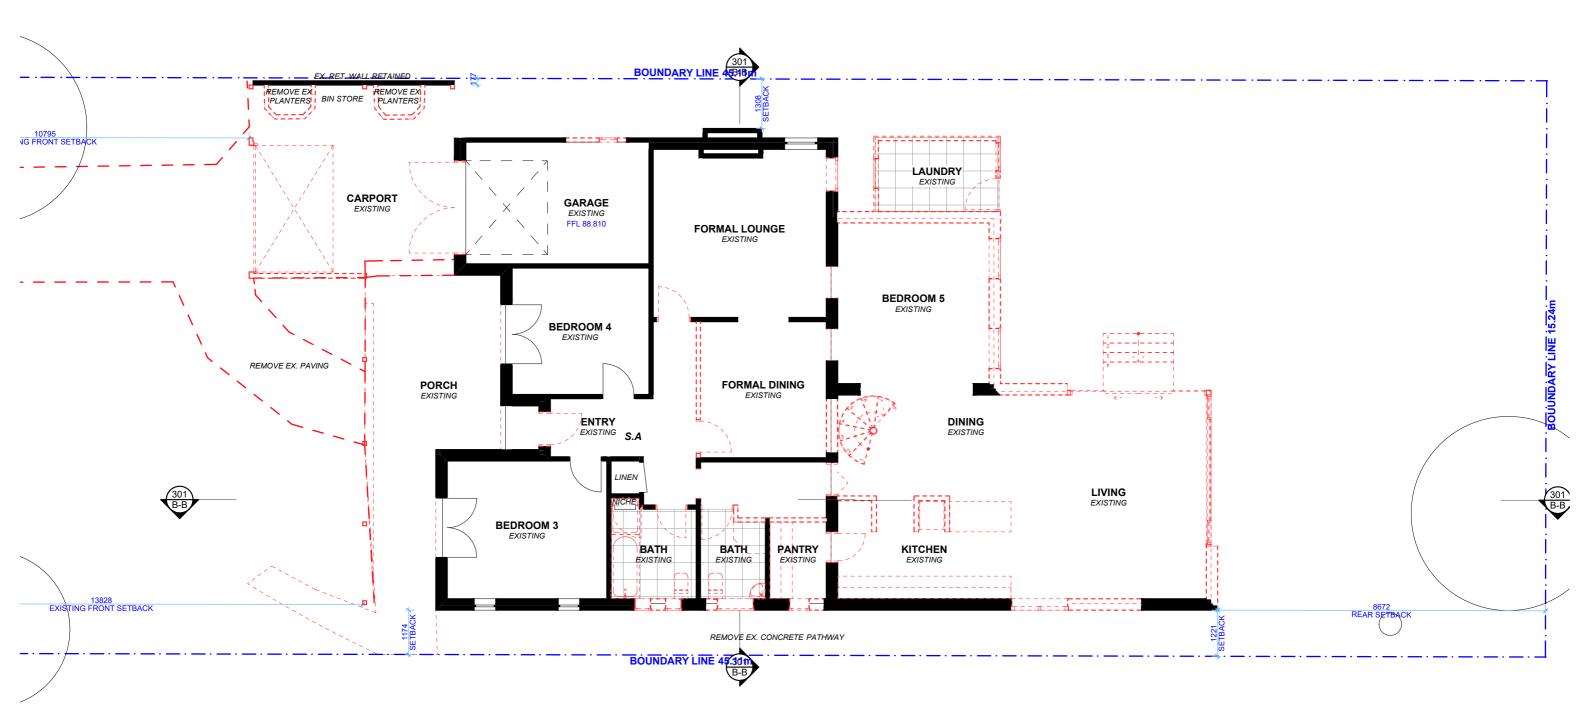
DRAWING NAME


2093

SITE / ROOF / SEDIMENT EROSION / WASTE MANAGEMENT / STORMWATER CONCEPT PLAN

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Monday, 28 June 2021



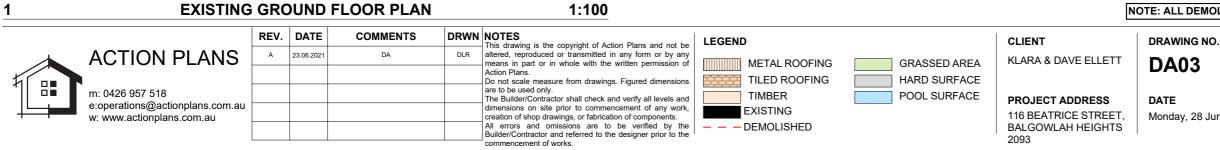



NOTE: ALL DEMOLISHED ELEMENTS TO ENG. SPECIFICATIONS AND AS. 2601 - 2001

DRAWING NAME EXISTING GROUND FLOOR PLAN



SCALE 1:100 @A3 Monday, 28 June 2021

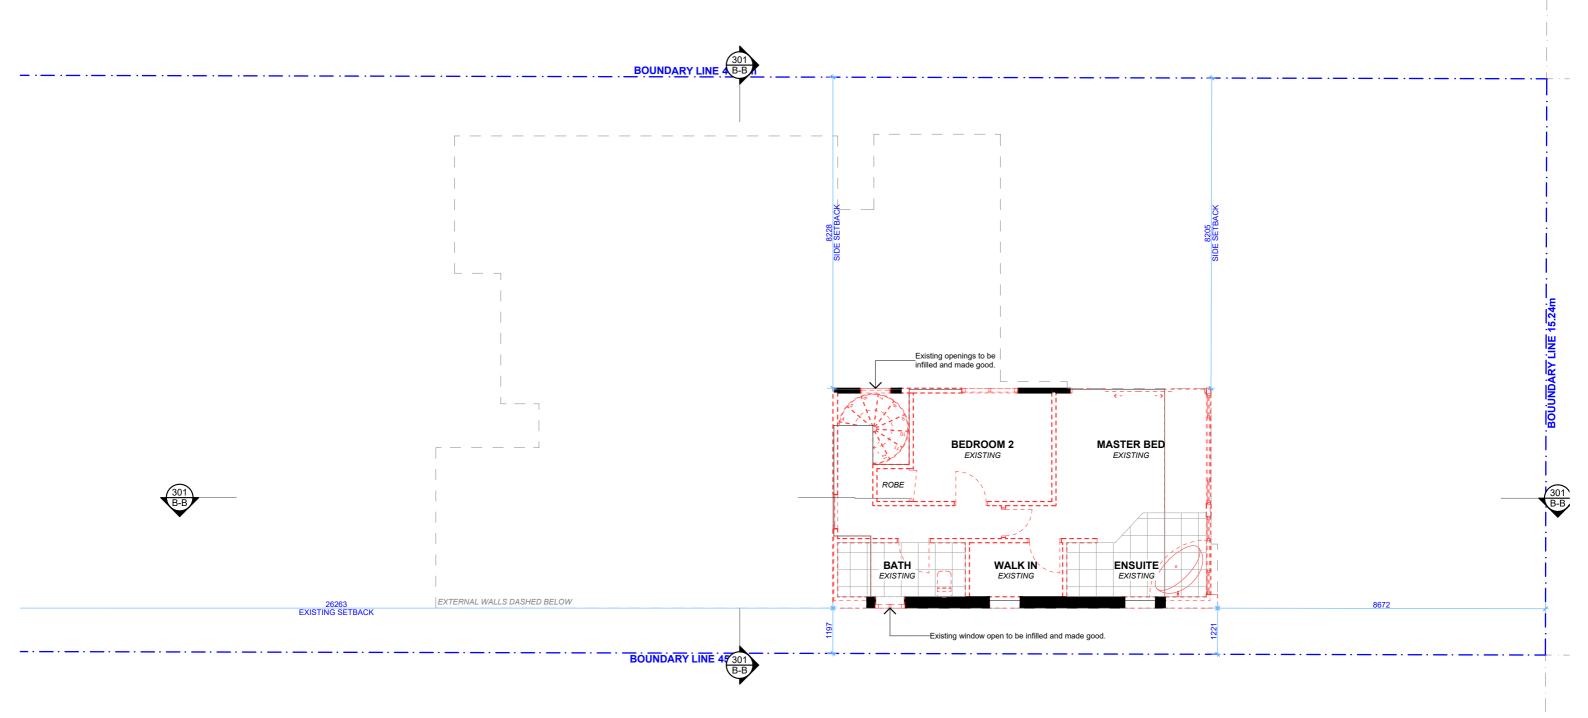


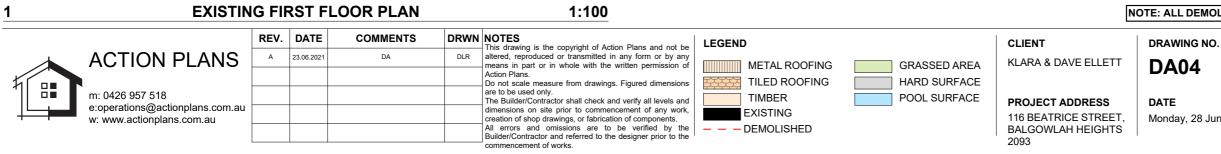

NOTE: ALL DEMOLISHED ELEMENTS TO ENG. SPECIFICATIONS AND AS. 2601 - 2001


DRAWING NAME EXISTING FIRST FLOOR PLAN




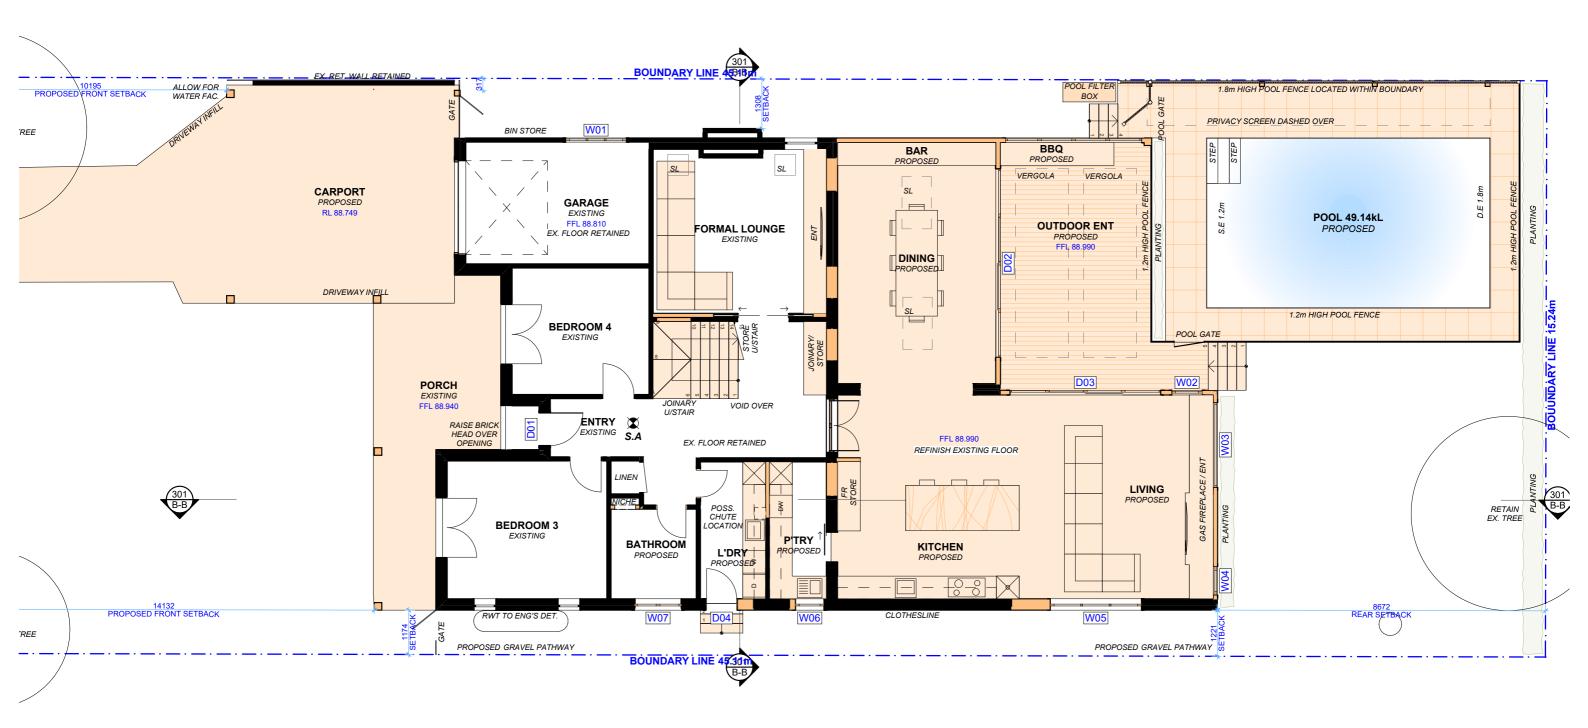




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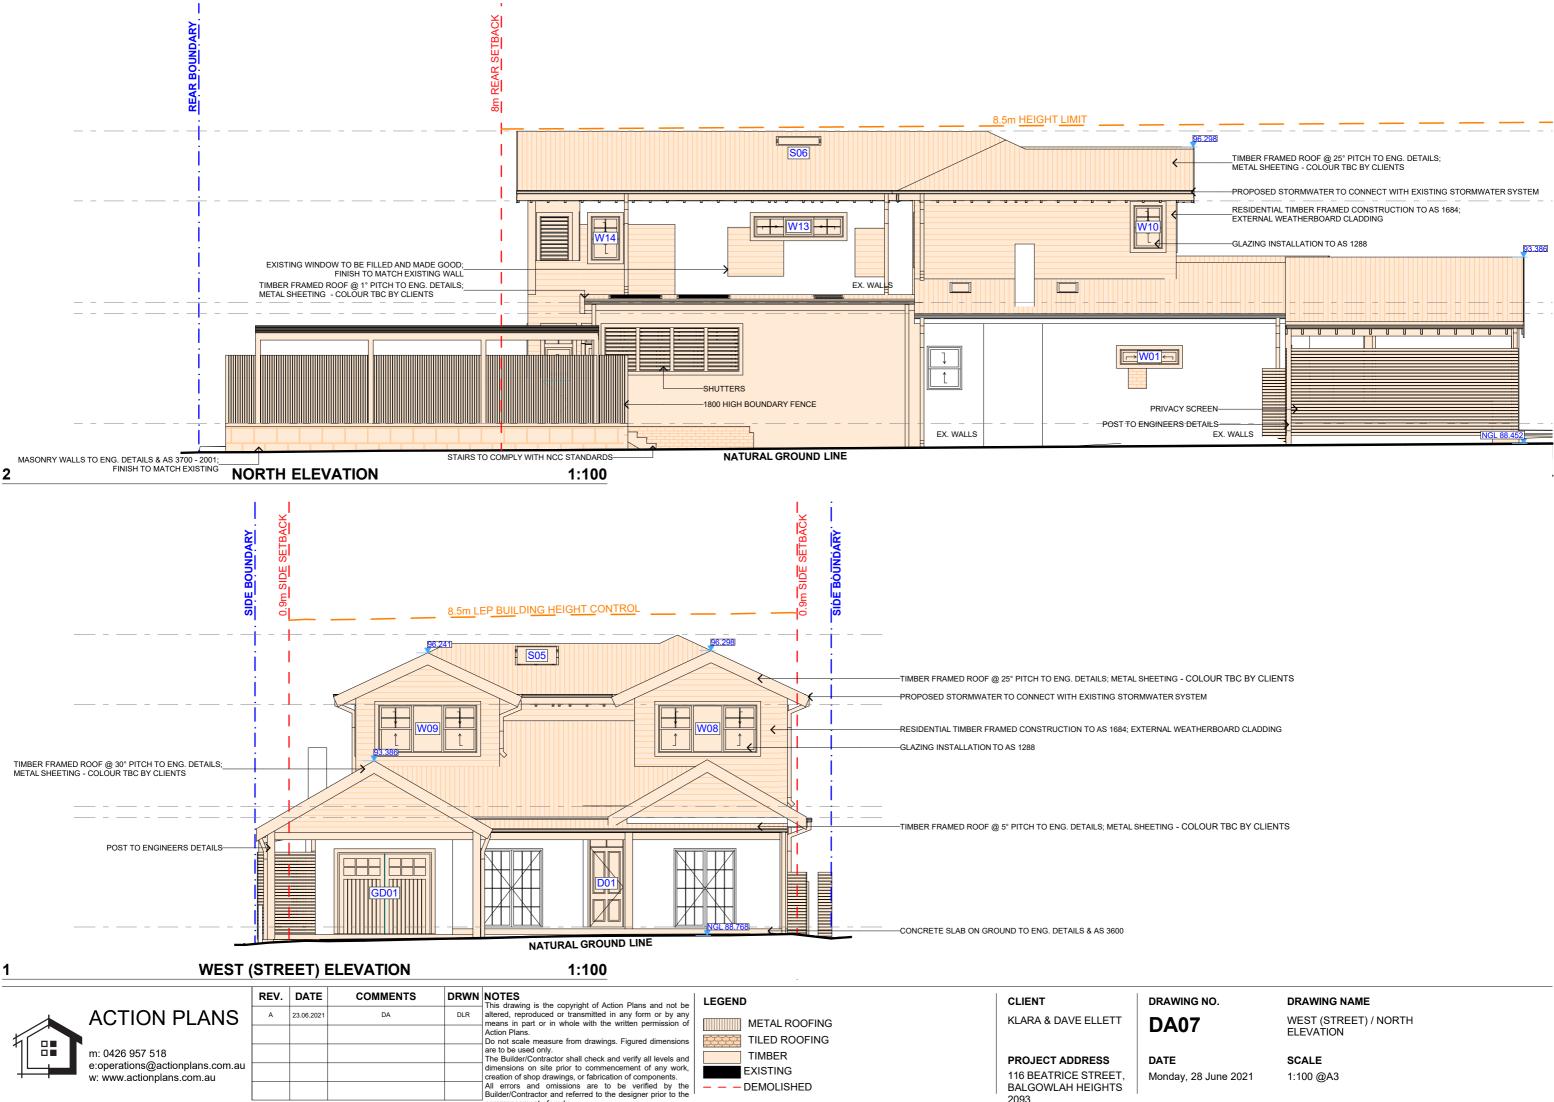


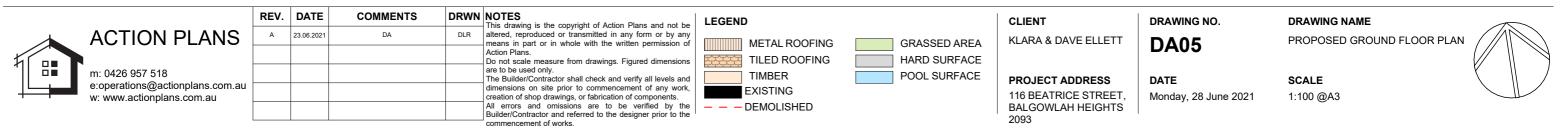

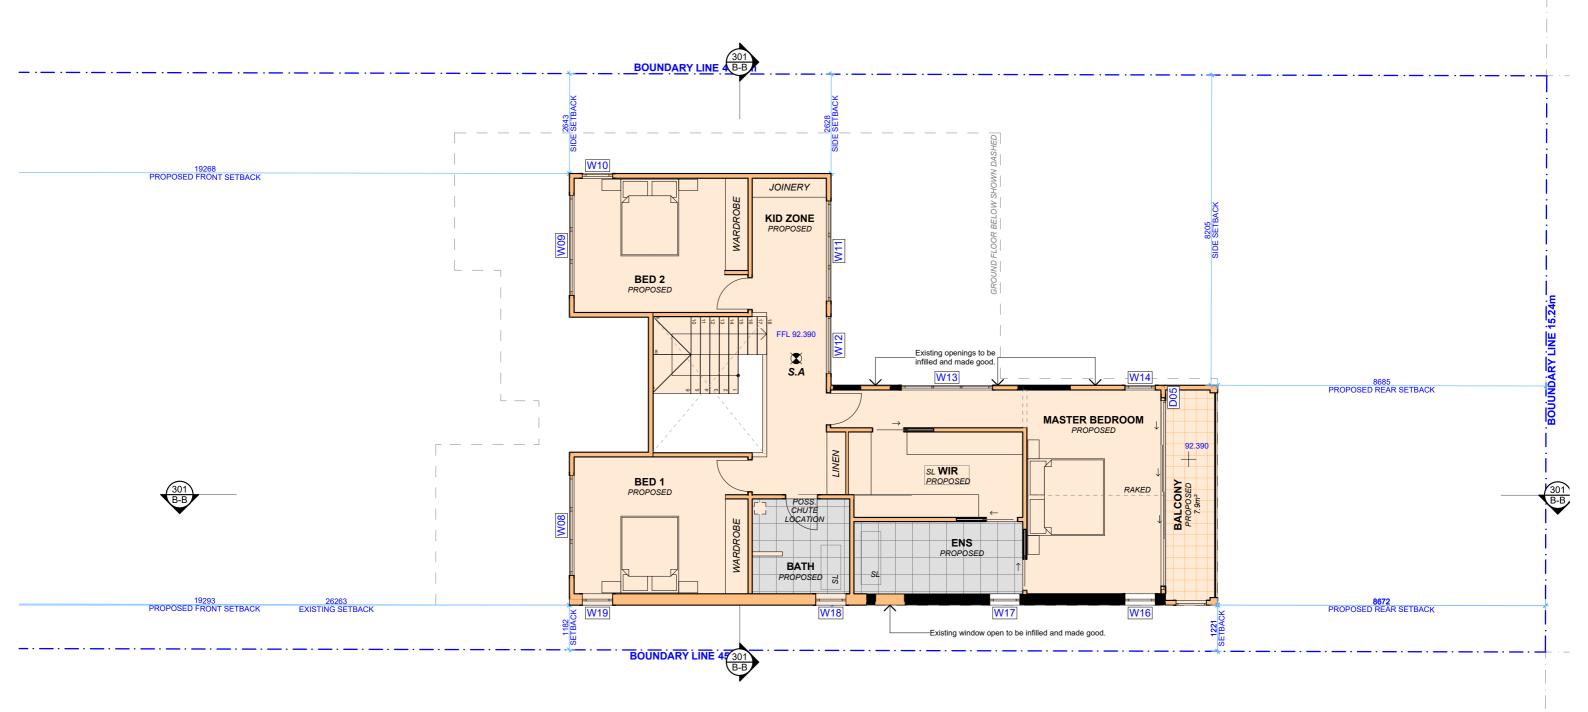DRAWING NAME PROPOSED FIRST FLOOR PLAN

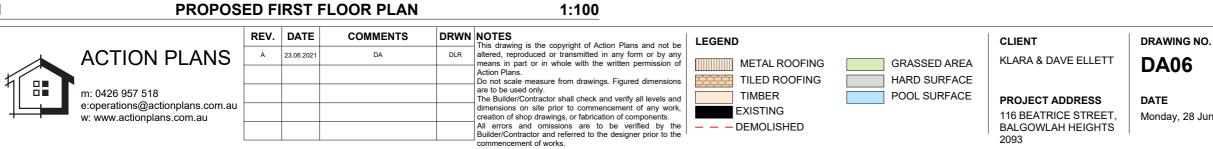



Monday, 28 June 2021



commencement of works.


2093

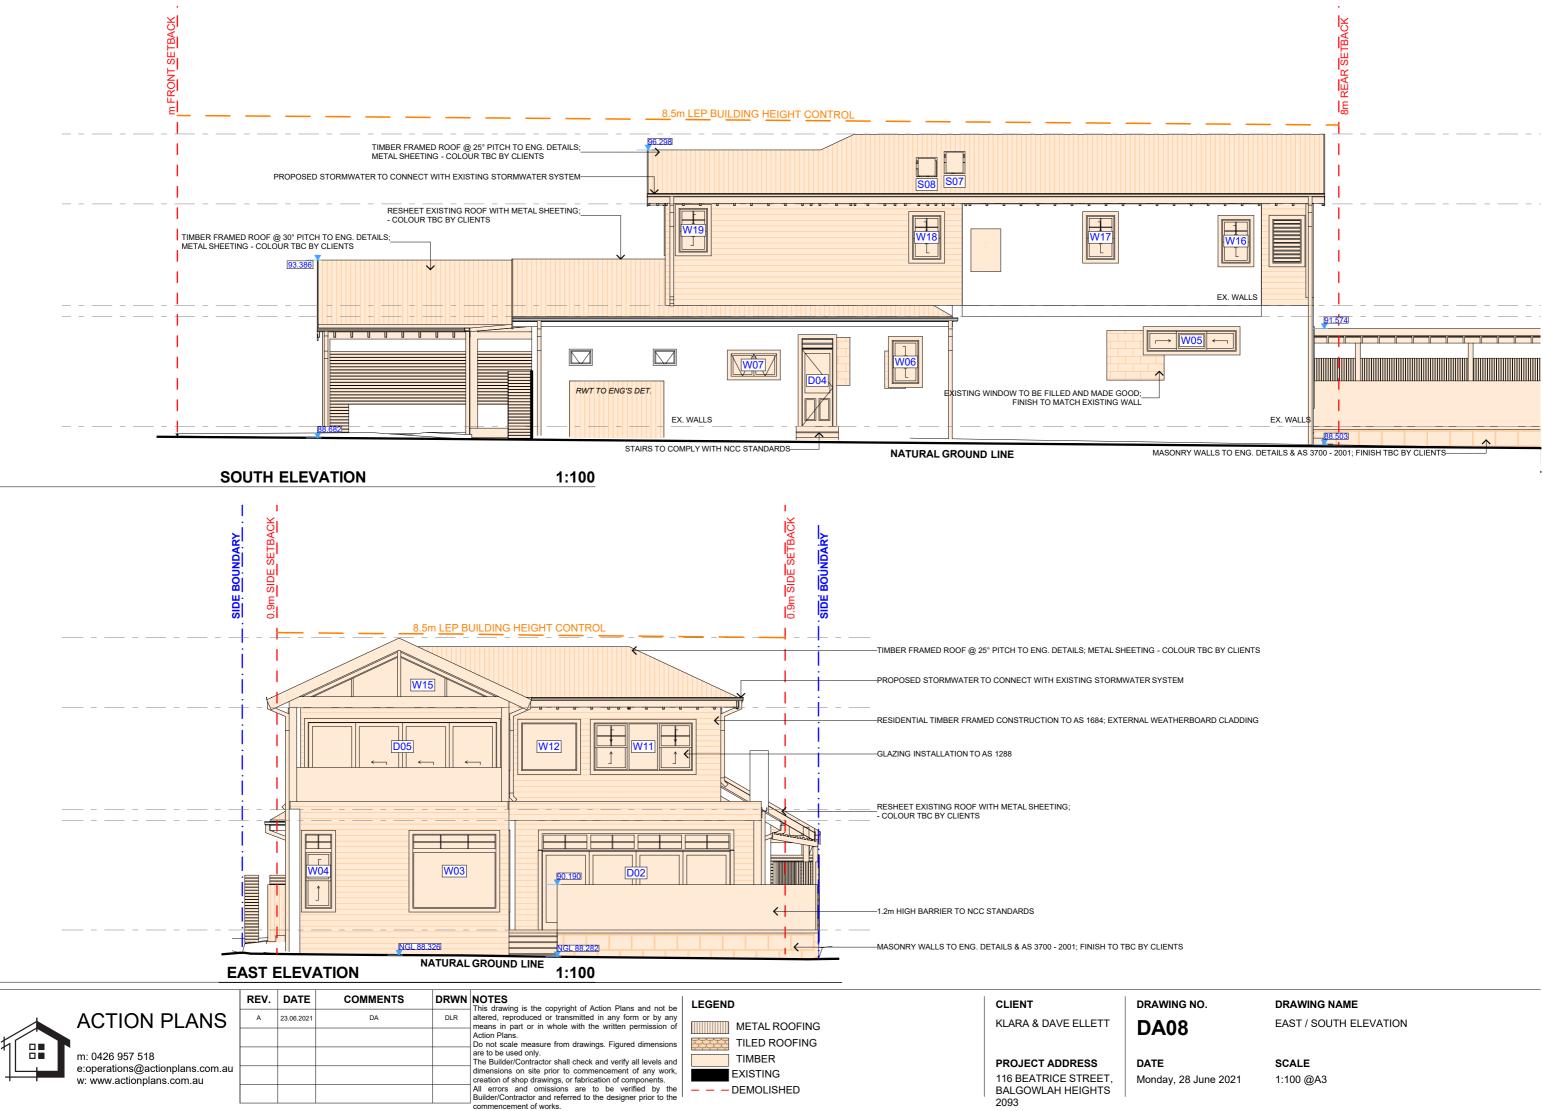


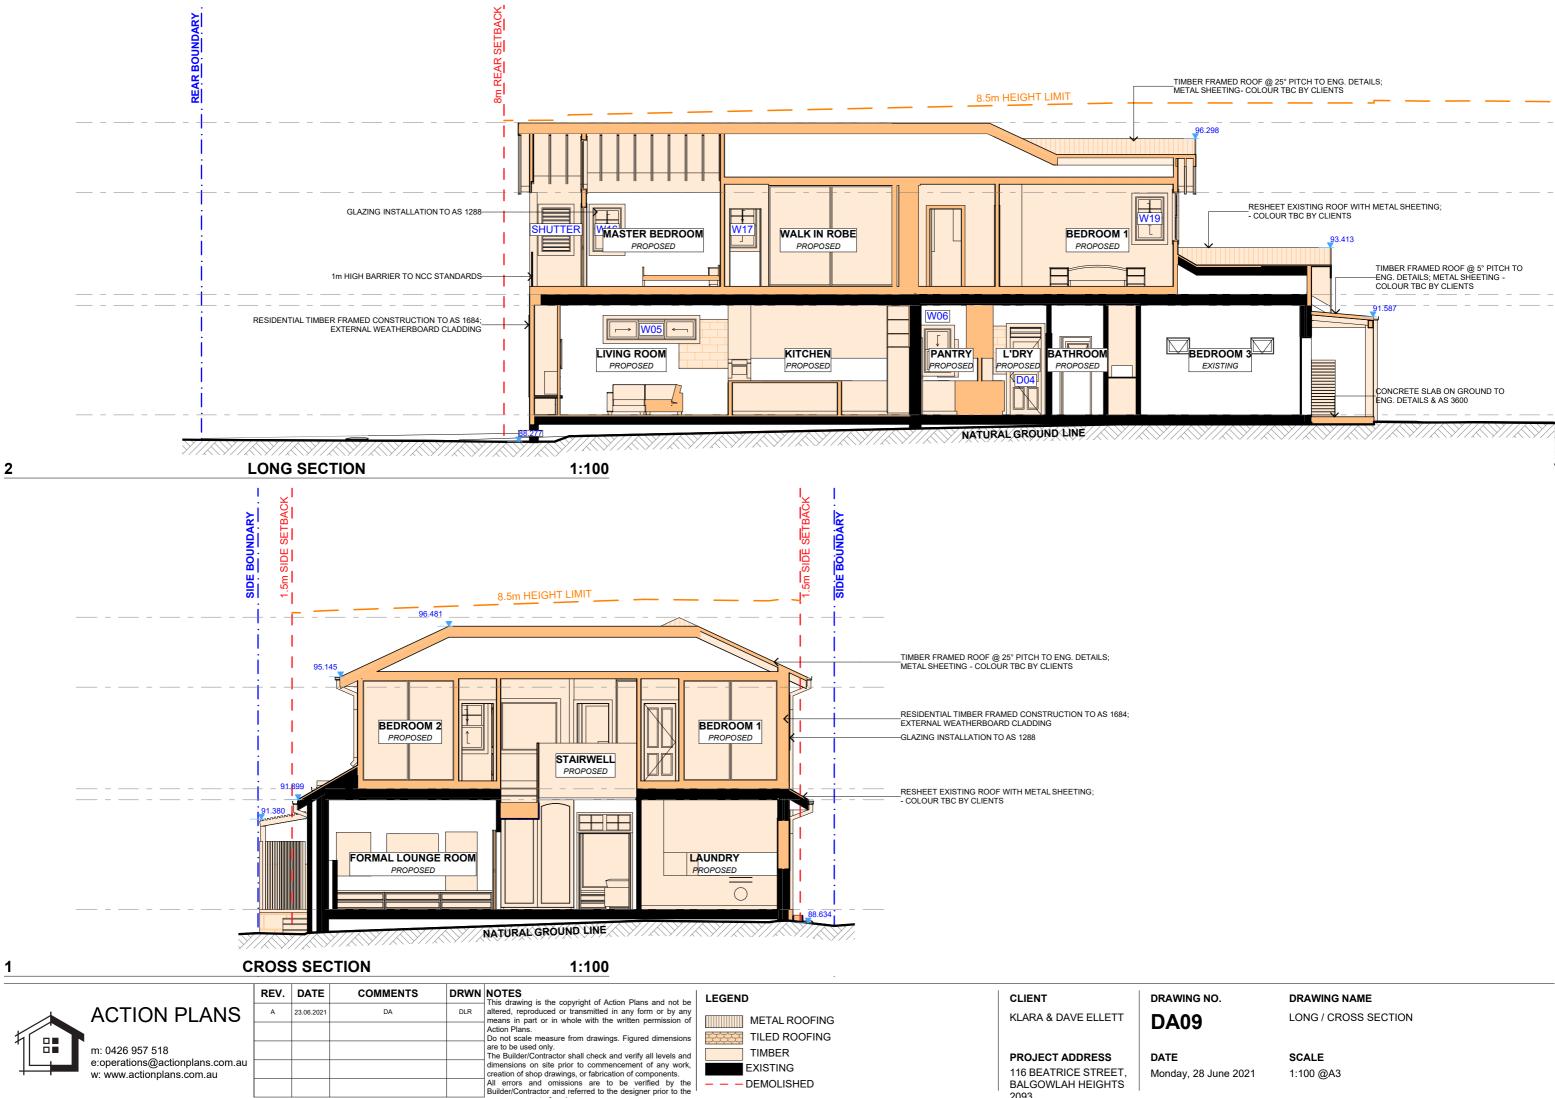

mmencement of works.

2093

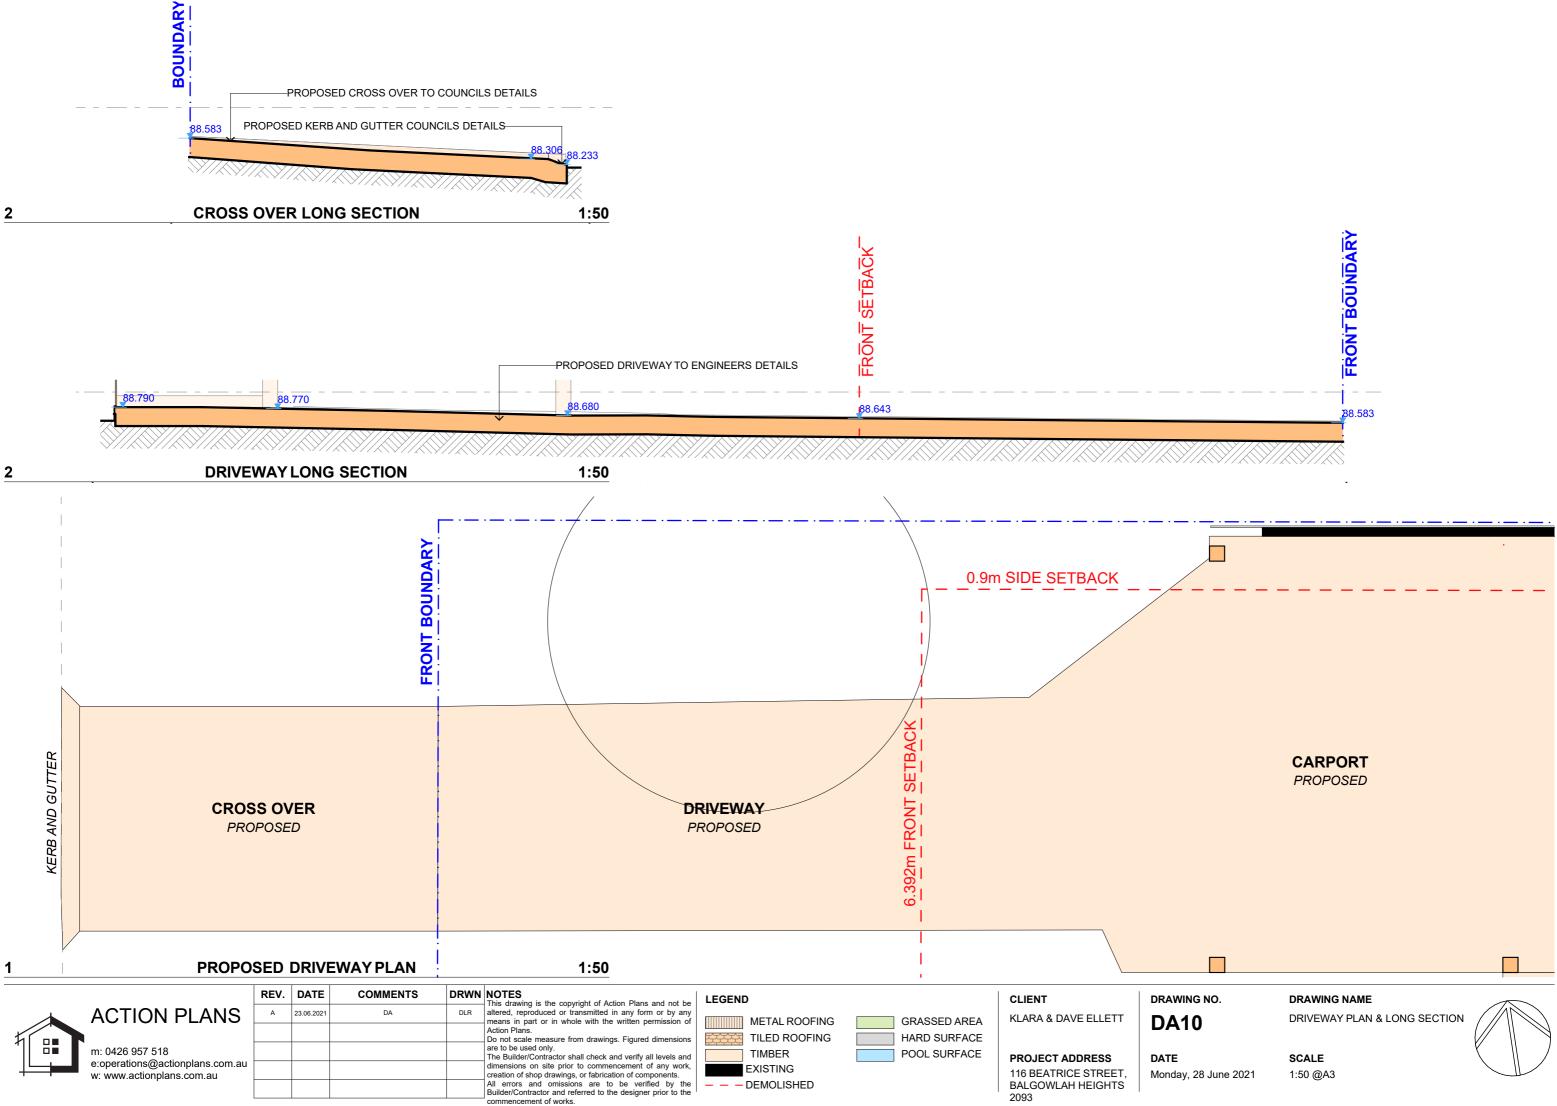

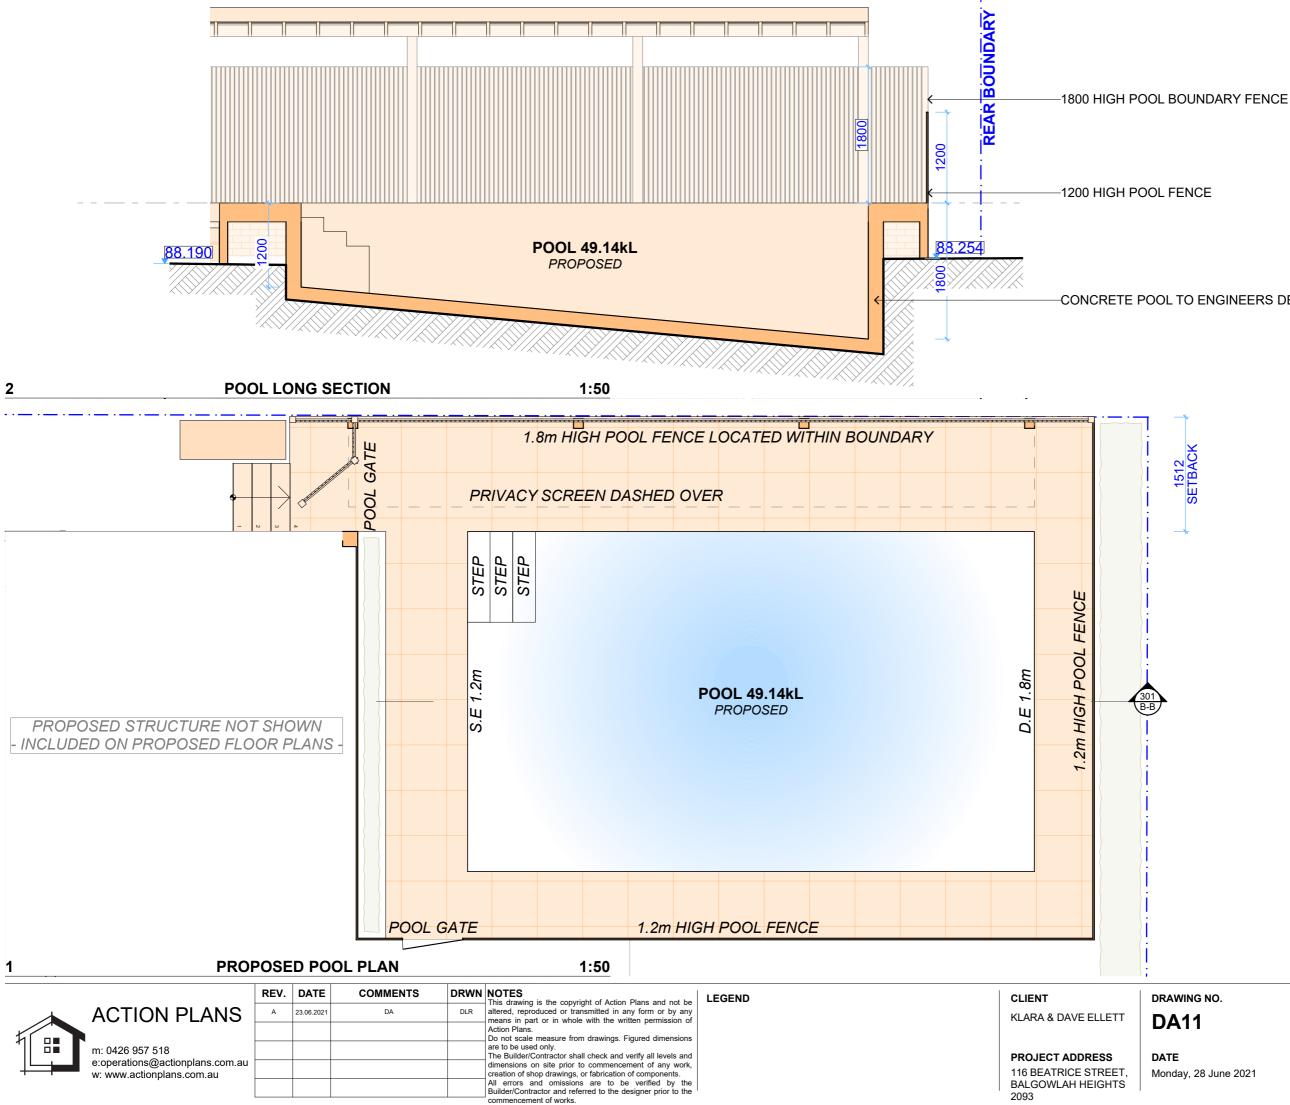


-CONCRETE POOL TO ENGINEERS DETAILS

DRAWING NAME POOL PLAN & LONG SECTION



Monday, 28 June 2021


SCALE 1:50 @A3

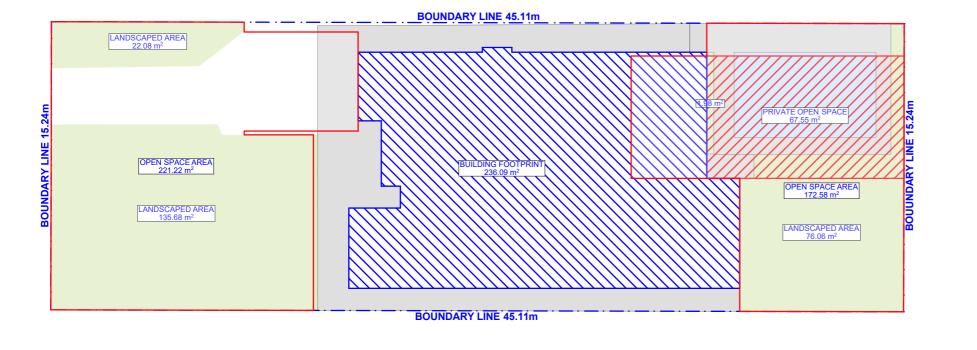

SITE AREA 687m²

PRIVATE OPEN SPA TOTAL OPEN SPAC LANDSCAPED ARE

PROPOSED AREA CALCULATIONS 1:200 2

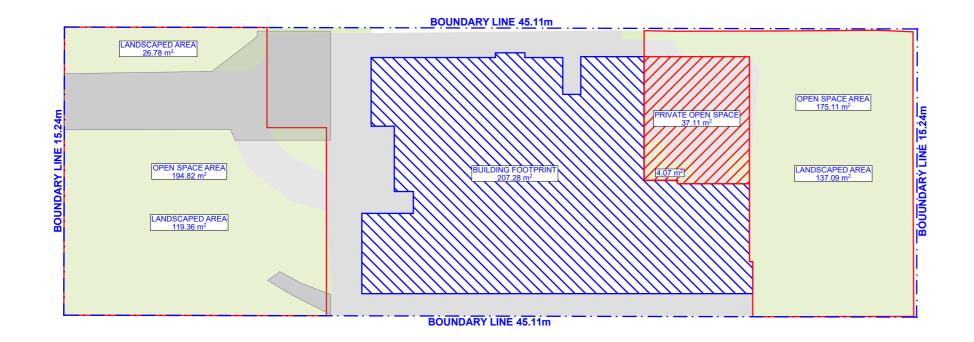

EXISTING AREA CALCULATONS

1	1	EXISTING	G AR	EACA	LCULATONS		1:200				
_			REV.	DATE	COMMENTS	DRWN	NOTES This drawing is the copyright of Action Plans and not be	LEGEND		CLIENT	DRAWING NO
		ACTION PLANS	A	23.06.2021	DA	DLR	altered, reproduced or transmitted in any form or by any means in part or in whole with the written permission of	BUILDING FOOTPRINT	POOL SURFACE	KLARA & DAVE ELLETT	DA12
							Action Plans. Do not scale measure from drawings. Figured dimensions	TOTAL OPEN SPACE			DAIZ
		m: 0426 957 518					are to be used only. The Builder/Contractor shall check and verify all levels and			PROJECT ADDRESS	DATE
	╷└──╞━━┛	e:operations@actionplans.com.au w: www.actionplans.com.au					dimensions on site prior to commencement of any work, creation of shop drawings, or fabrication of components.	HARD SURFACE		116 BEATRICE STREET,	Monday, 28 Ju
							All errors and omissions are to be verified by the Builder/Contractor and referred to the designer prior to the	PRIVATE OPEN SPACE		BALGOWLAH HEIGHTS	,,,,,,,,,,,,,,,,,,,,,,,,,,,,,,,,,,,,,,,
							commencement of works.			2093	

CONTROL TABLE

REQUIRED

ACE	18m ²
E	55% (377.85m ²)
A	35% (132.24m ²)

PROPOSED


67.55m² 57.3% (393.8m²) 59% (223.08m²)

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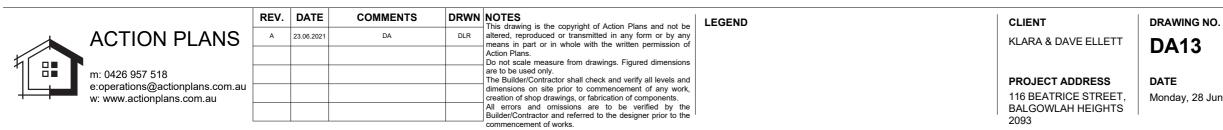
DRAWING NAME AREA CALCULATIONS



ay, 28 June 2021



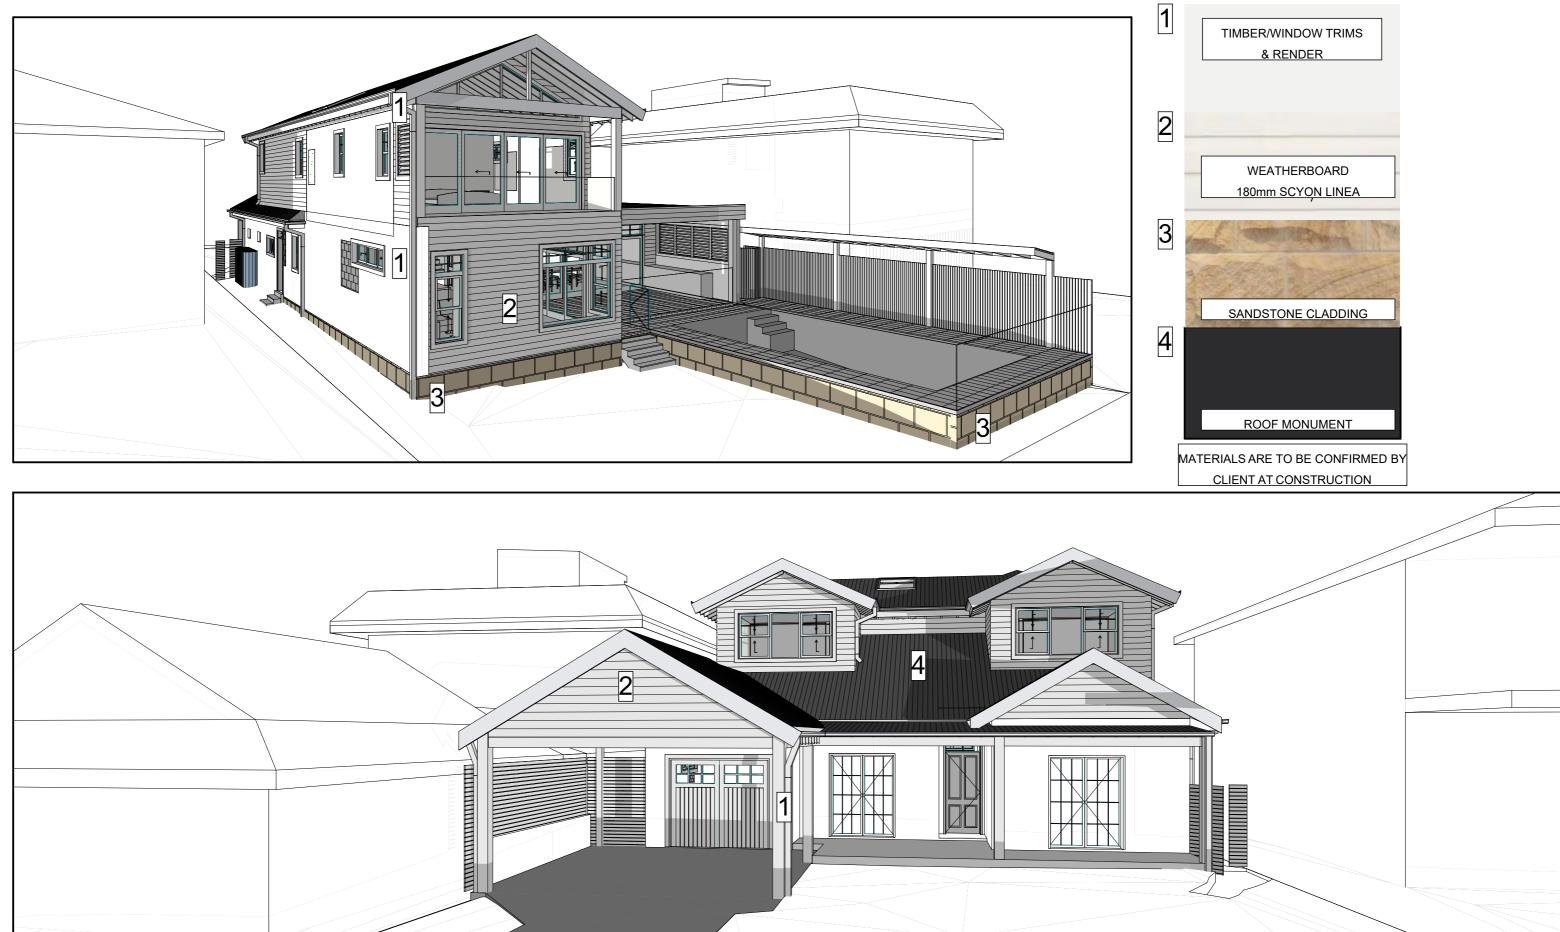




DRAWING NAME SAMPLE BOARD

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SCALE @A3

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m: 0426 957 518 e:operations@actionplans.com.au w: www.actionplans.com.au					Do not scale measure from drawings. Figured dimensions are to be used only. The Builder/Contractor shall check and verify all levels and dimensions on site prior to commencement of any work, creation of shop drawings, or fabrication of components. All errors and omissions are to be verified by the Builder/Contractor and referred to the designer prior to the commencement of works.	PROJECT ADDRESS 116 BEATRICE STREET, BALGOWLAH HEIGHTS 2093	DATE Monday, 28 Ju

2

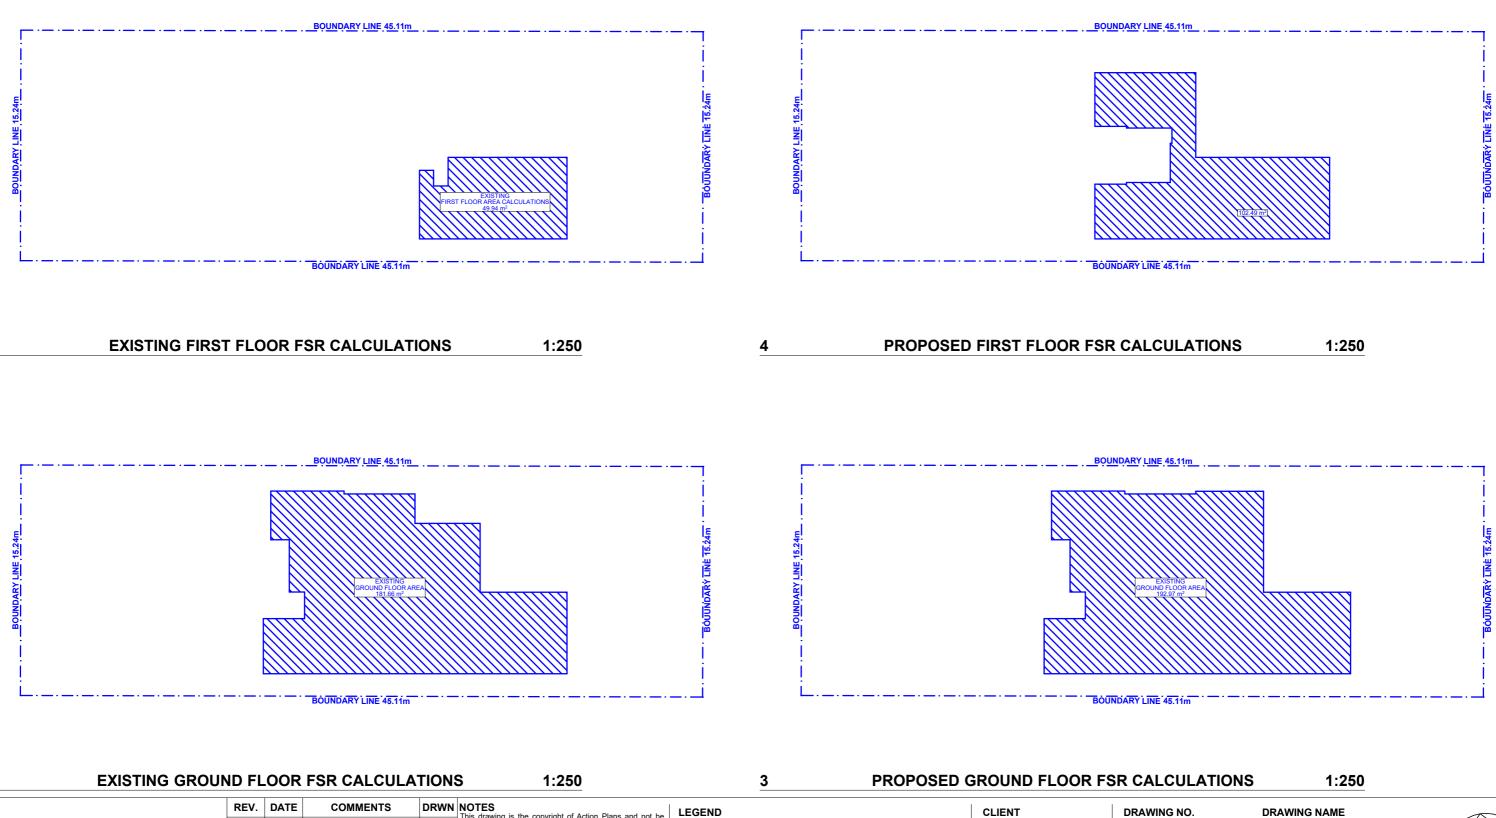1

CONTROL TABLE

REQUIRED

PROPOSED


0.45:1 (309.15m²)

0.43:1 (295.45m²)

FLOOR SPACE RATIO CALCULATIONS




28 June 2021

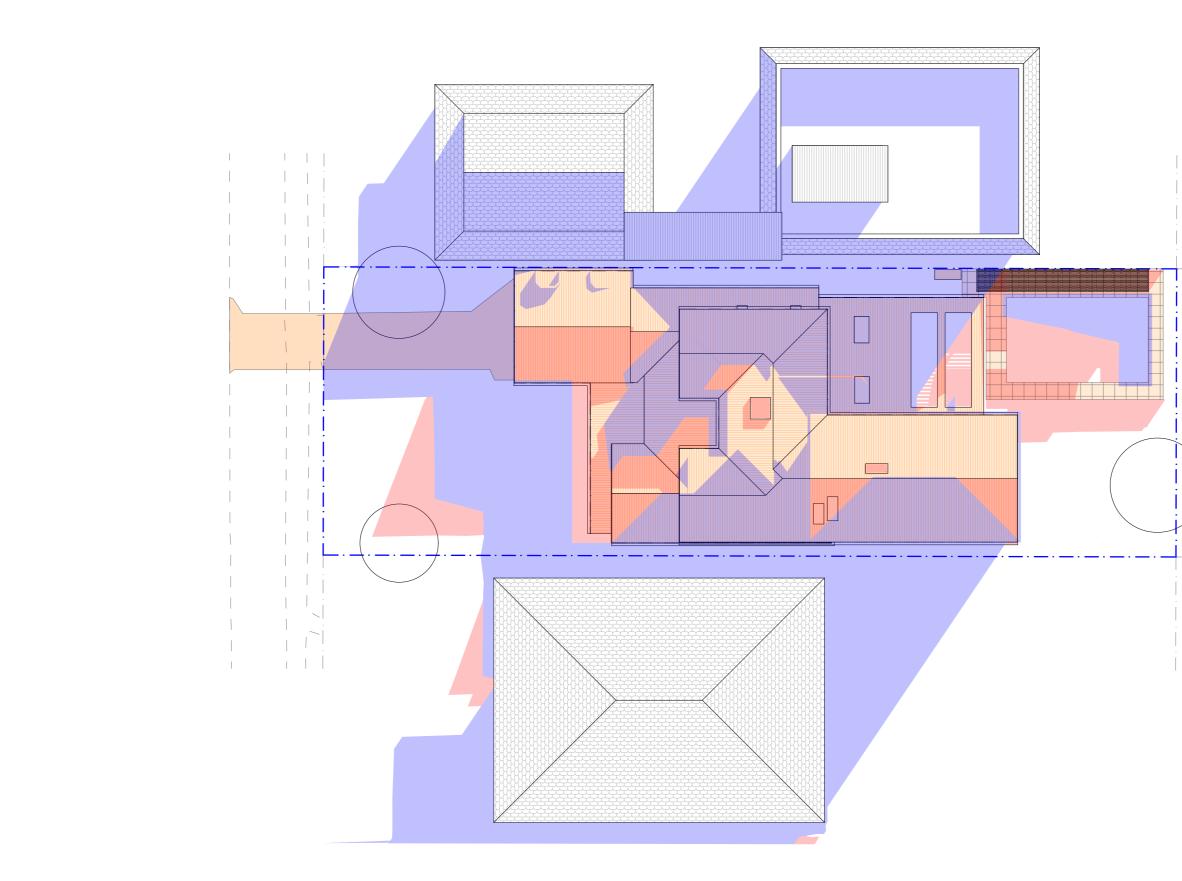




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DRAWING NAME WINTER SOLSTICE 9 AM

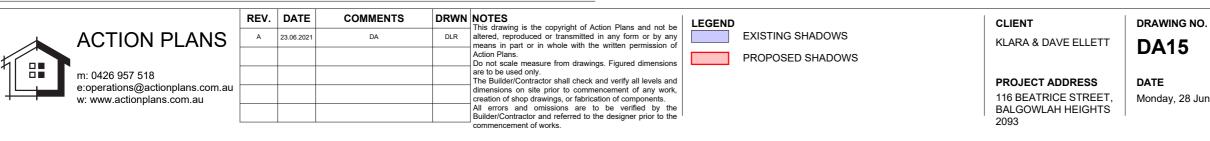


Monday, 28 June 2021



WINTER SOLSTICE - 1200

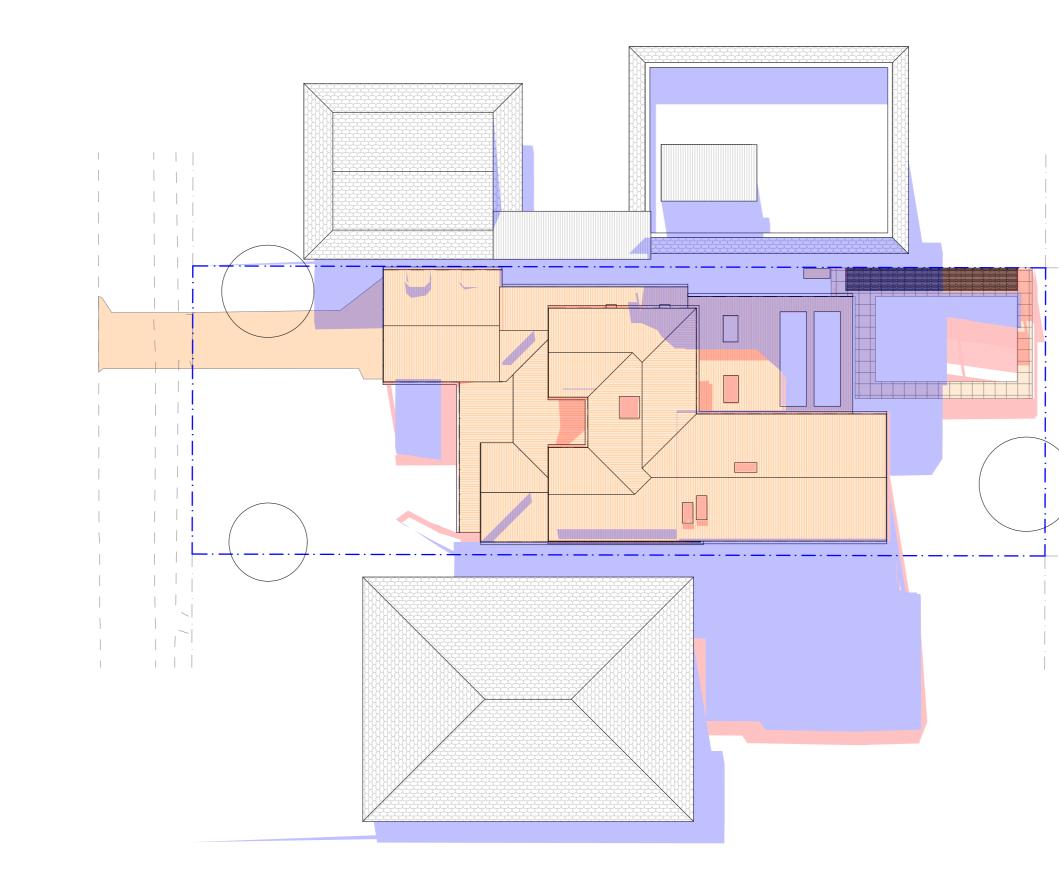
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DRAWING NAME WINTER SOLSTICE 12 PM

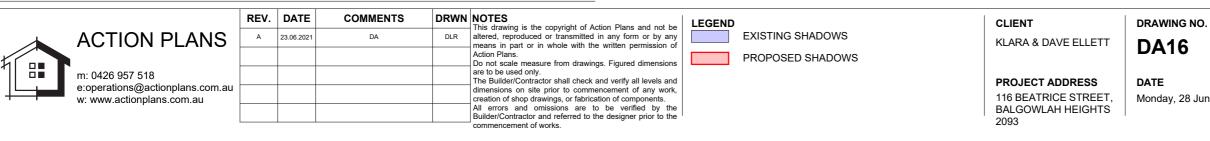


Monday, 28 June 2021



WINTER SOLSTICE - 1500

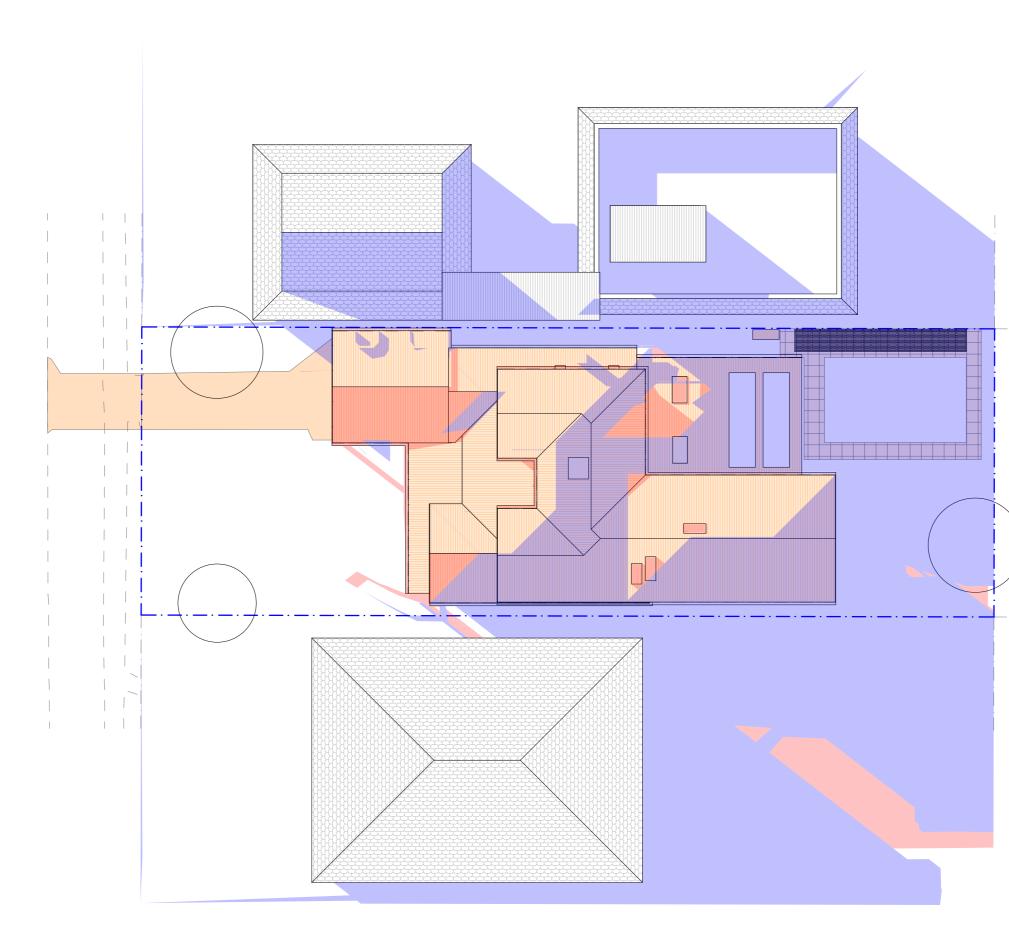1:200

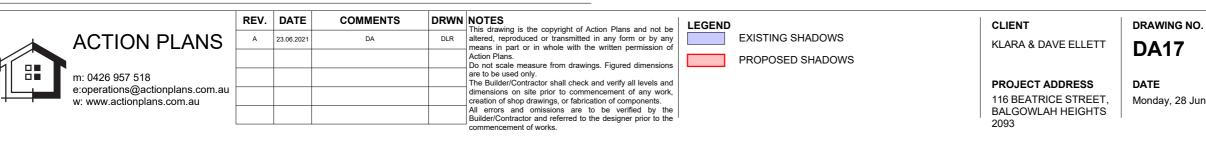

DRAWING NAME WINTER SOLSTICE 3 PM



Monday, 28 June 2021

BASIX[°]Certificate

Building Sustainability Index www.basix.nsw.gov.au

Alterations and Additions

Certificate number: A413009_02

This certificate confirms that the proposed development will meet the NSW government's requirements for sustainability, if it is built in accordance with the commitments set out below. Terms used in this certificate, or in the commitments, have the meaning given by the document entitled "BASIX Alterations and Additions Definitions" dated 06/10/2017 published by the Department. This document is available at www.basix.nsw.gov.au

Secretary Date of issue: Thursday, 24, June 2021 To be valid, this certificate must be lodged within 3 months of the date of issue.



BASIX Certificate number: A413009_02

BASIX Certificate number: A413009_02

Ū	Project address	
O	Project name	0768_116 BEATRICE ST, BALGOWLAH HEIG_02
proje	Street address	116 BEATRICE Street BALGOWLAH HEIGHTS 2093
ō	Local Government Area	Northern Beaches Council
	Plan type and number	Deposited Plan 2044
of	Lot number	18
_	Section number	В
o	Project type	
Ċ	Dwelling type	Separate dwelling house
scription	Type of alteration and addition	My renovation work is valued at \$50,000 or more, and includes a pool (and/or spa).
Des		

Certificate Prepared by (please complete before submitting to Council or PCA)

Name / Company Name: Action Plans ABN (if applicable): 17118297587

Construction	Show on DA Plans	Show on CC/CDC Plans & specs	Certifier Check		
nsulation requirements					
The applicant must construct the new or altere the table below, except that a) additional insula s not required for parts of altered construction	~	~	~		
Construction	Additional insulation required (R-value)	Other specifications			
suspended floor with enclosed subfloor: framed (R0.7).	R0.60 (down) (or R1.30 including construction)				
suspended floor above garage: framed (R0.7).	nil				
floor above existing dwelling or building.	nil				
external wall: brick veneer	R1.16 (or R1.70 including construction)				
external wall: framed (weatherboard, fibro, metal clad)	R1.30 (or R1.70 including construction)				
flat ceiling, pitched roof	ceiling: R1.45 (up), roof: foil backed blanket (75 mm)	medium (solar absorptance 0.475 - 0.70)			
raked ceiling, pitched/skillion roof: framed	ceiling: R1.74 (up), roof: foil backed blanket (75 mm)	medium (solar absorptance 0.475 - 0.70)			

BASIX Certificate number: A413009_02 Glazing requirements

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page 3 / 9

page 5 / 9

Certifier Check

Show on DA Plans CC/CDC Plans &

page 4 / 9

Pool and Spa	Show on DA Plans	Show on CC/CDC Plans & specs	Certifier Check
Rainwater tank			
The applicant must install a rainwater tank of at least 1711 litres on the site. This rainwater tank must meet, and be installed in accordance with, the requirements of all applicable regulatory authorities.	~	\checkmark	~
The applicant must configure the rainwater tank to collect rainwater runoff from at least 128.09 square metres of roof area.		\checkmark	\checkmark
The applicant must connect the rainwater tank to a tap located within 10 metres of the edge of the pool.		\checkmark	~
Dutdoor swimming pool			
The swimming pool must be outdoors.	\checkmark	\checkmark	\checkmark
The swimming pool must not have a capacity greater than 49.14 kilolitres.	\checkmark	\checkmark	\checkmark
The applicant must install a pool pump timer for the swimming pool.		\checkmark	\checkmark
The applicant must not incorporate any heating system for the swimming pool that is part of this development.		\checkmark	~

- **1**

Windows and	l glazed do	ors							
The applicant n Relevant overs		the specifications listed in the table below.	~	~	~				
The following re		~	\checkmark						
Each window o have a U-value must be calcula		~	~						
have a U-value	ar glazing, or toned/air gap/clear glazing must le below. Total system U-values and SHGCs i. The description is provided for information		~	~					
For projections above the head	~	~	\checkmark						
Pergolas with p		\checkmark	\checkmark						
Pergolas with fi shades a perpe		~	\checkmark						
Windows an	nd glazed o	loors gl	lazing r	equireme	nts				
Window / door	Orientation		Oversha	dowing	Shading device	Frame and glass type			
no.		glass inc. frame (m2)	Height (m)	Distance (m)					
W01	N	0.72	0	0	eave/verandah/pergola/balcony >=600 mm	standard aluminium, single pyrolytic low-e, (U-value: 5.7, SHGC: 0.47)			
W02	N	1.61	0	0	eave/verandah/pergola/balcony >=600 mm	standard aluminium, single pyrolytic low-e, (U-value: 5.7, SHGC: 0.47)			
W03	E	4.52	0	0	eave/verandah/pergola/balcony >=450 mm	standard aluminium, single pyrolytic low-e, (U-value: 5.7, SHGC: 0.47)			

Fixtures and systems	Show on DA Plans	Show on CC/CDC Plans & specs	Certifier Check
Lighting			
The applicant must ensure a minimum of 40% of new or altered light fixtures are fitted with fluorescent, compact fluorescent, or light-emitting-diode (LED) lamps.		~	~
Fixtures	•		
The applicant must ensure new or altered showerheads have a flow rate no greater than 9 litres per minute or a 3 star water rating.		\checkmark	\checkmark
The applicant must ensure new or altered toilets have a flow rate no greater than 4 litres per average flush or a minimum 3 star water rating.		\checkmark	\checkmark
The applicant must ensure new or altered taps have a flow rate no greater than 9 litres per minute or minimum 3 star water rating.		\checkmark	

			REV.	DATE	COMMENTS	DRV	I NOTES This drawing is the copyright of Action Plans and not be altered, reproduced or transmitted in any form or by any means in part or in	CLIENT	DRAWIN
		ACTION PLANS m: 0426 957 518 e:operations@actionplans.com.au w: www.actionplans.com.au	A	23.06.2021	DA	DLF	whole with the written permission of Action Plans. Do not scale measure from drawings. Figured dimensions are to be used only. The Builder/Contractor shall check and verify all levels and dimensions on site prior to commencement of any work, creation of shop	KLARA & DAVE ELLETT	DA1
1							drawings, or fabrication of components. All errors and omissions are to be verified by the Builder/Contractor and referred to the designer prior to the commencement of works. All window & door dimensions, orientation, glazing materials, opening types, frame types are to be confirmed by a suitably qualified person prior to the ordering of any such materials are to take place. U value takes precedence over glazing type/colour in all cases.	PROJECT ADDRESS	DATE Monday,
	-	w. www.actionplans.com.au					all new glazing must meet the BASIX specified frame and glass type, <u><i>DR</i></u> meet the ecified U value and SHGC value.	BALGOWLAH HEIGHTS	wonday,

Fixtures and systems	Show on DA Plans	Show on CC/CDC Plans & specs	Certifier Check
Lighting			
The applicant must ensure a minimum of 40% of new or altered light fixtures are fitted with fluorescent, compact fluorescent, or light-emitting-diode (LED) lamps.		~	~
Fixtures			
The applicant must ensure new or altered showerheads have a flow rate no greater than 9 litres per minute or a 3 star water rating.		\checkmark	\checkmark
The applicant must ensure new or altered toilets have a flow rate no greater than 4 litres per average flush or a minimum 3 star water rating.		\checkmark	\checkmark
The applicant must ensure new or altered taps have a flow rate no greater than 9 litres per minute or minimum 3 star water rating.		\checkmark	

WING NO. **\18**

DRAWING NAME BASIX COMMITMENTS Area of glass Hei inc. (m) frame (m2)

1.51

1.45

0.9

0.8

3.46

3.46

0.96

3.47

1.98

1.45

0.97

6.67

0.97

Height Distance (m) (m)

Shading device

eave/verandah/pergola/balcony >=600 mm

rame and glass type

eave/verandah/pergola/balcony >=450 mm standard aluminium, single pyrolytic low-e, (U-value: 5.7, SHGC: 0.47)

eave/verandah/pergola/balcony >=600 mm standard aluminium, single clear, (or U-value: 7.63, SHGC: 0.75)

eave/verandah/pergola/balcony standard aluminium, single clear, (or >=600 mm U-value: 7.63, SHGC: 0.75)

eave/verandah/pergola/balcony >=600 mm standard aluminium, single clear, (or U-value: 7.63, SHGC: 0.75)

eave/verandah/pergola/balcony improved aluminium, single pyrolytic low-e, >=600 mm (U-value: 4.48, SHGC: 0.46)

eave/verandah/pergola/balcony >=600 mm improved aluminium, single pyrolytic low-e, (U-value: 4.48, SHGC: 0.46)

eave/verandah/pergola/balcony standard aluminium, single pyrolytic low-e, >=600 mm (U-value: 5.7, SHGC: 0.47) eave/verandah/pergola/balcony >=600 mm (U-value: 5.7, SHGC: 0.47)

eave/verandah/pergola/balcony >=600 mm (U-value: 5.7, SHGC: 0.47)

eave/verandah/pergola/balcony standard aluminium, single pyrolytic low-e, (U-value: 5.7, SHGC: 0.47)

eave/verandah/pergola/balcony improved aluminium, single pyrolytic low-e, (U-value: 4.48, SHGC: 0.46)

eave/verandah/pergola/balcony standard aluminium, single clear, (or >=600 mm U-value: 7.63, SHGC: 0.75)

standard aluminium, single pyrolytic low-e, (U-value: 5.7, SHGC: 0.47)

Glazing requirements

Vindow / door O

W05

W06

W07

W08

W09

W10

W/11

W12

W13

W14

W15

W16

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Certifier Check

Show on CC/CDC Plans &

Show on DA Plans	Show on CC/CDC Plans & specs	Certifier Check	Glazing requir	Glazing requirements						
			Skylight number	Area of glazing inc. frame (m2)	Shading device	Frame and glass type				
			S01/S02	0.605	no shading	aluminium, moulded plastic single clear, (or U-value: 6.21, SHGC: 0.808)				
			S03/S04	2.184	no shading	timber, low-E internal/argon fill/clear external, (or U-value: 2.5, SHGC: 0.456)				
			S05	1.345	no shading	timber, low-E internal/argon fill/clear external, (or U-value: 2.5, SHGC: 0.456)				
			S06	0.649	no shading	timber, low-E internal/argon fill/clear external, (or U-value: 2.5, SHGC: 0.456)				
			S07/S08	1.54	no shading	timber, Iow-E internal/argon fill/clear external, (or U-value: 2.5, SHGC: 0.456)				
							1			

BASIX Certificate number: A413009 02

Glazing requ	Show on DA Plans	Show on CC/CDC Plans & specs	Certifier Check						
Window / door no.	Orientation	Area of glass inc. frame (m2)	Oversha Height (m)	adowing Distance (m)	Shading device	Frame and glass type			
W17	S	0.97	0	0	eave/verandah/pergola/balcony >=600 mm	standard aluminium, single clear, (or U-value: 7.63, SHGC: 0.75)			
W18	S	0.97	0	0	eave/verandah/pergola/balcony >=600 mm	standard aluminium, single clear, (or U-value: 7.63, SHGC: 0.75)			
W19	S	0.97	0	0	eave/verandah/pergola/balcony >=600 mm	standard aluminium, single clear, (or U-value: 7.63, SHGC: 0.75)			
D01	W	0.4	0	0	eave/verandah/pergola/balcony >=900 mm	standard aluminium, single clear, (or U-value: 7.63, SHGC: 0.75)			
D02	E	12.8	0	0	eave/verandah/pergola/balcony >=900 mm	standard aluminium, single clear, (or U-value: 7.63, SHGC: 0.75)			
D03	N	10.24	0	0	eave/verandah/pergola/balcony >=900 mm	standard aluminium, single clear, (or U-value: 7.63, SHGC: 0.75)			
D04	S	0.25	0	0	eave/verandah/pergola/balcony >=600 mm	standard aluminium, single clear, (or U-value: 7.63, SHGC: 0.75)			
D05	E	10.5	0	0	eave/verandah/pergola/balcony >=900 mm	standard aluminium, single clear, (or U-value: 7.63, SHGC: 0.75)			
Skylights							1	1	I
The applicant r	nust install th	e skylight	s in accor	dance with t	he specifications listed in the table l	below.	\checkmark	\checkmark	\checkmark
The following r	The following requirements must also be satisfied in relation to each skylight:							\checkmark	\checkmark
Each skylight may either match the description, or, have a U-value and a Solar Heat Gain Coefficient (SHGC) no greater than that listed in the table below.								~	~
Skylights gl	lazing requ	uiremen	ts				1		

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egend n these commitments, "applicant" means the person carrying out the development Commitments identified with a "" in the "Show on DA plans" column must be shown on the plans accompanying the development application for the proposed development (if a development application is to be lodged for the proposed development). Commitments identified with a *v* in the *Show on CC/CDC plans & specs* column must be shown in the plans and specifications accompanying the application for a construction certificate / complying development certificate for the proposed development. Commitments identified with a * V* in the *Certifier check* column must be certified by a certifying authority as having been fulfilled, before a final occupation certificate for the development may be issued.

		REV.	. DATE	COMMENTS	DRWN	NOTES This drawing is the copyright of Action Plans and not be altered, reproduced or transmitted in any form or by any means in part or in	CLIENT	DRAWING NO
	ACTION PLANS	A	23.06.2021	DA	DLR	whole with the written permission of Action Plans. Do not scale measure from drawings. Figured dimensions are to be used only.	KLARA & DAVE ELLETT	DA19
						The Builder/Contractor shall check and verify all levels and dimensions on site prior to commencement of any work, creation of shop drawings, or fabrication of components.		DAIS
	m: 0426 957 518 e:operations@actionplans.com.au					All errors and omissions are to be verified by the Builder/Contractor and referred to the designer prior to the commencement of works. All window & door dimensions, orientation, glazing materials, opening types, frame types are to be confirmed by a suitably qualified	PROJECT ADDRESS	DATE
	w: www.actionplans.com.au	nplans.com.au U value takes precedence over glazing type/colour in all cases.	person prior to the ordering of any such materials are to take place. U value takes precedence over glazing type/colour in all cases. all new glazing must meet the BASIX specified frame and glass type, <u>OR</u> meet the ecified U value and SHGC value.	116 BEATRICE STREET, BALGOWLAH HEIGHTS	Monday, 28 Ju			
							2093	I

VING NO.

DRAWING NAME BASIX COMMITMENTS

ay, 28 June 2021