Pittwater Data Services Pty Ltd ABN 36098815537 27 Ashby Street Dudley, 2290

Mobile: 0422 088 032

Email: pittwaterdataservices@live.com.au
Our Reference: PDS07112020:43PITTW:MANLY

Marston Architects 43 Pittwater Road, Manly, 2095 07/11/2020

Re: Flood Management Report Addendum for 43 Pittwater Road, Manly

Dear Pip,

I refer a Development Application (DA 2019/1126) at 43 Pittwater Road Manly (Lot 4 DP 233249 referred to as the *site*) which was approved by Northern Beaches Council (NBC) on 13th December 2019. The approval was for a 3.2 m2 extension of the existing Dwelling as shown in Figure 1.

A Flood Management Report was prepared by Pittwater Data Services Pty Ltd Dated 15th September 2019(Ref:PDS15092019:43PITTW:MANLY) and submitted with the DA application. In essence the report stated that the proposal complies with Manly DCP Section 5.4.3 for a Medium Flood Risk Precinct considering the flood processes, configuration of the existing Dwelling and extensions design.

A revision of the original approved extension was designed by Marston Architects as shown in Figures 2 and 3. The revision includes:

- 1. The retention of the original approval (3.2m2) with a designated use of a Family/ Dining room
- 2. Widening the southern wall of the Family/ Dinning room (4.4m2)
- 3. Constructing a deck on the western side of the Dwelling (5.1m2)
- 4. Additional bedroom on First Floor Level (Figure 3).

Notes:

- All extensions are suspended floors on peirs.
- Habitable combined extensions area 7.6 m2. This includes 3.2m2 of the original approval (DA 2019/1126).
- Non habitable decking 5.1m2.
- First Floor Level above PMF (Figure 3).

The original Flood Management Report based on NBC flood standard, generated the Medium Flood Risk Matrix which showed that compliance was met for the proposal. Adopting the same process for the revised extensions, only two standards need to be reassessed. That is:

F4. This requirement allows for up to 30 m2 extension of an existing room below the Flood Planning Level (FPL). The proposal is an extension of an existing room by 7.6m2 (including approved 3.2m2)


A3 No net loss of flood storage: there is approximately 0.032m3 of loss of flood storage from the piers. This is imperceptible considering the overall flood storage of the *site* and the accuracy of the 1%AEP flood predictions and therefore flood depths on the *site*.

In conclusion, considering the flooding processes at the *site* the design of the additions to the Dwelling as detailed in Figures 2 and 3, it is my opinion the revised design and the Flood Action Plan as detailed in the original Flood Management Report, will satisfy NBC Manly DCP Section 5.4.3 requirements.

Yours Faithfully,


Stephen Wyllie Bsc (Eng) FMA Member


Director

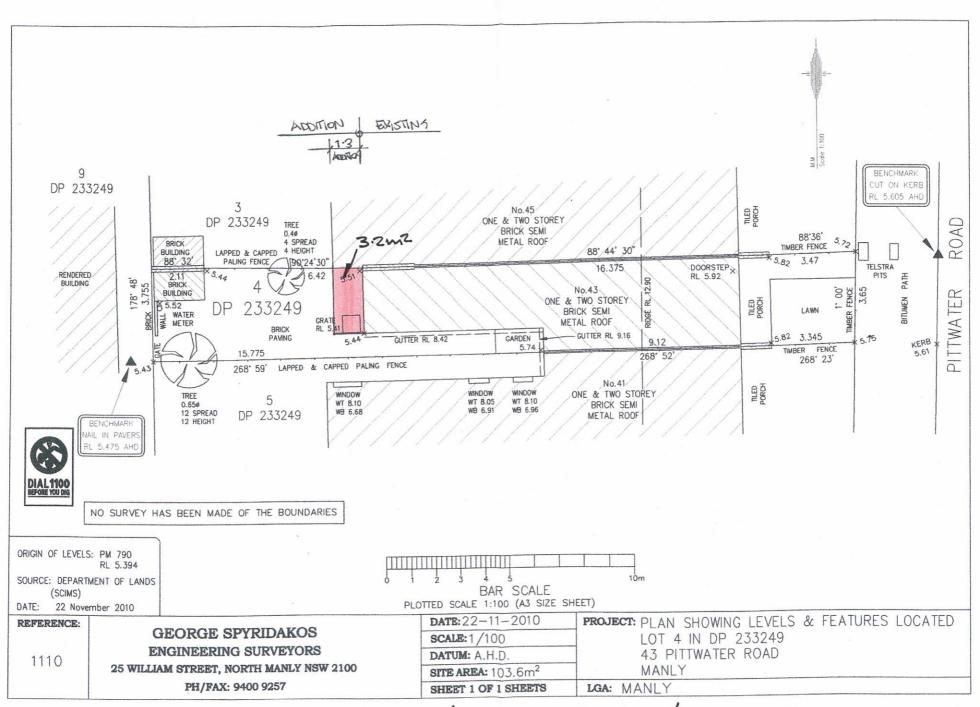

APPROVED DA 2019/126

FIGURE 1

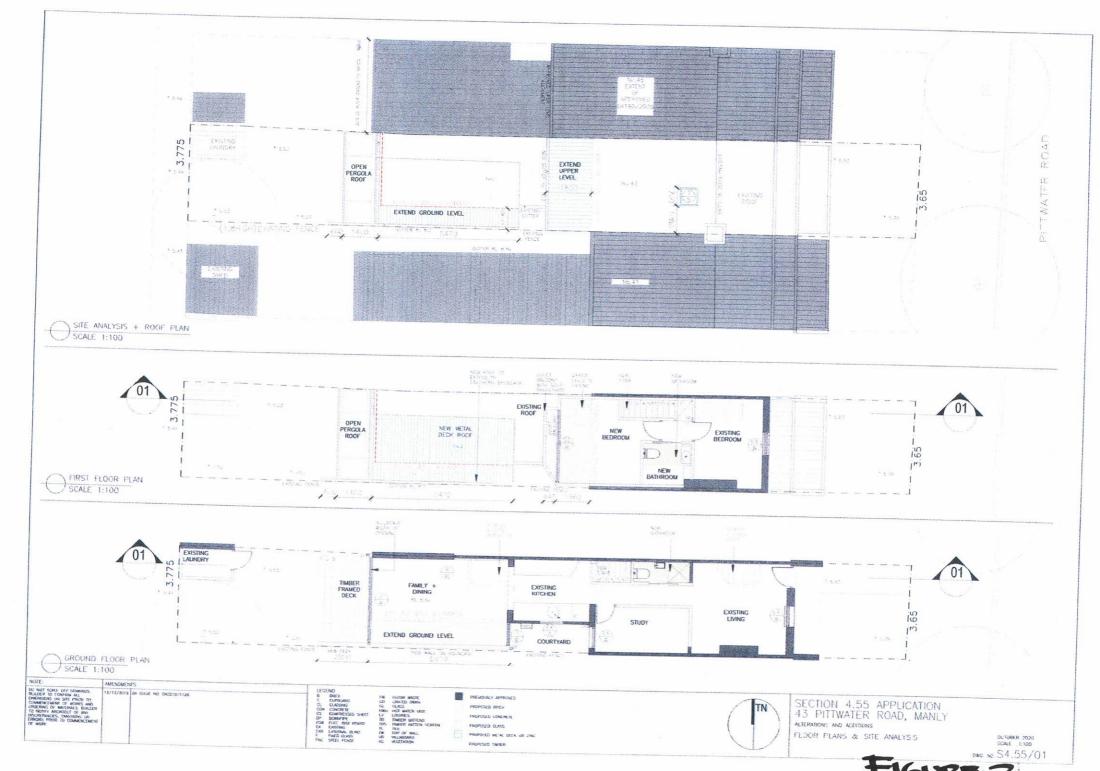

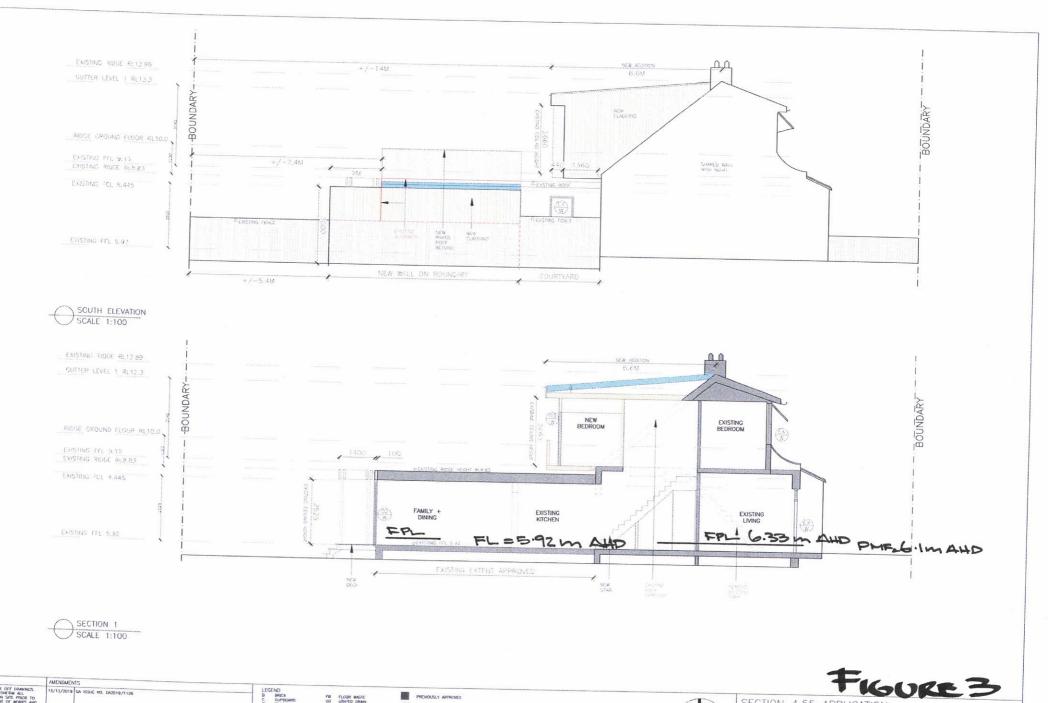

DIMPOSOR'S ON SITE PRIDE TO CHAMPENEUMPH OF RESIDES AND GOVERNMENT OF RESIDES AND GOVERNMENT OF RESIDES OF TO HOUSE AMERICAN OF PRINCES PRIDE TO COMMENCEMENT OF BURNES PRIDE TO COMMENCEMENT LEGEND

B BRICK
C DUPLOAND
CL CLADDING
CS COMPRESSED
DE DOMNIPE
DOM CIEC. DST POADD
CX CUSTING
ZES EXCELL CINCE
F FORD CLASS
FM STELL CINCE

FW FLOOR WASTE
OD OTHER DOWN
GL GLASS
HOUL HOT MATER UNIT
V COUNTRY
TO THE BUTTENS
THIS TIMEER HOTTENS
THE PLE
THE OT BREE
W CLASSING
VG VEGITATION
VG VEGITATION

PREVIOUSLY APPROVED
PROPOSED BRICK
PROPOSED CAUSE
PROPOSED CAUSS
PROPOSED METAL DECK OR ZINC
PROPOSED TIMER



SECTION 4.55 APPLICATION
4.3 PITTWATER ROAD, MANLY
ALTERATIONS AND ACCITIONS
SOUTH ELEVATION AND SECTION

OCTOBER 2020 SCALE 1:100 DWG. NO. S4.55/02