

ACTION PLANS

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DEVELOPEMENT APPLICATION

FOR DEVELOPMENT APPROVAL ONLY

SHEET NUMBER	SHEET NAME	DATE PUBLISHED
DA00	COVER	25/09/2019
DA01	NOTATION	25/09/2019
DA02	SITE ANALYSIS	25/09/2019
DA03	SITE / ROOF / SEDIMENT EROSION / WASTE MANAGEMENT / STORMWATER CONCEPT PLAN	25/09/2019
DA04	EXISTING LOWER GROUND FLOOR PLAN	25/09/2019
DA05	EXISTING GROUND FLOOR PLAN	25/09/2019
DA06	PROPOSED LOWER GROUND FLOOR PLAN	25/09/2019
DA07	PROPOSED GROUND FLOOR PLAN	25/09/2019
DA08	NORTH / EAST ELEVATION	25/09/2019
DA09	SOUTH / WEST ELEVATION	25/09/2019
DA10	LONG / CROSS SECTION	25/09/2019
DA11	AREA CALCULATIONS	25/09/2019
DA12	SAMPLE BOARD	25/09/2019
DA13	WINTER SOLSTICE 9AM / 12PM / 3PM	25/09/2019
DA14	BASIX COMMITMENTS	25/09/2019

ITEM DETAILS	DEVELOPMENT APPLICATION					
ADDRESS	12 HEATHCLIFF CRESENT, BALGOWLA	H HEIGHTS, NSW, 2093				
LOT & DP/SP	LOT 4 SECTION 29 DP 758044					
COUNCIL	,	IORTHERN BEACHS COUNCIL (MANLY)				
SITE AREA	556.4m²					
FRONTAGE	15.24m					
CONTROLS	PERMISSIBLE / REQUIRED	EXISTING	PROPOSED	COMPLIANCE		
	m / m² / %	m / m² / %	m / m² / %			
<u>LEP</u>						
LAND ZONING	R2 – LOW DENSITY RESIDENTIAL	R1	R1	YES		
MINIMUM LOT SIZE	500m²	556.4m²	UNCHANGED	YES		
FLOOR SPACE RATIO	0:45 : 1 (250.38m²)	0.23 : 1 (127.49m²)	0.29 : 1 (161.32m²)	YES		
MAXIMUM BUILDING HEIGHT	8.5m	5.72m	UNCHANGED	YES		
HAZARDS						
ACID SULFATE SOILS	NOT IDENTIFEID	N/A	N/A	N/A		
FLOOD PLANNING	NOT IDENTIFEID	N/A	N/A	N/A		
WATERCOURSE	NOT IDENTIFEID	N/A	N/A	N/A		
WETLANDS	NOT IDENTIFEID	N/A	N/A	N/A		
LANDSLIP RISK	NOT IDENTIFEID	N/A	N/A	N/A		
BIODIVERSITY	NOT IDENTIFEID	N/A	N/A	N/A		
FORESHORE SCENIC PRO. AREA	NOT IDENTIFEID	N/A	N/A	N/A		
BUSHFIRE PRONE LAND	BUFFER 30M - 100M	N/A	N/A	N/A		
DCP						
RESIDENTIAL OPEN SPACE	AREA OS3	N/A	N/A	YES		
TOTAL OPEN SPACE (TOS)	55% (306.20m²)	69.35% (385.86m²)	67.63% (376.27m²)	YES		
LANDSCAPE AREA	35% OF TOS (55%): 107.11m ²	208.76m²	215.52m²	YES		
PRINCIPAL PRIVATE OPEN SPACE	18m²	237.16m²	227.57m²	YES		
FRONT SETBACK	PREVALING BULDING LINE: 10.09m	10.09m	UNCHANGED	YES		
REAR SETBACK	8.0m	14.15m	UNCHANGED	YES		
SIDE SETBACKS - 1/3 WALL HEIGHT	N: 1.560m S: 1.360m	N: 1.010m S: 0.793m	N: UNCHANGED S: UNCHANGED	YES		
WALL HEIGHT	6.5m	5.455m	UNCHANGED	YES		
CAR PARKING SPACES	Required: 1	2	1	YES		

12 HEATHCLIFF CRES, BALGOWLAH HEIGHTS, NSW, 2093



NCC & AS COMPLIANCES SPECIFICATIONS

- EARTHWORKS: METHOD OF EXCAVATION AND FILL - PART 3.1.1 OF NCC - SURFACE SUBSOIL-STORMWATER DRAINAGE - PART 3.1.2 OF NCC - TERMITE-RISK MANAGEMENT - PART 3.1.3 OF NCC - FOOTINGS & SLAB - PART 3.2 OF NCC INCLUDING AS2870 - MASONRY CONSTRUCTION - PART 3.3 OF NCC INCLUDING AS3700 - SUB FLOOR VENTILATION - PART 3.4.1 OF NCC - FRAMING - PART 3.4 OF NCC - ROOF, WALL-CLADDING, GUTTERS & DOWNPIPES - PART 3.5 OF NCC - GLAZING - PART 3.6 OF NCC INCLUDING AS1288 - FIRE SEPARATION - PART 3.7.1 OF NCC - SMOKE ALARMS - PART 3.7.2 OF NCC - HEATING APPLIANCES - PART 3.7.3 OF NCC - WET AREAS-PROTECTION OF WALLS & FLOORS - PART 3.8.1 OF NCC - MINIMUM ROOF HEIGHTS - PART 3.8.3 OF NCC - FACILITIES REQUIRRED & SANITARY DOOR CONSTRUCTION - PART 3.8.3 OF NCC - LIGHT: NATURAL AND ARTIFICIAL - PART 3.8.4 OF NCC

- SOUND INSULATION - PART 3.8.6 OF NCC - STAIR CONSTRUCTION INCLUDING DIMENSIONS - PART 3.9.1 OF NCC

- VENTILATION & LOCATION OF TOILETS - PART 3.8.5 OF NCC

- BALUSTRADES & OTHER BARRIERS - PART 3.9.2 OF NCC - FENCING & OTHER PROVISIONS - REGS & AS1926

- FENCING & OTHER PROVISIONS - REGS & AS1926 - DEMOLITION WORKS - AS2601-1991 THE DEMOLITION OF STRUCTURES.

- ALL WATERPROOF MEMBRANES TO COMPLY WITH WITH AS 3740-2004 - ALL PLUMBING & DRAINAGE WORK TO COMPLY WITH AS 3500

- SITE CLASSIFICATION AS TO AS 2870

- ALL PLASTERBOARD WORK TO COMPLY WITH AS 2588-1998

- ALL STRUCTURAL STEEL WORK TO COMPLY WITH AS 4100 & AS 1554
- ALL CONCRETE WORK TO COMPLY WITH AS 3600

- ALL ROOF SHEETING WORK TO COMPLY WITH AS 1562-1992

- ALL SKYLIGHTS TO COMPLY WITH WITH AS 4285-2007

- ALL CERAMIC TILING TO COMPLY WITH AS 3958.1-2007 & 3958.2-1992 - ALL GLAZING ASSEMBLIES TO COMPLY WITH AS2047 & 1288

 - ALL TIMBER RETAINING WALLS ARE TO COMPLY WITH AS 1720.1-2010, AS 1720.2-2006, AS 1720.4-2006, AS 1170.1-1989 & AS 1170.4-1993

- ALL RETAINING WALLS ARE TO COMPLY WITH 3700 - 2011 & AS 3600 -2001 - ALL CONSTRUCTION TO COMPLY TO AS3959- 1991

NOTES

- APPROVED MEANS BY THE 'RELEVANT LOCAL AUTHORITY' OR COUNCIL
- THE OWNER WILL DIRECTLY PAYTHE FEES ASSOCIATED WITH THE FOLLOWING:


BUILDING APPROVAL FROM COUNCIL, FOOTPATH AND KERB DEPOSITS WITH THE LOCAL COUNCIL, INSURANCE FEE TO BUILDING SERVICES CORPORATION, LONG SERVICE LEAVE SERVICE LEVY FEE AND APPROVAL FEE BY WATER AND SEWERAGE AUTHORITY. ALL OTHER FEES ARE TO BE PAID BY THE BUILDER. THE AMOUNT OF ANY LOCAL AUTHORITY DEPOSITS WHICH ARE FORFEITED DUE TO DAMAGE OR OTHER CAUSE WILL BE DEDUCTED FROM THE PAYMENTS DUE TO THE BUILDER.

- THE BUILDER IS TO PROVIDE AT HIS/HER OWN EXPENSE ADEQUATE PUBLIC RISK INSURANCE AND ARRANGE INDEMNIFICATION UNDER THE WORKERS COMPENSATION ACT. WORKS INSURANCE TO BE STATED IN THE CONTRACT CONDITIONS.
- ALL WORK TO BE CARRIED OUT IN A TRADESMEN LIKE MANNER AND IN ACCORDANCE WITH THE STANDARDS CODES AND REGULATIONS OF THE STANDARDS ASSOCIATION OF AUSTRALIA, BUILDING CODE OF AUSTRALIA AND ANY STATUTORY AUTHORITY HAVING JURISDICTION OVER THE WORK.
- ALL TENDERERS ARE TO VISIT THE SITE TO SATISFY THEMSELVES AS TO THE NATURE AND EXTENT OF THE WORKS, FACILITIES AVAILABLE AND DIFFICULTIES ENTAILED IN THE WORKS AS VARIATIONS WILL NOT BE ALLOWED DUE TO WORK ARISING OWING TO NEGLECT OF THIS CLAUSE.
- ALL WORK AND MATERIALS TO COMPLY WITH THE CURRENT AUSTRALIAN STANDARDS AT THE TIME OF COMMENCEMENT WERE APPLICABLE.
- THESE DRAWINGS SHALL BE READ IN CONJUNCTION WITH ALL STRUCTURAL AND OTHER CONSULTANTS DRAWINGS AND SPECIFICATIONS AND WITH ANY SUCH WRITTEN INSTRUCTIONS AS MAY BE ISSUED DURING THE COURSE OF THE CONTRACT.
- SET OUT DIMENSIONS SHOWN ON THIS DRAWING SHALL BE VARIFIED BY THE BUILDER ON SITE BEFORE COMMENCEMENT OF ANY WORK. DIMENSIONS SHOULD NOT BE OBTAINED BY SCALING THE DRAWINGS. USE ONLY FIGURED DIMENSIONS. ALL DIMENSIONS ARE IN MILLIMETRES.
- THE BUILDER IS TO ENSURE ALL CONSTRUCTION, LEVELS AND OTHER ITEMS COMPLY WITH THE CONDITIONS OF THE BUILDING APPROVAL.
- THE BUILDER IS TO COMPLY WITH ALL ORDINANCES, LOCAL AUTHORITY REGULATIONS AND THE REQUIREMENTS OF ALL SERVICES SUPPLY AUTHORITIES HAVING JURISDICTION OVER THE WORKS.
- ALL PLUMBING AND DRAINAGE WORK TO BE INSTALLED AND COMPLETED BY A LICENCED TRADESMAN AND IN ACCORDANCE WITH THE STATUTORY BODY HAVING AUTHORITY OVER THE WORKS. CONNECT ALL WASTE TO SYDNEY WATER SEWER LINE
- ALL NEW DOWNPIPES ARE TO BE CONNECTED TO THE EXISTING STORM WATER SYSTEM.
- ALL POWER AND STORMWATER OUTLET LOCATIONS SHALL BE DETERMINED ONSITE BY THE OWNER.
- SMOKE DETECTOR ALARM TO BE INSTALLED IN ACCORDANCE WITH AS3786 AND THE BUILDING CODE OF AUSTRALIA.
- ELECTRICAL WORK TO BE IN ACCORDANCE WITH SAA WIRING RULES AND BE DONE BY A LICENCED TRADESMAN
- ANY DETAILING IN ADDITION TO WHAT IS SUPPLIED SHALL BE RESOLVED BETWEEN THE OWNER AND THE BUILDER TO THE OWNERS APPROVAL, EXCEPT FOR ANY STRUCTURAL DETAILS OR DESIGN WHICH IS SUPPLIED BY THE ENGINEER.
- ALL TIMBER SIZES AND CONCRETE DETAILS TO BE CONFIRMED BY THE BUILDER PRIOR TO COMMENCEMENT OF ANY WORK.
- ALL STRUCTURAL WORK IS TO BE IN ACCORDANCE WITH THE STRUCTURAL DETAILS PREPARED BY A STRUCTURAL ENGINEER (i.e.) PIERS, FOOTINGS, CONCRETE SLABS, RETAINING WALLS, STEELWORK, FORMWORK, UNDERPINNING, ADDITIONAL STRUCTURAL LOADS, TIMBER FRAMING, WIND BRACING AND ASSOCIATED CONNECTIONS. BUILDER TO OBTAIN PRIOR TO FINALISING TENDER.
- ANY WORK INDICATED ON THE PLANS BUT NOT SPECIFIED, AND ANY ITEM NOT SHOWN ON THE PLAN WHICH IS OBVIOUSLY NECESSARY AS A PART OF CONSTRUCTION AND/OR FINISH IS TO BE CONSIDERED AS SHOWN AND SPECIFIED, AND IS TO BE DONE AS PART OF THE CONTRACT. VARIATIONS WILL NOT BE PERMITTED WITHOUT THE WRITTEN CONSENT OF THE OWNER.
- THE BUILDER SHALL PROVIDE SEDIMENT AND SILTRATION CONTROL MEASURES AS REQUIRED BY COUNCIL AND MAINTAIN THEM THROUGH THE DURATION OF THE WORKS.
- A LEGIBLE COPY OF THE PLANS BEARING APPROVAL STAMPS MUST BE MAINTAINED ON THE JOB AT ALL TIMES. HOURS OF CONSTRUCTION WILL BE RESTRICTED TO THE TIMES AS REQUIRED BY THE BUILDING APPROVAL.
- THE BUILDER IS TO ARRANGE FOR ALL INSPECTIONS REQUIRED BY THE AUTHORITIES AND LENDING INSTITUTIONS TO THEIR REQUIREMENTS.
- THE BUILDER IS TO OBTAIN APPROVAL FOR INTERUPTIONS TO EXISTING SERVICES AND MINIMISE THE DURATION AND NUMBER OF INTERUPTIONS. ANY INTERRUPTIONS WITH EXISTING SERVICES AND EQUIPMENT TO BE ATTENDED TO BY THE APPROPRIATELY SKILLED TRADESMEN.
- THE BUILDER SHALL RESTORE, REINSTATE OR REPLACE ANY DAMAGE CAUSED TO EXISTING STRUCTURES OR LANDSCAPING BY CONSTRUCTION WORK OR WORKMEN. PROVIDE PROTECTION TO EXISTING TREES TO REMAIN AS REQUIRED BY APPROVAL CONDITIONS.
- ALL BRICKWORK IS TO BE SELECTED BY OWNER AND IS TO COMPLY WITH AS1640
- ALL MASONRY TO COMPLY WITH AS3700
- · ALL METALWORK AND FLASHING ITEMS NECESSARY TO SATISFACTORY COMLPETE WORK SHALL BE PROVIDED.
- ALL GUTTERS, DOWNPIPES TO BE COLORBOND.
- ALL TIMBER CONSTRUCTION TO BE IN ACCORDANCE WITH THE AUSTRALIAN STANDARD 1684 "TIMBER FRAMING CODE"
- ALL GLAZING INSTALLED TO COMPLY WITH AS1288, 2047 AND IN ACCORDANCE WITH MANUFACTURERS RECOMMENDATION
- ALL WALL AND CEILING LININGS TO BE PLASTERBOARD OR CEMENT RENDER AS SELECTED AND VILLA BOARD IN WET AREAS, TO COMPLY WITH THE RELEVANT AUSTRALIAN STANDARDS OR INSTALLED IN ACCORDANCE WITH MANUFACTURERS SPECIFICATION.
- ALL BATHROOMS AND WET AREAS TO BE ADEQUATELY WATERPROOFED TO MANUFACTURERS SPECIFATION AND AS3740 AND PART 3.8.1 OF THE BUILDING CODE OF AUSTRALIA HOUSING PROVISIONS
- STAIRS AND BALUSTRADES TO COMPLYWITH PART 3.9.1 & 3.9.2 OF THE BUILDING CODE OF AUSTRALIA HOUSING PROVISION.
- TERMITE PROTECTION MEASURES TO COMPLY WITH AS 3660 AND BE INSTALLED TO MANUFACTURERS SPECIFICATION.
- ANY DETAILING ADDITIONAL TO THAT SUPPLIED, SHALL BE RESOLVED BETWEEN THE OWNER AND THE BUILDER TO THE OWNERS APPROVAL. EXCEPT FOR ANY STRUCTURAL DETAILS OR DESIGN WHICH IS TO BE SUPPLIED BY THE STRUCTURAL ENGINEER.

This is a **summary** of the **minimum** specifications in 'Planning for Bushfire Protection 2006' as amended in 2010 and 'AS 3959 2009 — Construction of buildings in bushfire-prone areas' which are recommended in this report. It is included as a courtesy, is a guide only, and may not be complete. In addition, the contents of the documents from which this information was extracted may have changed between the dates of preparation of this report, and its use or application. Specifications in other documents such as the Building Code of Australia (BCA) may apply. It is the user's responsibility to comply with all statutory conditions as well as those specified by the approving authority with particular reference to this report. The appropriate source documents should be consulted to determine the full specifications abbreviated in this table.

DAI 40

		BAL-12.5	BAL-19	BAL-29	BAL-40
Floor	Slab OK				
	Timber <400mm ag		FRT or lined or enclo	sed	Non-combustible or
	Timber >400mm ag		OK		FRT or enclosed
Floor posts			FRT or enclosed		Enclosed or non-
					combustible
External walls		400mm FRT or	non-combustible	FRT or non-combustible	Non-combustible
Windows	Frame		FRT or metal		Metal
	Screens	Al, Fe or Br mes	h on all openable	Fe or Br mesh on all	Fe or Br mesh on all,
				openable, 5mm toughened	6mm toughened glass,
				glass, or shutters	or shutters
External doors	Sliding	Safety glass	5mm toughened	6mm toughened glass or	6mm toughened glass
			glass	full mesh	plus full mesh or shutter
	Screens		Al, Fe or Br, if fitte	d	Fe or Br
	Timber frames		FRT		Metal only
	Garage	Lower 400mm FRT	or non-combustible	FRT or non-combustible	Non-combustible
Vents etc	Mesh		Al, Fe or Br mesh 2r	mm	Fe or Br mesh 2mm
Roofs	Tiled		Fully sarked (Flammability Index <5)	
	Sheeted Non		 combustible, fully 	sarked (Flammability Index <5	5)
	Rooflights	Non-com	nbustible sleeve/lining, 4r	mm safety glass	FRL -/30/-
Verandahs, decks etc	Enclosed	Any supports,	<3mm spaced deck, FR	T or non-combustible	Any supports, unspaced
					deck, non-combustible
	Unenclosed	FRT or	non-combustible, <3mm	n spaced deck	All non-combustible,
					unspaced deck
	<300mm to glass	300mm wide FRT	or non-combustible	FRT or non-combustible	Non-combustible
Services			Exposed water	er & gas pipes to metal	
Ag Above ground	FRT Fire Re	esistant Timber Al	Aluminium Fe	Stainless steel Br	Bronze

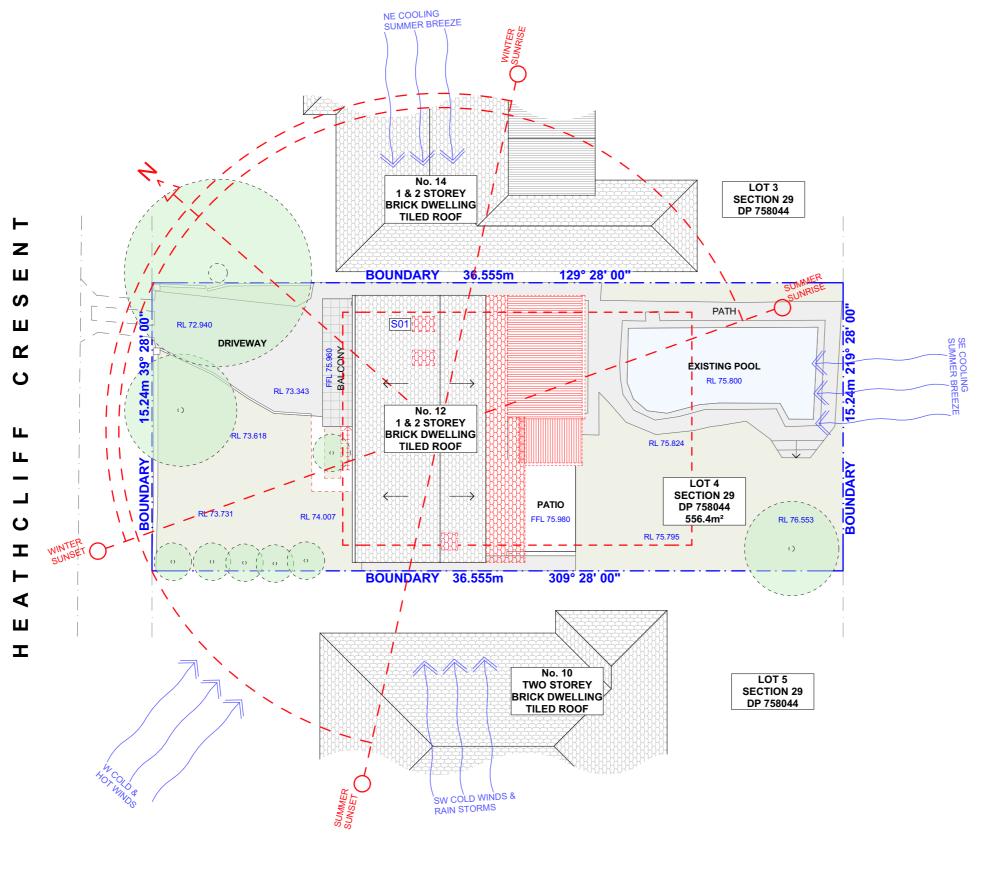







NOTE: ALL DEMOLISHED ELEMENTS TO ENG. SPECIFICATIONS AND AS. 2601 - 2001

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	REV.	DATE	COMMENTS	DRWN
	Α	05/10/2018	INITIAL DESIGN PLAN	DLR
	В	23/11/2018	FIRST DESIGN AMENDMENT	DLR
	С	01/04/2019	DA REVIEW SET	AJF
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any	LANDSCAPING	EXISTING METAL ROOF
the	PAVING	EXISTING TILED ROOF
and any	WALLS	PROPOSED METAL ROOF
of	DEMOLISHED	PROPOSED TILE ROOF

LEGEND

CLIENT EXISTING METAL ROOF EXISTING TILED ROOF

BEN & LEIGHANNE FARMER

PROJECT ADDRESS 12 HEATHCLIFF CRES, BALGOWLAH HEIGHTS, NSW, 2093 DRAWING NO.


DA02


DATE Wednesday, 25

September 2019

DRAWING NAME SITE ANALYSIS

SCALE 1:200 @A3

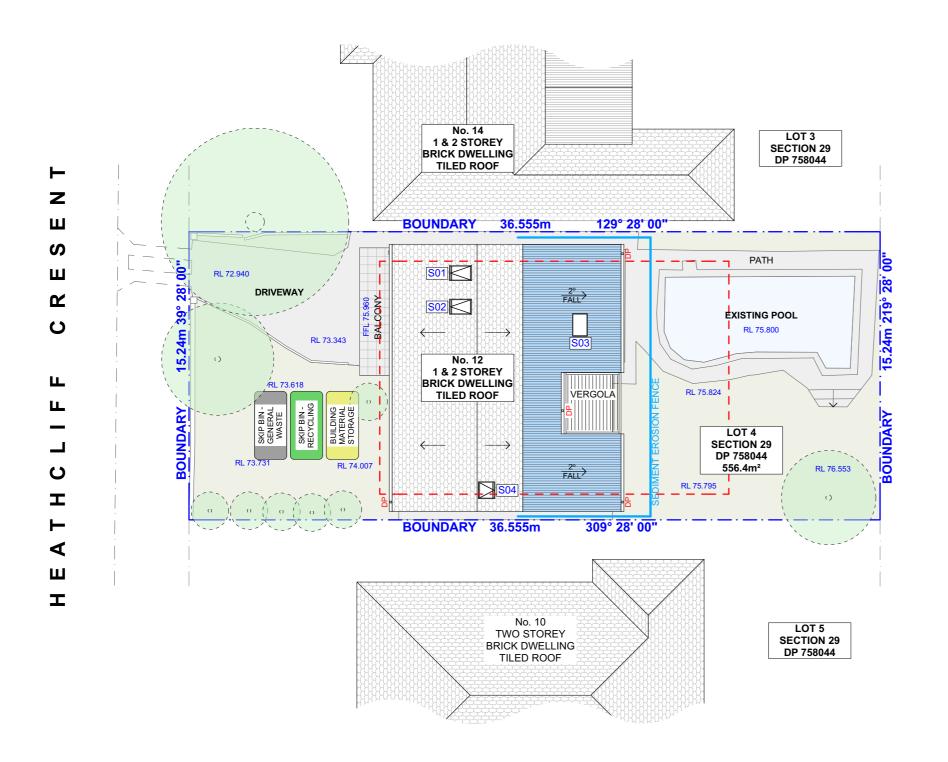

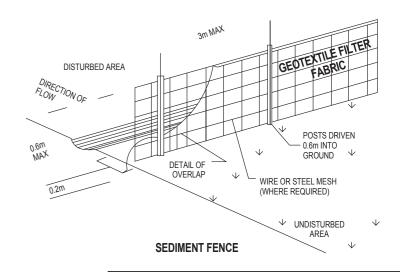

DUST CONTROL:

TO REDUCE DUST GENERATED BY WIND ACTION, THE REMOVAL OF THE TOP SOIL IS TO BE MINIMISED. TO PREVENT DUST GENERATION, WATERING DOWN OF THE SITE, ESPECIALLY DURING THE MOVEMENT OF MACHINERY IS REQUIRED. WHERE EXCAVATING INTO ROCK, KEEP THE SURFACE MOIST TO MINIMISE DUST. CONSTRUCT A GRAVEL ENTRY/EXIT POINT USING BLUE METAL AND RESTRICT ALL VEHICLE MOVEMENTS WITHIN THE SITE TO A MINIMUM. ENSURE WIND BREAKS, SUCH AS EXISTING FENCES ARE MAINTAINED DURING THE CONSTRUCTION PHASE UNTIL NEW LANDSCAPING IS PROVIDED OR REINSTATED. PREVENT DUST BY COVERING STOCKPILES

SEDIMENT NOTE:

1. ALL EROSION AND SEDIMENT CONTROL MEASURES TO BE INSPECTED AND MAINTAINED DAILY BY THE SITE MANAGER.

2. MINIMISE DISTURBED AREAS, REMOVE EXCESS SOIL FROM EXCAVATEDAREA AS SOON AS POSSIBLE. 3. ALL MATERIAL STOCKPILE TO BE CLEAR FROM DRAINS, GUTTERS AND FOOTPATHS, OR WITHIN SEDIMENT FENCE AREA.

4. DRAINAGE TO BE CONNECTED TO STORMWATER AS SOON AS POSSIBLE. IF STORED ON SITE, IT MUST BE FILTERED BEFORE RELEASING INTO STORMWATER SYSTEM OR WATERWAYS.

5. ROADS AND FOOTPATHS TO BE SWEPT DAILY.

STOCKPILES:

ALL STOCKPILES ARE TO BE KEPT ON-SITE WHERE POSSIBLE. ANY MATERIALS PLACED ON THE FOOTPATHS OR NATURE STRIPS REQUIRE COUNCIL'S PERMISSION

ALL STOCKPILES ARE TO BE PLACED AWAY FROM THE DRAINAGE LINES AND STREET GUTTERS. IT IS BEST TO LOCATE THESE ON THE HIGHEST PART OF THE SITE IF POSSIBLE. PLACE WATERPROOF COVERING OVER STOCKPILES.

IF REQUIRED PROVIDE DIVERSION DRAIN & BANK AROUND STOCKPILES.

GUTTER PROTECTION:

PROVIDE PROTECTION TO DOWNHILL GRATE IN GUTTER BY MEANS OF SAND BAGS OR BLUE METAL WRAPPED IN GEOTEXTILE FABRIC. WHEN SOIL OR SAND BUILDS UP AROUND THIS SEDIMENT BARRIER, THE MATERIAL SHOULD BE RELOCATED BACK TO THE SITE FOR DISPOSAL

> NOTE: ALL PROPOSED STORMWATER TO CONNECT WITH EXISTING

NOTE: BUSHFIRE PRONE LAND, REFER TO TABLE ON NOTATION PAGE




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12 HEATHCLIFF CRES. BALGOWLAH HEIGHTS, NSW, 2093

DRAWING NO.

DA03

DATE


Wednesday, 25 September 2019

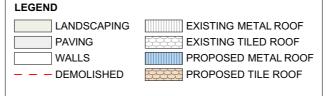DRAWING NAME

SITE / ROOF / SEDIMENT EROSION / WASTE MANAGEMENT / STORMWATER CONCEPT PLAN

SCALE

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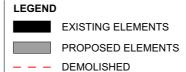
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D	10/04/2019	DA SUBMISSION	DLR
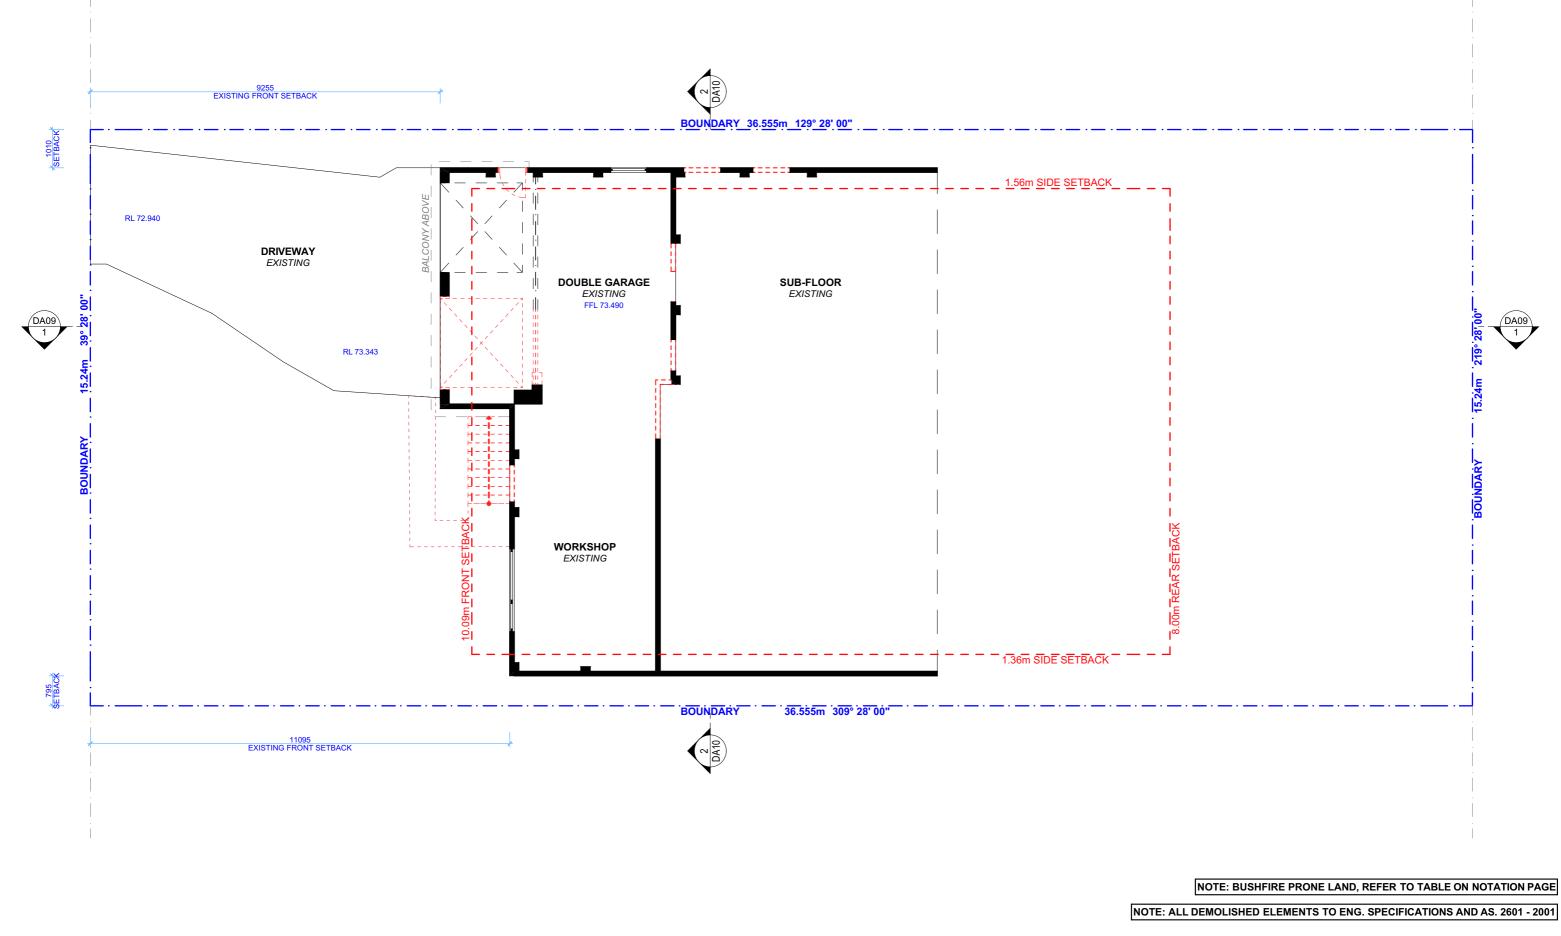
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NSW, 2093

DA04 DATE


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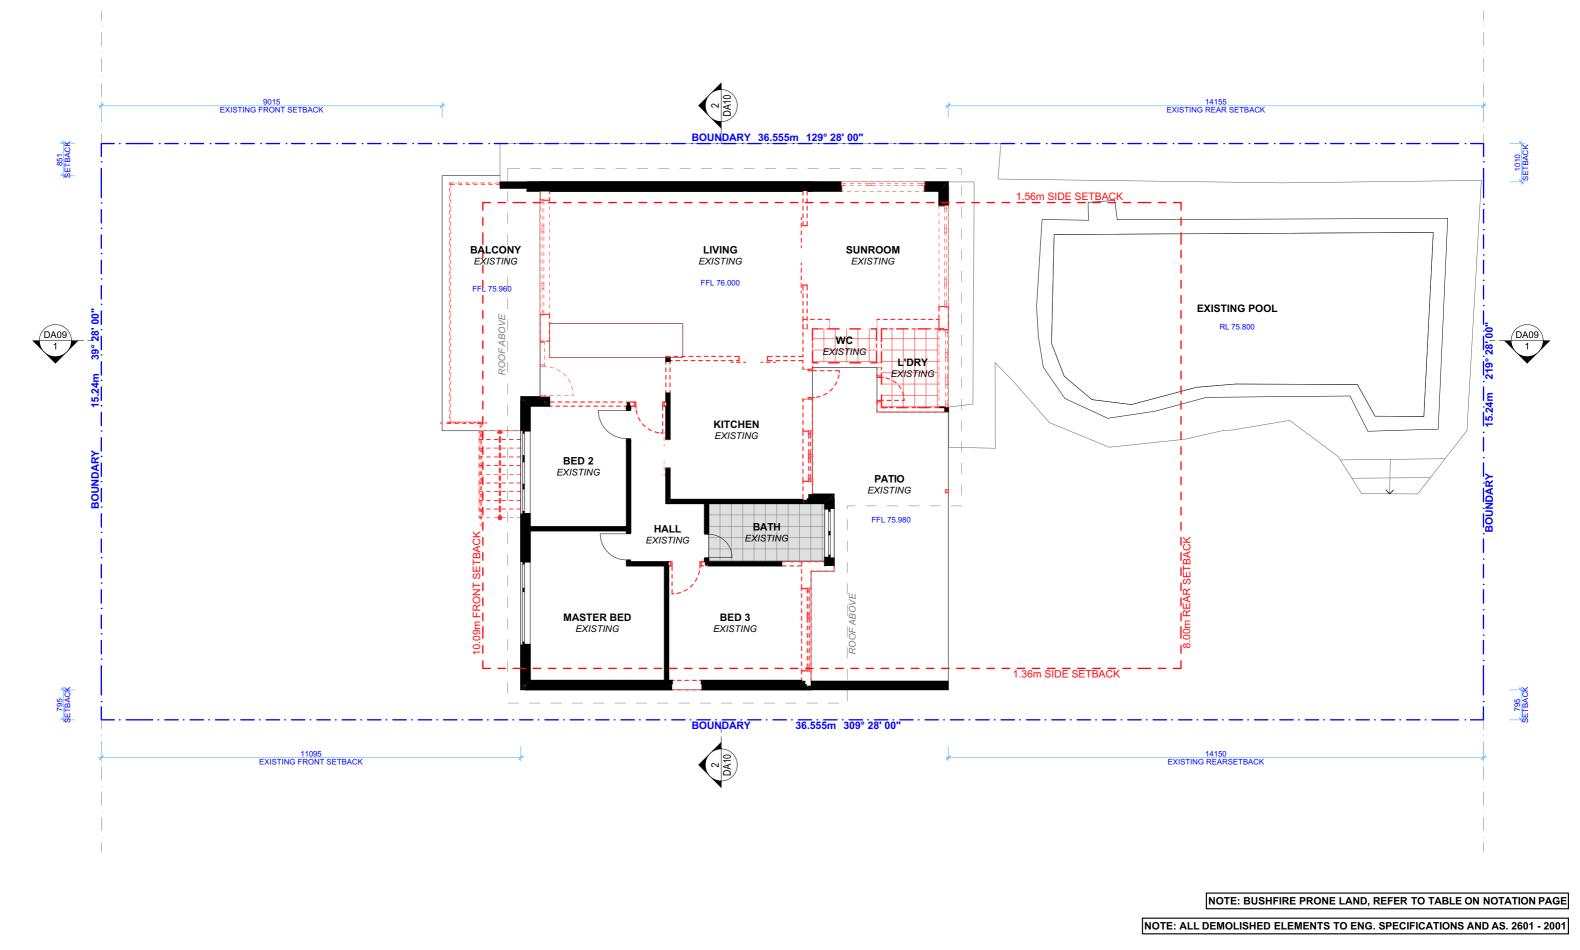
Wednesday, 25

September 2019

DRAWING NAME EXISTING LOWER GROUND FLOOR PLAN

SCALE 1:100 @A3



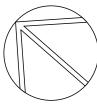



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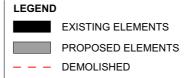
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I	D	10/04/2019	DA SUBMISSION	DLR

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DA05

DRAWING NO.


EXISTING GROUND FLOOR PLAN


DATE

Wednesday, 25 September 2019

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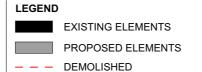
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DA06

September 2019

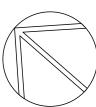
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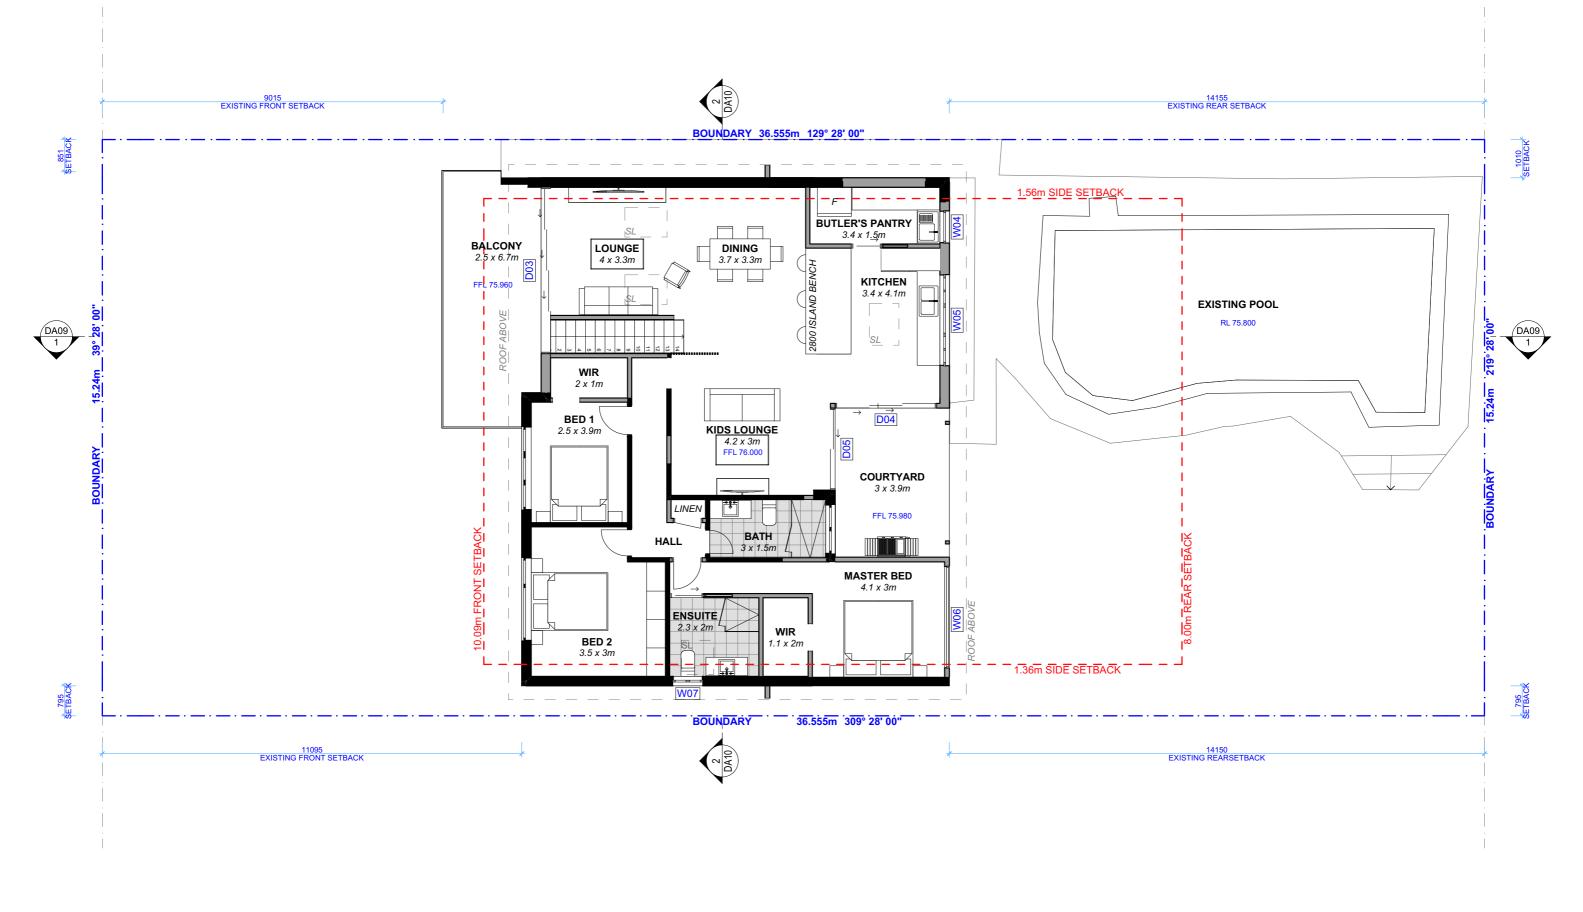
DATE Wednesday, 25 DRAWING NAME

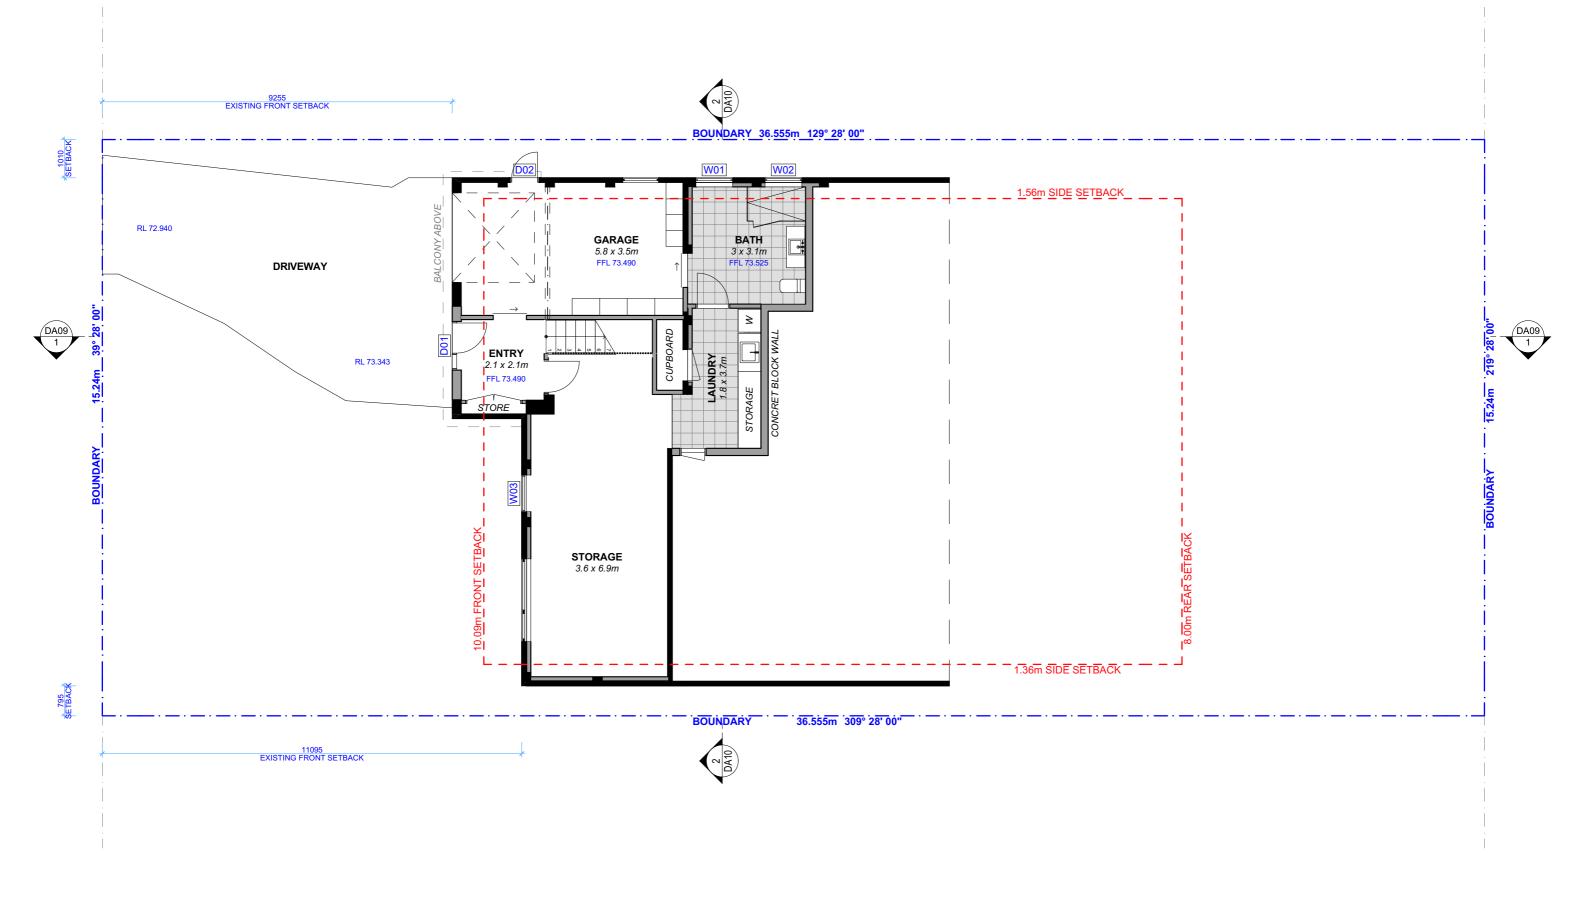PROPOSED LOWER GROUND FLOOR PLAN

SCALE

1:100 @A3



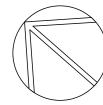



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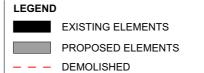
REV.	DATE	COMMENTS	DRWN
А	05/10/2018	INITIAL DESIGN PLAN	DLR
В	23/11/2018	FIRST DESIGN AMENDMENT	DLR
С	01/04/2019	DA REVIEW SET	AJF
D	10/04/2019	DA SUBMISSION	DLR

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CLIENT

NSW, 2093

BEN & LEIGHANNE FARMER

PROJECT ADDRESS 12 HEATHCLIFF CRES, BALGOWLAH HEIGHTS,

DA07

DRAWING NO.


PLAN




Wednesday, 25 September 2019 PROPOSED GROUND FLOOR

DRAWING NAME



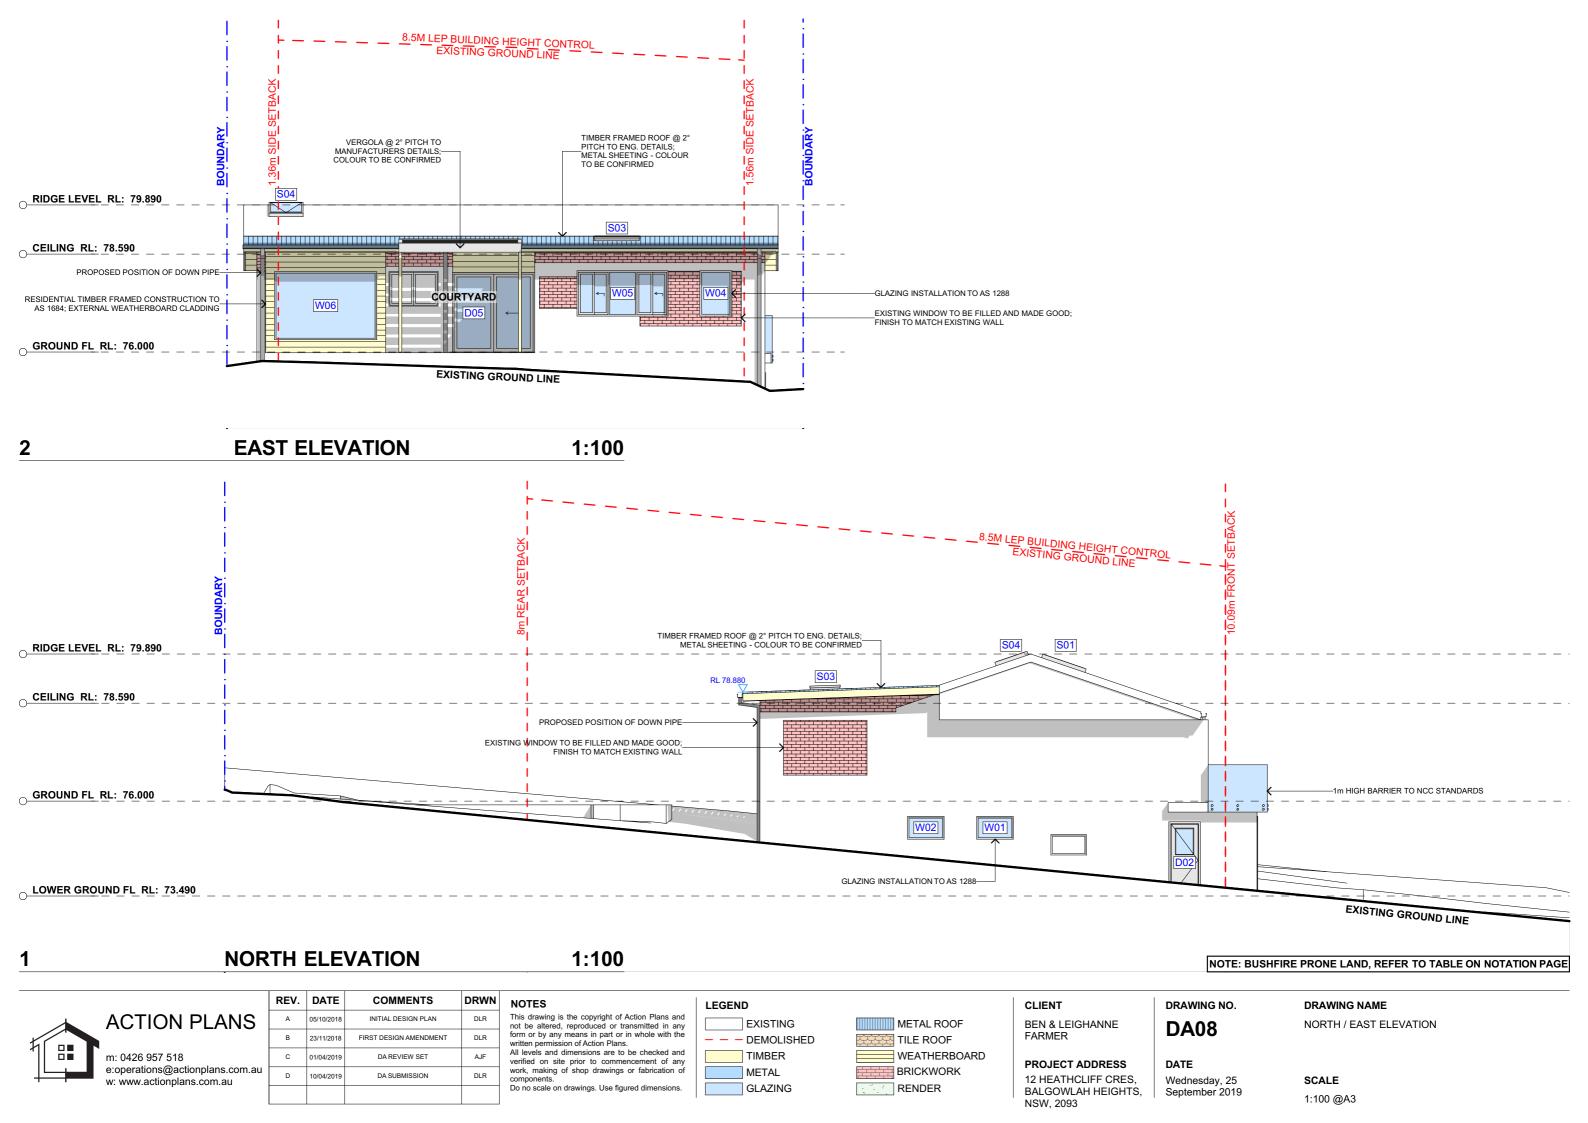

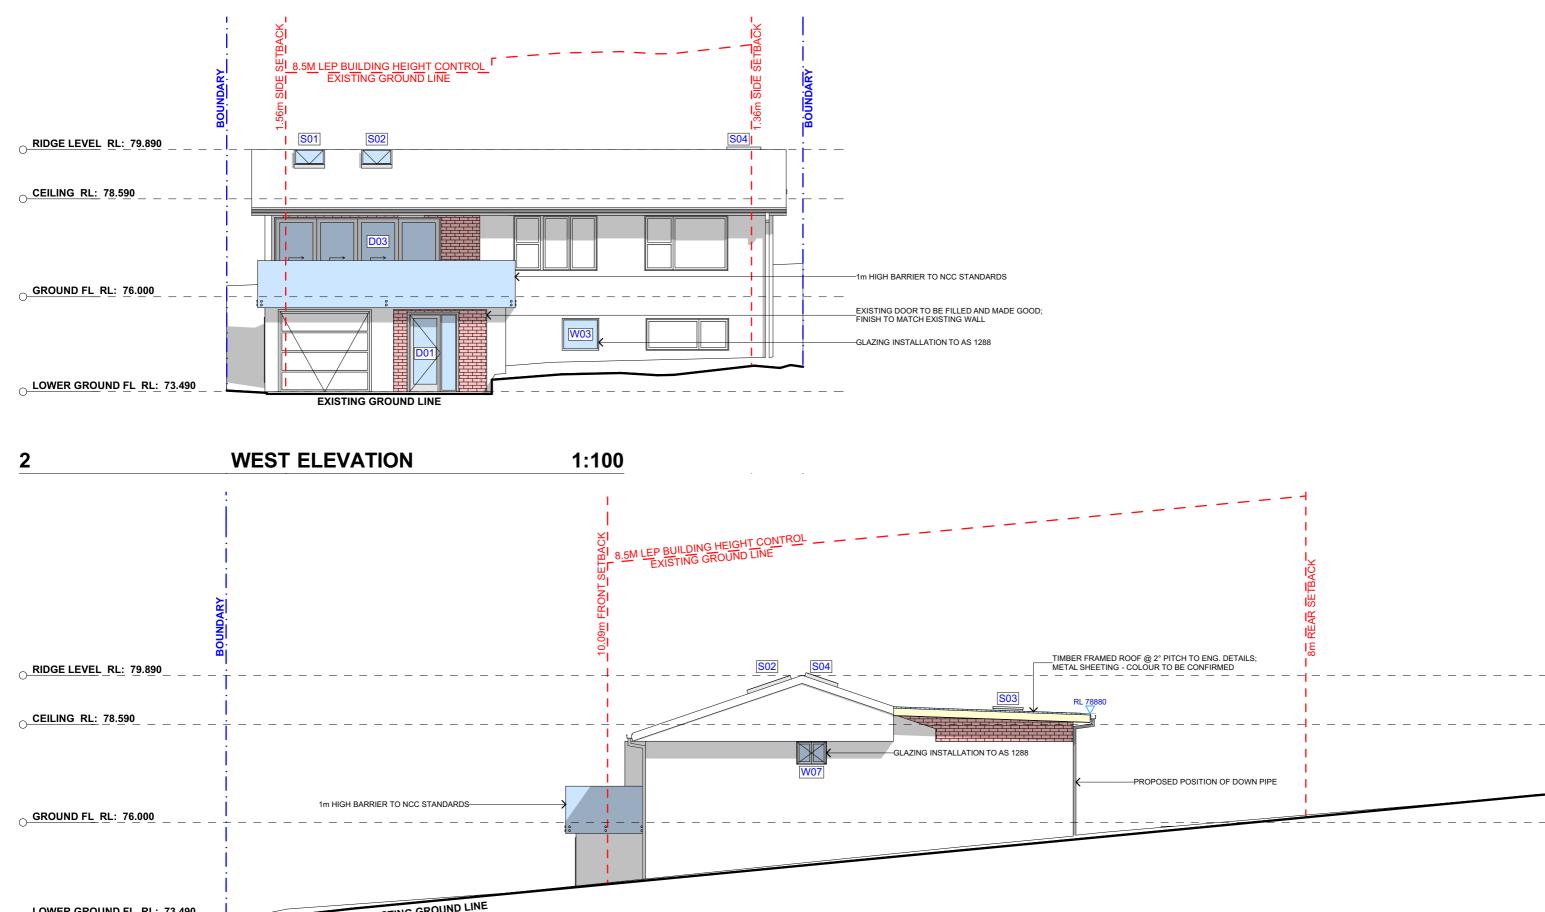

-EXISTING GROUND LINE __LOWER GROUND FL_RL: 73.490_ **SOUTH ELEVATION** 1:100 NOTE: BUSHFIRE PRONE LAND, REFER TO TABLE ON NOTATION PAGE REV. DATE COMMENTS DRWN NOTES CLIENT DRAWING NO. LEGEND DRAWING NAME This drawing is the copyright of Action Plans and not be altered, reproduced or transmitted in any form or by any means in part or in whole with the written permission of Action Plans.

All levels and dimensions are to be checked and verified on site prior to commencement of any work, making of shop drawings or fabrication of components. **ACTION PLANS** 05/10/2018 BEN & LEIGHANNE FARMER EXISTING METAL ROOF SOUTH / WEST ELEVATION **DA09** 23/11/2018 FIRST DESIGN AMENDMENT — — DEMOLISHED TILE ROOF TIMBER WEATHERBOARD m: 0426 957 518 DA REVIEW SET 01/04/2019

METAL

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GLAZING

BRICKWORK

RENDER

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10/04/2019

PROJECT ADDRESS

NSW, 2093

12 HEATHCLIFF CRES,

BALGOWLAH HEIGHTS,


DATE


Wednesday, 25

September 2019


SCALE

1:100 @A3

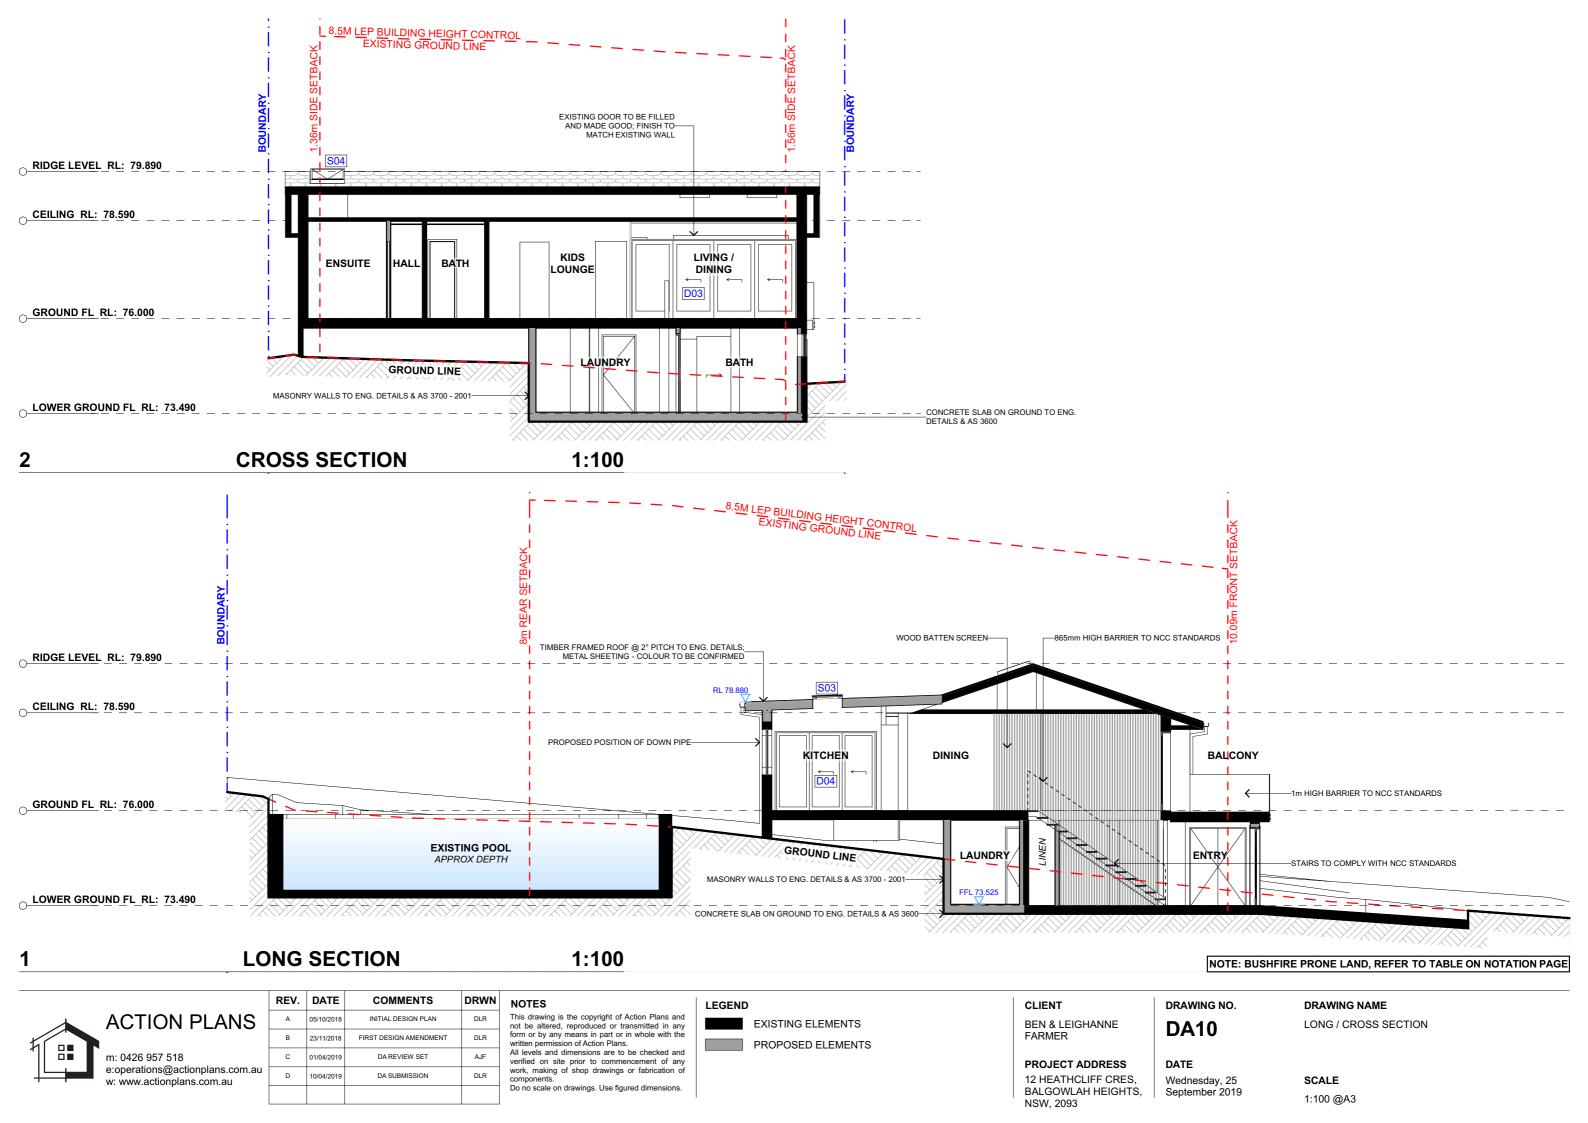

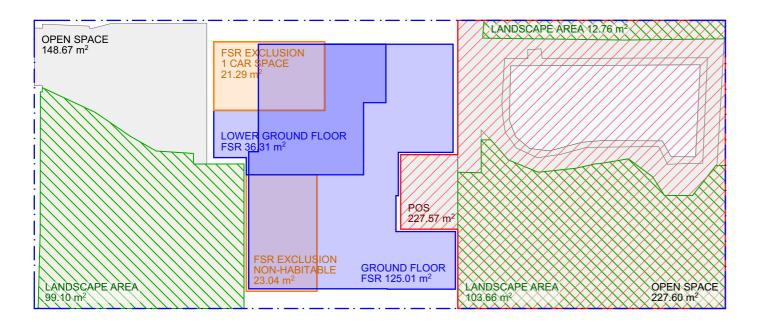

PROPOSED AREA CALCULATIONS

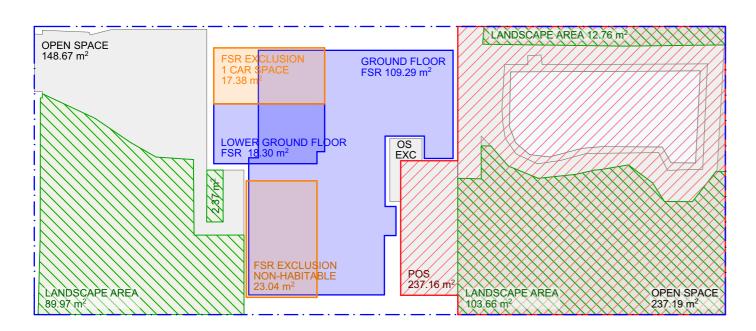

SITE AREA: 556.40m²

FLOOR SPACE RATIO: PERMISSABLE 250.38 m² (0:45 : 1) 127.59 m² (0:23 : 1) **EXISTING** PROPOSED 161.32 m² (0:29 : 1)

PRIVATE OPEN SPACE: REQUIRED **EXISTING** PROPOSED

GRASS CONC

TOTAL OPEN SPACE: REQUIRED 55.00% (306.20 m²)

EXISTING 69.35% (385.86 m²) **PROPOSED** 67.63% (376.27 m²)

LANDSCAPE AREA: % OF OPEN SPACE REQUIRED

35.00% (76.55 m²) 208.76 m² EXISTING PROPOSED 215.52 m²

1:200 **EXISTING AREA CALCULATIONS**



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BEN & LEIGHANNE **FARMER**

PROJECT ADDRESS

18.00 m²

237.16 m²

227.57 m²


12 HEATHCLIFF CRES, Wednesday, 25 BALGOWLAH HEIGHTS, September 2019 DRAWING NAME AREA CALCULATIONS


DATE

DA11

DRAWING NO.

SCALE 1:200 @A3

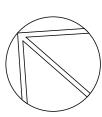

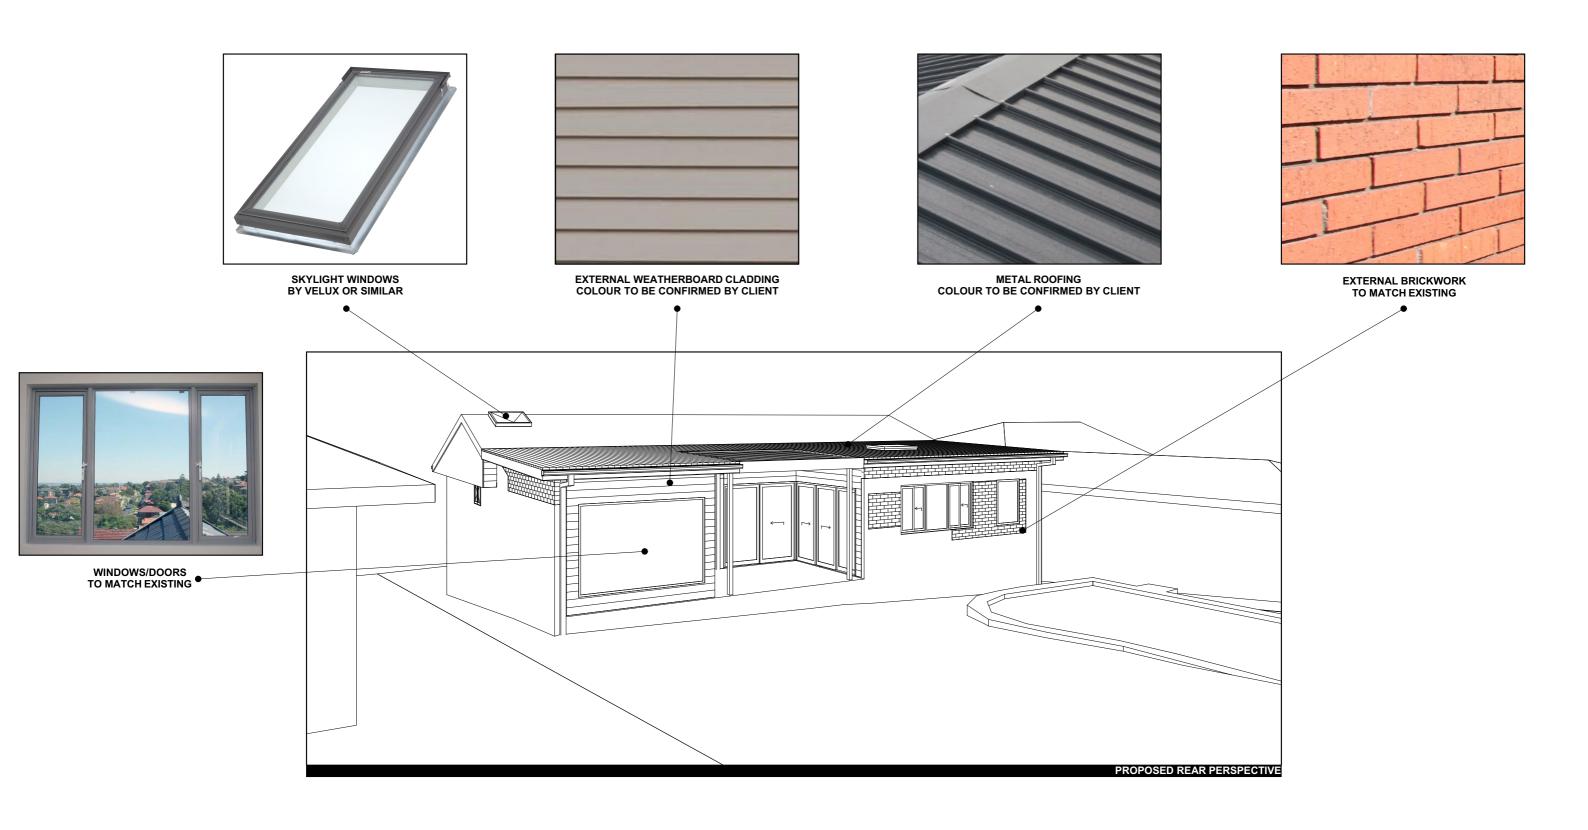



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	А	05/10/2018	INITIAL DESIGN PLAN	DLR	
	В	23/11/2018	FIRST DESIGN AMENDMENT	DLR	
	С	01/04/2019	DA REVIEW SET	AJF	
u	D	10/04/2019	DA SUBMISSION	DLR	

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BEN & LEIGHANNE FARMER

PROJECT ADDRESS


12 HEATHCLIFF CRES, BALGOWLAH HEIGHTS, NSW, 2093 DRAWING NO.


DA12


Wednesday, 25 September 2019

DATE

DRAWING NAME SAMPLE BOARD

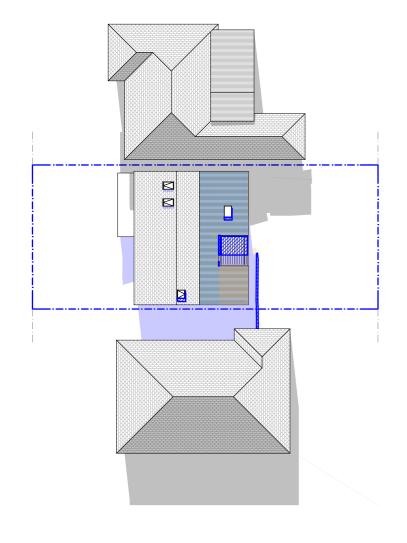

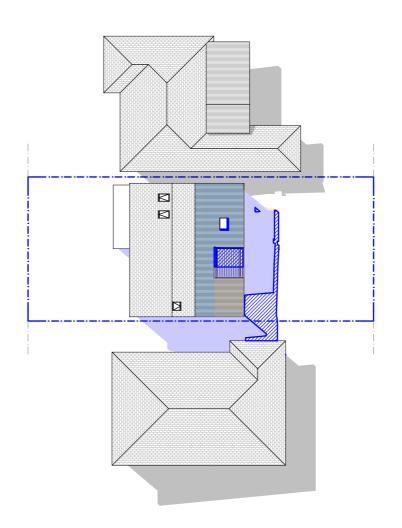

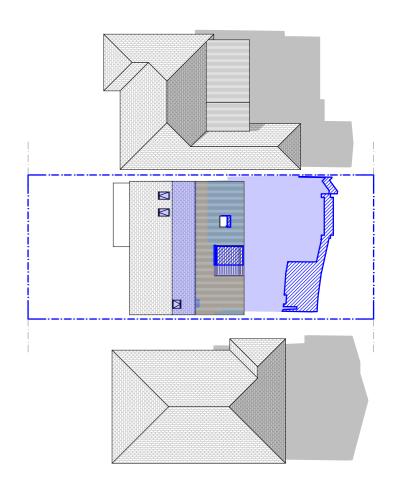

WINTER SOLSTICE 9AM 1:400

WINTER SOLSTICE 12PM 1:400

WINTER SOLSTICE 3PM 1:400 3

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REV.	DATE	COMMENTS	DRWN
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EXISTING SHADOWS - RETAINED EXISTING SHADOWS - REDUCED PROPOSED SHADOWS NEIGHBOURING SHADOWS

LEGEND

CLIENT

BEN & LEIGHANNE FARMER

PROJECT ADDRESS 12 HEATHCLIFF CRES,

BALGOWLAH HEIGHTS, NSW, 2093

DRAWING NO.

DA13

Wednesday, 25 September 2019

DATE

DRAWING NAME

WINTER SOLSTICE 9AM / 12PM / 3PM

SCALE

1:400 @A3





Building Sustainability Index www.basix.nsw.gov.au

Alterations and Additions

Certificate number: A344489_03

This certificate confirms that the proposed development will meet the NSW government's requirements for sustainability, if it is built in accordance with the commitments set out below. Terms used in this certificate, or in the commitments, have the meaning given by the document entitled "BASIX Alterations and Additions Definitions" dated 06/10/2017 published by the Department. This document is available at www.basix.nsw.gov.au

Secretary

Date of issue: Wednesday, 25, September 2019
To be valid, this certificate must be lodged within 3 months of the date of issue.



Project address					
Project name	#0446 - Ben & Leighanne Farmer_03				
Street address	12 HEATHCLIFF Crescent BALGOWLAH HEIGHTS 2093				
Local Government Area	Northern Beaches Council				
Plan type and number	Deposited Plan 758044				
Lot number	4				
Section number	29				
Project type					
Dwelling type	Separate dwelling house				
Type of alteration and addition	My renovation work is valued at \$50,000 or more, and does not include a pool (and/or spa).				

Glazing requirements

Windows and glazed doors

Certificate Prepared by (please complete before submitting to Council or PCA)
Name / Company Name: Action Plans
ABN (if applicable): 17118297587

Fixtures and systems	Show on DA Plans	Show on CC/CDC Plans & specs	Certifier Check
Lighting			
The applicant must ensure a minimum of 40% of new or altered light fixtures are fitted with fluorescent, compact fluorescent, or light-emitting-diode (LED) lamps.		✓	✓
Fixtures			
The applicant must ensure new or altered showerheads have a flow rate no greater than 9 litres per minute or a 3 star water rating.		✓	✓
The applicant must ensure new or altered toilets have a flow rate no greater than 4 litres per average flush or a minimum 3 star water rating.		✓	✓
The applicant must ensure new or altered taps have a flow rate no greater than 9 litres per minute or minimum 3 star water rating.		✓	

project

of

escription

Construction	Show on DA Plans	Show on CC/CDC Plans & specs	Certifier Check		
Insulation requirements					
	d construction (floor(s), walls, and ceilings/roofs ation is not required where the area of new cons where insulation already exists.		V	√	~
Construction	Additional insulation required (R-value)	Other specifications			
concrete slab on ground floor.	nil				
external wall: framed (weatherboard, fibro, metal clad)	R1.30 (or R1.70 including construction)				
external wall: brick veneer	R1.16 (or R1.70 including construction)				
flat ceiling, flat roof: framed	ceiling: R2.50 (up), roof: foil/sarking	medium (solar absorptance 0.475 - 0.70)			

Legend

In these commitments, "applicant" means the person carrying out the development.

Commitments identified with a "\"" in the "Show on DA plans" column must be shown on the plans accompanying the development application for the proposed development (if a development application is to be lodged for the proposed development).

Commitments identified with a "\sqrt{"}" in the "Show on CC/CDC plans & specs" column must be shown in the plans and specifications accompanying the application for a construction certificate / complying development certificate for the proposed development.

Commitments identified with a "\" in the "Certifier check" column must be certified by a certifying authority as having been fulfilled, before a final occupation certificate for the development may be issued.

	VIII IGOVVO C	and glazed	40015							
izan vinicou or glazed door with standard aluminium or timber frames and single clear or toned glass may althour nation the description, or, was a U-value and a Solar Heat Sain Confedent (1916) or greater than that listed in the table below. Total system U-values and SHGCs must be calculated in accordance with National Fenestration Rating Council (NFRC) conditions. To projections described in milliments, the leading sight of each even, perplay, varied by the heat of the window or glazed door and no more than 2400 mm above the sill. **Pargolas with flood batters must have batteres parallel to the window or glazed door above which they are situated, unless the pergola also hades a perpendicular window. The spacing between batters must have a shading coefficient of less than 0.35. **Variety of the standard aluminium of the window or glazed door above which they are situated, unless the pergola also hades a perpendicular window. The spacing between batters must not be more than 50 mm. **Variety of the window of projection of the window or glazed door above which they are situated, unless the pergola also hades a perpendicular window. The spacing between batters must have a shading coefficient of less than 80% shading ratio). Adjustable blades with the personal project of the window of glazed door, as percentage in plan view. **Windows and glazed doors glazing requirements** Windows an							he specifications listed in the table below.	✓	✓	~
ave a U-value and a Solar Heat Gain Coefficient (SHGC) no greater than that listed in the table below. Total system U-values and SHGCs us the calculated no accordance with National Fenestration Rating Council (FHCR) conditions. or projections described in millimetres, the leading edge of each eave, pergola, verandah, balcony or awning must be no more than 500 mm bove the head of the window or glazed door and no more than 2400 mm above the sill. vergolas with fixed batters must have batters parallel to the window or glazed door above which they are situated, unless the pergola also hades a perpendicular window. The spacing between battern suns not be more than 50 mm. The state of the situate of the si	he followin	ig requiremen	its must also	be satisf	ied in relatior	n to each window and glazed door:			✓	~
bove the head of the window or glazed door and no more than 2400 mm above the sill. rergolas with fixed batters must have batters parallel to the window or glazed door above which they are situated, unless the pergola also hades a perpendicular window. The spacing between batters must not be more than 50 mm. rergolas with fixed batters must have batters parallel to the window or glazed door above which they are situated, unless the pergola also hades a perpendicular window. The spacing between batters must not be more than 50 mm. rergolas with adjustable shading may have adjustable blades or removable shade cloth (not less than 80% shading ratio). Adjustable blades used to the window and glazed door, as pecified in the tovershadowing column in the table below. Vindows and glazed doors glazing reculirements without the control of the period	ave a U-va	ve a U-value and a Solar Heat Gain Coefficient (SHGC) no greater than that listed in the table below. Total system U-values and SHGC ust be calculated in accordance with National Fenestration Rating Council (NFRC) conditions.								~
ergolas with fixed battens must have battens parallel to the window or glazed door above which they are situated, unless the pergola also hades a perpendicular window. The spacing between battens must not be more than 50 mm. Fregolas with dubtable shading may have adjustable blades or removable shade doft (not less than 80% shading ratio). Adjustable blades used voted in the parallel pa							ony or awning must be no more than 500 mm	✓	✓	~
Anders a perpendicular window. The spacing between batters must not be more than 50 mm. gregoise with adjustable blades or removable shade cloth (not less than 80% shading ratio). Adjustable blades used overlap in plan view. Wershadowing buildings or vegetation must be of the height and distance from the centre and the base of the window and glazed door, as pecified in the vovershadowing column in the table below. Windows and glazed doors glazing requirements Window 7 door Oilentation Area of Overshadowing Column in the table below. Windows and glazed doors glazing requirements Window 7 door Oilentation Area of Overshadowing Column in the table below. Windows and glazed doors glazing requirements Window 7 door Oilentation Area of Overshadowing Column in the table below. Windows and glazed doors glazing requirements Window 7 door Oilentation Area of Overshadowing Column in the table below. Windows and glazed doors glazing requirements Window 7 door Oilentation Area of Overshadowing Column in the table below. Windows and glazed doors glazing requirements Window 7 door Oilentation Area of Overshadowing Column in the table below. Windows 3 door Oilentation Area of Overshadowing Column in the table below. Windows 3 door Oilentation Area of Overshadowing Column in the table below. Windows 4 door Oilentation Area of Overshadowing Column in the table below. Windows 4 door Oilentation Area of Oilentation Oilentatio	ergolas wit	th polycarbon	ate roof or s	similar trar	nslucent mate	erial must have a shading coefficient	of less than 0.35.		✓	~
usus toverlap in plan view. Weershadowing buildings or vegetation must be of the height and distance from the centre and the base of the window and glazed door, as decided in the 'overshadowing' column in the table below. Window and glazed doors glazing requirements Window / door Orientation Area Overshadowing glass in the column of the centre and the base of the window and glazed door, as decided in the 'overshadowing' column in the table below. Will not be a column of the centre and the base of the window and glazed door, as decided in the 'overshadowing' column in the table below. Will not be a column of the centre and the base of the window and glazed door, as decided in the 'overshadowing' column in the table below. Will not be a column of the centre and the base of the window and glazed door, as decided in the 'overshadowing' column in the table below. Will not be a column of the centre and the base of the window and glazed door, as decided in the 'overshadowing' column in the table below. Will not be a column of the centre and the base of the window and glazed door, as decided in the centre and the base of the window and glazed door, as decided in the centre and the base of the window and glazed door, as decided in the centre and t							h they are situated, unless the pergola also		✓	~
Windows and glazed doors glazing requirements				y have ad	justable blad	es or removable shade cloth (not les	s than 80% shading ratio). Adjustable blades		✓	✓
Mindow / door Orientation Area of Orientation Orie						nt and distance from the centre and t	he base of the window and glazed door, as	✓	✓	✓
	Vindows	and glaze	d doors g	lazing r	equireme	nts		-		
No NE 0.58 2.61 1.44 none		oor Orientatio			adowing	Shading device	Frame and glass type			
No	10.		inc. frame							
U-value: 7.63, SHGC: 0.75 Value: 7.63, SHGC	V01	NE	, ,	2.61	1.44	none				
U-value: 7.63, SHGC: 0.75 U-value: 7.63,	V02	NE	0.58	2.61	1.44	none				
Seboom S	V03	NW	0.82	2.5	1.5	awning (adjustable) >=900 mm				
SE	V04	SE	1.02	0	0					
Section Sect	V05		2.89							
U-value: 7.63, SHGC: 0.75 Standard aluminium, single clear, (or U-value: 7.63, SHGC: 0.75 U-val						>=600 mm	U-value: 7.63, SHGC: 0.75)			
U-value: 7.63, SHGC: 0.75)							U-value: 7.63, SHGC: 0.75)			
U-value: 7.63, SHGC: 0.75) Standard aluminium, single clear, (or U-value: 7.63, SHGC: 0.75) U-val	001	NW	2.66	0	0	awning (adjustable) >=900 mm				
>=900 mm	002	NE	1.46			none				
mm U-value: 7.63, SHGC: 0.75) SE 4.56 0 0 eave/verandah/pergola/balcony standard aluminium, single clear, (or U-value: 7.63, SHGC: 0.75) kylights the applicant must install the skylights in accordance with the specifications listed in the table below. the following requirements must also be satisfied in relation to each skylight: ach skylight may either match the description, or, have a U-value and a Solar Heat Gain Coefficient (SHGC) no greater than that listed in the table below. Show on DA Plans Show on DA Plans Show on CCC/CDC Ch						>=900 mm	U-value: 7.63, SHGC: 0.75)			
kylights the applicant must install the skylights in accordance with the specifications listed in the table below. the following requirements must also be satisfied in relation to each skylight: ach skylight may either match the description, or, have a U-value and a Solar Heat Gain Coefficient (SHGC) no greater than that listed in the table below. Show on DA Plans Show on DA Plans Show on DA Plans						mm	U-value: 7.63, SHGC: 0.75)			
The applicant must install the skylights in accordance with the specifications listed in the table below. The following requirements must also be satisfied in relation to each skylight: The following requirements must also be satisfied in relation to each skylight: The following requirements must also be satisfied in relation to each skylig	005	SE	4.56	0	0					
The following requirements must also be satisfied in relation to each skylight: Each skylight may either match the description, or, have a U-value and a Solar Heat Gain Coefficient (SHGC) no greater than that listed in the table below. Show on DA Plans CC/CDC Ch	kylights									
Sach skylight may either match the description, or, have a U-value and a Solar Heat Gain Coefficient (SHGC) no greater than that listed in the table below. Show on DA Plans CC/CDC Ch	he applicar	nt must install	I the skyligh	ts in acco	rdance with t	he specifications listed in the table b	elow.	✓	✓	~
Slazing requirements Show on DA Plans CC/CDC Ch	he followin	ig requiremen	its must also	be satisf	ied in relatior	n to each skylight:			~	~
DA Plans CC/CDC Ch			match the d	escription	, or, have a l	J-value and a Solar Heat Gain Coeff	icient (SHGC) no greater than that listed in		✓	✓
DA Plans CC/CDC Ch								Chow ex	Chow ex	Contific
specs	azing re	equirements							CC/CDC Plans &	Certifier Check
	vternal au	nings and lour	Vros muet fi	ıllıy ehada	the skylight	ahove which they are situated when	fully drawn or closed			~

Glazing require	ements			DA Plans	CC/CDC Plans & specs	Check
External awnings	and louvres must fo	ully shade the skylight above which they are	re situated when fully drawn or closed.		~	✓
Skylights glaz	ing requireme	nts				
Skylight number	Area of glazing inc. frame (m2)	Shading device	Frame and glass type			
S01	0.92	external adjustable awning or blind	aluminium, moulded plastic single clear, (or U-value: 6.21, SHGC: 0.808)			
S02	0.92	external adjustable awning or blind	aluminium, moulded plastic single clear, (or U-value: 6.21, SHGC: 0.808)			
S03	0.92	external adjustable awning or blind	aluminium, moulded plastic single clear, (or U-value: 6.21, SHGC: 0.808)			
S04	0.757	no shading	aluminium, moulded plastic single clear, (or U-value: 6.21, SHGC: 0.808)			

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BEN & LEIGHANNE FARMER

PROJECT ADDRESS

12 HEATHCLIFF CRES, BALGOWLAH HEIGHTS, NSW, 2093

DRAWING NO.

DA14

DRAWING NAME BASIX COMMITMENTS

DATE
Wednesday, 25
September 2019