
LEP FLOOR AREA - EXISTING	m²
EXISTING GARAGE	26.00
EXISTING HOUSE	133.21
TOTAL EXISTING FLOOR AREA	159.21 m²

LEP FLOOR AREA - PROPOSE	ED m²
EXISTING GARAGE	26.00
EXISTING HOUSE	133.21
NEW FLOOR AREA	33.93
TOTAL PROPOSED FLOOR AR	<b>EA</b> 193.14 m <sup>2</sup>

LOT 15 DP 28466

SITE AREA = 716.05 m<sup>2</sup>



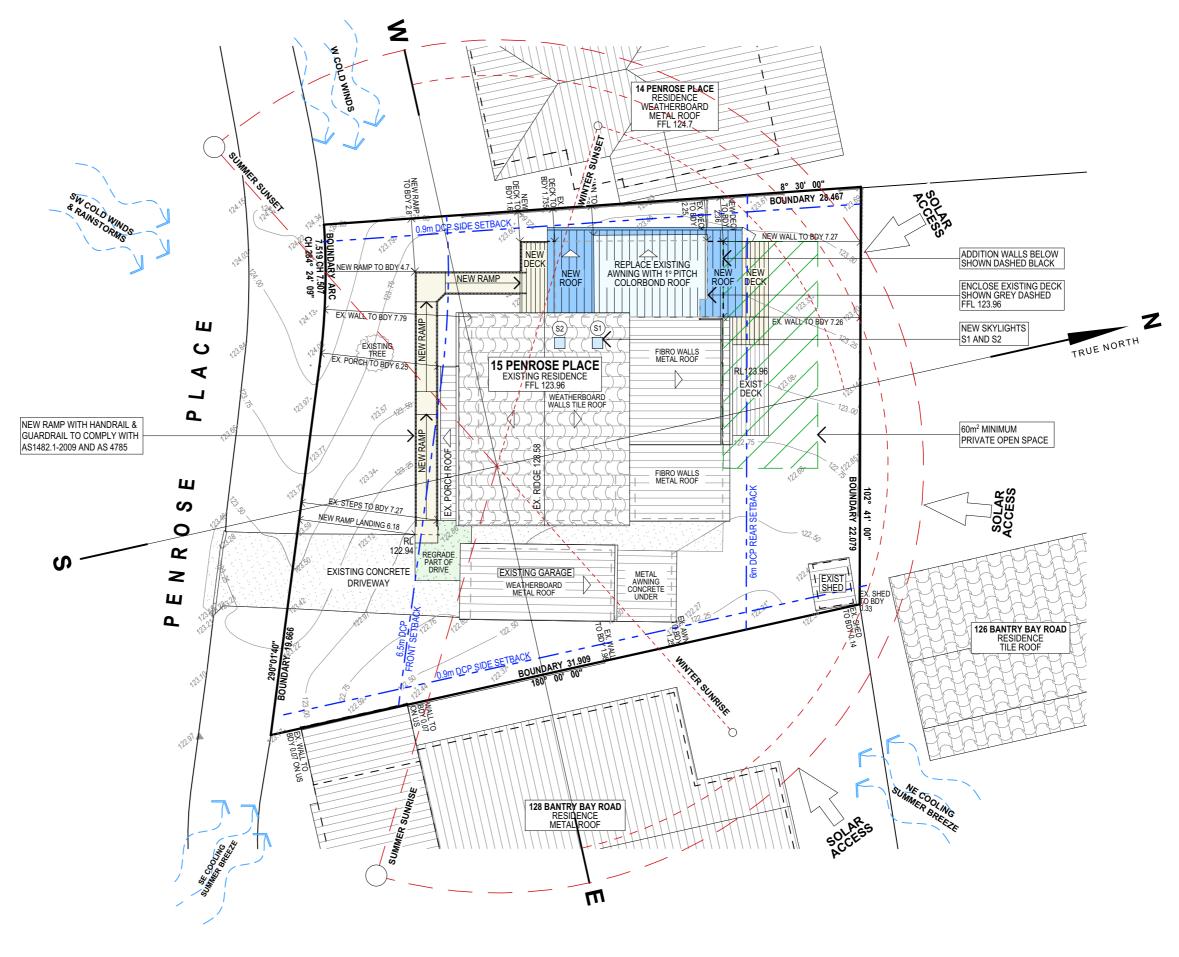

# **SITE ANALYSIS PLAN**



NOTES (E & OE)

All structures including stormwater & drainage to engineer's details.
 Do not obtain dimensions by scaling drawings.
 All dimensions are to be checked on site prior to starting work.
 These drawings are to be read in conjunction with all other consultant's drawings and


New materials are to be used throughout unless otherwise noted.
 Concrete footings, slab, structural beams or any other structural members are to be designed.

## \_\_\_\_\_ JJ Drafting Division of JJ DRAFTING AUSTRALIA PTY LTD

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	REV:	DATE:	DESCRIPTION:
	Α	01/07/2021	ISSUE TO BUSHFIRE CONSULTANT FOR QUOTE
	В	05/07/2021	EXISTING DECK INCLUDED
	С	-	NOT ISSUED
	D	19/08/2021	ISSUE FOR DA
u			

1	PROPOSED ALTERATIONS AND ADDITIONS 15 PENROSE PLACE FRENCHS FOREST NSW 2086 CLIENT:	DATE: JUNE 2021	DRAWN BY:	SCALE: 1:200 @ A3
1	STEVE KHATCHADOURIAN	JOB No:	CHECKED BY:	DRAWING No:
1	DRAWING TITLE: SITE ANALYSIS PLAN	914/21	JJ	DA.01



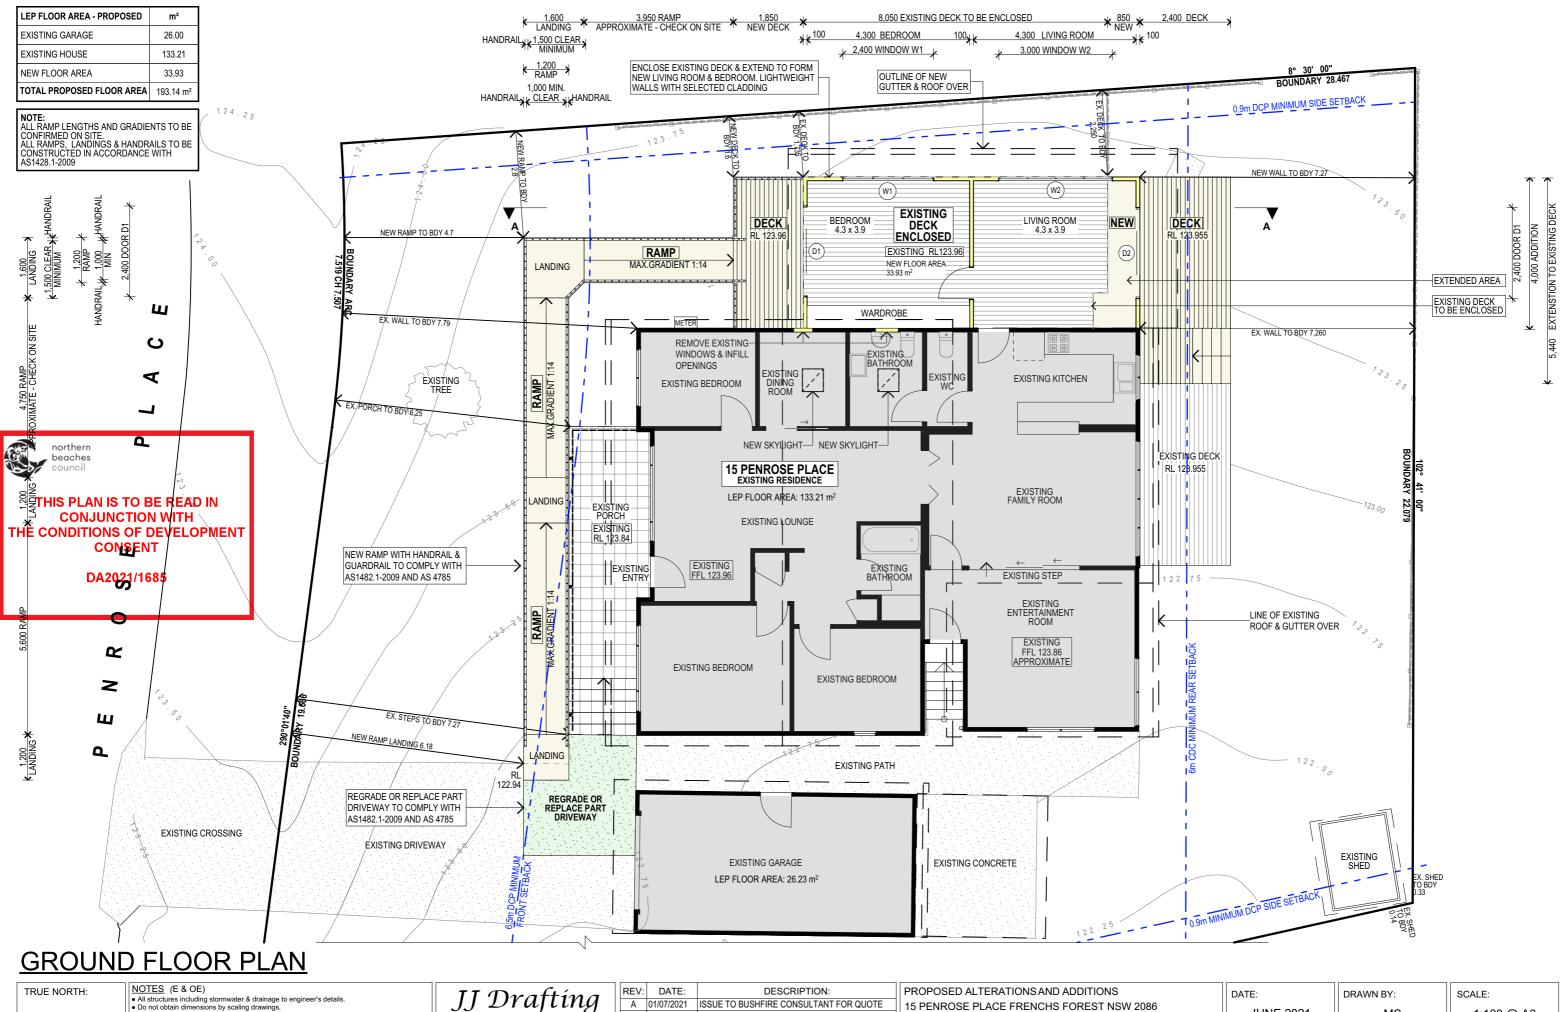

 All structures including stormwater & drainage to engineer's details
 Do not obtain dimensions by scaling drawings.
 All dimensions are to be checked on site prior to starting work. These drawings are to be read in conjunction with all other consultant's drawings and

specifications.

• All workmanship & materials shall be in accordance with the requirements of current editions

including amendments of the National Construction Code, relevant Australian Standards & local council requirements.

New materials are to be used throughout unless otherwise noted.

Concrete footings, slab, structural beams or any other structural members are to be designed by a practicing engineer.


## \_\_\_ JJ Drafting Division of JJ DRAFTING AUSTRALIA PTY LTD


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l	REV:	DATE:	DESCRIPTION:
ı	Α	01/07/2021	ISSUE TO BUSHFIRE CONSULTANT FOR QUOTE
ı	В	05/07/2021	EXISTING DECK INCLUDED
ı	С	06/07/2021	BEDROOM EXTENDED
ı	D	19/08/2021	ISSUE FOR DA
ı			
ı			
ı			

	PROPOSED ALTERATIONS AND ADDITIONS 15 PENROSE PLACE FRENCHS FOREST NSW 2086 CLIENT:	DATE: JUNE 2021	DRAWN BY:	SCALE: 1:100 @ A3
1	STEVE KHATCHADOURIAN	JOB No:	CHECKED BY:	DRAWING No:
	DRAWING TITLE: FLOOR PLAN	914/21	JJ	DA.03

@ A3



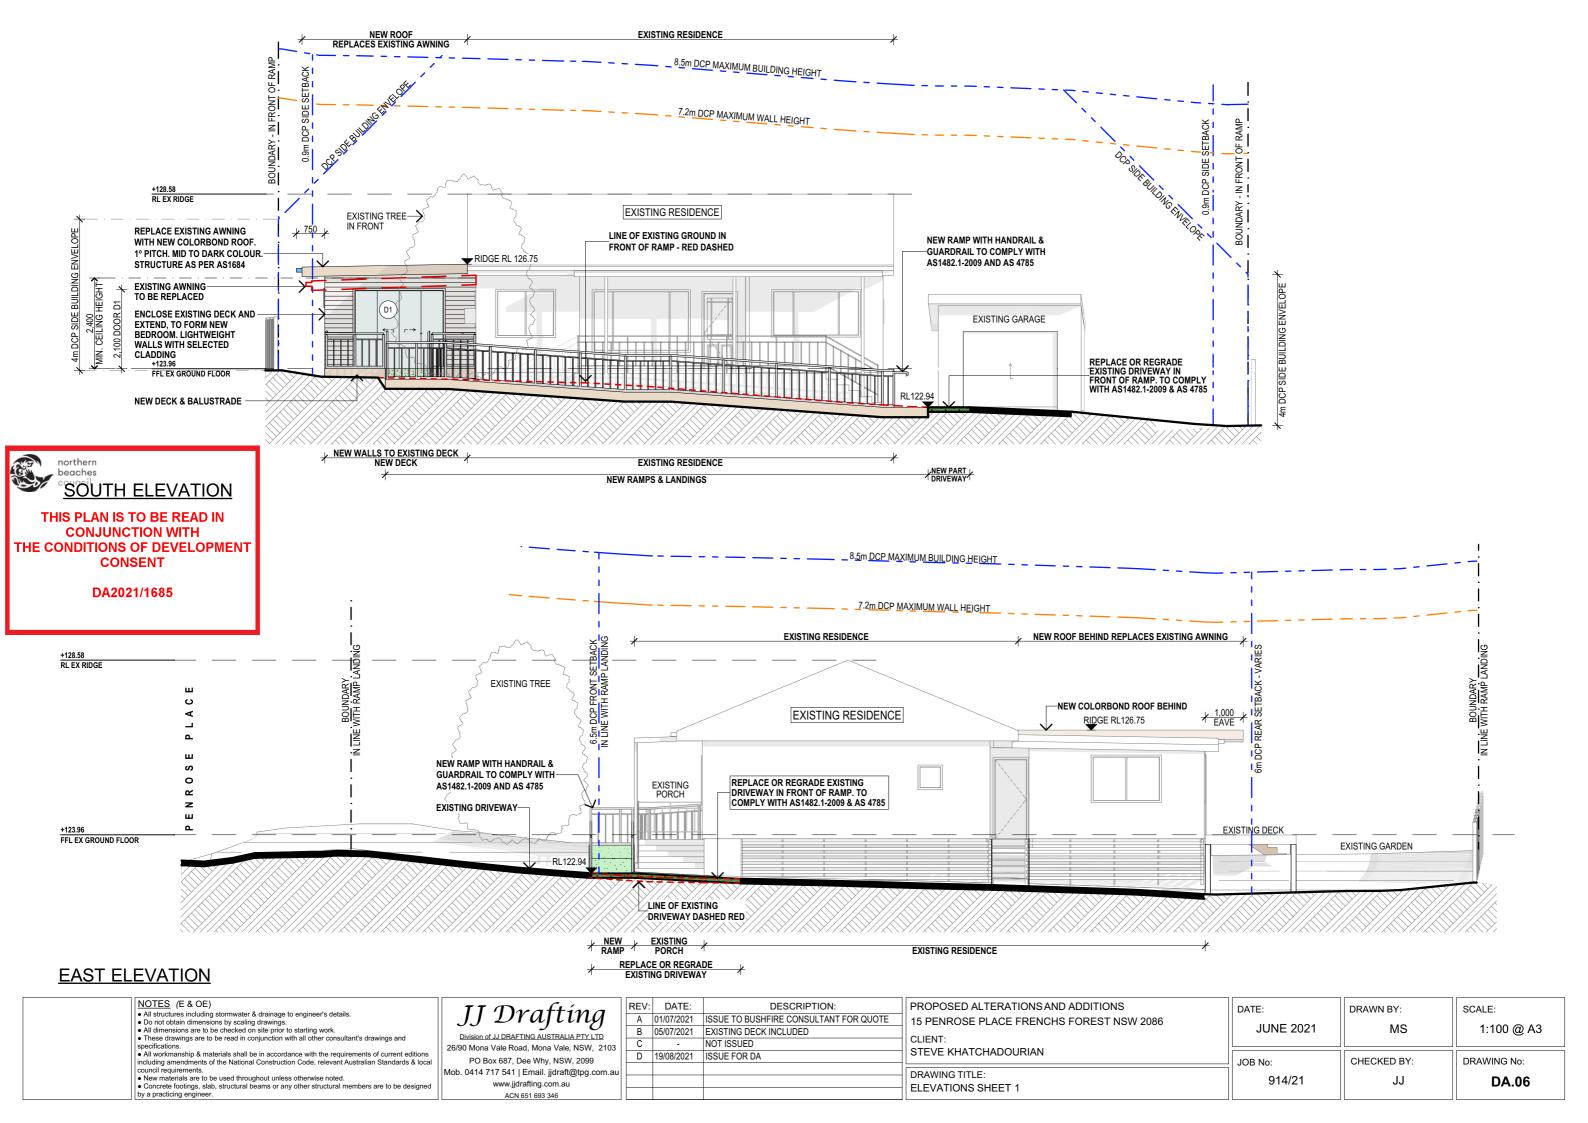

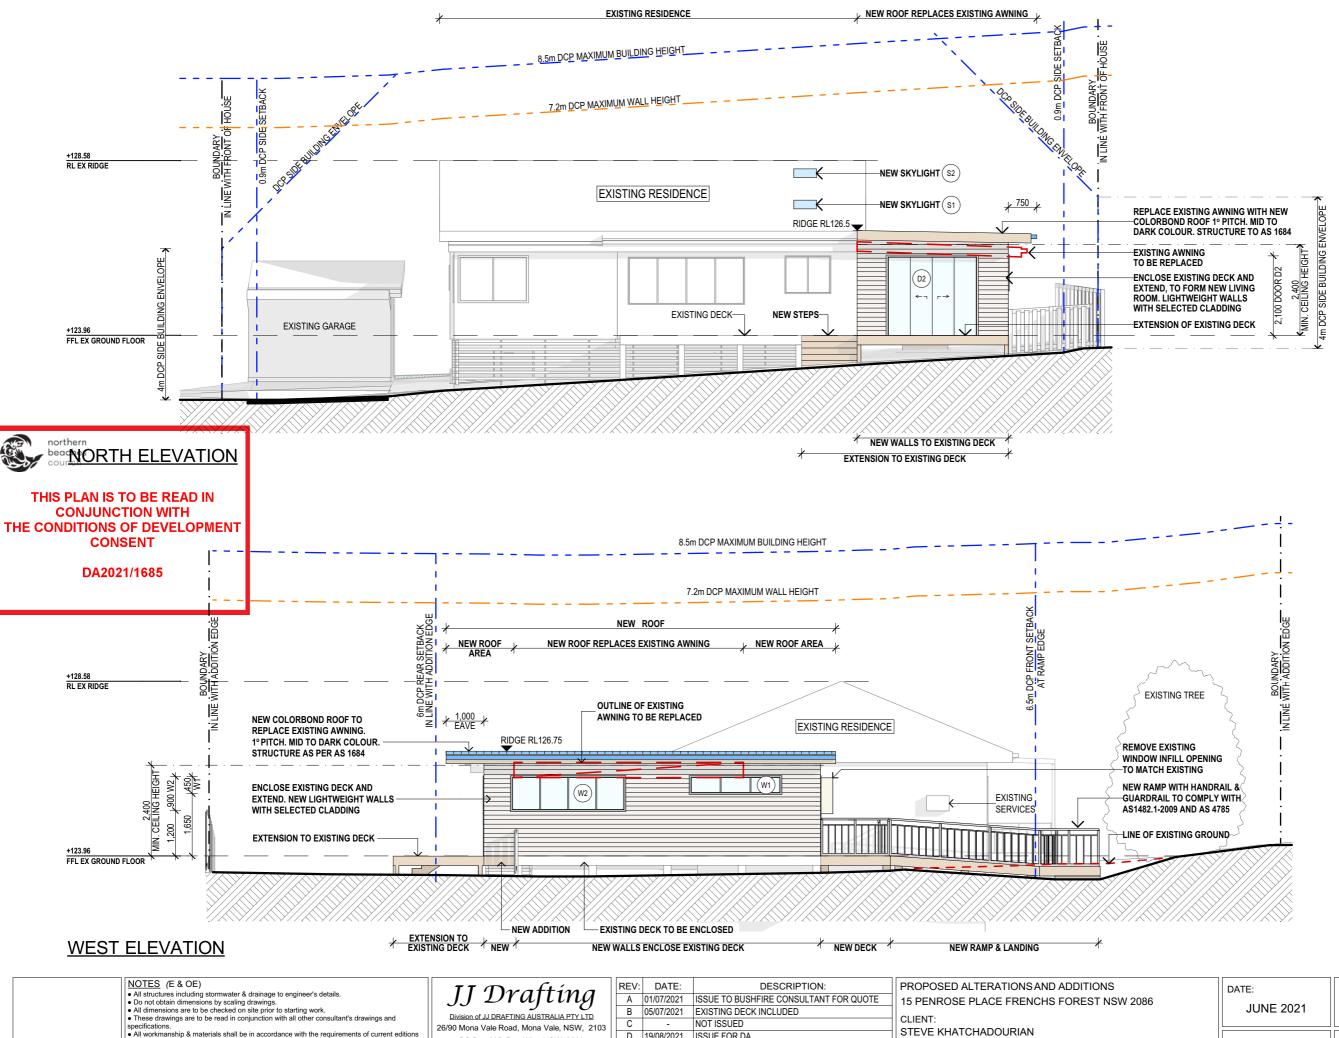
- New materials are to be used throughout unless otherwise noted.
   Concrete footings, slab, structural beams or any other structural members are to be designed.
- by a practicing engineer.
- 26/90 Mona Vale Road, Mona Vale, NSW, 2103 PO Box 687, Dee Why, NSW, 2099 Mob. 0414 717 541 | Email. jjdraft@tpg.com.a www.jjdrafting.com.au ACN 651 693 346

	REV:	DATE:	DESCRIPTION:
	Α	01/07/2021	ISSUE TO BUSHFIRE CONSULTANT FOR QUOTE
	В	05/07/2021	EXISTING DECK INCLUDED
13	С	-	NOT ISSUED
	D	19/08/2021	ISSUE FOR DA
au			

	PROPOSED ALTERATIONS AND ADDITIONS 15 PENROSE PLACE FRENCHS FOREST NSW 2086 CLIENT:	DATE: JUNE 2021	DRAWN BY:	SCALE: 1:100 @ A3
1	STEVE KHATCHADOURIAN	JOB No:	CHECKED BY:	DRAWING No:
1	DRAWING TITLE: ELEVATIONS SHEET 2	914/21	JJ	DA.07

@ A3

### **BASIX REQUIREMENTS:** INCLUSIONS FOR 15 PENROSE PLACE FRENCHS FOREST NSW 2086 LIGHTING REQUIREMENTS 40% OF NEW OR ALTERED LIGHT FIXTURES TO BE FITTED WITH FLUORESCENT, COMPACT FLUORESCENT, OR LIGHT-EMITTING-DIODE (LED) LAMPS INSULATION REQUIREMENTS CONSTRUCTION ADDITIONAL INSULATION REQUIREMENT (R-VALUE) / OTHER SUSPENDED FLOOR WITH OPEN R 1.50 (DOWN) (INCLUDING CONSTRUCTION) SUBFLOOR: OTHER / UNDECIDED SUSPENDED FLOOR WITH ENCLOSED R 1.30 (DOWN) (INCLUDING CONSTRUCTION) SUBFLOOR: OTHER / UNDECIDED EXTERNAL WALL: FRAMED R 1.30 (OR R 1.70 INCLUDING CONSTRUCTION) (WEATHERBOARD, FIBRO, METAL CLAD) EXTERNAL WALL: OTHER / UNDECIDED R 1.70 INCLUDING CONSTRUCTION FLAT CEILING, FLAT ROOF: FRAMED CEILING: R2.08 (UP), ROOF: FOIL BACKED BLANKET (55 mm) MEDIUM (SOLAR ABSORPTANCE 0.475 - 0.70) **GLAZING REQUIREMENTS GLAZING DOORS / WINDOWS** - STANDARD ALUMINIUM, SINGLE CLEAR, (or U-value: 7.63, SHGC: 0.75) WINDOWS - W1 AND W2; DOORS - D1 AND D2 **GLAZING SKYLIGHTS** TIMBER, LOW-E INTERNAL, / ARGON FILL / CLEAR EXTERNAL (U-value: 2.5, SHGC: 0.456) SKYLIGHTS - S1 AND S2

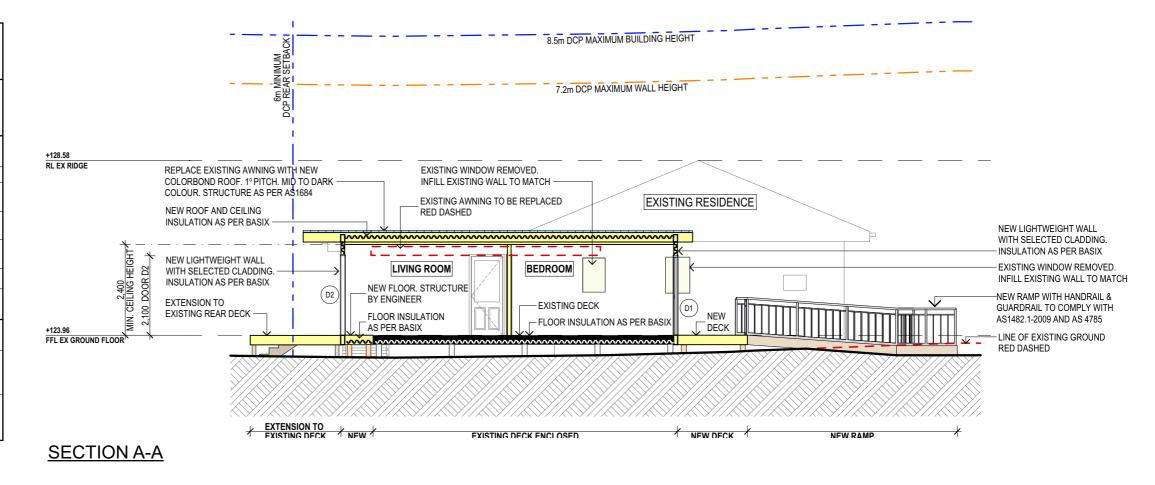

### THIS PLAN IS TO BE READ IN **CONJUNCTION WITH** THE CONDITIONS OF DEVELOPMENT **CONSENT**

## SPECIFICATION NOTES DA2021/1685

PROVIDE PLASTERBOARD LINING

INSTALL TO MANUFACTURERS SPECIFICATIONS & AS 2589

BRICK VENEER WALLS WITH SELECTED BRICKS TO DWFI LING

- LIGHTWEIGHT TIMBER CLADDING OR SIMILAR TO SINGLE GARAGE/GYM.

- GROUND FLOOR TO BE TIMBER FRAMED FINISHED WITH BOARD OR T&G HARDWOOD FLOORING.

- SHALL BE INSTALLED TO COMPLY WITH AS1684 AS AMENDED FOR TIMBER COMPONENTS OR AS3620

FOR LIGHTWEIGHT STEEL FRAMING SECTIONS OR AS PER THE NASH ALTERNATIVES TO AS 3623.

- SHALL BE INSTALLED IN ACCORDANCE WITH AS3660.

### PROFILED STEEL ROOF:

- DESIGN AND INSTALLATION SHALL BE IN ACCORDANCE WITH AS/NZS 1562

- COLORBOND ROOF CLADDING

SHALL BE IN ACCORDANCE WITH NCC VOL.1 PART B1.4 OR VOL.2 PART 3.2.3.
- ALL WORKMANSHIP AND MATERIALS SHALL BE IN ACCORDANCE WITH CURRENT EDITIONS OF THE

### FOOTINGS

FOOTINGS TO BE IN ACCORDANCE WITH AS1480.

- FOOTINGS TO BE IN ACCORDANCE WITH NCC VOL.2 PARTS 3.2.3, 3.2.4 AND 3.2.5 - ALL REINFORCEMENTS SHALL CONFORM TO AS1302, AS1303 AND AS1304.

TIMBER TO COMPLY WITH AS1170.2 OR AS4055 - ALL WORKMANSHIP AND MATERIALS SHALL BE IN ACCORDANCE WITH AS1684 AND 1720 AS APPLICABLE.

BRICK AND BLOCKWORK:
- CONSTRUCTION OF MASONRY BUILDINGS SHALL BE AS PER AS3700 OR AS4773.

### TIMBER FRAMING:

- TO COMPLY WITH NCC VOL 2 PART 3.4 - GROUND FLOOR TIMBERS SHALL BE ONLY OF HARDWOOD, CYPRESS PINE OR PRESSURE TREATED RADIATA OR CANADA PINE BELOW A HEIGHT OF 300mm ABOVE FINISHED GROUND LEVEL AND MUST NOT BE BUILT INTO BRICKWORK.

- SUBFLOOR VENTILATION SHALL CONFORM TO NCC VOL.2 PART 3.4.1.
- IN BUSHFIRE PRONE AREAS SPECIAL CONDITIONS APPLY
- WHERE TERMITE BARRIERS NEED TO BE INSPECTED, 400mm CLEARANCE IS REQUIRED BETWEEN THE UNDERSIDE OF BEARER AND GROUND SURFACE.
- USE TREATED TIMBER WHERE REQUIRED FOR DURABILITY.
- DO NOT USE TIMBER UNSUITABLE FOR EXPOSURE TO MOISTURE IN EXPOSED LOCATION.
   PROVIDE STRUCTURE BRACING IN ACCORDANCE WITH AS1684
- PROVIDE STRUCTURE TIEDOWN IN ACCORDANCE WITH AS1684
- USE GALVANISED FIXINGS WHERE EXPOSED TO WEATHER

### TERMITE CONTROL:

- TO BE IN ACCORDANCE WITH TO AS3660.1 - SHALL BE IN ACCORDANCE WITH NCC VOL.2 PART 3.1.3 OR VOL.1 PART B1.4.

- SELECTION AND INSTALLATION OF METAL RAINWATER GOODS REFER TO AS2180

- FLASH PROJECTIONS ABOVE THE ROOF WITH TWO PART FLASHINGS CONSISTING OF AN APRON FLASHING AND OVER FLASHING, WITH AT LEAST  $100\,\mathrm{mm}$  OVERLAP.

PROVIDE FOR INDEPENDENT MOVEMENT BETWEEN ROOF AND PROJECTION

### CONCRETE BLOCKS OR BRICKS:

TO COMPLY WITH TO AS4455 MASONRY BUILDING BLOCKS/PAVER.

40% OF NEW OR ALTERED LIGHT FIXTURES TO BE FITTED WITH FLUORESCENT, COMPACT FLUORESCENT, OR LIGHT-EMITTING-DIODE (LED) LAMPS

- ALL FRAMED WINDOWS SHALL BE INSTALLED IN ACCORDANCE WITH AS2047-48 FOR ALUMINIUM WINDOWS AND AS2047 FOR TIMBER WINDOWS.

- ALUMINIUM FRAMED WINDOWS AND DOORS WEATHER STRIPPING IS TO BE PROVIDED TO ALL EXTERNAL WINDOWS AND DOORS.

### STAIRS, HANDRAILS AND BALUSTRADES:

- NCC VOL.2 PARTS 3.9.1 AND 3.9.2

RELATIONSHIP OF RISER TO GOING SHALL BE BETWEEN 1:2 AND 1:1.35 UNLESS OTHERWISE DIRECTED TO GOING SHALL BE BETWEEN 1:2 AND 1:1.35 UNLESS OTHERWISE DIRECTED OR AS PERMITTED IN

- BALUSTRADES SHALL BE PROVIDED TO ALL LANDINGS, RAMPS, DECKS, ROOFS AND OTHER ELEVATED PLATFORMS WHERE THE VERTICAL DISTANCE FROM THAT LEVEL IS MORE THAN 1m ABOVE THE

ADJOINING FLOOR OR FINISHED GROUND LEVEL.
- THE HEIGHT OF BALUSTRADE MUST BE A MINIMUM OF 1m HIGH ABOVE LANDING AND NOT LESS THAN 865mm ABOVE THE NOSINGS OF ANY STAIR TREADS OR FLOOR RAMP AND HAVE NO OPENING GREATER

- THE HEIGHT OF BALUSTRADE TO THE NEW STAIRCASES IS TO BE MEASURED A MINIMUM 865mm ABOVE THE NOSING LINE AND HAVE NO OPENING GREATER NO OPENING GREATER THAN 125mm

### SLIP RESISTANCE:

- MATERIALS TO BE USED FOR SURFACES OF FLOORS. STAIR LANDING, STEPS AND NOSINGS SHALL BE IN ACCORDANCE WITH THE CLASSIFICATIONS FOR SLIP RESISTANCE AS APPLY IN AS4586 AND HB198.

### EAVES GUTTERS, VALLEY GUTTERS AND DOWPIPES

- TO COMPLY WITH AS/NZS 2179 FOR METAL AND AS1273 FOR UPVC COMPONENTS.

SECTION / BASIX

- NEW DOWNPIPES TO BE CONNECTED INTO EXISTING STORMWATER LINE
- COLORBOND GUTTERS AND DOWNPIPES
- MINIMUM SLOPE OF EAVES AND GUTTERS 1:200

GLAZING: - NCC VOL.1 PARTS B 1.4, D 3.12, F1.13 OR NCC VOL.2 PART 3.6

### SMOKE DETECTORS/ALARMS:

- NCC VOL 2 PART 3.7.2, FIRE/SMOKE DETECTORS COMPLYING WITH THE REQUIREMENTS OF THE LOCAL GOVERNMENT ACT AND/OR STATE OR TERRITORY REGULATIONS MUST BE FITTED IN THE LOCATIONS REQUIRED AND APPROVED BY THE AUTHORITY AND SHALL BE INSTALLED IN ACCORDANCE WITH AS3786 - INSTALLATIONS IN BUILDINGS OTHER THAN CLASS 1 AND 10 MUST BE INSTALLED AND MANAGED TO COMPLY WITH NCC SPEC. E2.2a.
- MULTIPLE ALARMS WITHIN HOUSES AND SOLE OCCUPANCY UNITS MUST BE HARD WIRED AND

INTERCONNECTED

### WASTE MANAGEMENT:

- ALL WASTE SHALL BE TAKEN AWAY BY TRUCKS TO A SUITABLE LANDFILL OR RECYCLE DEPOT. ALL WASTE SHALL BE COVERED DURING TRANSPORTATION.
- WASTE GENERATED DURING CONSTRUCTION SHALL BE PLACED IN STEEL BINS AND TAKEN AWAY BY AN APPROVED CONTRACTOR TO A APPROVED LANDFILL SITE.

### SEDIMENT CONTROL:

- A FILTER CLOTH SYSTEM SHALL BE INSTALLED TO STOP ANY SEDIMENT ENTERING COUNCILS

### ACCESSIBLE RAMPS, LANDINGS & ASSOCIATED HANDRAILS, BALUSTRADES & GUARDRAILS:

- TO BE BUILT IN ACCORDANCE WITH AS 1428.1 - 2009 AND AS 4795 - ALL GRADIENTS AND DIMENSIONS TO BE CHECKED ON SITE PRIOR TO PRODUCTION OF SHOP DRAWINGS, MANUFACTURE AND INSTALLATION.

ALL PLANS ARE TO BE READ IN CONJUNCTION AND COMPLY WITH THE BASIX CERTIFICATE AND **BUSHFIRE REPORT** 

### NOTES (E & OE)

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- REV: DATE: DESCRIPTION: A 01/07/2021 ISSUE TO BUSHFIRE CONSULTANT FOR QUOTE 05/07/2021 EXISTING DECK INCLUDED NOT ISSUED D 19/08/2021 ISSUE FOR DA
- PROPOSED ALTERATIONS AND ADDITIONS 15 PENROSE PLACE FRENCHS FOREST NSW 2086 STEVE KHATCHADOURIAN DRAWING TITLE:

DATE: DRAWN BY SCALE: **JUNE 2021** MS 1:100 @ A3 CHECKED BY: JOB No: DRAWING No: 914/21 **DA.08**