

AUSTRAX STRUCTURAL CIVIL ENGINEERS

STORMWATER MANAGEMENT PLAN AND DETAIL

10 RAVEN CIRUIT, WARRIEWOOD NSW


LEGEND:

- STORMWATER LINE
- CHARGED LINE
- SUBSOIL LINE
- STORMWATER RISING MAIN
- OVERFLOW LINE
- AUTHORITY STORMWATER LINE
- AUTHORITY SEWER LINE
- AUTHORITY WATER LINE
- EXISTING STORMWATER LINE
- AUTHORITY ELECTRICITY LINE
- AUTHORITY UNDERGROUND ELECTRICITY LINE
- AUTHORITY COMMS LINE
- FENCE LINE

- GRATED SURFACE INLET PIT
- GRATED SURFACE INLET PIT WITH ENVIROPOD INSERT
- JUNCTION PIT
- KERB INLET PIT
- EXISTING GRATED SURFACE INLET PIT
- EXISTING JUNCTION PIT
- EXISTING KERB INLET PIT
- EXISTING TELSTRA PIT
- EXISTING HYDRANT
- EXISTING STOP VALVE
- EXISTING GAS VALVE
- EXISTING POWER POLE
- EXISTING BOUNDARY TRAP
- EXISTING SEWER MANHOLE

ABBREVIATIONS:

- Ø or DIA DIAMETER
- CL CENTER LINE
- CO CLEAR OUT
- DGS DENSE GRADED SUB-BASE
- DP DOWNPIPE
- e EXISTING
- FFL FINISHED FLOOR LEVEL
- GTD GRATED TRENCH DRAIN
- GSIP GRATED SURFACE INLET PIT
- IL INVERT LEVEL
- K&G KERB & GUTTER
- OPF OVERLAND FLOW PATH
- OSD ON-SITE DETENTION
- R RADIUS
- RCP REINFORCED CONCRETE PIPE
- RL REDUCED LEVEL
- RW RETAINING WALL
- RWT RAINWATER TANK
- SMH SEWER MAN HOLE
- SW STORMWATER
- SV STOP VALVE
- TOK TOP OF KERB
- TOW TOP OF WALL
- TWL TOP WATER LEVEL
- UPVC UNPLASTICISED POLYVINYL CHLORIDE
- UNO UNLESS NOTED OTHERWISE
- FF FIRST FLUSH DEVICE
- TYP TYPICAL
- OPF OVERLAND FLOW PATH
- RWO RAINWATER OUTLET
- CO CLEAR OUT POINT
- FF FIRST FLUSH
- DDO DISH DRAIN OUTLET
- PD PLANTER DRAIN
- FW FLOOR WASTE
- CAPPING
- (1.0) PIT TAG/NUMBER
- RH RAINHEAD
- DOWNPIPE DROP
- DP DOWNPIPE
- NRV NON RETURN VALVE
- WP WALL PENETRATION
- DP DOWNPIPE SPREADER
- RH RAINHEAD
- WL WARNING LIGHT
- SPOT LEVELS
- BENCHMARK

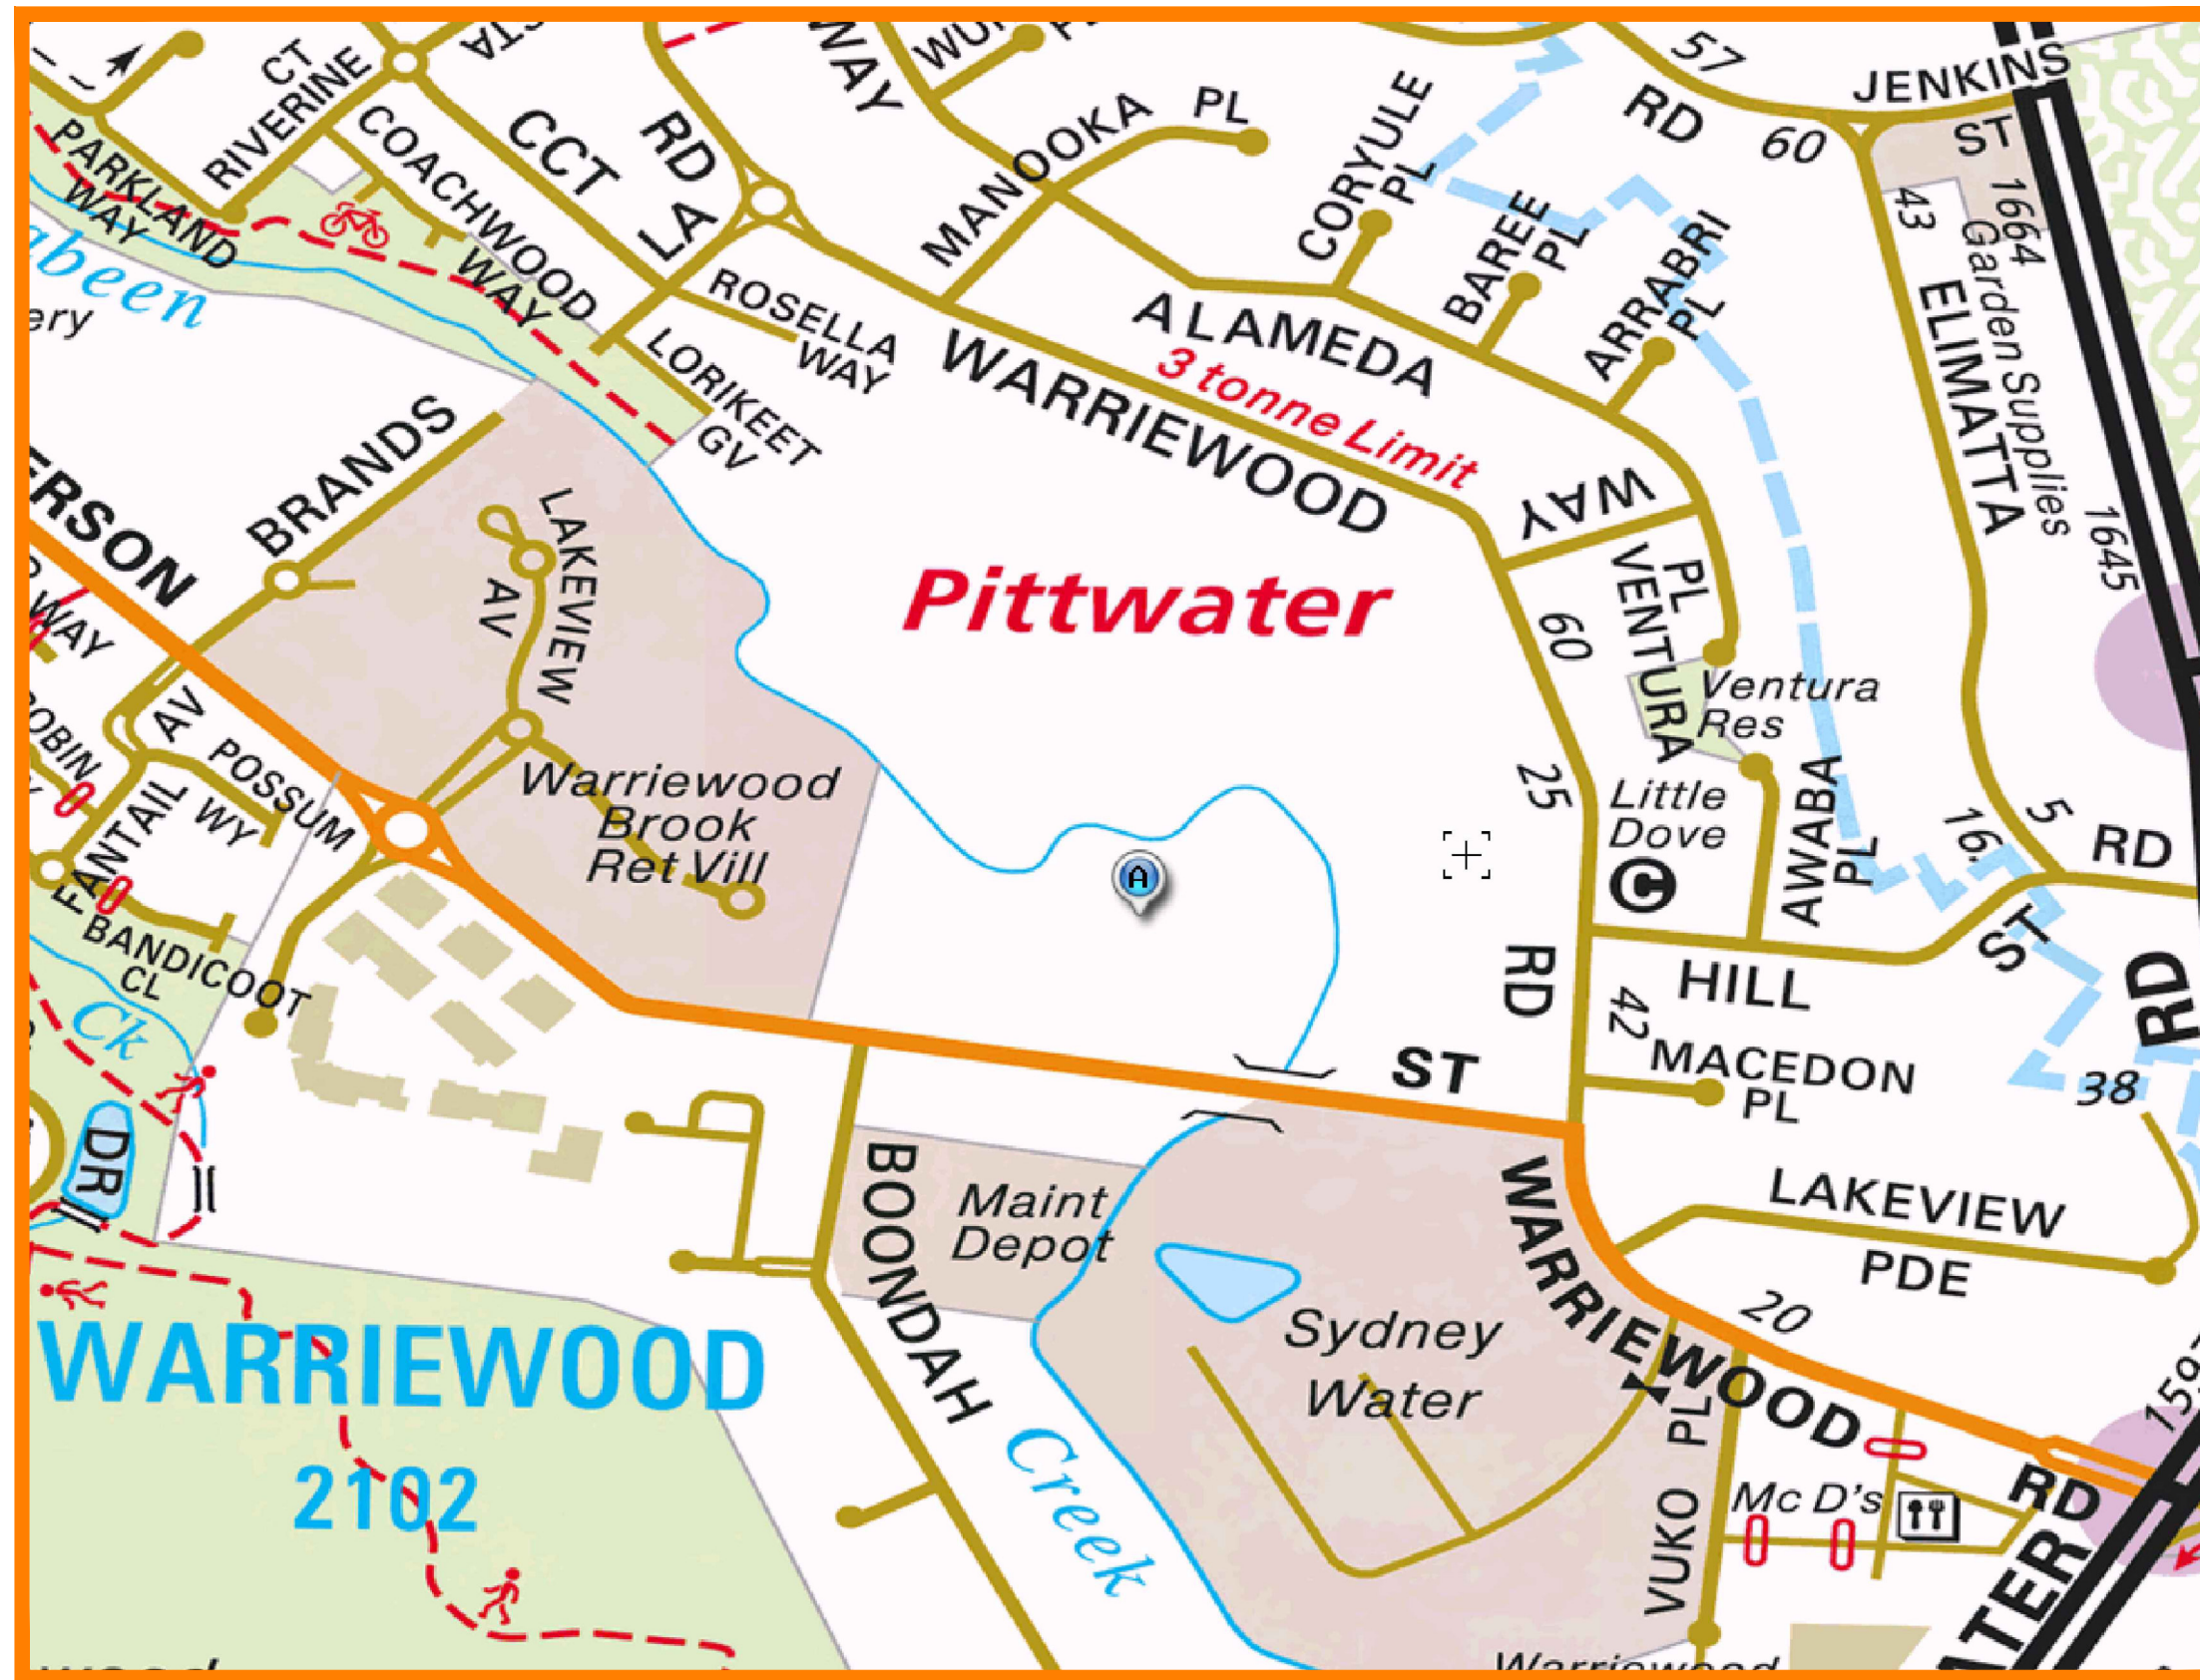

SITE LOCATION

DRAWING REGISTER

NUMBER	NAME	REVISION
SWDP01	COVER SHEET	A
SWDP02	EROSION SEDIMENT CONTROL PLAN	A
SWDP03	STORMWATER MANAGEMENT PLAN	A
SWDP04	STORMWATER DRAINAGE DETAILS	A

DRAINAGE NOTES:

- ALL PIPES TO BE LAID ON 75mm SAND BED WITH THE BARRELS FULLY SUPPORTED
- 100mm AND 150mm DIAMETER PIPES TO BE LAID ON MINIMUM 1% GRADE
- MINIMUM DEPTH OF COVER FOR PIPES NOT SUBJECT TO VEHICULAR LOADING TO BE 300mm
- ALL DRAINAGE PIPES LAID UNDER PAVEMENT SHALL BE REINFORCED CONCRETE WITH RUBBER RING JOINTS
- BACKFILL TRENCHES WITH COMPACTED SAND OR APPROVED AGGREGATE MATERIAL
- ALL PITS TO HAVE 600x600mm INTERNAL DIMENSIONS (U.N.O.)
- SILT ARRESTORS TO HAVE 900x900mm INTERNAL DIMENSIONS
- HEAVY DUTY GRATES AND COVERS ARE TO BE PROVIDED IN TRAFFICABLE AREAS
- PIT GRATE TO BE TYPE WELDLK OR APPROVED EQUIVALENT
- ALL PITS SHALL BE PROVIDED WITH A LOCKING CLIP
- ALL PITS SHALL BE MAINTAINED REGULARLY
- TOP OF BENCHING SHALL BE TO THE HALF OF THE OUTLET PIPE DIAMETER
- MAXIMUM FRONT ENTRY PIPE: - STRAIGHT ENTRY - Ø750 SKEW ENTRY 45° - Ø525
- Ø100 SUBSOIL DRAINAGE PIPE 3000mm LONG WRAPPED IN FABRIC SOCK TO BE PROVIDED ADJACENT TO INLET PIPES
- COMPRESSIVE STRENGTH f_c FOR CAST IN SITU CONCRETE TO BE A MINIMUM OF 20MPa AT 28 DAYS
- PROVIDE CLEANING EYES TO ALL DOWNPIPES NOT DIRECTLY CONNECTED TO PITS
- ISOLATED JOINTS TO BE PROVIDED TO ISOLATE CONCRETE PAVEMENTS FROM PITS
- ALL TRENCH GRATES PROVIDED SHALL HAVE A MINIMUM CLEAR WIDTH OF 200mm
- STORMWATER DRAINAGE CONNECTIONS TO THE MAIN SYSTEM SHALL BE TO THE REQUIREMENTS AND THE SATISFACTION OF LOCAL COUNCIL

STORMWATER PIPE BEDDING/PAVING NOTES:

- WHERE TRENCH BASE IS ROCK A MINIMUM OF 75mm BEDDING TO BE PROVIDED UNDER PIPE COLLARS.
- STORMWATER PIPE BEDDING DETAIL TO BE IN ACCORDANCE WITH LOCAL COUNCIL REQUIREMENTS. BEDDING DETAILS TO BE CONFIRMED UPON EXCAVATION & PRIOR TO INSTALLATION OF PIPEWORK.

FOOTPATH REINSTATEMENT NOTES:


- REMOVE ALL SAND FILL WITHIN THE FOOTPATH AREA TO THE EXISTING SUBGRADE.
- SUPPORT ALL AUTHORITY SERVICES TO STRUCTURAL ENGINEERS DETAILS DURING EXCAVATION.
- REINSTATE FOOTPATH SUBGRADE.
- THE CONTRACTOR SHALL PROVIDE CERTIFICATION OF COMPACTION FROM A NATA REGISTERED TESTING AUTHORITY. MINIMUM THREE TESTS PER LAYER AS FOLLOWS:

SELECT FILL	95% MODIFIED
SELECT FILL (LESS THAN 300mm BELOW BASE COURSE)	98% MODIFIED
BASE COURSE	100% MODIFIED

DIAL BEFORE YOU DIG SHOULD BE CONTACTED PRIOR TO ANY EXCAVATION ON SITE

TM: TRADE MARK OF THE ASSOCIATION OF DIAL BEFORE YOU DIG SERVICES LTD. USED UNDER LICENSE.

SERVICES SHOWN ON PLAN ARE INDICATIVE, EXACT DEPTH AND LOCATION TO BE CONFIRMED ONSITE. CONTRACTOR TO CARRY OUT DIAL BEFORE YOU DIG APPLICATION AND ENGAGE A REGISTERED SURVEYOR TO PEG OUT ALL EXISTING SERVICES PRIOR TO ANY WORK COMMENCING ONSITE.

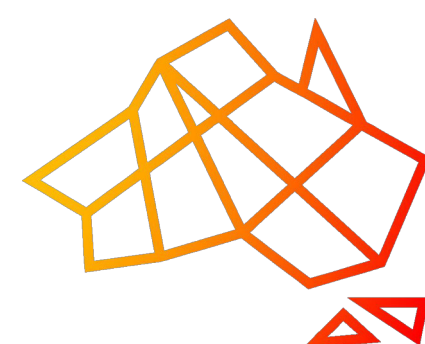

AUSTRAX STRUCTURAL CIVIL ENGINEERS

PH: 0423095373

2/4 COLONY CLOSE, TUGGERAH NSW
671 HUNTER STREET, NEWCASTLE NSW
38 STATION STREET, BONNELLS BAY NSW

Structural • Civil • Hydraulic • Flooding • Residential • Commercial
Industrial • Land Development

Sydney
Newcastle
Central Coast
Hunter Valley
New South Wales
Victoria
Queensland
A.B.N. 91 620 485 716
www.globalceng.com.au
E: info@globalceng.com.au

CLIENT


D PROJECTS

PROJECT

10 RAVEN CIRCUIT
WARRIEWOOD NSW

COUNCIL

NORTHERN
BEACHES
COUNCIL

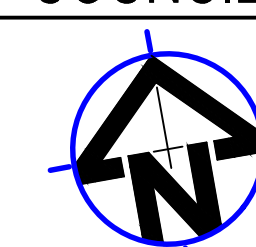

TITLE

COVER SHEET
DRAWING
FOR APPROVAL

DATE

11.01.2025

SCALE

1:200-A3

DESIGNED:

G.K

PROJECT NO.

GCE.24478

ENGINEER:

G.K.

DRAWING NO.

SWDP01

CHECKED:

G.K.



REVISION NO.

A


©This drawing is copyright to Global Consulting Engineers, no part of this drawing shall be used for any other purpose without the prior written consent of Global Consulting Engineers.

SEDIMENTATION AND EROSION CONTROL PLAN


- SEDIMENTATION AND EROSION CONTROL NOTES
1. SELECTIVE CLEARING OF VEGETATION TO BE RESTRICTED TO NOMINATED AREAS WITH CLEARED VEGETATION WIND ROWED ON THE CONTOUR.
 2. ALL EROSION AND SEDIMENT CONTROL MEASURES TO BE INSTALLED PRIOR TO SITE DISTURBANCE.
 3. TOPSOIL FROM ALL AREAS THAT WILL BE DISTURBED TO BE STRIPPED AND STOCKPILED AT THE NOMINATED SITE.
 4. NO MORE THAN 150m OF TRENCH TO BE OPEN AT ANY ONE TIME.
 5. CUT AND FILL BATTER GRADIENTS OF 1:2 (MAXIMUM).
 6. A STRIP OF TURF 450mm WIDE IS TO BE PLACED IMMEDIATELY BEHIND THE KERB ON ALL NEW ROAD TO ACT AS A FILTER TRAP. REFER TO DETAIL.
 7. ALL SEDIMENT CONTROL STRUCTURES TO BE INSPECTED BY SITE SUPERVISOR AFTER EACH RAINFALL EVENT FOR STRUCTURAL DAMAGE AND ALL TRAPPED SEDIMENT TO BE REMOVED TO A NOMINATED STOCKPILE SITE.
 8. THE PROJECT MANAGER TO INFORM ALL CONTRACTORS AND SUB-CONTRACTORS OF THEIR OBLIGATIONS UNDER THE EROSION AND SEDIMENT CONTROL PLAN.
 9. NO DISTURBED AREA IS TO REMAIN DENUDED LONGER THAN 14 DAYS.
 10. ALL FILLS ARE TO BE LEFT WITH A LIP AT THE TOP OF THE SLOPE AT THE END OF EACH DAY'S OPERATION.
 11. THE CONTRACTOR MUST ENSURE THE SUITABILITY AND INTEGRITY OF ALL WORKS AT THE END OF EACH DAY'S WORK.
 12. ORANGE BARRIER TAPE TO BE AFFIXED TO TOP OF SEDIMENT CONTROL BARRIER TO IDENTIFY WORK AREA.
 13. ALL SEDIMENTATION & EROSION CONTROL MEASURES ARE TO STRICTLY COMPLY WITH THE GUIDELINES DETAILED IN THE DEPARTMENT OF HOUSING PUBLICATION, "MANAGING URBAN STORMWATER - SOILS AND CONSTRUCTION", 4TH EDITION.
 14. WATER TRUCKS TO BE USED AS REQUIRED TO PREVENT WIND EROSION.
 15. SUBGRADE MATERIAL TO BE CONSTRUCTED IMMEDIATELY FOLLOWING FILL.

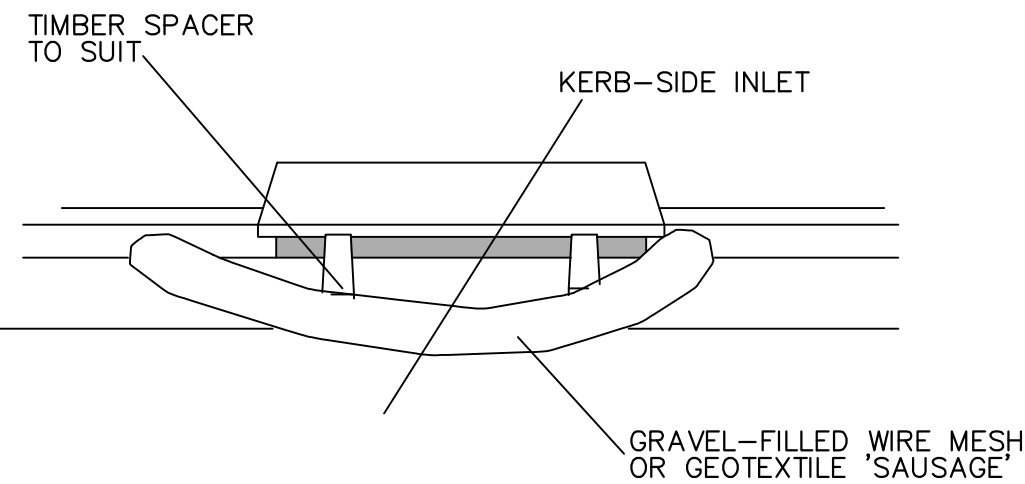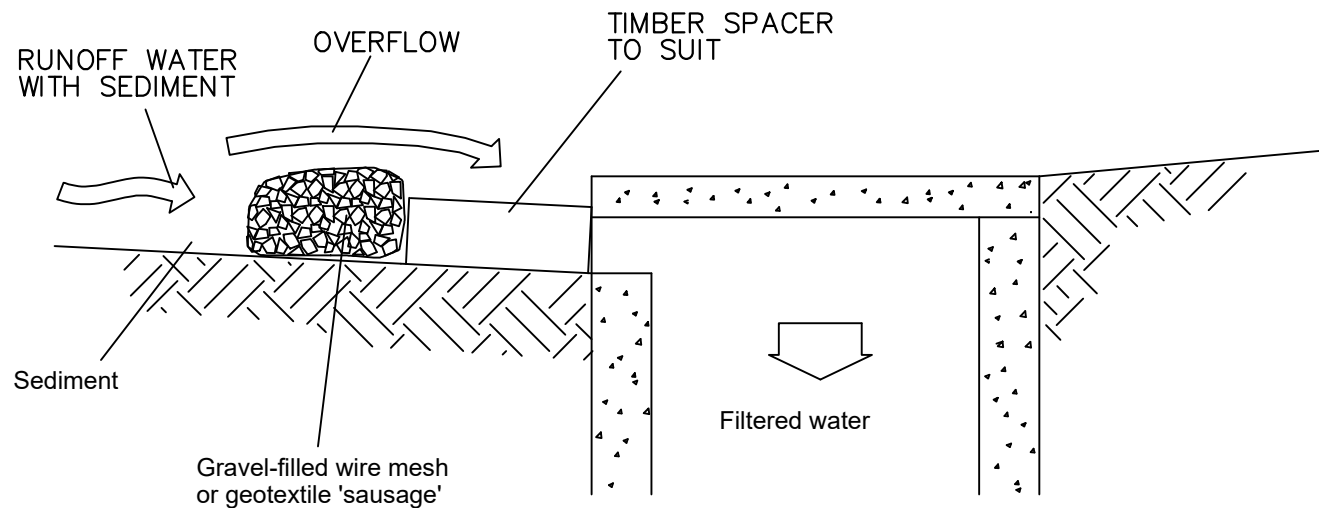

DETAIL
SAND BAG DETAILS
NOT TO SCALE

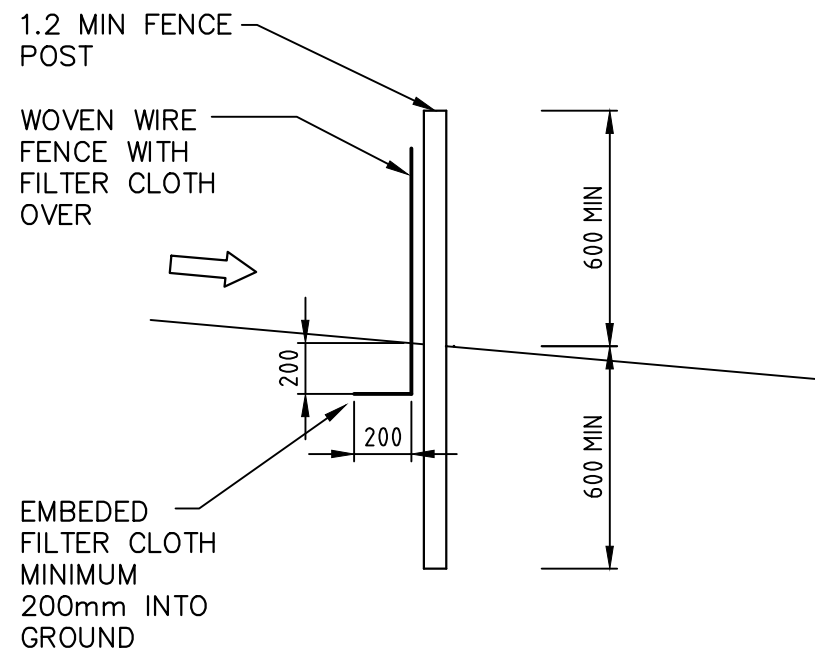

TYPICAL SECTION


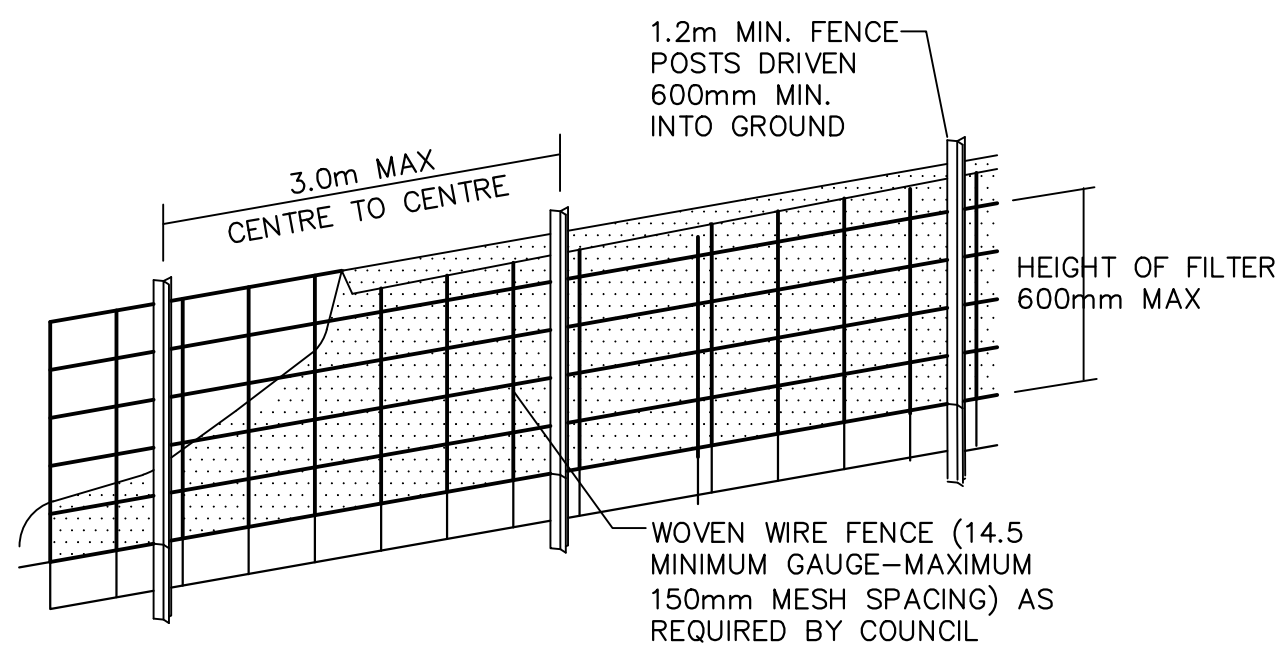


DIAGRAMMATIC VIEW

DETAIL
SEDIMENT FENCE
NOT TO SCALE



CONSTRUCT TEMPORARY RUBBLE ENTRY/EXIT TO PREVENT TRANSFER OF SEDIMENT AND DEBRIS DURING VEHICULAR TRAFFIC (REFER DETAIL). LOCATION TO BE CONFIRMED ON SITE.

CONSTRUCT TEMPORARY SILT FENCE AROUND PITS AS SHOWN (TYP). REFER DETAIL.

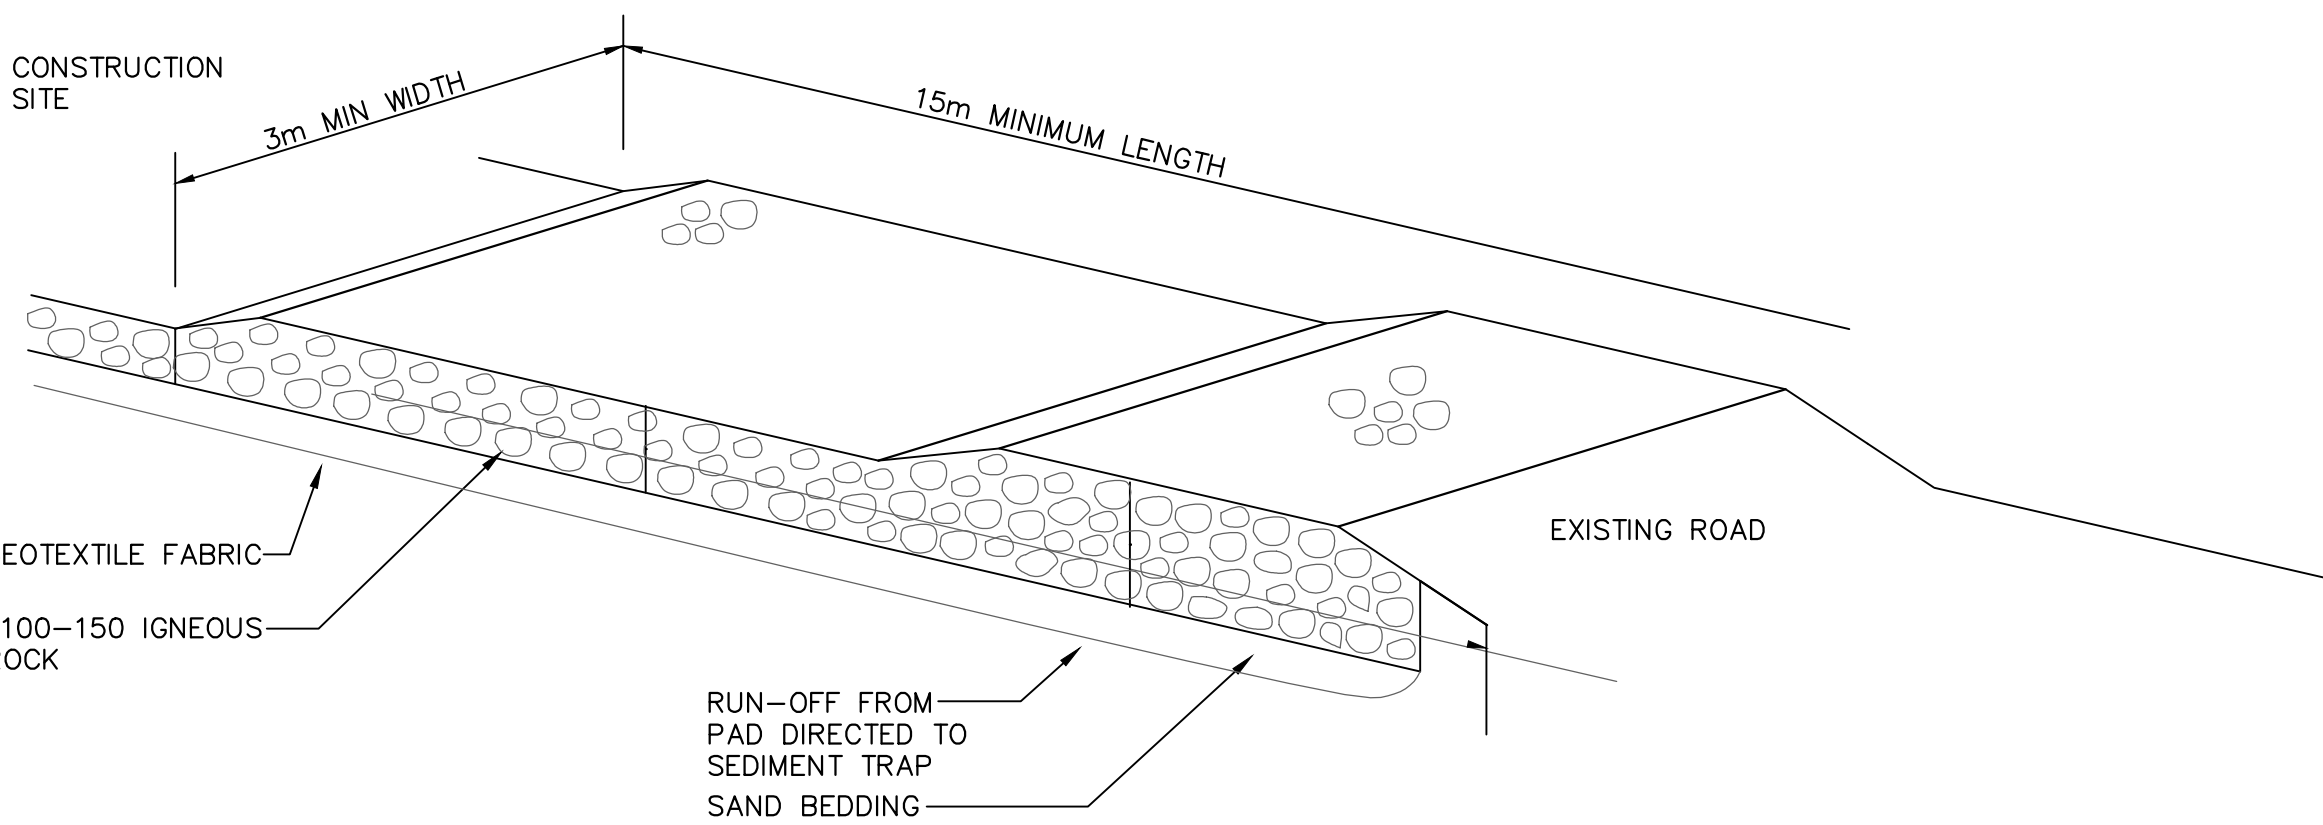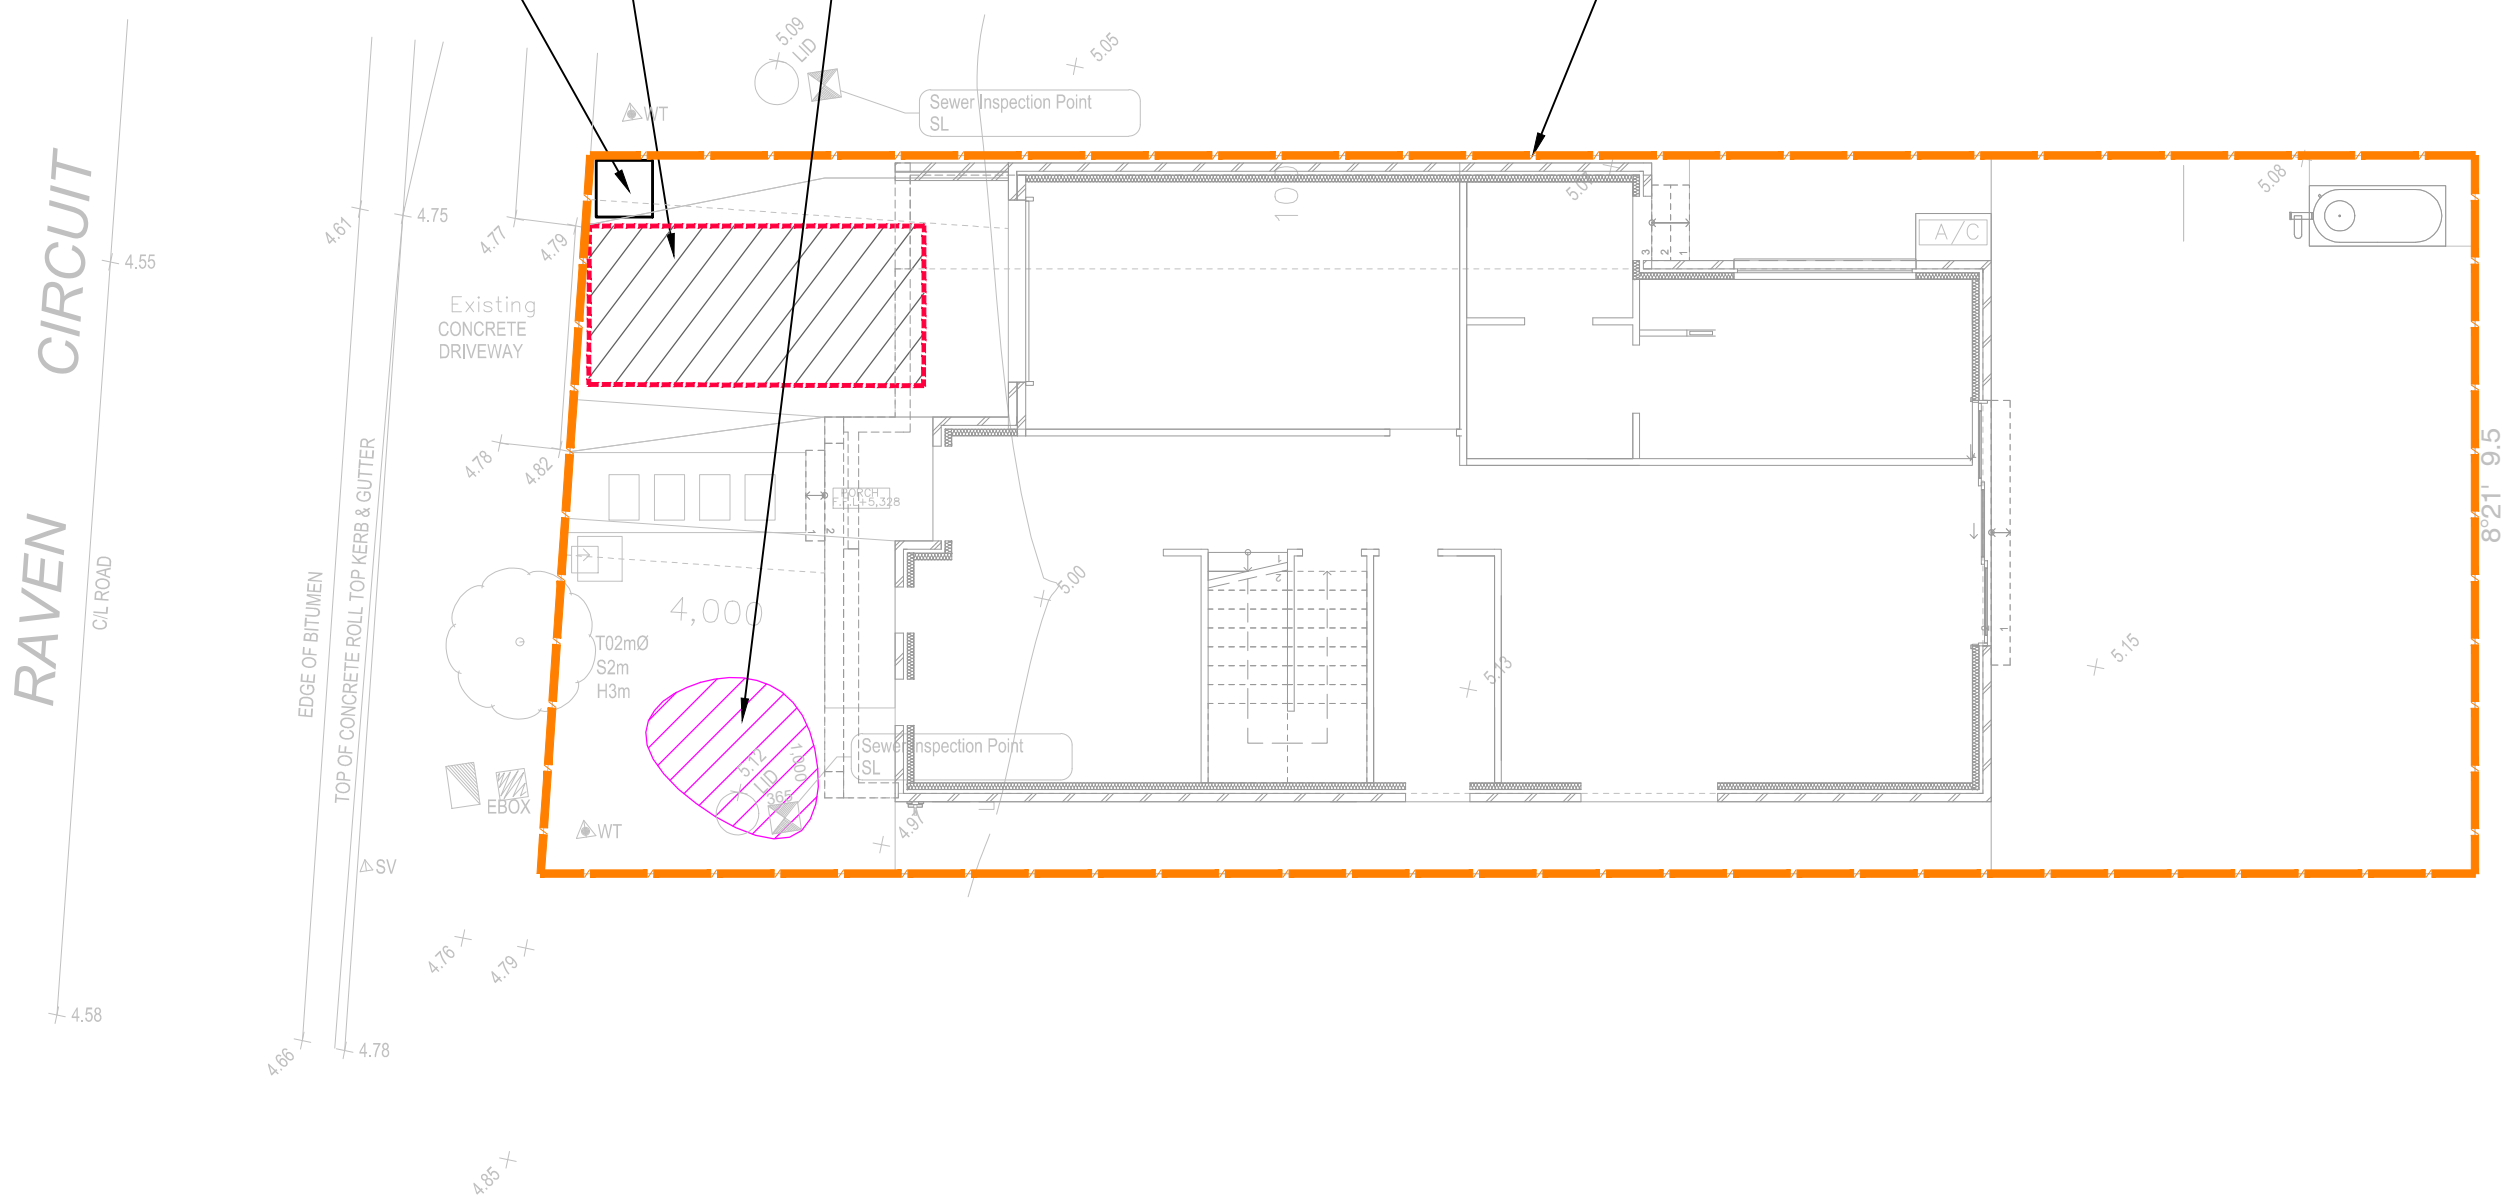

RUBBLE ALTERNATIVE

DETAIL
TEMPORARY
CONSTRUCTION EXIT
NOT TO SCALE

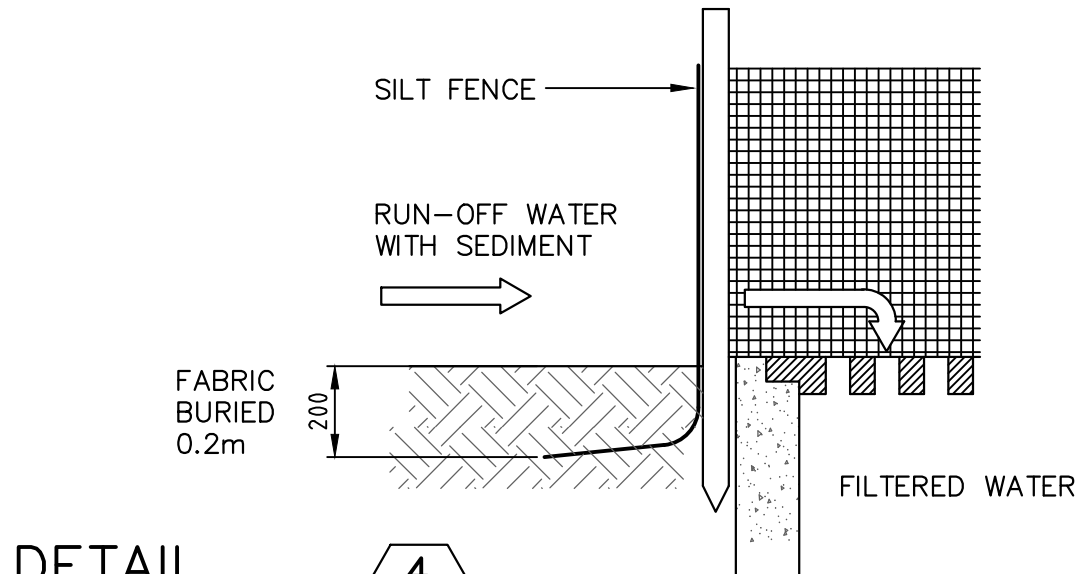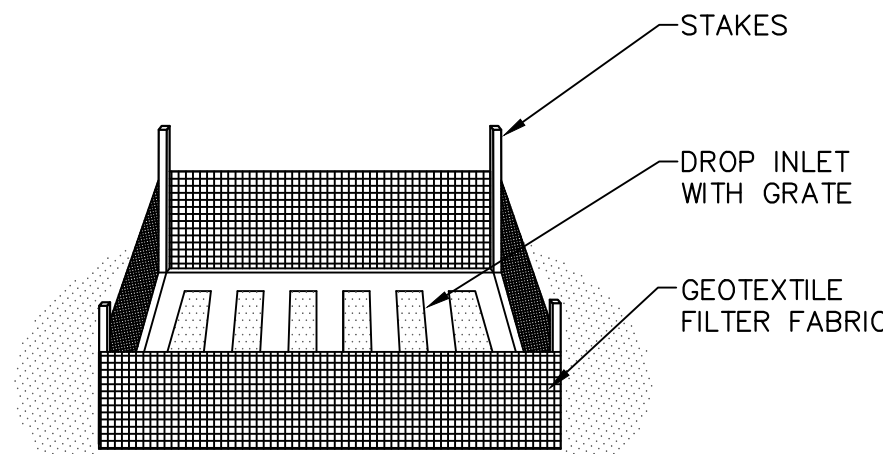

DETAIL
SUMP SEDIMENT TRAP
NOT TO SCALE

LEGEND

- DENOTES SEDIMENT FENCE, REFER TO DETAIL
- DENOTES MESH AND GRAVEL INLET FILTER, REFER TO DETAIL
- DENOTES GEOTEXTILE INLET FILTER, REFER TO DETAIL
- DENOTES STABILISED SITE ACCESS, REFER TO DETAIL

NOTE
THIS DRAWING HAS BEEN DEVELOPED IN ACCORDANCE WITH THE REQUIREMENTS OF THE CENTRAL COAST COUNCIL, PLANNING FOR EROSION AND SEDIMENT CONTROL ON RESIDENTIAL ALLOTMENTS. AND THE REQUIREMENTS OUTLINED IN THE LANDCOM PUBLICATION "MANAGING URBAN STORMWATER SOILS AND CONSTRUCTION-2004".


A	FOR CONSTRUCTION	11.01.2025	G.K.
REV	DESCRIPTION	DATE	APP



AUSTRAX STRUCTURAL CIVIL ENGINEERS
PH: 0423095373
2/4 COLONY CLOSE, TUGGERAH NSW
671 HUNTER STREET, NEWCASTLE NSW
38 STATION STREET, BONNELLS BAY NSW

Structural • Civil • Hydraulic • Flooding • Residential • Commercial
Industrial • Land Development

Sydney
Newcastle
Central Coast
Hunter Valley
New South Wales
Victoria
Queensland
A.B.N. 91 620 485 716
www.globalceng.com.au
E: info@globalceng.com.au


©This drawing is copyright to Global Consulting Engineers, no part of this drawing shall be used for any other purpose without the prior written consent of Global Consulting Engineers.

CLIENT	D PROJECTS	COUNCIL	NORTHERN BEACHES COUNCIL	TITLE EROSION SEDIMENT CONTROL PLAN DRAWING FOR APPROVAL			
PROJECT	10 RAVEN CIRCUIT WARRIEWOOD NSW		DATE 11.01.2025	DESIGNED: G.K	ENGINEER: G.K.	CHECKED: G.K.	
			SCALE 1:200-A3	PROJECT NO. GCE.24478	DRAWING NO. SWDP02	REVISION NO. A	

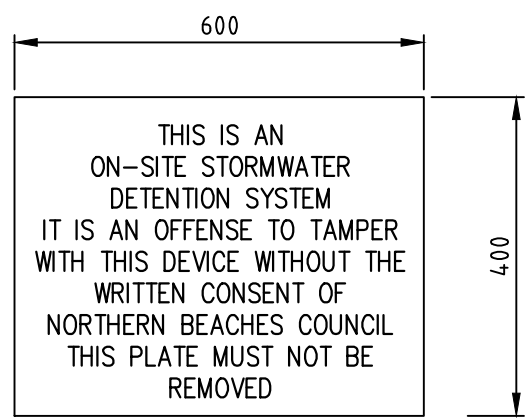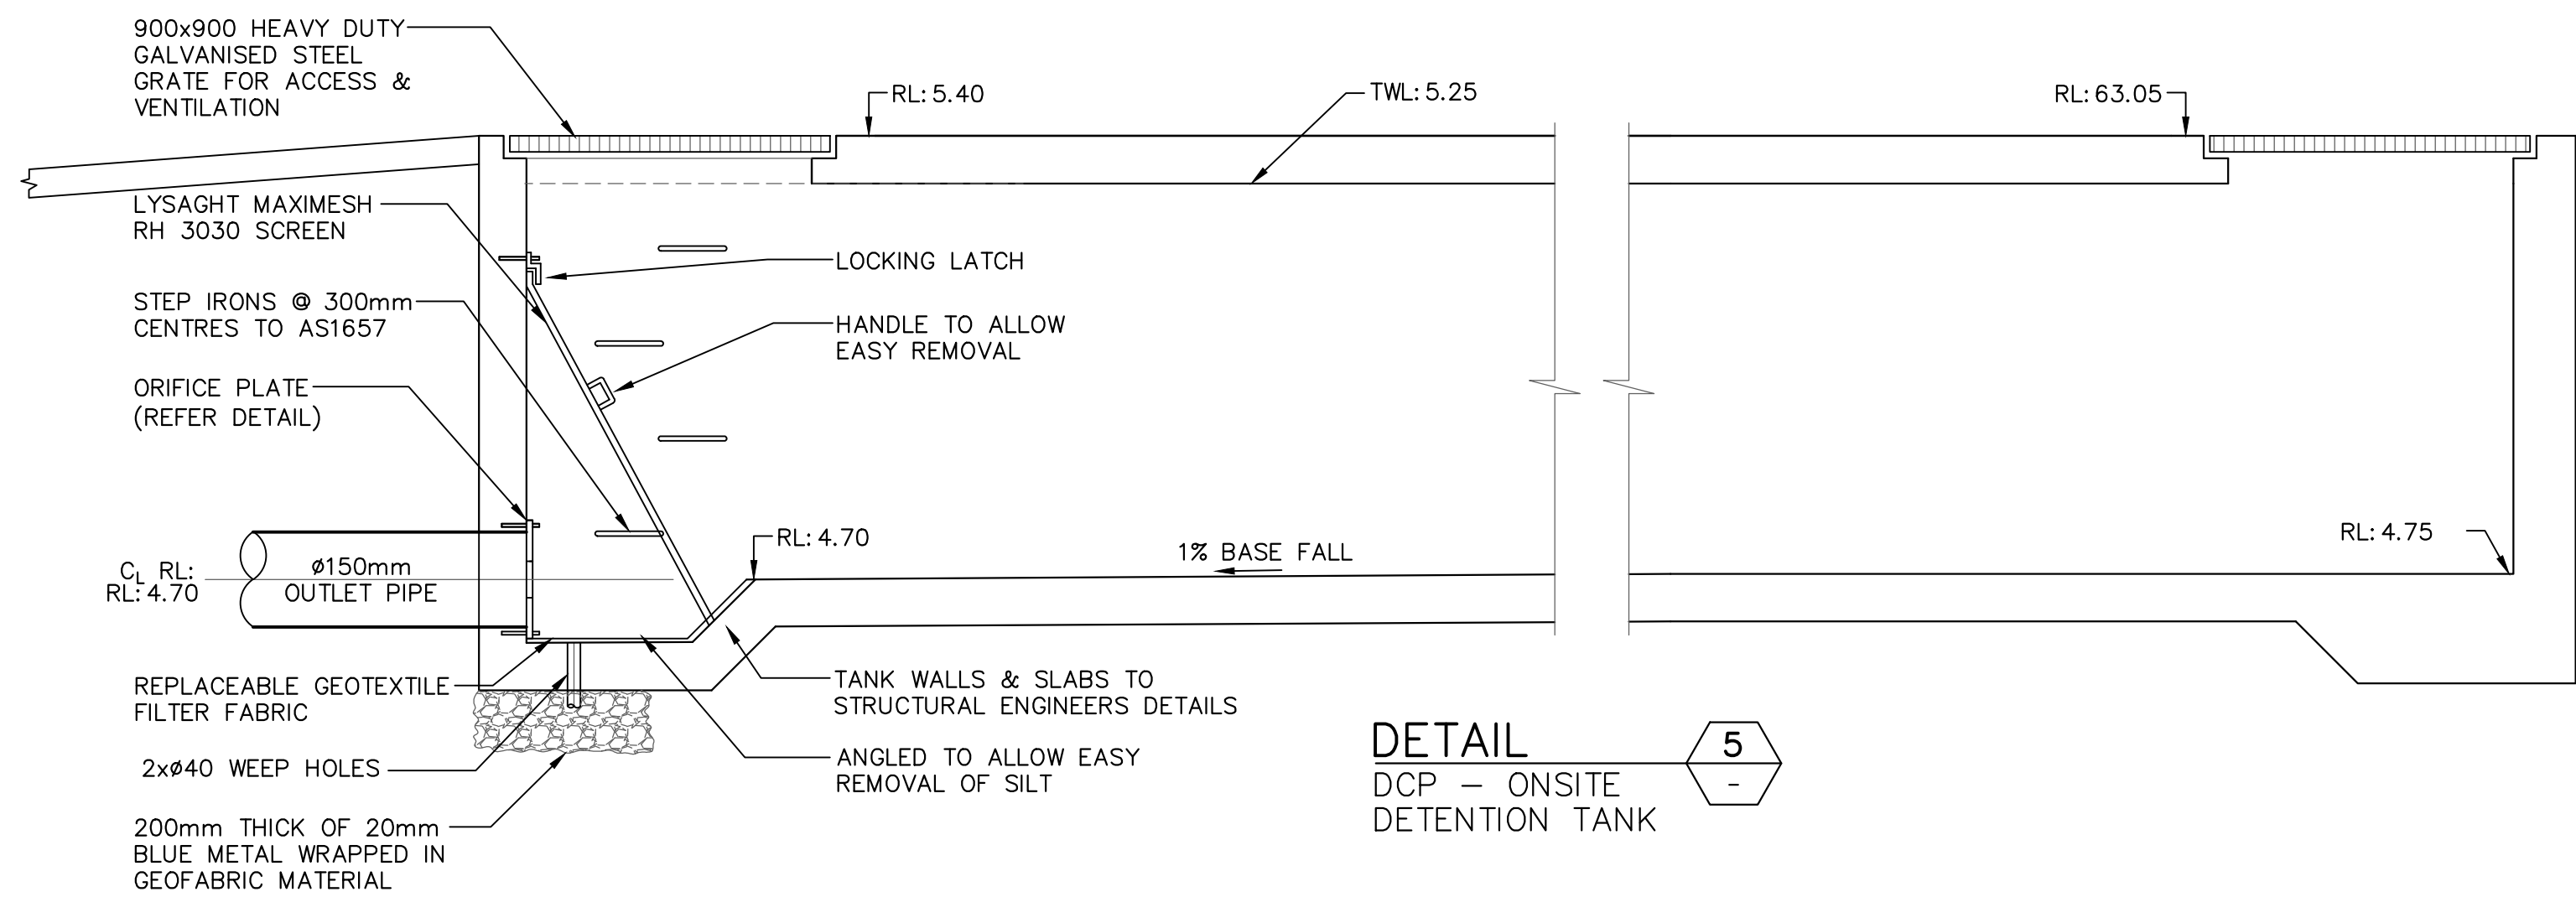


DETAIL 10

OSD SIGN

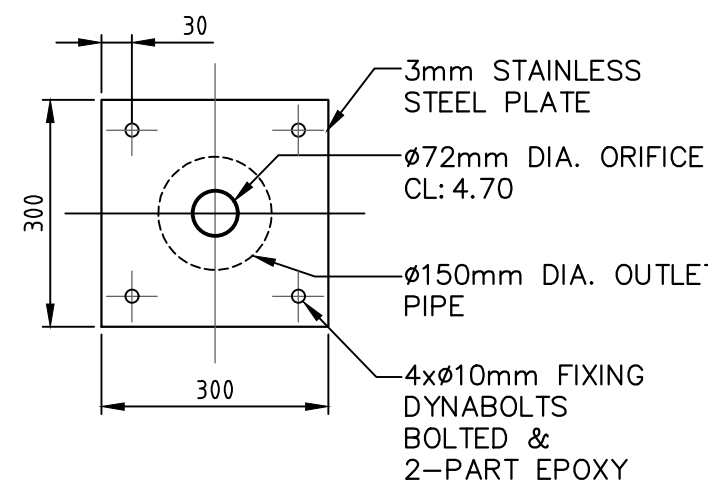


DETAIL 8

ORIFICE PLATE

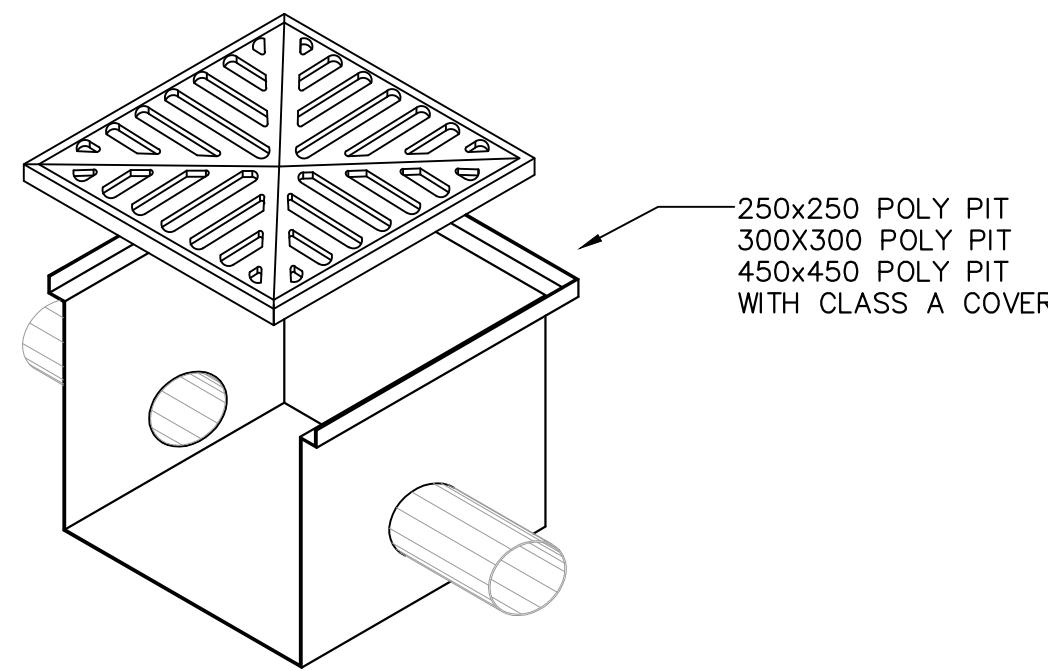

DETAIL 7

POLY PIT CLASS A COVER (FOR LANDSCAPED AND BACKYARD AREAS ONLY)

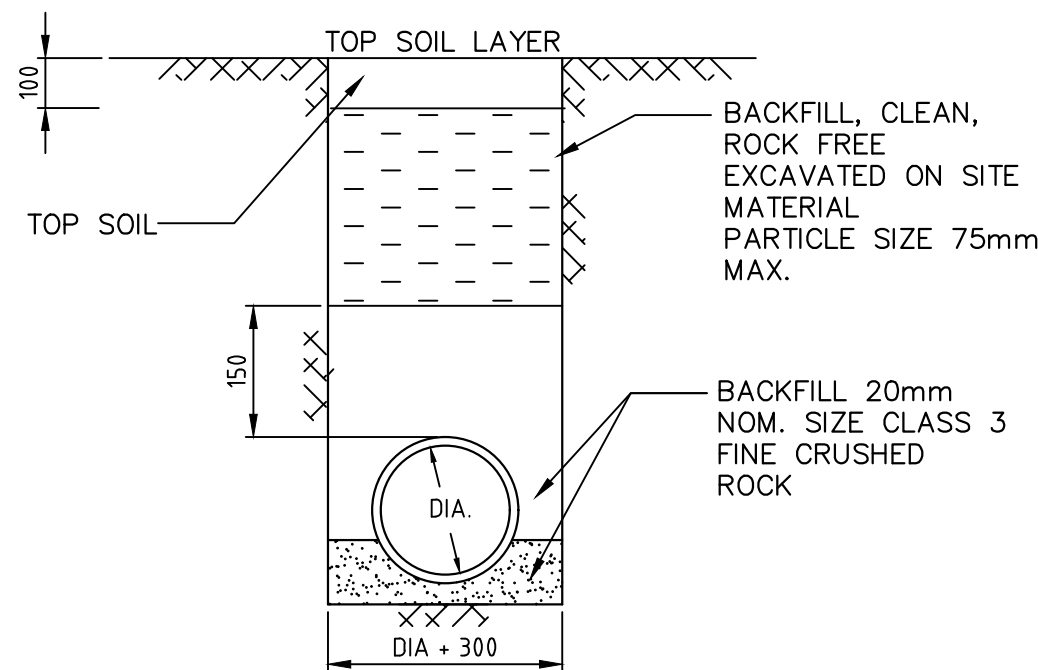


DETAIL 9

TRENCH FOR PIPING NOT UNDER PAVEMENT




DETAIL 11

RAINWATER SIGN

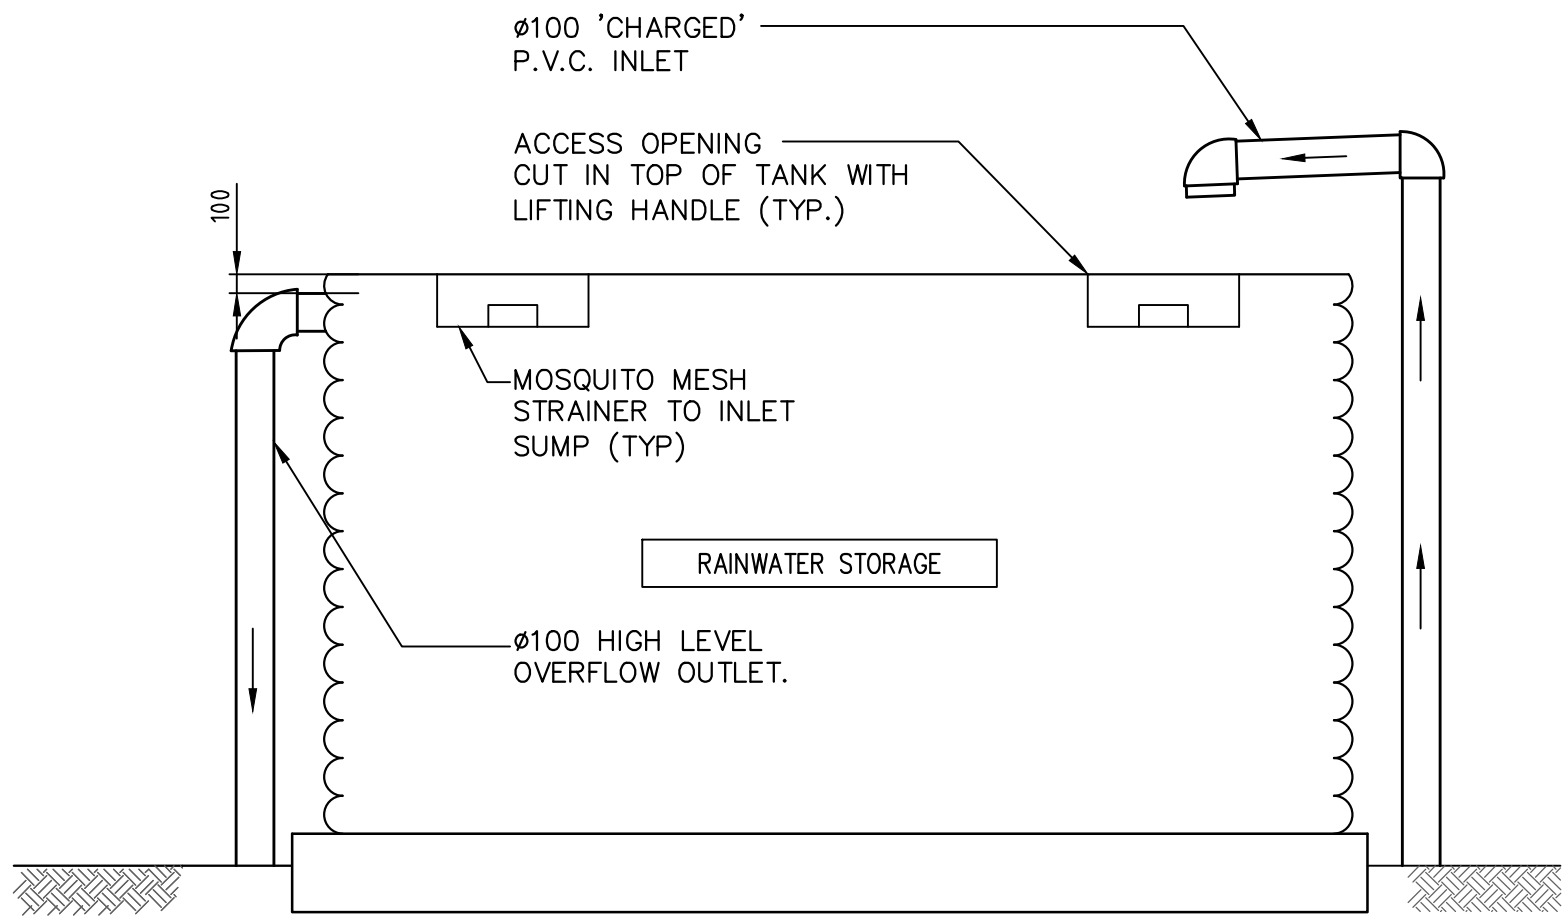


DETAIL 12

RAINWATER STORAGE TANK

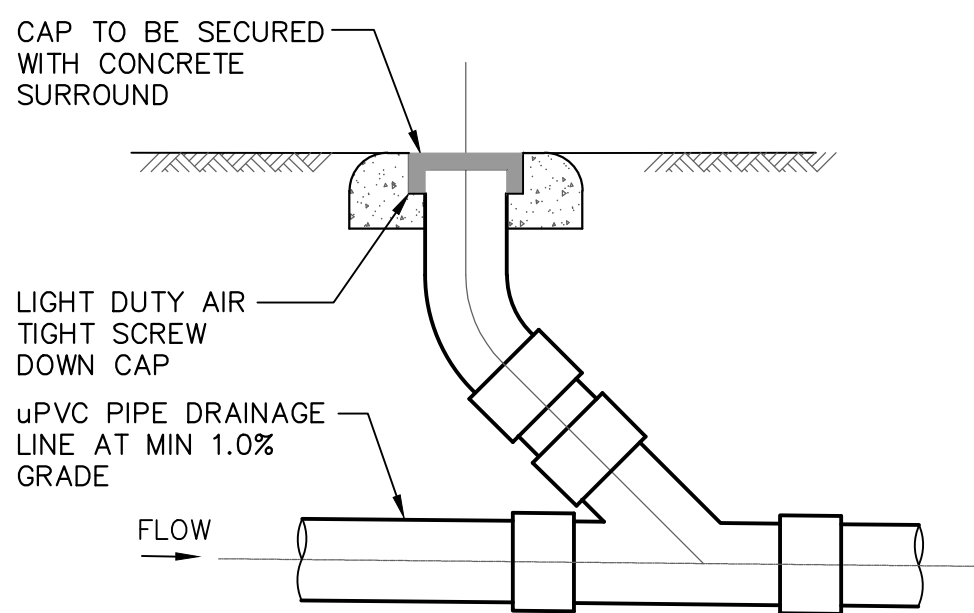

DETAIL 13

CLEANING EYE

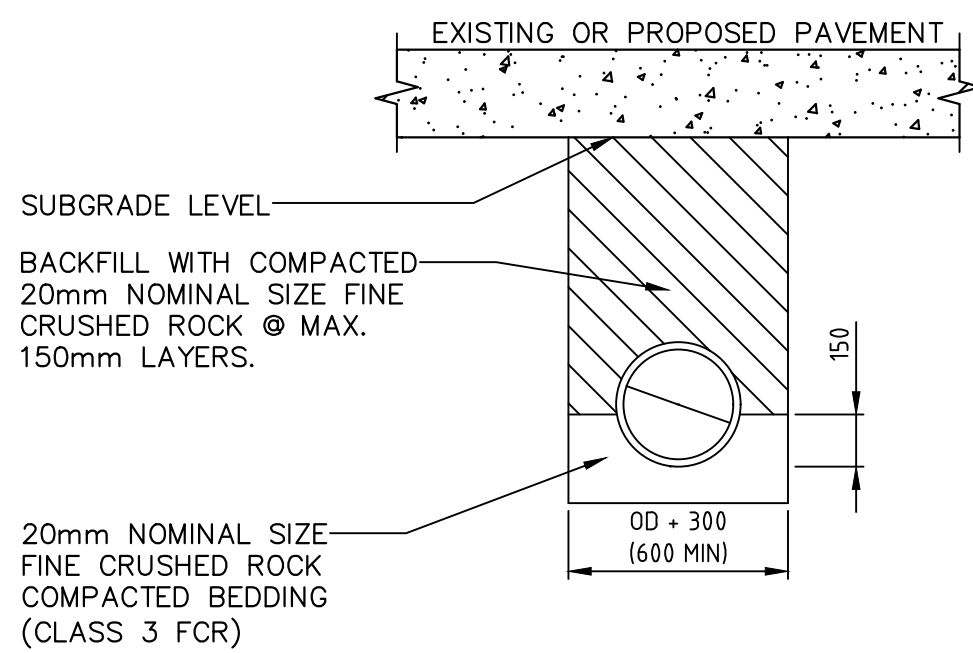

DETAIL 14

TRENCH FOR PIPING UNDER PAVEMENT

A	FOR CONSTRUCTION	11.01.2025	G.K.
REV	DESCRIPTION	DATE	APP




**AUSTRAX STRUCTURAL
CIVIL ENGINEERS**

PH: 0423095373
2/4 COLONY CLOSE, TUGGERAH NSW
671 HUNTER STREET, NEWCASTLE NSW
38 STATION STREET, BONNELLS BAY NSW

Structural • Civil • Hydraulic • Flooding • Residential • Commercial
Industrial • Land Development

Sydney
Newcastle
Central Coast
Hunter Valley
New South Wales
Victoria
Queensland
A.B.N. 91 620 485 716
www.globalceng.com.au
E: info@globalceng.com.au

©This drawing is copyright to Global Consulting Engineers, no part of this drawing shall be used for any other purpose without the prior written consent of Global Consulting Engineers.

CLIENT D PROJECTS	COUNCIL NORTHERN BEACHES COUNCIL	TITLE DRAINAGE DETAILS DRAWING FOR APPROVAL			
		DATE 11.01.2025	DESIGNED: G.K	ENGINEER: G.K.	CHECKED: G.K.
PROJECT 10 RAVEN CIRCUIT WARRIEWOOD NSW		SCALE 1:200-A3	PROJECT NO. GCE.24478	DRAWING NO. SWDP04	REVISION NO. A