
BKEA Investment

LOT 27, NO. 2 MARETIMO STREET, BALGOWLAH, NSW 2093

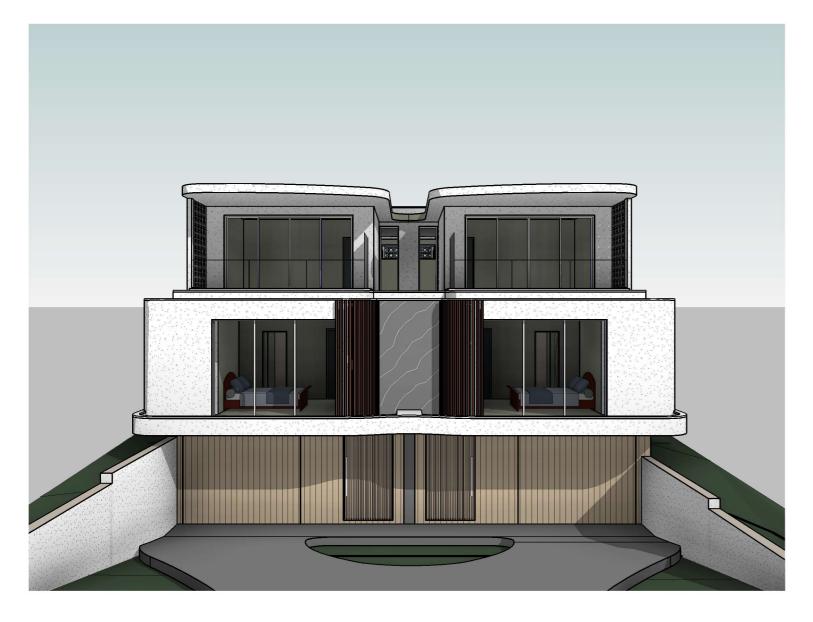



SHEET LIST				
SHEET	SHEET NAME	ISSUE	DATE	
1	COVER SHEET	C1	12.12.24	
2	BUILDING SPECIFICATION	C1	12.12.24	
3	SITE PLAN	C1	12.12.24	
3a	SITE PLAN 2	C1	12.12.24	
3b	ROOF PLAN	C1	12.12.24	
4	BASEMENT	C1	12.12.24	
5	GROUND FLOOR	C1	12.12.24	
6	FIRST FLOOR	C1	12.12.24	
7	ELEVATIONS 1-2	C1	12.12.24	
8	ELEVATIONS 3-4	C1	12.12.24	
9	SECTIONS	C1	12.12.24	
10	SCHEDULE OF COLOURS & FINISHES	C1	12.12.24	
11	CONCEPT LANDSCAPE PLAN	C1	12.12.24	
12	PLANTING SCHEDULE	C1	12.12.24	
13	SEDIMENT CONTROL PLAN	C1	12.12.24	
14	SHADOW DIAGRAMS	C1	12.12.24	
15	SLAB SETOUT PLAN	C1	12.12.24	

	REVISION SCHEDULE			
ISSUE	ISSUE DATE DETAILS		BY	
A1	29.10.24	CONSTRUCTION DRAWINGS	MQ - AKD	
B1	08.11.24	COMPLIANCE AMENDMENT	MQ - JCF	
B2	15.11.24	GFA AMENDMENT, SURVEY PLAN & POOL. ADJUSTED FF BALCONY TO 2M & BALCONY CANOPY	MQ - JCF	
В3	21.11.24	AMENDMENT FOR 6.5M BUILDING LINE, REMOVED GF FRONT CURVE WALLS, REDUCED GF LIVING TO 300M	MQ - JCF	
B4	04.12.24	REVERTED BACK TO B1; AMENDED KITCHEN & LIVING	MQ - JJS	
C1	12.12.24	COMPLIANCE AMENDMENT	MQ - JCF	

- 3D IMAGE FOR ILLUSTRATION ONLY
- RAIN WATER TANK AS PER BASIX CERTIFICATE
- VEHICLE CROSSING TO COMPLY WITH AS 2890.1-2004

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- WHEN TESTED IN ACCORDANCE WITH AS4586-2013. OPENABLE WINDOWS TO BE IN ACCORANCE WITH CLAUSE 3.9.2.5 OF THE BCA 2013 VOL. 2
- FIRST FLOOR WINDOWS TO BE RESTRICTED TO OPEN A MAX. OF 125mm IF SILL HEIGHT IS LOWER THAN 1700mm ABOVE A FLOOR LEVEL.

CLIENT DESIGN APPROVAL: BKEA Investment CLIENT NAME:
CLIENT SIGNATURE:

CERTIFICATE NUMBER: TBD

DRAWING NAME: DRAWN: MQ - JCF DATE: 12.12.24 **COVER SHEET** SCALE: LGA: NORTHERN BEACHES LODGEMENT: CDC - LRHDC ADDRESS: ISSUE: LOT 27, NO. 2 MARETIMO STREET, CONSTRUCTION BALGOWLAH, NSW 2093 DRAWINGS SHEET No:

BUILDING SPECIFICATION

This reference specification is designed to ensure that the building works carried out are in accordance with the Environmental Planning Assessment Act 1979, and Regulations, and the Building Code of Australia, Reference to "AS" means the Australian Standard. Reference of the "BCA" means the Building Code of Australia applicable at the time that the application for the construction certificate was issued.

Demolition

All demolition shall be carried out in accordance with the provisions of the Environmental Planning Assessment Act 1979, and Regulations, any applicable condition of a relevant development consent or provision of an LEP and AS 2601.

Site Preparation

- Preparation for site is to ensure that safety is applied at all stages of construction
- All temporary fencing to be provided in accordance with architectural detail
- · Amenities, Portable toilets, Site office and lunch to be provided in accordance with
- All services to be terminated prior to commencement of work
- Temporary power and water to be established in a safe location
- Temporary Driveway to be installed in accordance with architectural detail and council requirements / guidelines.

Termite control Treatment

Termite treatment for new works shall be carried out in accordance with Part 3.1.3 of the BCA Housing Provisions (Volume 2) and AS 3660.1

· Surveyor is to peg out new proposed dwellings prior to any excavation work All excavation is to be in accordance with Engineering details and AS 3798

Footings and Slabs

Where provided, reinforcement, concrete, piers footings, slabs, under floor fill and vapour barriers shall conform and be placed in accordance

with AS 3600, AS 2870, structural engineer's details and Part 3.2 of the BCA Housing

All masonry construction, including damp proof courses and flashings shall be in accordance with Part 3.3 of the BCA Housing Provisions (Vol

2) and AS 3700. Where the lowest storey floor is timber framed® sub floor ventilation shall comply with Part 3.4 of the BOA Housing Provisions (Vol 2). All lintels are to comply with Clause 3.3.3.4 of the BCA Housing Provisions (Vol

Brickwork

- Dwellings to consist of 250 thick brick veneer walls using standard 230 x 110 x 76
- Brick work to be in accordance with AS 3700. All relevant ties to be used as specified. \bullet Mortar mix for bricklaying to be of 5:2:1 50/50 yellow bricks sand and grey cement. Lintels to be used for openings and concrete lintels where needed

Structural Timber & Timber Framing

- To be in accordance with Engineers details and AS 1684 timber framing code
- Stud walls members are to be at 600 centers
- All floor joists are to be at 450 cts

- Roof frame to AS1884 or Truss to Manufactures standards or AS 1684
- Rafter members are to be at 600 centers All ceiling joists are to be at 450 cts
- Eaves: Eaves line 400 wide lined with fibro

- Provide cavity flashing and weep holes above lower storey openings
- Waterproofing of wet areas to comply with AS3740:2010 Waterproofing of Domestic and/or with NCC Part 10.2 Wet Area Waterproofing.

Provide stairs, handrails and balustrades as required in accordance with Parts 3.9.1 and 3.9.2 of the BOA Housing Provisions (Vol 2). Specific attention should be given to the specifications for the wire balustrades.

- To be concrete poured in accordance with engineers details
- Where Kerb damaged is to be replaced

Windows & Sliding Doors

Windows and sliding doors shall be manufactured and installed in accordance with AS 2047 and in accordance with Part 3.6 of the BCA Housing Provisions (Vol 2). Where not tagged® a certificate of supply by the glazing manufacturer certifying that the glass supplied complies with nominated AS must be submitted to the PCA before requesting a final inspection of the work.

All windows and external glazed door to comply with NCC Part 8.2

- Windows must be installed in accordance with the following (a) Structural building loads must not be transferred to the window assembly.
- (b) A minimum 10 mm gap must be provided between the top of the window assembly and any loadbearing framing or masonry wall element. (c) The requirements of (b) may be increased where necessary to allow for frame
- settlement over wide openings (d) Packing, if provided between each window assembly and the frame, must be-
- (i) located along each side and bottom; and
- (ii) fixed to ensure the sides and bottom of the window assembly remain
- (iii) clear of any flashing material

Timber flooring/Carpet

• Floor finishing to be selected by the owners and installed in accordance with AS 2455 (carpet) and AS 1889 (PVC floor lining)

Plastering

- All internal walls and ceiling to be of 10mm thick plasterboard and installed in accordance with BCA and AS 2588

 Wall and floor tiles will be supplied and installed in accordance with clients selection and installed in accordance with AS 3740 (Waterproofing of wet areas within residential

Painting

Entire complex to be painted inside and out, in accordance with AS 3730 where required. All Internal areas to be 1 coat of sealer, 1 coat of under coat and 2 finish coats of the

Building in Bushfire Zones

Where relevant, all bushfire related conditions contained in the development consent for the work are to be complied with.

Where relevant, all energy efficiency conditions contained in the development consent for the work are to be complied with and, where required by the PCA, certified on completion of the work (see approved plans and construction certificate notes).

Natural and Mechanical Ventilation

All ventilation shall comply with the Part 3.8 of the BCA Housing Provisions (Vol 2) and, in the case of mechanical ventilation AS 1668.

Mechanical ventilation to all wet areas to comply with:

Part 10.6.2 Ventilation requirements

(c) An exhaust fan or other means of mechanical ventilation may be used to ventilate a sanitary compartment, laundry, kitchen or bathroom, or where mechanical ventilation is provided in accordance with 10.6.3(b), provided contaminated air exhausts comply with

10.8.1 - External wall construction

10.8.2 - Exhaust systems

(1)An exhaust system installed in a kitchen, bathroom, sanitary compartment or laundry must have a minimum flow rate of

(i) 25 L/s for a bathroom or sanitary compartment; and

(ii) 40 L/s for a kitchen or laundry.

(2)Exhaust from a kitchen, kitchen range hood, bathroom, sanitary compartment or laundry must discharge directly or via a shaft or duct to outdoor air.

(3)Where a venting clothes dryer is installed, it must discharge directly or via a shaft or duct to outdoor air.

(4)An exhaust system that is not run continuously and is serving a bathroom or sanitary compartment that is not ventilated in accordance with 10.6.2(a) must be interlocked with the room's light switch; and

include a run-on timer so that the exhaust system continues to operate for 10 minutes after the light switch is turned off.

(5)Except for rooms that are ventilated in accordance with 10.6.2(a), a room with an exhaust system in accordance with (1) must be provided with make-up airvia openings to an adjacent room with a free area of 14,000 mm2; or in accordance with

(6)Except for rooms that are ventilated in accordance with 10.6.2(a), a room with an exhaust system in accordance with (3) must be provided with make-up air in accordance

Storm water Drainage

All storm water drainage, including roof gutters, is to be in accordance with Part 3.1.2 of the BCA Housing Provisions (Vol 2) and AS 3500.

10.8.3 Ventilation of roof spaces

In climate zones 6, 7 and 8, a roof must have a roof space that—

is located-

immediately above the primary insulation layer; or

immediately above sarking with a vapour permeance of not less than 1.14 µg/N.s, which is immediately above the primary insulation layer; or

immediately above ceiling insulation that meets the requirements of 13.2.3(3) and 13.2.3(4);

has a height of not less than 20 mm; and

ventilated to outdoor air through evenly distributed openings in accordance with Table 10.8.3;

located immediately underneath the roof tiles of an unsarked tiled roof.

(2) The requirements of (1) do not apply to a-

concrete roof; or

roof that is made of structural insulated panels; or

roof that is subject to Bushfire Attack Level FZ requirements in accordance with AS 3959.

- All internal walls and ceiling to be of 10mm thick plasterboard and installed in accordance with BCA and AS 2588
- Cornices to be 3 stepped cornice

Provide and install smoke detectors in accordance with Part 3.7 of the BCA Housing Provisions (Vol 2) and AS 3786. Detectors are to be hardwired to the mains power supply. A certificate from the installing electrician is to be submitted to the PCA certifying compliance with the AS before requesting a final inspection of the work.

Part 3.7 Fire safety

a. Building wall offsets along adjoining allotments are within 900mm off the allotment boundaries the BCA requires that these walls be fire resistant walls in accordance with Part 3.7.1 (fire separation) in particular with clause 3.7.1.3 "An external wall of a class 1 building, and any openings in that wall, must comply with 3.7.1.5 if the wall is less than 900mm from an allotment boundary other than the boundary adjoining a road alignment or other public

The fire resistant levels required by the BCA is FRL 60/60/60

9.5.1 - Smoke alarm requirements

(a) be located in-

(i) Class 1a building in accordance with 9.5.2 and 9.5.4; and

(ii) Class 1b building in accordance with 9.5.3 and 9.5.4; and

(b) alarm comply with AS 3786, except that in a Class 10a private garage where the use of the area is likely to result in smoke alarms causing spurious signals, any other alarm deemed suitable in accordance with AS 1670.1 may be installed provided that smoke alarms complying with AS 3786 are installed elsewhere in the Class 1 building; and

(c) be powered from the consumer mains source where a consumer mains source is supplied to the building; and


(d) be interconnected where there is more than one alarm.


Class 1 b dwellings (hostels/guest houses/bed and breakfast premises) require smoke alarms to be installed on or near the ceiling:


- In every bedroom; and
- In every corridor or hallway associated with a bedroom; and
- Any other storey not containing bedrooms, in the area of the stairway (exit path) between

NATIONAL CONSTRUCTION CODE SERIES VOLUME TWO

EXTRACTS

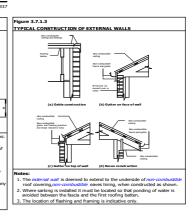

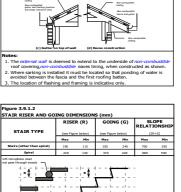

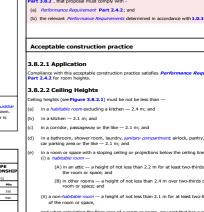

PART 3.8.2 ROOM HEIGHTS

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CLIENT DESIGN APPROVAL:

ENT OF ACCEPTABLE CEILING HEIGHTS

BKEA Investment CLIENT NAME

CLIENT SIGNATURE:

BASIX Certificate CERTIFICATE NUMBER: TBD

DRAWING NAME:

BUILDING SPECIFICATION

LGA: NORTHERN BEACHES

LOT 27, NO. 2 MARETIMO STREET, BALGOWLAH, NSW 2093

MQ - JCF DATE: 12.12.24 SCALE: LODGEMENT:


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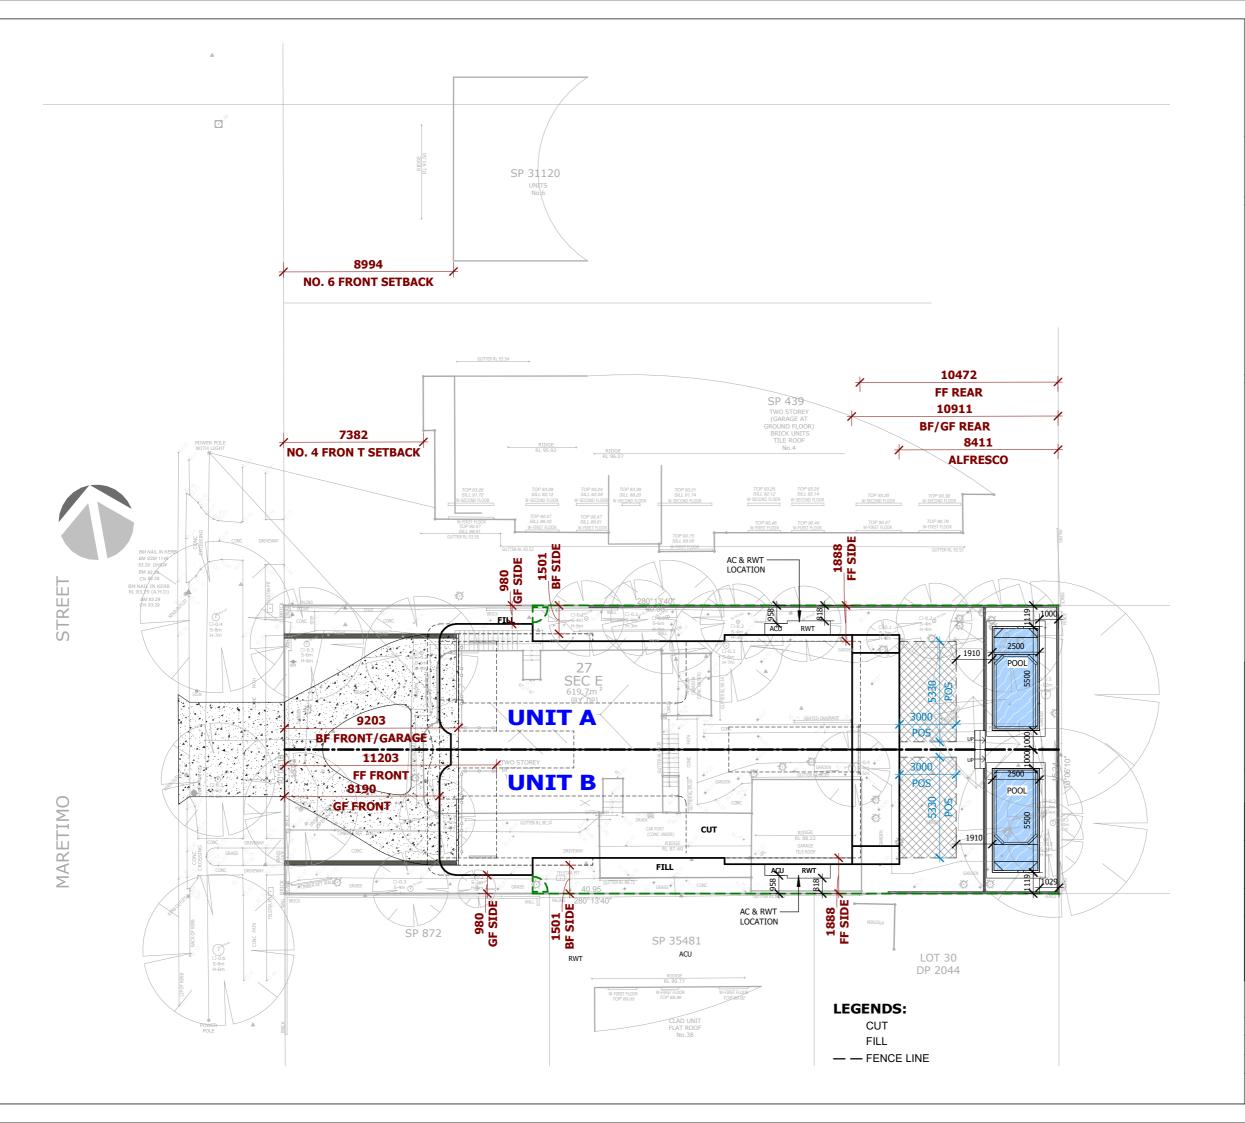
DRAWN:

CONSTRUCTION **DRAWINGS**

SHEET No:

CDC - LRHDC



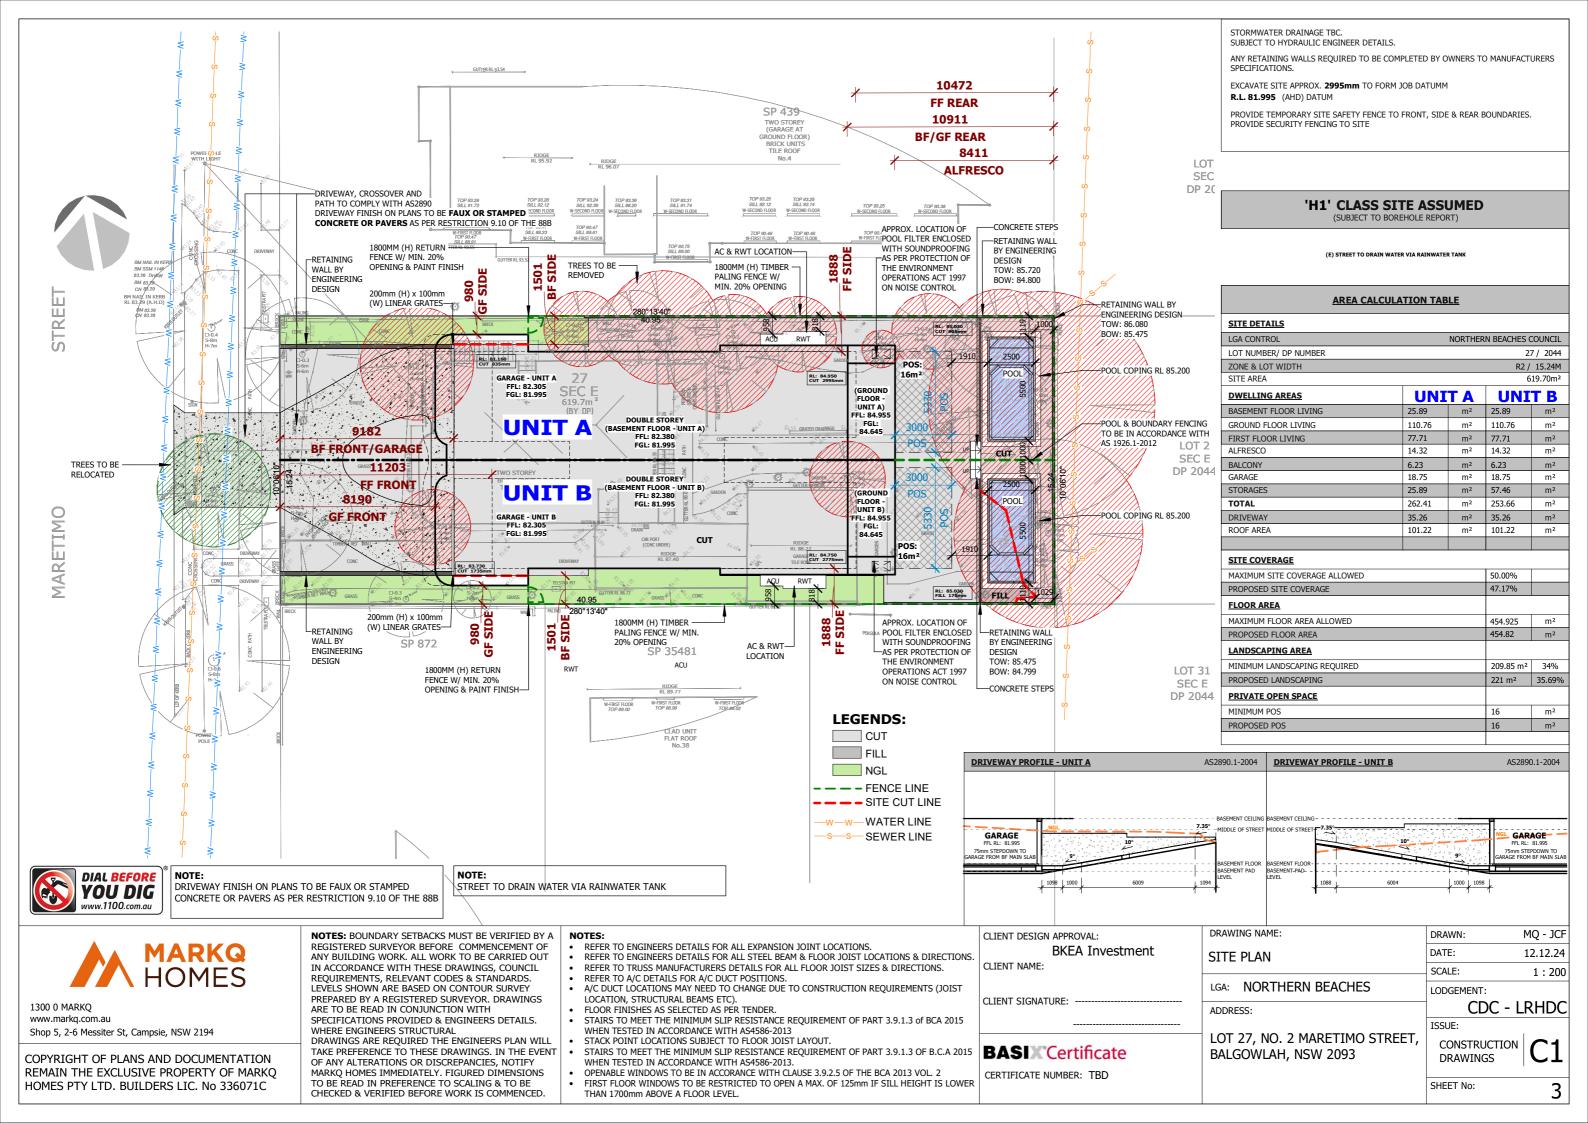



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BKEA Investment
CLIENT NAME:
CLIENT SIGNATURE:

BASIX Certificate

CERTIFICATE NUMBER: TBD

DRAWING NAME:

SITE PLAN 2

LGA: NORTHERN BEACHES

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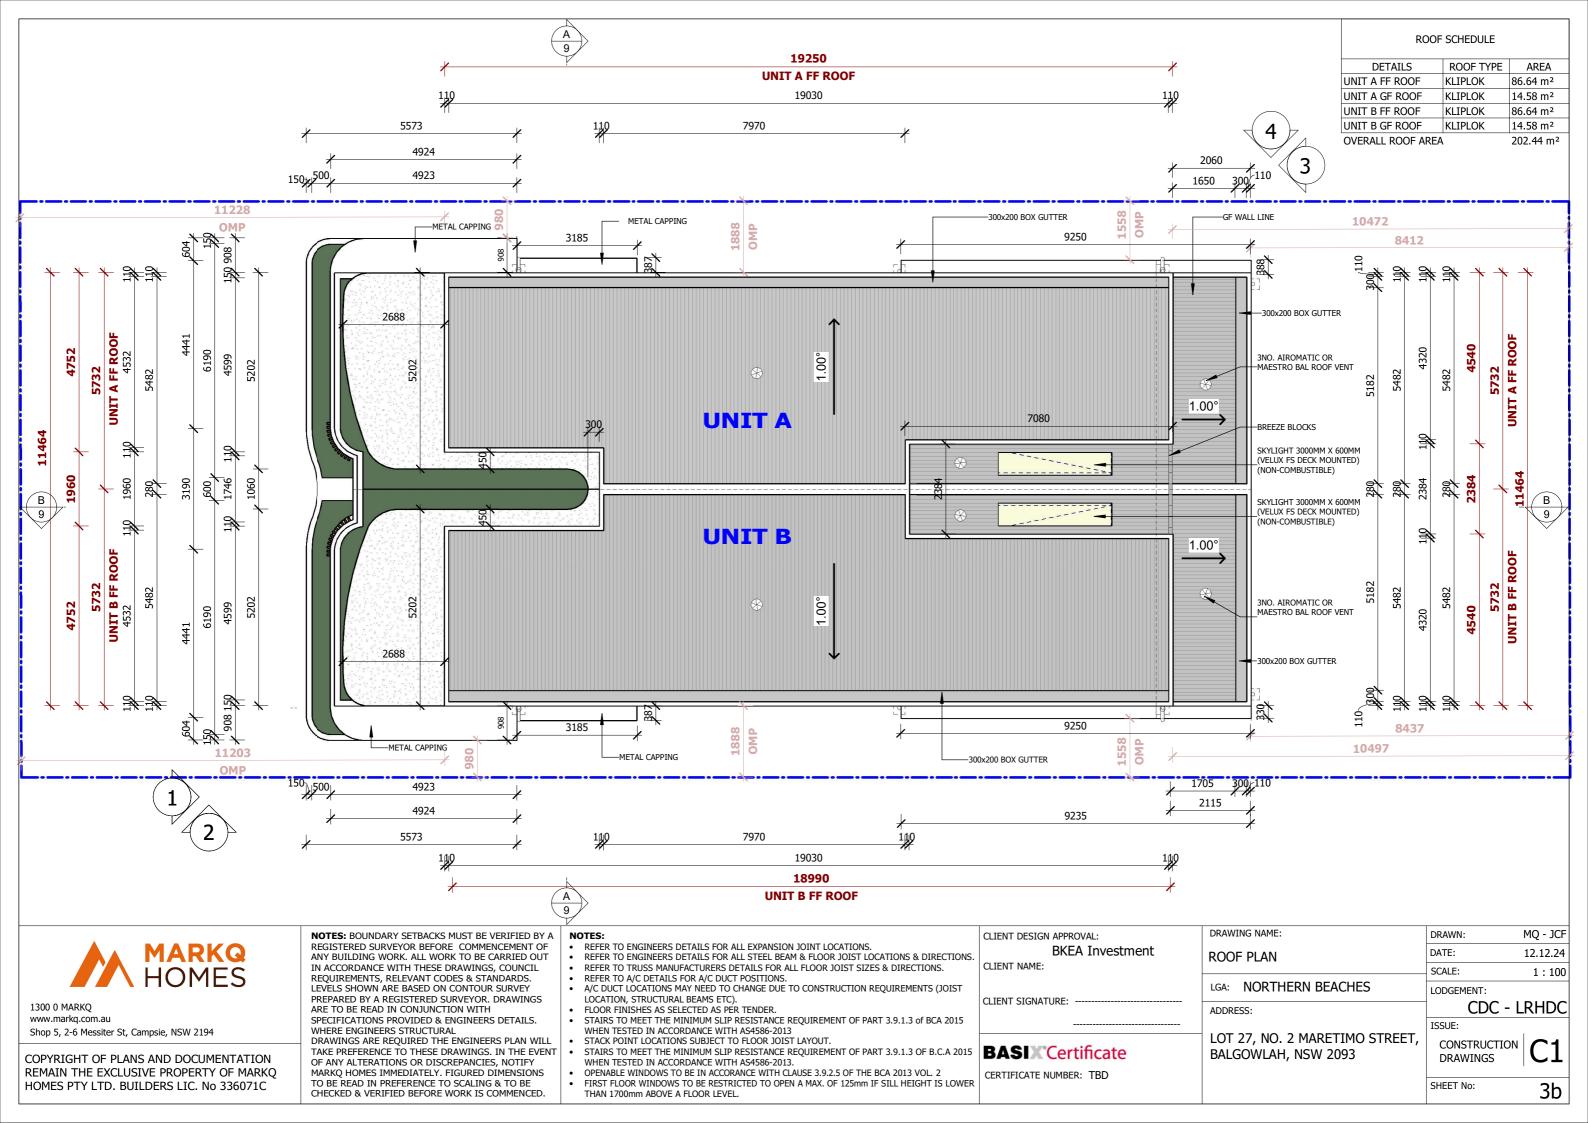
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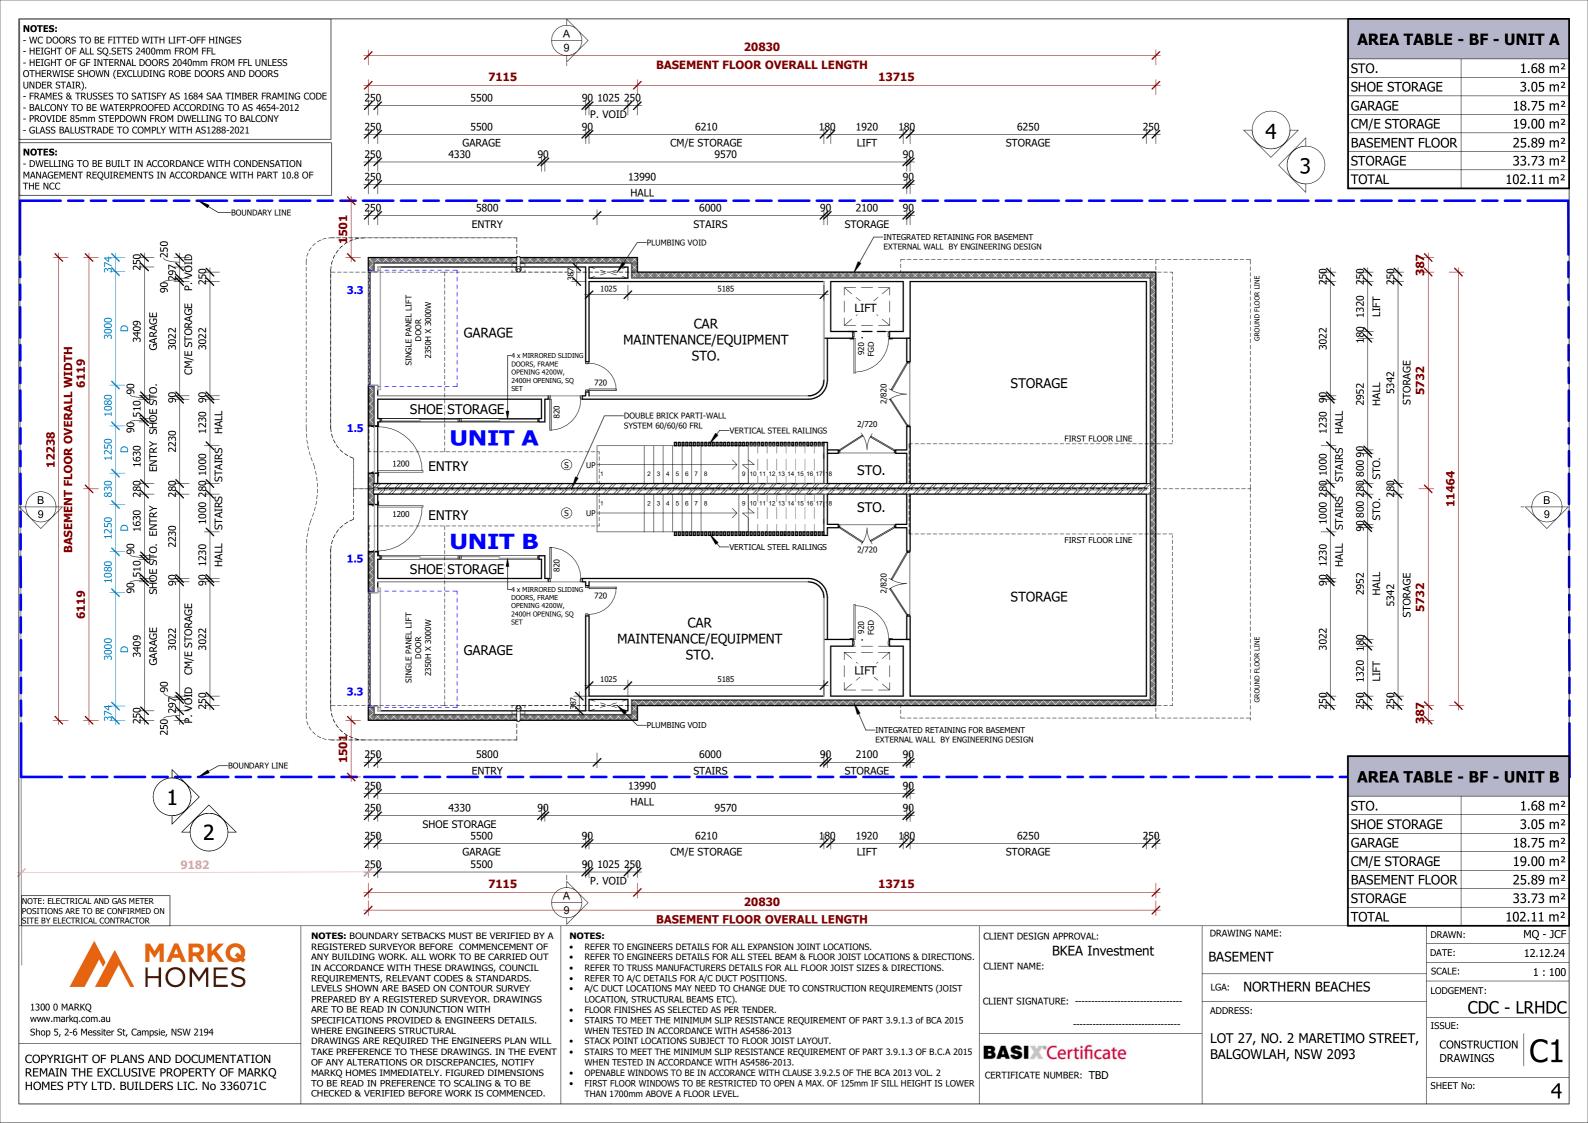
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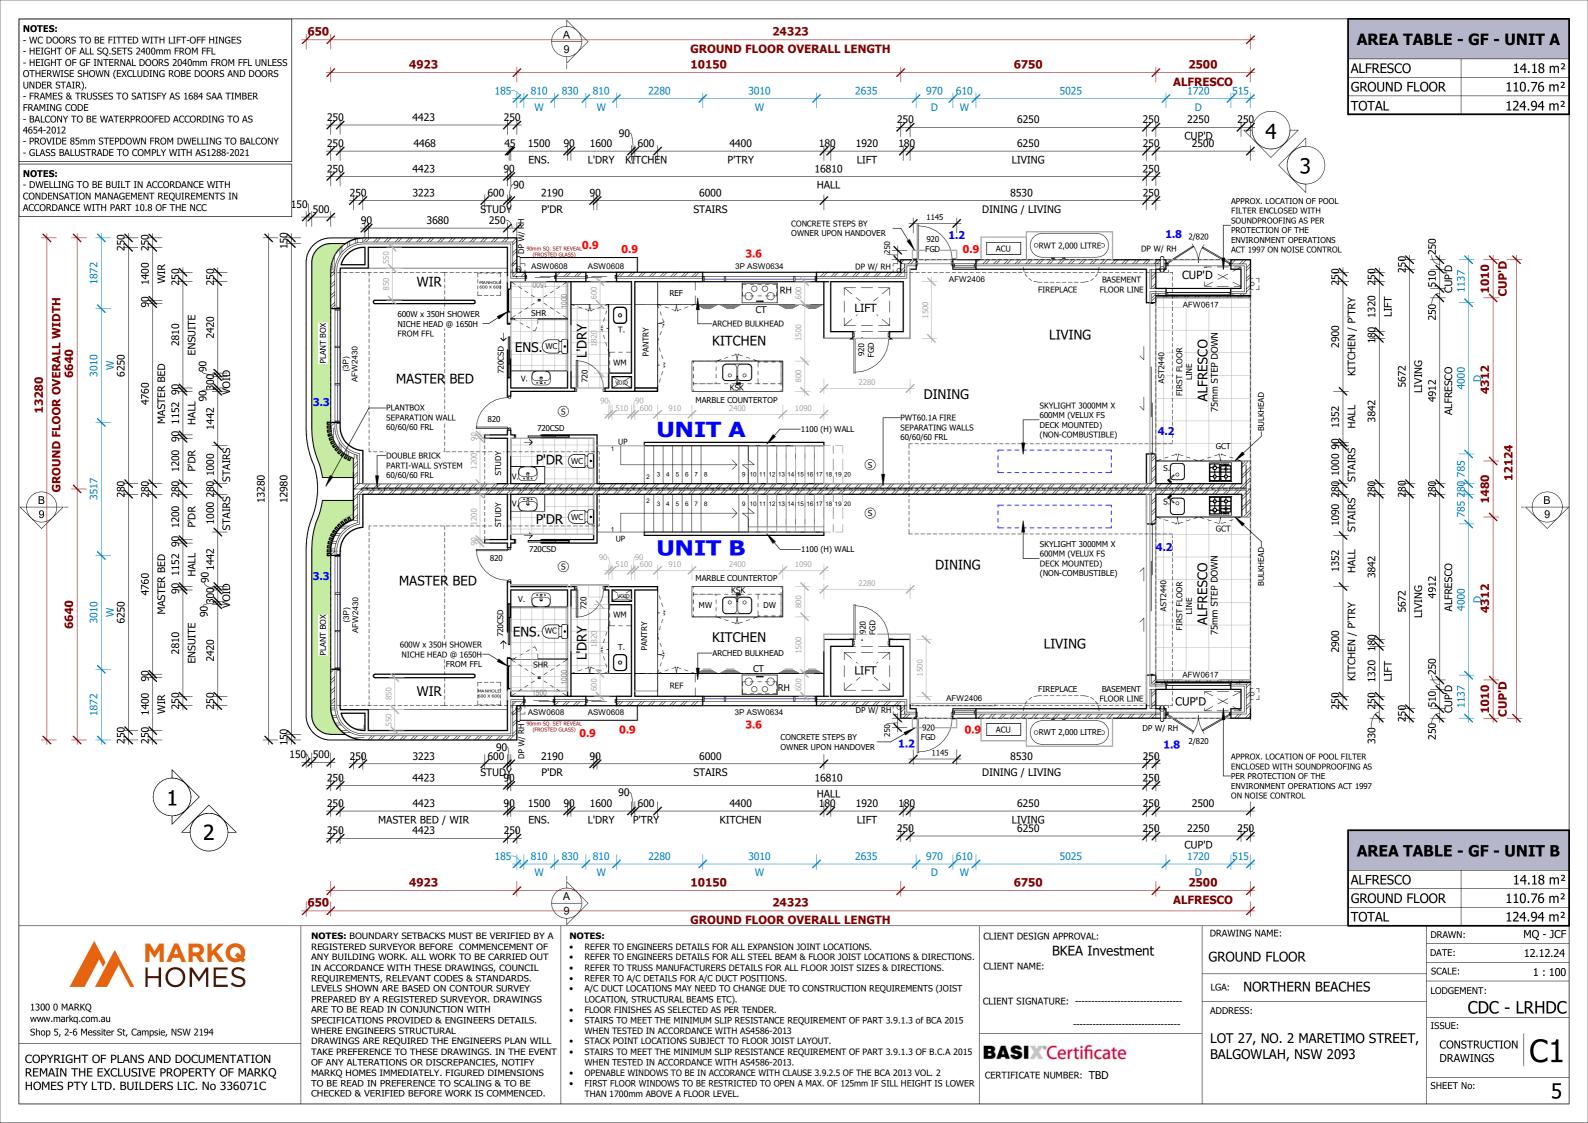
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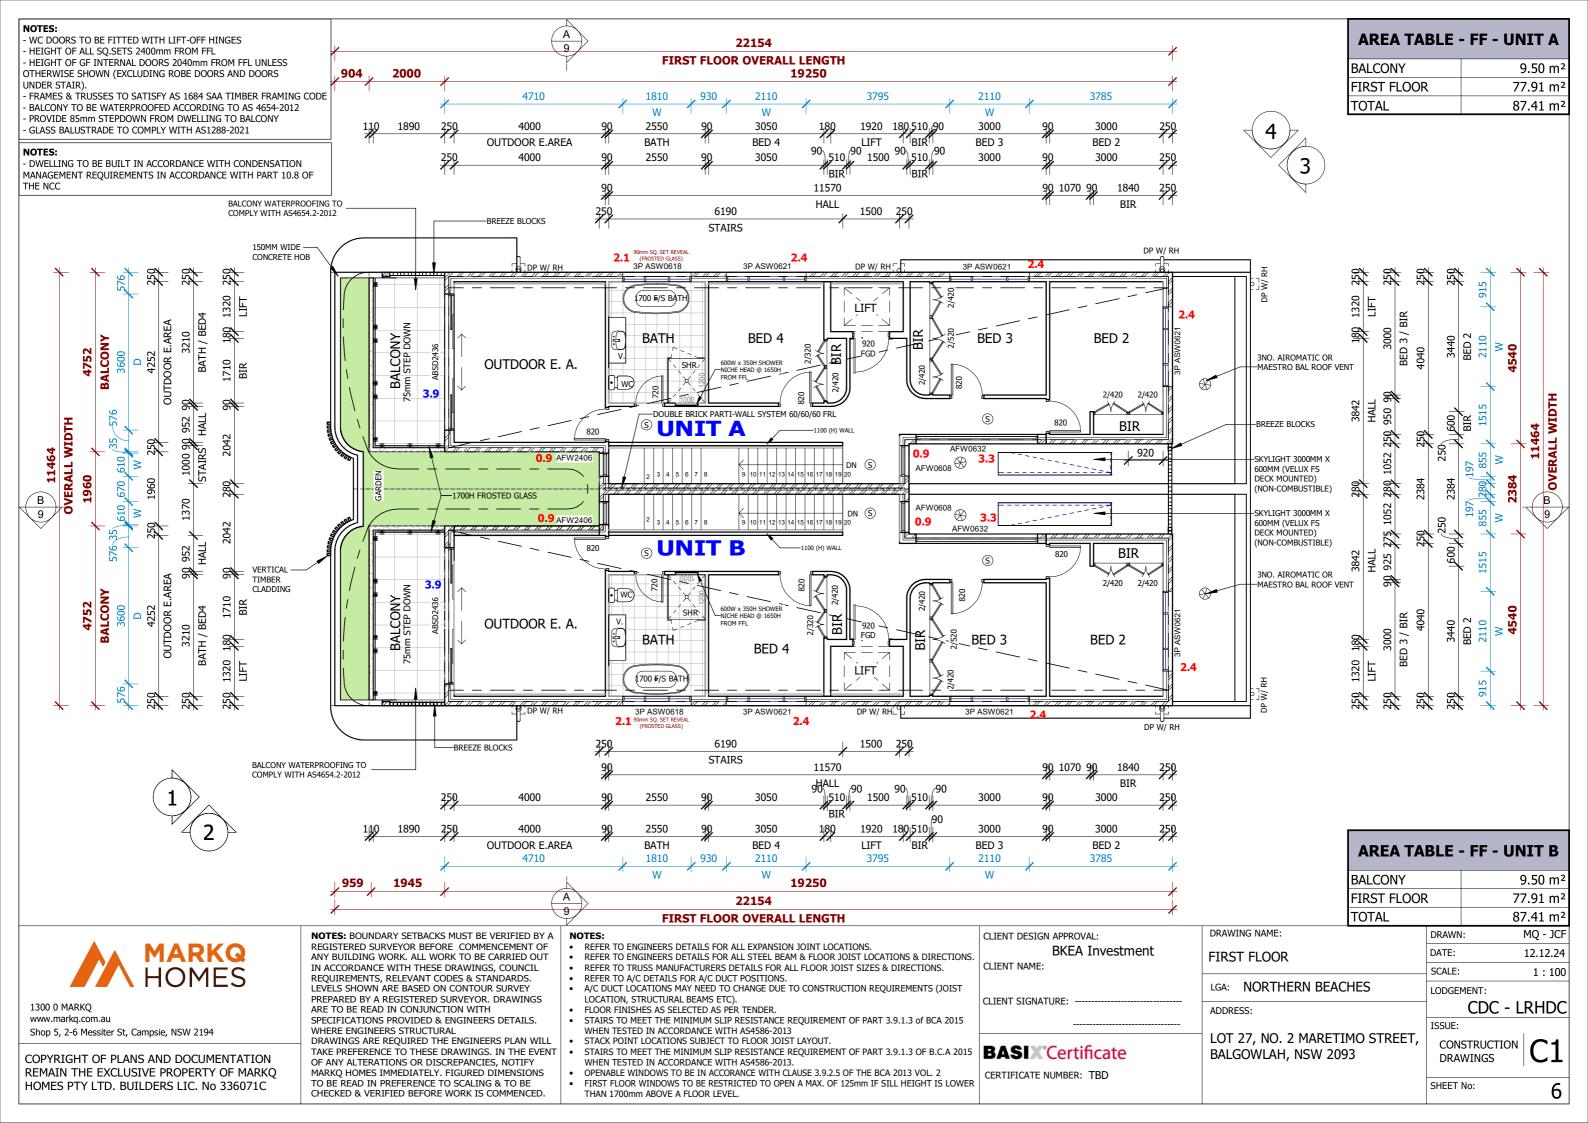
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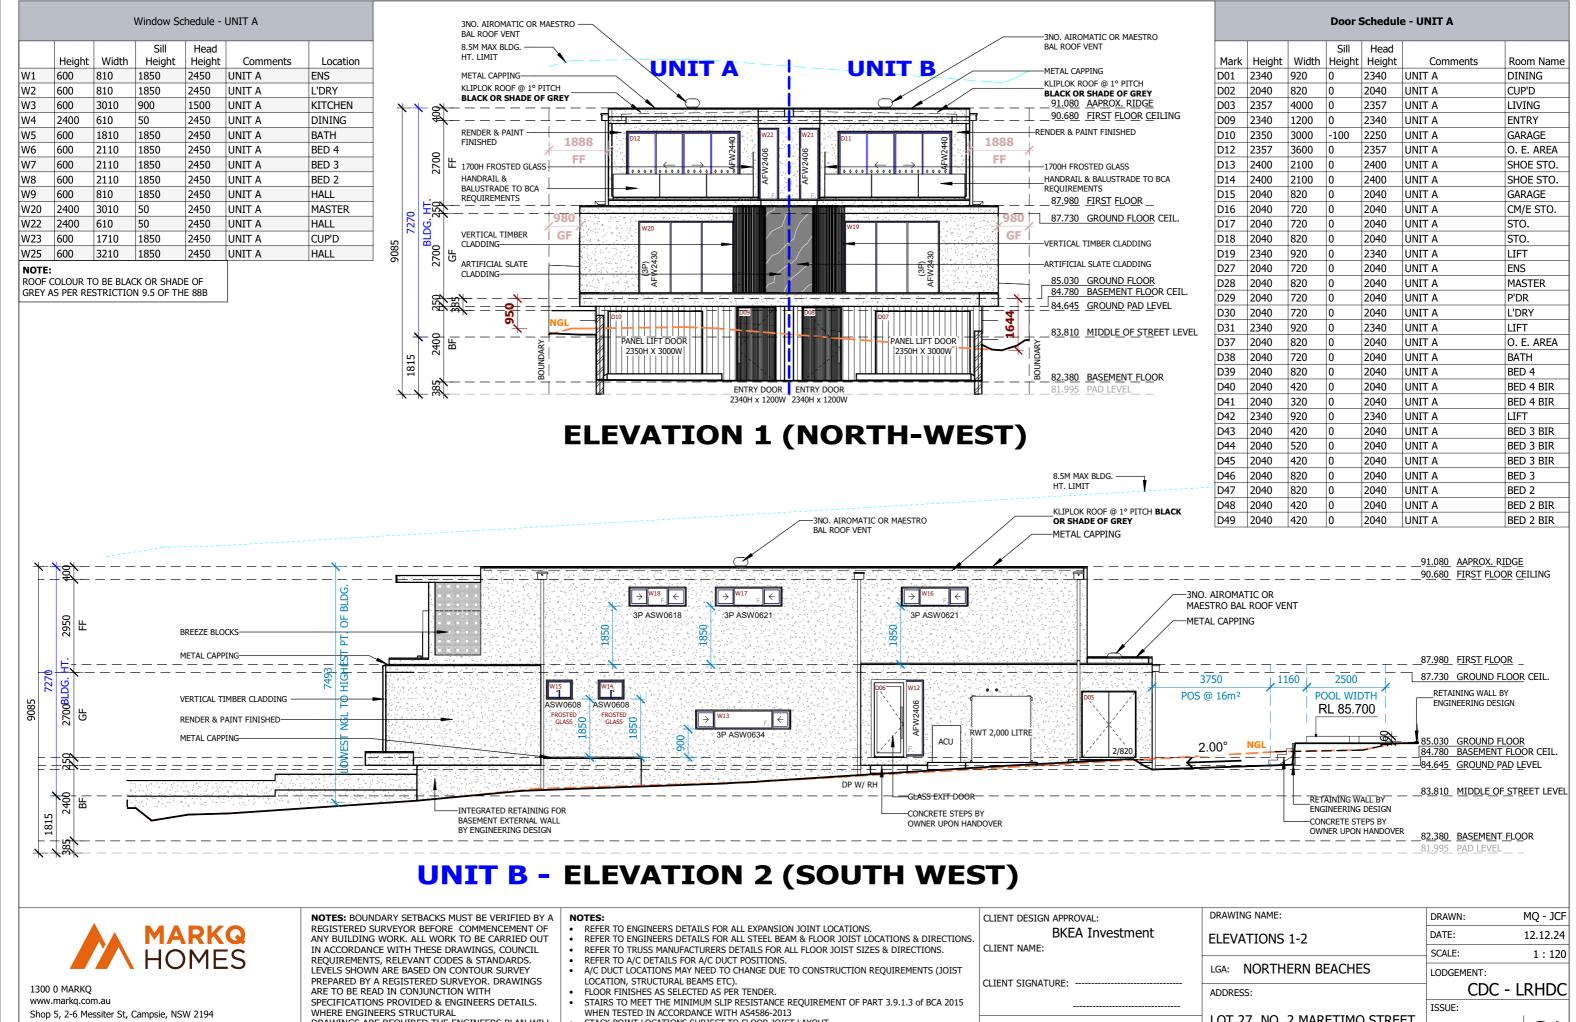
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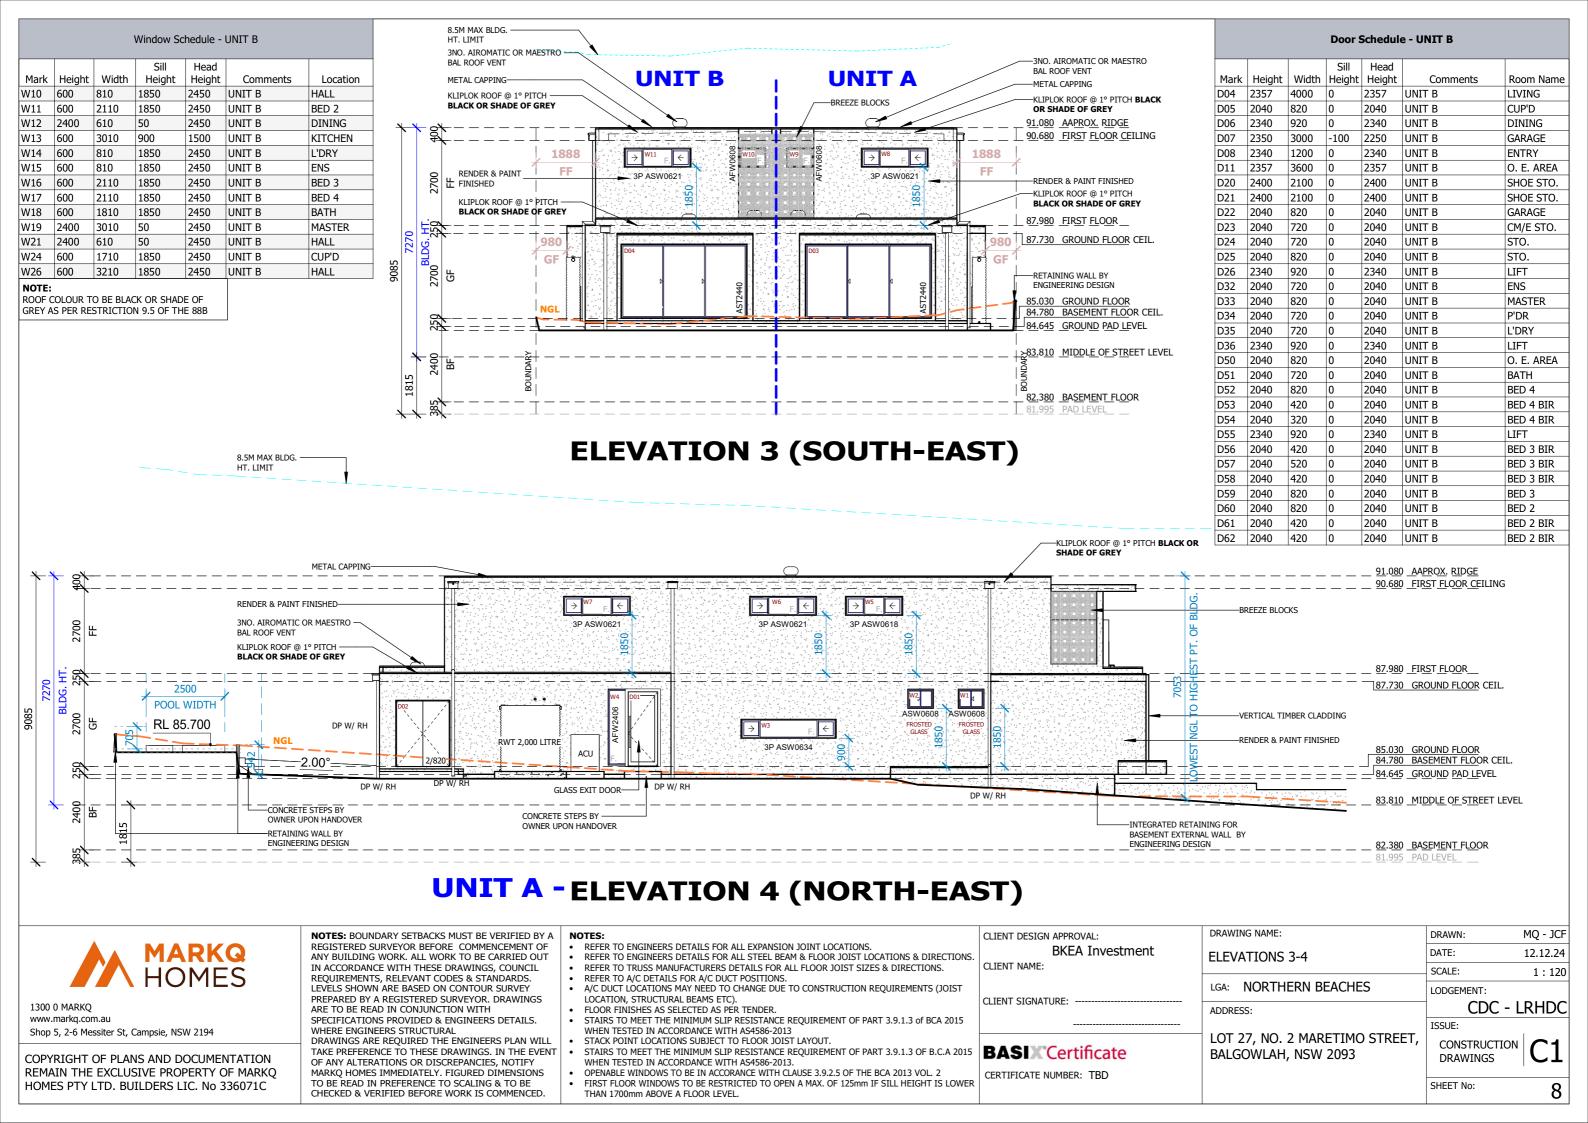
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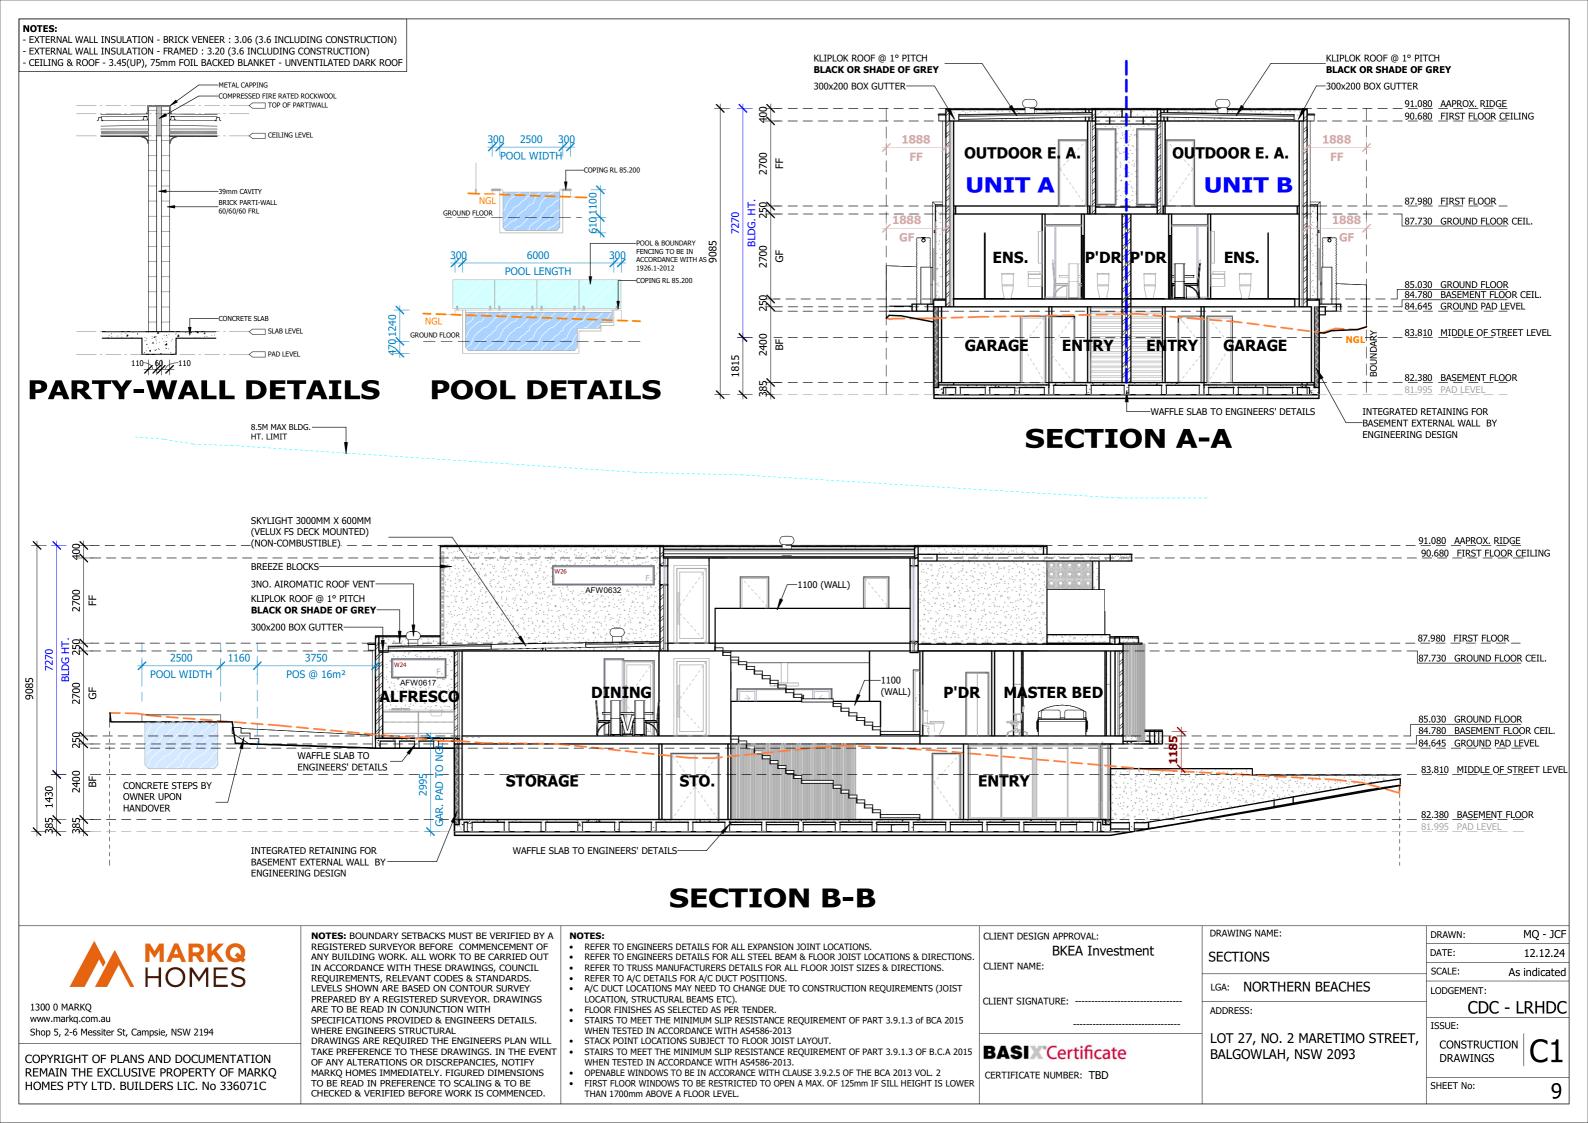
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CONSTRUCTION

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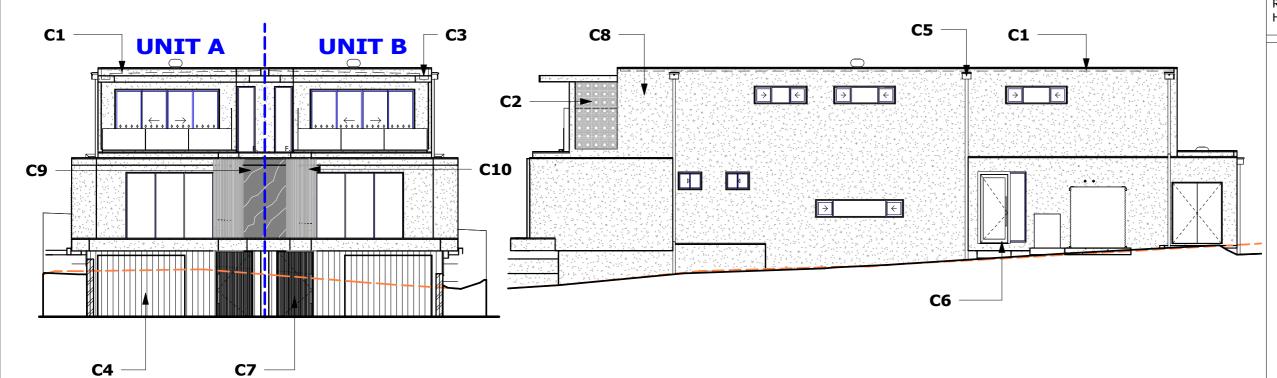






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COLOUR SWATCHES					
	DESCRIPTION	COLOUR CODE		DESCRIPTION	COLOUR CODE
C1	KLIPLOK ROOF	BABYLON	C6	ALUMINIUM WINDOWS & DOORS	VICTORIAN ASH
C2	BREEZE BLOCKS	WHITE	C7	ENTRANCE DOOR	VICTORIAN ASH
С3	FASCIA & GUTTER	BASALT	C8	RENDER	ZINCALUME
C4	GARAGE DOOR	VICTORIAN ASH	С9	STONE CLADDING	NOSTRA
C5	DOWN PIPE	WINDSPRAY	C10	VERTICAL TIMBER WALL CLADDING	VICTORIAN ASH


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SCHEDULE OF COLOURS & FINISHES

LGA: NORTHERN BEACHES

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LODGEMENT:			
	CDC -	LRHDC	
DRAWN:	MQ - JCF	ISSUE:	
DATE:	12.12.24	CONSTRUCTION	C 1
SCALE:	1:130	DRAWINGS	CI
		SHEET No:	10



Tree planting requirement to be complete by owner prior to occupation certificate as per following:

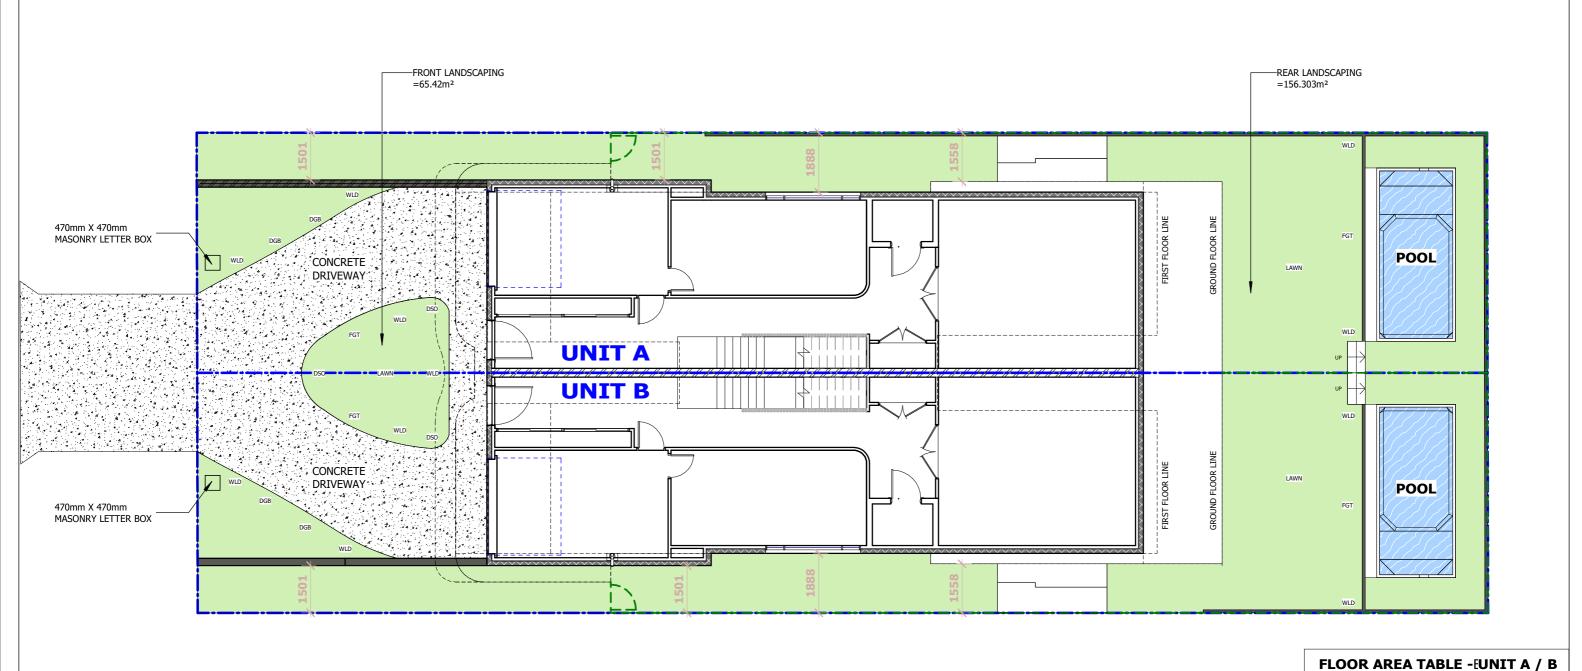- in the area opposite the boundary to which the front of the dwelling house faces—that is capable of achieving a height of at least 8m at maturity, and
- in the area opposite the rear boundary of the dwelling house—that is capable of achieving a height of at least 5m at maturity

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- STACK POINT LOCATIONS SUBJECT TO FLOOR JOIST LAYOUT.
- STAIRS TO MEET THE MINIMUM SLIP RESISTANCE REQUIREMENT OF PART 3.9.1.3 OF B.C.A 2015 WHEN TESTED IN ACCORDANCE WITH AS4586-2013.
- OPENABLE WINDOWS TO BE IN ACCORANCE WITH CLAUSE 3.9.2.5 OF THE BCA 2013 VOL. 2
- FIRST FLOOR WINDOWS TO BE RESTRICTED TO OPEN A MAX. OF 125mm IF SILL HEIGHT IS LOWER THAN 1700mm ABOVE A FLOOR LEVEL.

CLIENT DESIGN APPROVAL: **BKEA Investment** CLIENT NAME: CLIENT SIGNATURE: **BASIX** Certificate CERTIFICATE NUMBER: TBD

TOTAL LAWN AREA DRAWING NAME: CONCEPT LANDSCAPE PLAN LGA: NORTHERN BEACHES ADDRESS:

LOT 27, NO. 2 MARETIMO STREET, BALGOWLAH, NSW 2093

221.16 m² DRAWN: MQ - JCF DATE: 12.12.24 SCALE: 1:120 LODGEMENT: CDC - LRHDC ISSUE:

102.11 m²

125.45 m²

87.41 m²

18.75 m²

619.70 m²

202.24 m²

65.422 m²

156.303 m²

m²

14.32

9.50

70.52

28.30

BASEMENT FLOOR

GROUND FLOOR

FIRST FLOOR

GARAGE

ALFRESCO

BALCONY

SITE AREA

CROSSOVER

ROOF AREA

DRIVEWAY & PATH

FRONT LAWN AREA


BACK LAWN AREA


CONSTRUCTION **DRAWINGS**

SHEET No:


11


	PLANTING SCHEDULE				
CODE	COMMON NAME	BOTANICAL NAME	IMAGE	QUANTITY	
DGB	DWARF GREEN FLOWERING BOTTLEBRUSH	CALLISTEMON PACHYPHYLLUS GREEN		4	
DSO	DWARF SPIDER OAK	GREVILLA LEIOPHYLLA		3	
FGT	FLOWERING GUM	CORYMBIA		4	
WLD	WEDGE LEAFED DAMPIERA	DAMPIERA CORONATA		11	

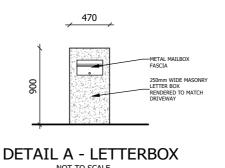

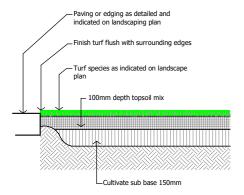



Ground preparation Grassed area: turf using imported topsoil Detail. Not.To.Scale.

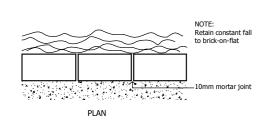

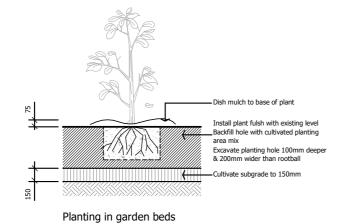

50x228x113mm brick—on—flat and bedding 100x200mm 20Mpa

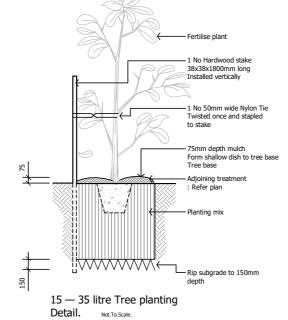

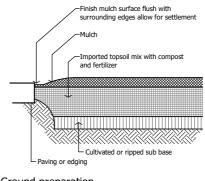

Ground preparation Planting area using imported topsoil Detail. Not.To.Scale.



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NOTES: BOUNDARY SETBACKS MUST BE VERIFIED BY A REGISTERED SURVEYOR BEFORE COMMENCEMENT OF ANY BUILDING WORK. ALL WORK TO BE CARRIED OUT IN ACCORDANCE WITH THESE DRAWINGS, COUNCIL REQUIREMENTS, RELEVANT CODES & STANDARDS. LEVELS SHOWN ARE BASED ON CONTOUR SURVEY PREPARED BY A REGISTERED SURVEYOR. DRAWINGS ARE TO BE READ IN CONJUNCTION WITH SPECIFICATIONS PROVIDED & ENGINEERS DETAILS. WHERE ENGINEERS STRUCTURAL

Brick garden edge

Detail.

Detail. Not.To.Scale.


DRAWINGS ARE REQUIRED THE ENGINEERS PLAN WILL TAKE PREFERENCE TO THESE DRAWINGS. IN THE EVENT OF ANY ALTERATIONS OR DISCREPANCIES, NOTIFY MARKO HOMES IMMEDIATELY, FIGURED DIMENSIONS TO BE READ IN PREFERENCE TO SCALING & TO BE CHECKED & VERIFIED BEFORE WORK IS COMMENCED.

- REFER TO ENGINEERS DETAILS FOR ALL EXPANSION JOINT LOCATIONS.
- REFER TO ENGINEERS DETAILS FOR ALL STEEL BEAM & FLOOR JOIST LOCATIONS & DIRECTIONS.
- REFER TO TRUSS MANUFACTURERS DETAILS FOR ALL FLOOR JOIST SIZES & DIRECTIONS.
- REFER TO A/C DETAILS FOR A/C DUCT POSITIONS.
- A/C DUCT LOCATIONS MAY NEED TO CHANGE DUE TO CONSTRUCTION REQUIREMENTS (JOIST
- LOCATION, STRUCTURAL BEAMS ETC).
- FLOOR FINISHES AS SELECTED AS PER TENDER STAIRS TO MEET THE MINIMUM SLIP RESISTANCE REQUIREMENT OF PART 3.9.1.3 of BCA 2015 WHEN TESTED IN ACCORDANCE WITH AS4586-2013
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- OPENABLE WINDOWS TO BE IN ACCORANCE WITH CLAUSE 3.9.2.5 OF THE BCA 2013 VOL. 2 FIRST FLOOR WINDOWS TO BE RESTRICTED TO OPEN A MAX. OF 125mm IF SILL HEIGHT IS LOWER THAN 1700mm ABOVE A FLOOR LEVEL.

CLIENT DESIGN APPROVAL: **BKEA Investment** CLIENT NAME: CLIENT SIGNATURE:

BASIX Certificate CERTIFICATE NUMBER: TBD

DRAWING NAME: DRAWN: MQ - JCF DATE: 12.12.24 PLANTING SCHEDULE SCALE: As indicated LGA: NORTHERN BEACHES LODGEMENT: CDC - LRHDC ISSUE: LOT 27, NO. 2 MARETIMO STREET, CONSTRUCTION BALGOWLAH, NSW 2093 **DRAWINGS** SHEET No: 12

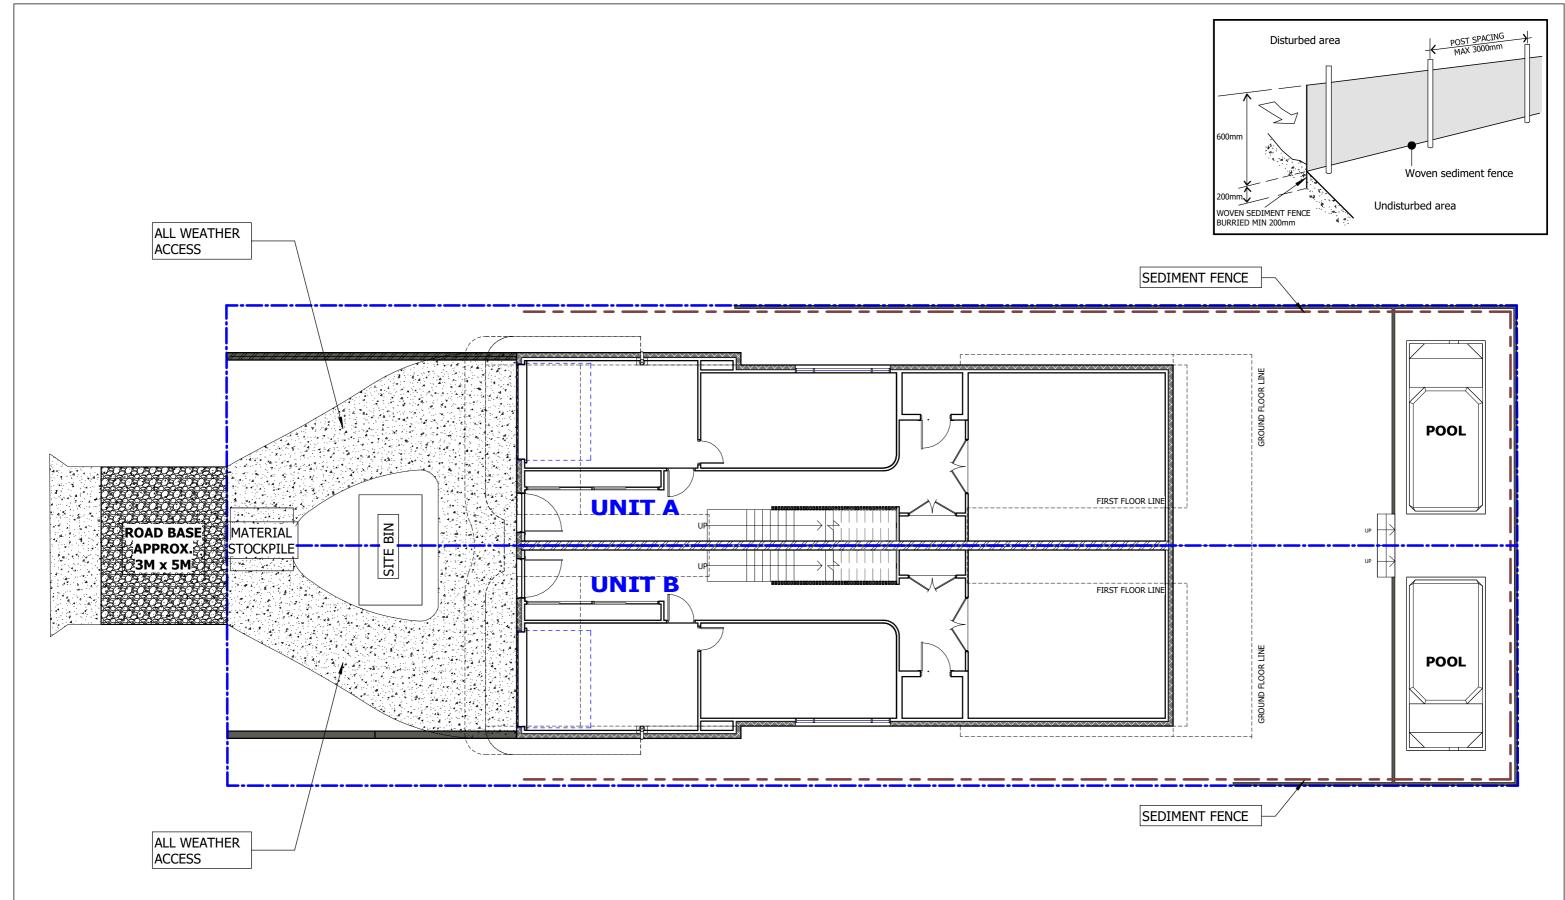



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- WHEN TESTED IN ACCORDANCE WITH AS4586-2013.
- OPENABLE WINDOWS TO BE IN ACCORANCE WITH CLAUSE 3.9.2.5 OF THE BCA 2013 VOL. 2
 FIRST FLOOR WINDOWS TO BE RESTRICTED TO OPEN A MAX. OF 125mm IF SILL HEIGHT IS LOWER THAN 1700mm ABOVE A FLOOR LEVEL.

CLIENT DESIGN APPROVAL: **BKEA Investment** CLIENT NAME:

CERTIFICATE NUMBER: TBD

CLIENT SIGNATURE:


DRAWING NAME: SEDIMENT CONTROL PLAN LGA: NORTHERN BEACHES LOT 27, NO. 2 MARETIMO STREET, BALGOWLAH, NSW 2093


DRAWN: MQ - JCF DATE: 12.12.24 SCALE: As indicated LODGEMENT: CDC - LRHDC ISSUE:


CONSTRUCTION DRAWINGS

SHEET No:

13

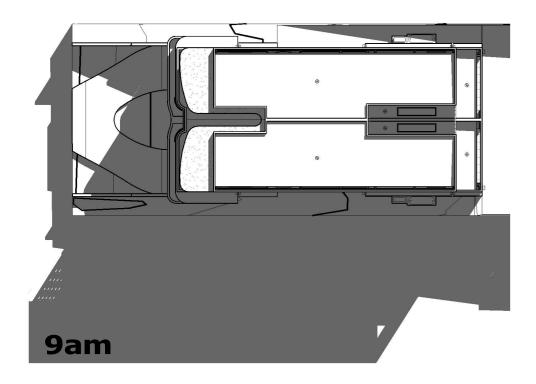

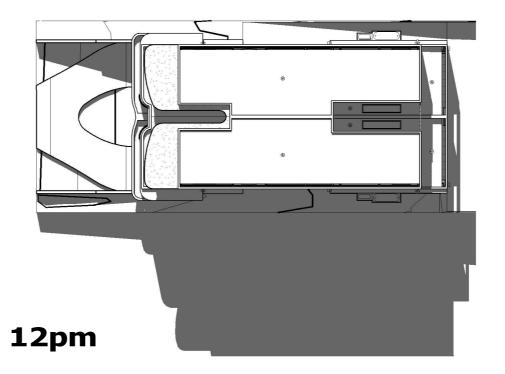

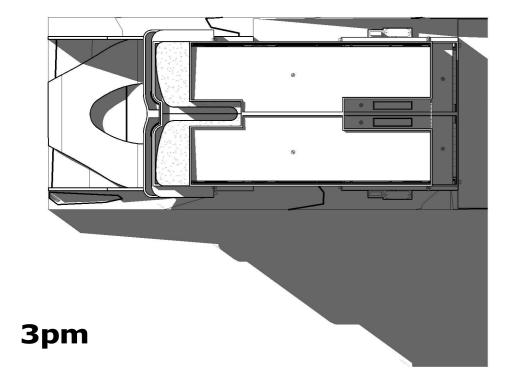



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CLIENT DESIGN APPROVAL:
BKEA Investment
CLIENT NAME:
CLIENT SIGNATURE:

BASIX*Certificate

CERTIFICATE NUMBER: TBD

DRAWING NAME:

SHADOW DIAGRAMS

LGA: NORTHERN BEACHES

ADDRESS:

LOT 27, NO. 2 MARETIMO STREET, BALGOWLAH, NSW 2093

LODGEMENT:


CDC - LRHDC

DRAWN:	MQ - JCF
DATE:	12.12.24
SCALE:	1:300

CONSTRUCTION DRAWINGS

SHEET No:

14

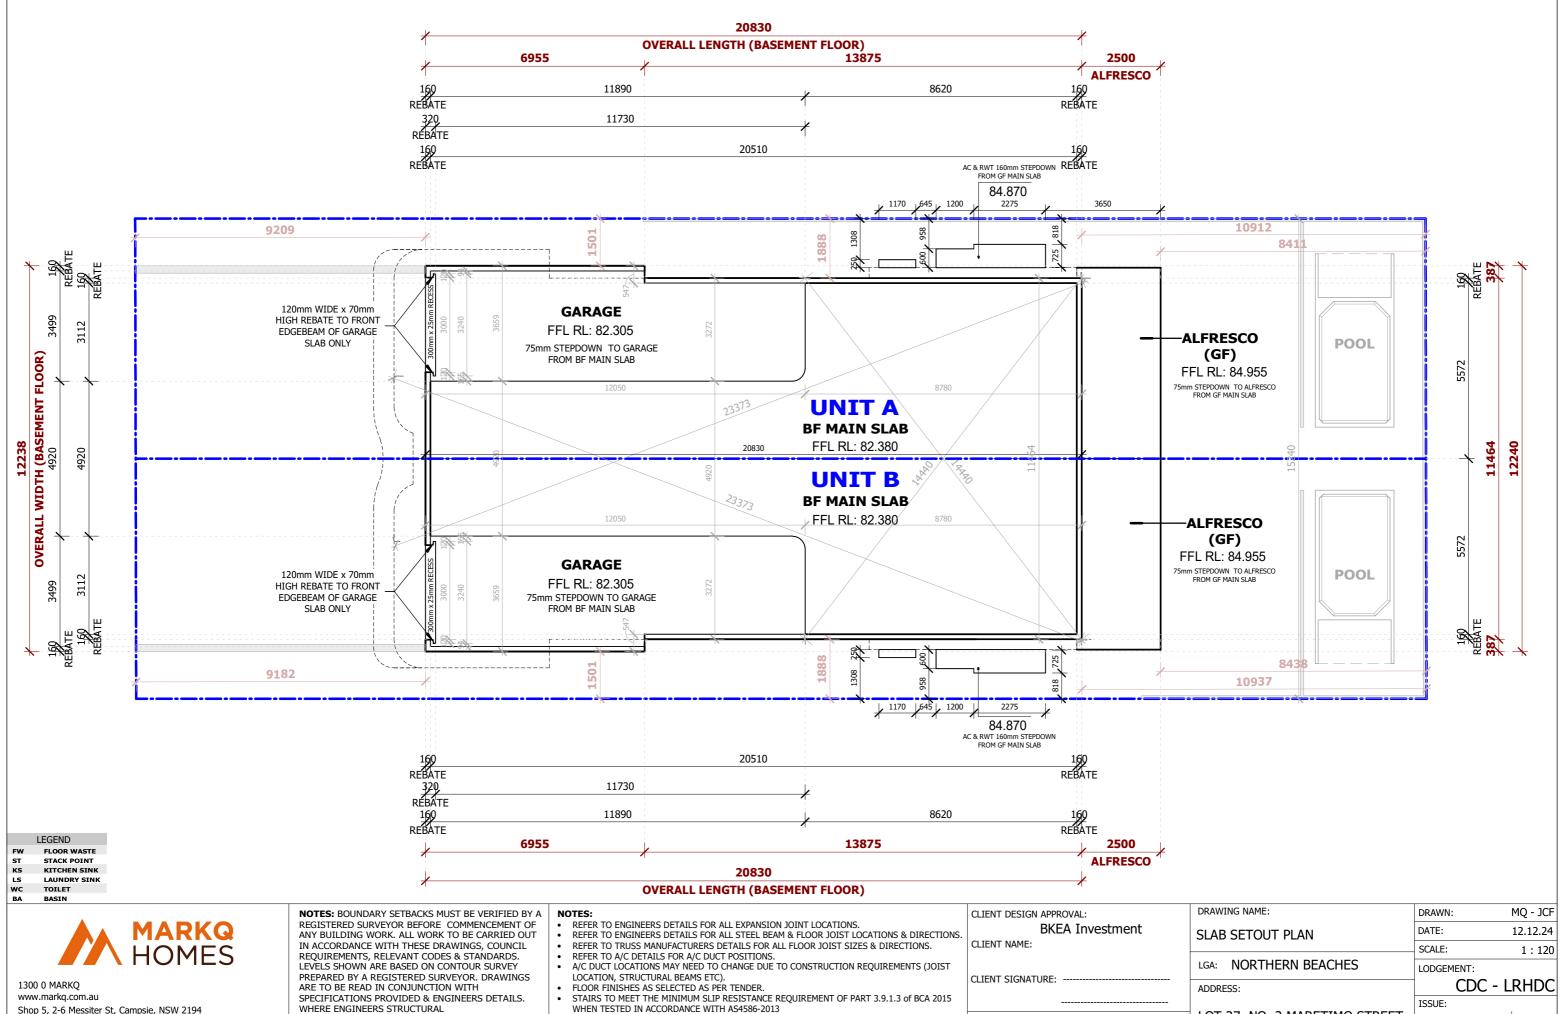

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STACK POINT LOCATIONS SUBJECT TO FLOOR JOIST LAYOUT.

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OPENABLE WINDOWS TO BE IN ACCORANCE WITH CLAUSE 3.9.2.5 OF THE BCA 2013 VOL. 2 CERTIFICATE NUMBER: TBD

BASIX Certificate

LOT 27, NO. 2 MARETIMO STREET, BALGOWLAH, NSW 2093

CONSTRUCTION

DRAWINGS

SHEET No: 15