#### STANDARD CONSTRUCTION NOTES **BASIX COMMITMENTS**

#### WALL FRAMING

- WRITTEN DIMENSIONS TAKE PRECEDENCE OVER SCALE. ALL STRUCTURAL TIMBER FRAMING SIZES TO BE IN ACCORDANCE WITH
- AS 1684:2010 NATIONAL TIMBER FRAMING CODE AND ENGINEER'S STRUCTURAL COMPUTATIONS. WALL BRACING, FIXING, TIE DOWNS, DURABILITY
- NOTES & ANY ADDITIONAL ENGINEERING REQUIREMENTS TO BE AS PER ENGINEER'S DETAILS. FLOOR PLAN DIMENSIONS ARE TO FRAME SIZE ONLY.
- ALL WATER CLOSET DOORS TO BE REMOVABLE IN ACCORDANCE WITH N.C.C. 3.8.3.3
- CENTRE ALL WINDOWS & DOORS INTERNALLY TO ROOM UNLESS DIMENSIONED OTHERWISE
- PROVIDE 2No. 90mm x 45mm JAMB STUDS TO ALL INTERNAL DOOR OPENINGS AND ALL SLIDING ROBE DOOR OPENINGS AS PER DETAIL S-TYP-DOOR-01

#### **ROOF FRAMING**

- GARAGE ROOF TO BE TIED DOWN MIN. 1200mm INTO BRICKWORK WITH HOOP IRON STRAPS.
- PREFABRICATED ROOF TRUSSES TO MANUFACTURER'S SPECIFICATIONS. PITCH AS SHOWN ON ELEVATIONS.

#### EXTERNAL WALLS

ALL PARAPET WALLS TO BE PROVIDED WITH COLORBOND METAL CAPPING/FLASHING (50mm MIN. OVERLAP TO ALL JOINTS WITH CONTINUOUS SILICONE SEALANT BETWEEN & 30mm MIN. VERTICAL OVERHANG).

#### SLAB AND FOOTINGS

- REINFORCED CONCRETE SLAB AND ASSOCIATED FOOTINGS IN ACCORDANCE WITH ENGINEER'S DETAILS.
- SUB-FLOOR VENTILATION IN ACCORDANCE WITH N.C.C. 3.4.1. TO BE PROVIDED TO SUSPENDED TIMBER FLOOR WHERE APPLICABLE.

#### PLUMBING AND DRAINAGE

• ALL PLUMBING, DRAINAGE & ASSOCIATED WORKS TO COMPLY WITH THE PLUMBING CODE OF AUSTRALIA, N.C.C. & AS 3500 - PLUMBING AND DRAINAGE.

#### TERMITE PROTECTION

 PROVIDE TERMITE MANAGEMENT SYSTEM AS PER; AS 3660.1:2014 - TERMITE MANAGEMENT

#### GLAZING

- WINDOWS TO SIDE AND REAR ELEVATIONS ARE ALUMINIUM SLIDING (UNLESS NOTED OTHERWISE).
- WINDOW SIZES ARE NOMINATED AS GENERIC CODES; FIRST TWO NUMBERS REFER TO HEIGHT & SECOND TWO REFER TO WIDTH.
- WINDOW SUPPLIER TO PROVIDE COVER BOARDS TO ALL CORNER WINDOWS UNLESS NOTED OTHERWISE.
- ALL GLAZING TO COMPLY WITH; AS 1288:2006 GLASS IN BUILDINGS
- AS 4055:2012 WIND LOADS FOR HOUSING WINDOW HEAD HEIGHT DIMENSIONS TO BE TAKEN TO
- THE NEAREST CORRESPONDING BRICK COURSE. PROTECTION OF OPENABLE WINDOWS TO BE PROVIDED IN ACCORDANCE WITH N.C.C. 3.9.2.5

#### **STEPS, STAIRS & BALUSTRADES**

- ALL STEPS & STAIRS TO HAVE; 240mm MIN. & 355nm MAX. TREAD DEPTH AND 115mm MIN. & 190mm MAX. RISER HEIGHT IN ACCORDANCE WITH N.C.C. 3.9.1.
- BALUSTRADE IN ACCORDANCE WITH N.C.C. 3.9.2. TO BE INSTALLED WHERE INTERNAL & EXTERNAL LANDINGS EXCEED 1000mm ABOVE GROUND LEVEL. PROVIDE SLIP RESISTANCE IN ACCORDANCE WITH
- N.C.C. 3.9.1.4 AND AS 4586:2013 SLIP RESISTANCE.

#### WATERPROOFING

- PROVIDE CAVITY FLASHING & WEEP HOLES ABOVE LOWER STOREY OPENINGS
- WATERPROOFING OF WET AREAS TO COMPLY WITH: AS 3740:2010 WATERPROOFING OF DOMESTIC WET AREAS &/OR N.C.C. 3.8.1

#### INTERNAL ELEVATIONS

- TILE & CUPBOARD DIMENSIONS ARE APPROXIMATE ONLY & MAY BE ALTERED TO SUIT MODULAR SIZES.
- DIMENSIONS INDICATED TAKEN FROM PLASTER.
- ALL DIMENSIONS ARE SUBJECT TO SITE MEASURE
- SHOWER SCREEN HEIGHTS ARE INDICATIVE ONLY AND
- WILL ALTER DEPENDING ON SHOWER BASE CONSTRUCTION METHOD

## Certificate No.: 1225207S Date of Issue: 21.07.2021

## WATER COMMITMENTS

### FIXTURES

- 3 STAR RATED SHOWERHEADS >7.5 BUT <9L/MIN.
- **3 STAR** RATED TOILET FLUSHING SYSTEMS **3 STAR** RATED KITCHEN TAPS
- **3 STAR** RATED BASIN TAPS
- ALTERNATIVE WATER
- PROVIDE A RAINWATER TANK OF AT LEAST **3000L**
- TANK MUST BE CONFIGURED TO COLLECT RAIN
- RUNOFF FROM THE 161.71 SQM OF THE ROOF AREA. TANK MUST BE CONNECTED TO;
- ALL TOILETS •• WASHING MACHINE COLD WATER TAP
- •• AT LEAST ONE OUTDOOR TAP

#### ENERGY COMMITMENTS

HOT WATER

• 6 STAR RATED ELECTRIC HEAT PUMP WITH A PERFORMANCE OF 26 TO 30STCs OR BETTER.

### COOLING SYSTEM

- 1-PHASE AIR COND. TO AT LEAST 1 LIVING AREA WITH A MIN. ENERGY RATING OF EER 2.5-3.0
- 1-PHASE AIR COND. TO AT LEAST 1 BEDROOM AREA WITH A MIN. ENERGY RATING OF EER 2.5-3.0
- SYSTEM MUST PROVIDE FOR DAY/NIGHT ZONING BETWEEN LIVING AREAS AND BEDROOMS

### HEATING SYSTEM

- 1-PHASE AIR COND. TO AT LEAST 1 LIVING AREA WITH A MIN. ENERGY RATING OF EER 2.5-3.0
- 1-PHASE AIR COND. TO AT LEAST 1 BEDROOM AREA WITH A MIN. ENERGY RATING OF EER 2.5-3.0 SYSTEM MUST PROVIDE FOR DAY/NIGHT ZONING
- BETWEEN LIVING AREAS AND BEDROOMS

## VENTILATION

- PROVIDE EXTERNALLY DUCTED EXHAUST FANS TO:
- •• AT LEAST 1 BATHROOM •• THE KITCHEN
- •• THE LAUNDRY

#### NATURAL LIGHTING

- PROVIDE A WINDOW/SKYLIGHT IN THE KITCHEN OF THE DWELLING FOR NATURAL LIGHTING
- PROVIDE A WINDOW/SKYLIGHT IN AT LEAST 3 BATHROOMS/TOILET FOR NATURAL LIGHTING

#### ALTERNATIVE ENERGY

INSTALL A PHOTOVOLTAIC SYSTEM WITH THE CAPACITY TO GENERATE ATLEAST 1 PEAK KILOWATTS OF **FI FCTRICITY** 

#### **OTHER COMMITMENTS**

- INSTALL A GAS COOKTOP & ELECTRIC OVEN
- PROVIDE A WELL VENTILATED FRIDGE SPACE
- PROVIDE A FIXED OUTDOOR CLOTHESLINE



#### PROVIDE AIR-CONDITIONING DUCTS AND OUTLETS FOR AIR-CONDITIONING BY METRICON








OR RENDERED LIGHTWEIGHT SUBSTRATE CLADDING ABOVE LOWER ROOFS WHERE APPLICABLE


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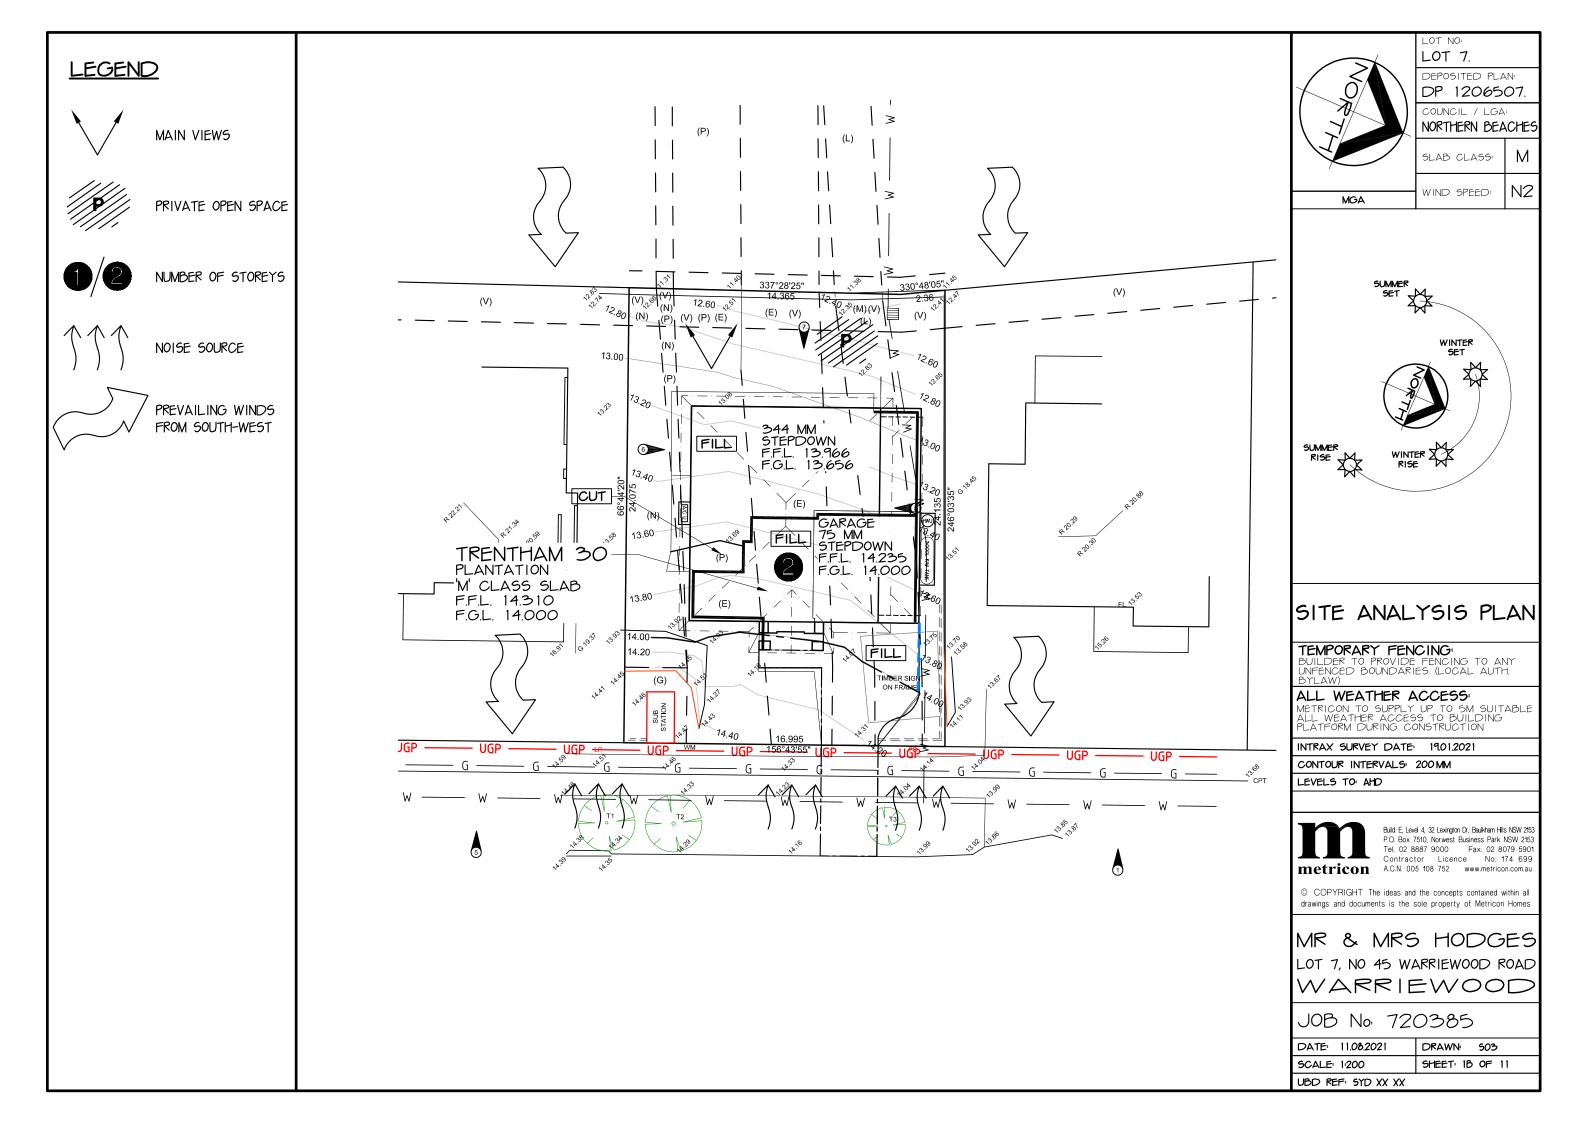
TABLE OF REVISIONS				
REV.	DATE	REVISION DESCRIPTION	DRAWN	CHECKED
A	17.02.2021	PRELIMINARY CONTRACT PLANS	CMB	
В	07.05.21	PRELIMINARY CONTRACT VARIATION	JF9	XX
C	19.07.21	VARIATION OO1	OSA	
D	06.08.21	VARIATION OO2	A90	XX
E	11.08.21	LODGEMENT PLANS	503	
F	10.09.21	VARIATION 003	NA4	
G	DD.MM.YY	DESCRIPTION	XX	XX
н	DD.MM.YY	DESCRIPTION	XX	XX
	DD.MM.YY	DESCRIPTION	XX	XX
J	DD.MM.YY	DESCRIPTION	XX	XX


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COVER CHEET	BY METRICON	JOB No: 720385	DATE:	17.02.2021
COVER SHEET	Build. E, Level 4, 32 Lexington Dr, Baulkham Hills NSW 2153 P.O. Box 7510, Norwest Business Park NSW 2153	FC DATE: <b>DD.MM.YYYY</b>	MST VE	R: <b>16.02.2017</b>
METRICON HOMES OWNS COPYRIGHT IN THIS DRAWING UNAUTHORISED USE, REPRODUCTION OR ADAPTATION	Tel: 02 8887 9000 Fax: 02 8079 5901 Contractor Licence No: 174 699 A.C.N. 005 108 752	SCALE:	-	REVISION: F
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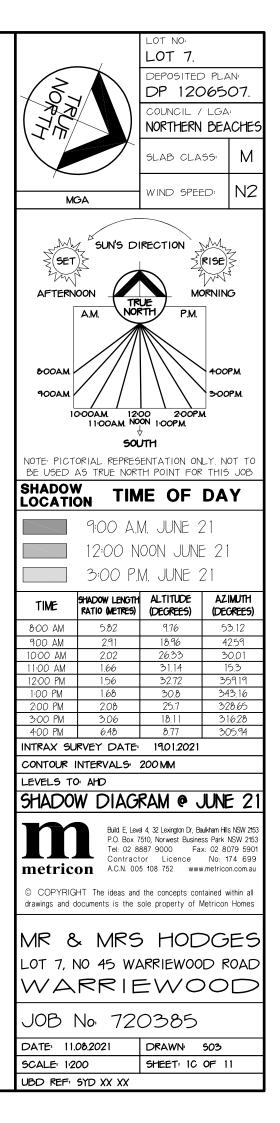
SITE AREA:	404.4 SQM	
PROPOSED ROOF COVERA	GE 161.71 SQM	
TOTAL COVERAGE AREA	161.71 SQM	
PRIVATE OPEN SPACE		
PRIVATE OPEN SPACE	80 SQM	
MIN. REQUIRED BY COUNCIL. MINIMUM DIMENSION OF 3M	80 SQM	
PRINCIPAL PRIVATE OPEN	SPACE	
PRINCIPAL PRIVATE OPEN SPAC	E: 24 SQM	
MIN. REQUIRED BY COUNCIL. MINIMUM DIMENSIONS OF 4M X 4M	24 SQM	
LANDSCAPED AREA		
TOTAL LANDSCAPED AREA: EXCL ALL HARD SURFACES.	189.49 SQM	
EXCL. ALL HARD SURFACES, MINIMUM DIMENSION OF 2M	46.85 %	
MIN. REQUIRED BY COUNCIL'	45 %	
FRONT YARD LANDSCAF	ED ARFA	
TOTAL FRONT YARD AREA		
LANDSCAPED FRONT YARD ARE	A: 72.00 SQM	
LANDSCAPED FRONT YARD ARE	<u>-</u> Α; 65.32 %	
MIN. REQUIRED BY COUNCIL <sup>1</sup>	60 %	
STORMWATER CALCULA	TION	
HARD LANDSCAPE AREAS: (INCL. ROOF/DRIVEWAY/PATHS E	TC)	
SITE COVERAGE RATIO	47.50 %	
MAXIMUM ALLOWABLE BY COUN PRIOR TO 0.5.D. BEING REQUIRED (EXISTING SITE COVERAGE + 50	> 0%	
BUILDING HEIGHT RESTR MAXIMUM 8.5M RIDGE HEIGHT		
(F.F.L. MUST BE ACCURATE TO C	COMPLY)	
BUILDING ENVELOPE PROVIDE 45 DEGREE PLANE PROJECTED AT 4,5M HIGH ABOV BOUNDARY NATURAL GROUND LE	E SIDE	
MAXIMUM 1000 MM ( MAXIMUM 1000 MM F		
SURVEYORS NOTES		
A. THIS SURVEY IS SPECIFICALLY FOR CO PURPOSES ONLY. THE BOUNDARIES OF PROPERTY HAVE NOT BEEN INVESTIGATI POSITION SHOWN IS APPROXIMATE ONLY	THE SUBJECT ED AND THE	(E)
B. AREAS AND DIMENSIONS ARE SUBJECT	TO SURVEY.	(G)
C. SERVICES SHOWN HAVE BEEN DERIVED EVIDENCE APPARENT AT THE TIME OF RELEVANT SERVICE AUTHORITY SHALL TO VERIFY THE EXISTENCE AND POSITI SERVICES PRIOR TO THE COMMENCEMEN CONSTRUCTION OR EXCAVATION.	SURVEY. THE BE CONTACTED ION OF ALL	(L) (M) (N) (P)
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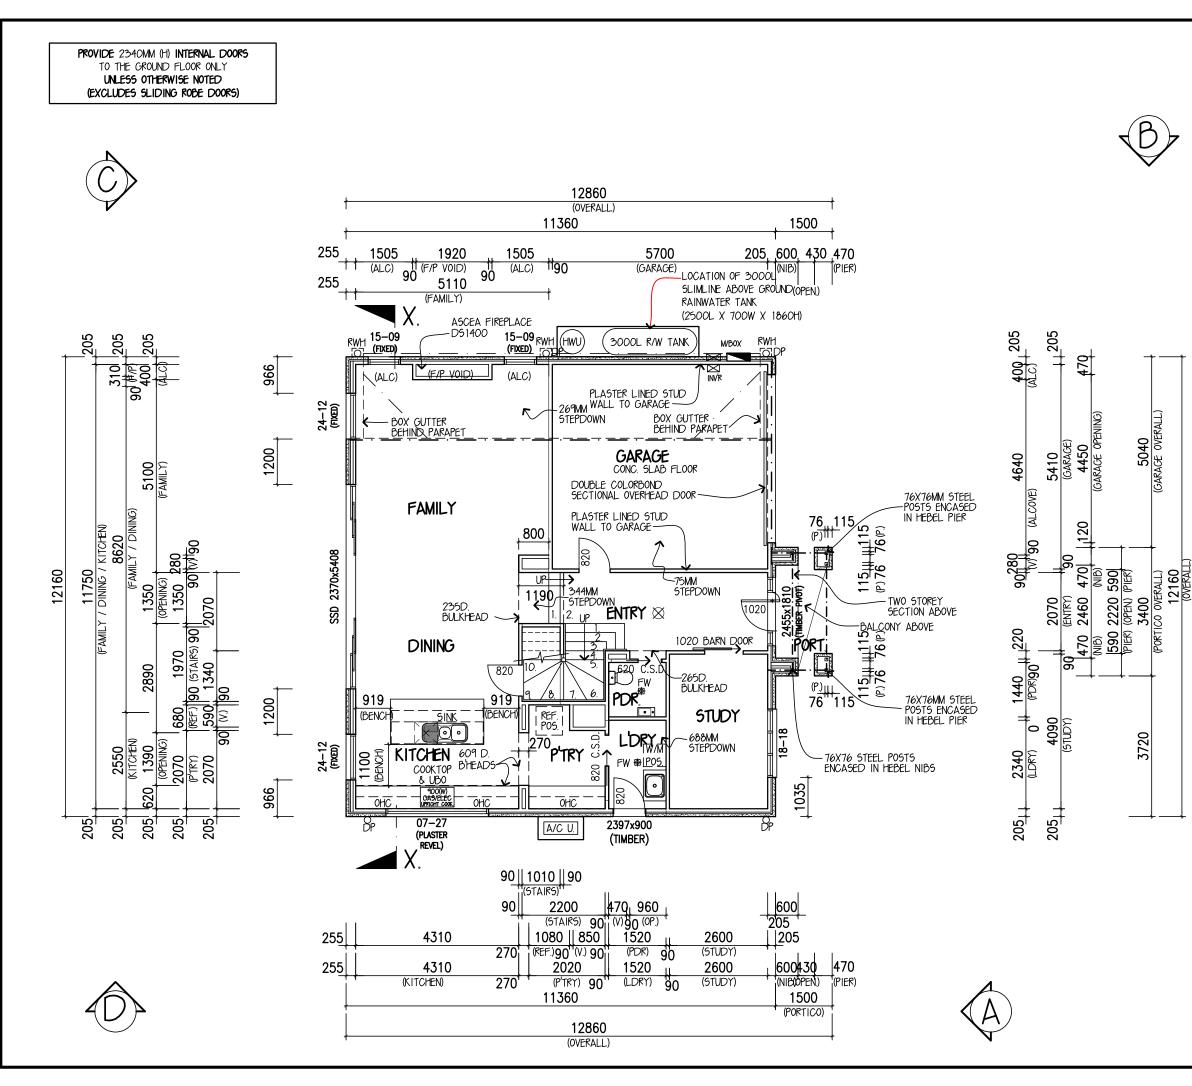







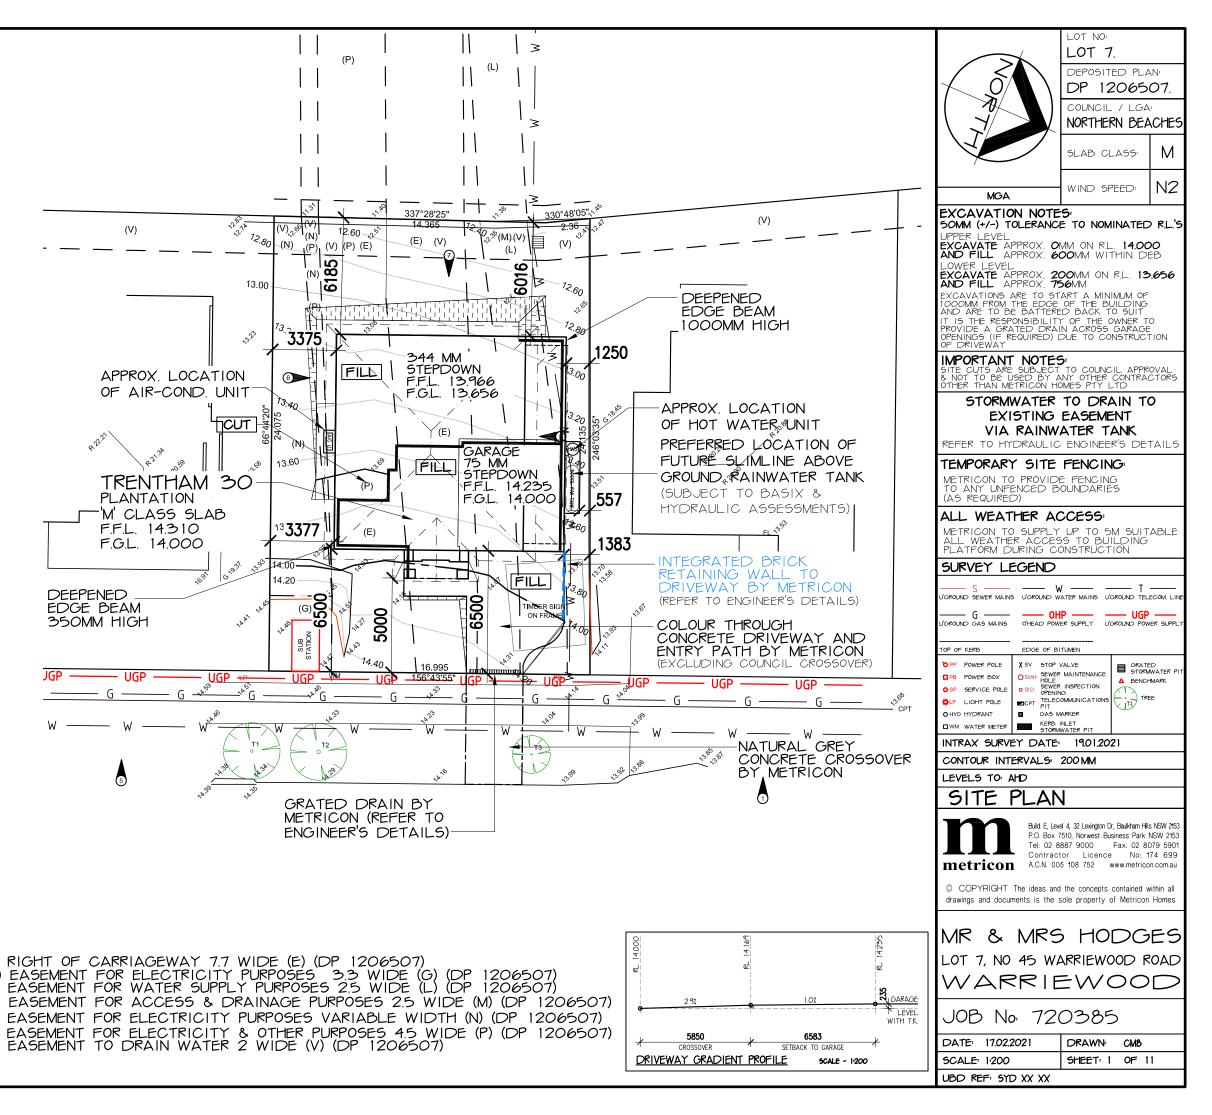

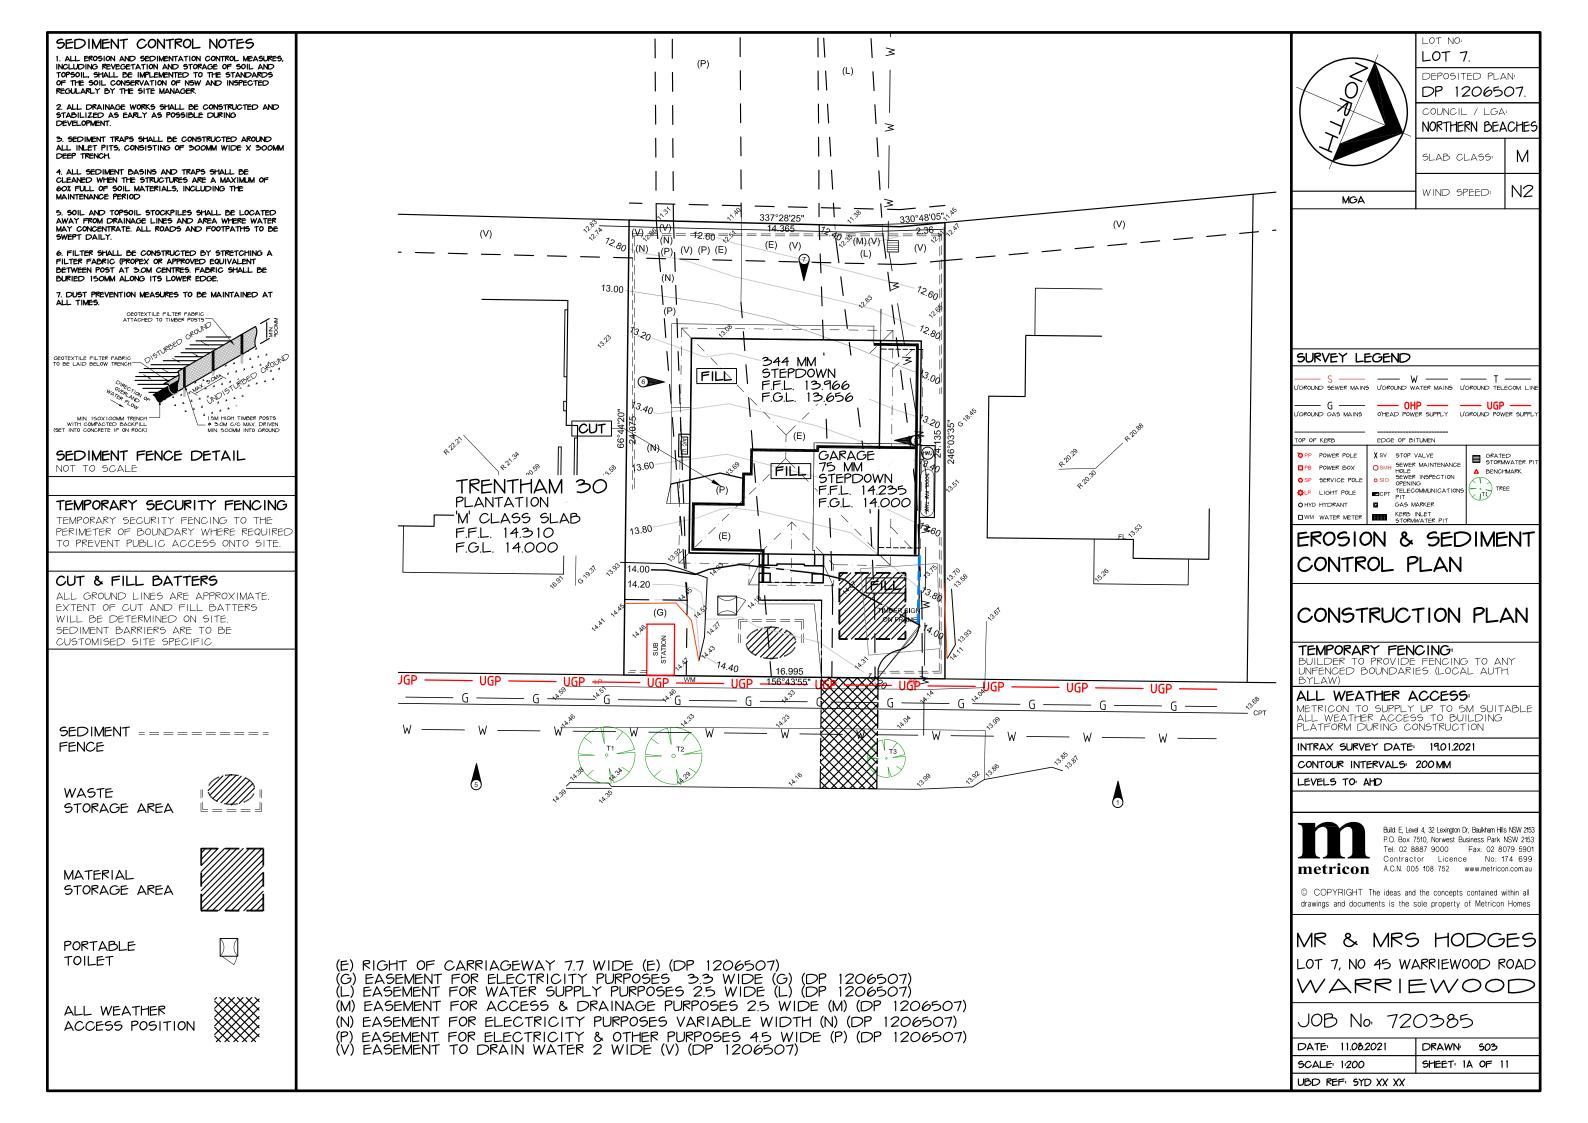

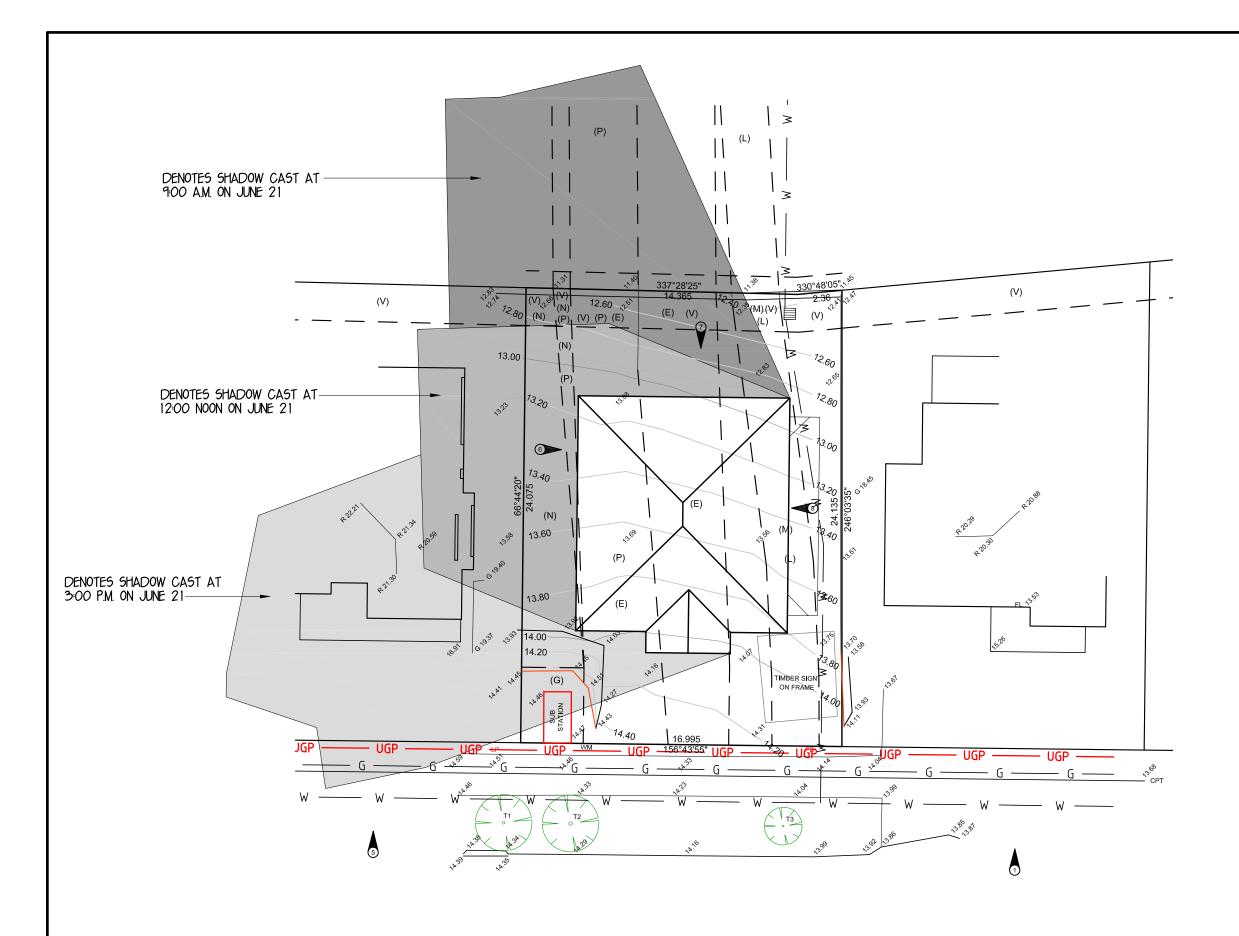

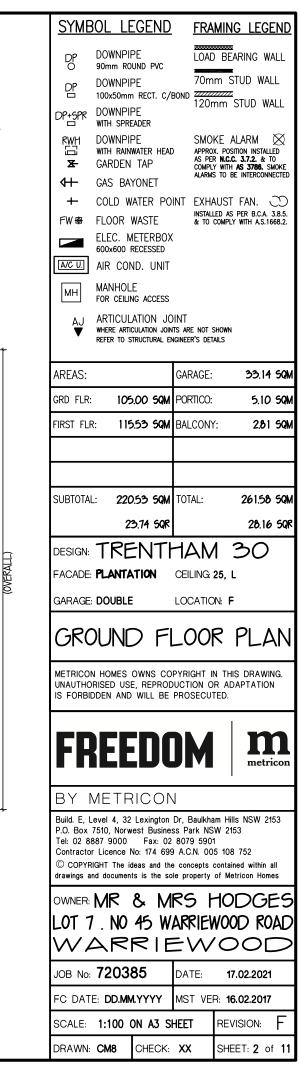


12860 (OVERALL) 11360 600, 900 (BALCONY) 115 3020 3470 500 970 2040 ,90 **500** 90 (R.) (W.C.) (90 (DATH) 90 (R.) 90 970 2040 90 100 (R.) 90 970 2040 90 100 (R.) 10 (BED 2) 115 (BED 3) \_\_\_\_\_115 \_\_\_\_\_90∭\_\_\_\_15 90 115||| 115||| 4060 3610 <u>115</u> 90 (BED 2) (BED 3) 115||| 115||| 7490 4060 90 (BED 1) 205 205 <u>180</u> 3150 3150 0 1510 40090 901 (KODE901[[V]][[115 1650 90 1650 90 <u>1</u>15  $\square$ 10<sub>†</sub>0<del>6</del> | **12–1**5| DP+SPR 06,()) 260 **6** 6 -NOTE: RAKE EAVE TO THIS SECTION ONLY 1560 BATH - 2330MM (H) FRAMED MIRRORED ROBE SLIDING DØØRS 2330MM (H) FRAMED MIRRORED ROBE SLIDING DOORS 1560 H WC. 3150 3150 (BED 3) 3000 3000 15-18 BATH FW B 12–18 췅 8<u>8, 1</u>15 BEQ 2 BED 3 || 1010 || 90 90 1060 90 90<sup>11,12</sup>05 120115 1111 88 88 (P) (P) 445 670 <u>901</u> 2650 -APPROX. LOCATION OF (MAX. 14) ELEC. SOLAR PANELS 양 윩 90 3400 (DALCONY OVERALL) 10120 (OVERALL) 465 10120 (OVERALL) 2,230 90 4090 115115901001110 500 4090 115111500 960 2390 90 90 115111 (ENSUTE) 0 (W.C) 190 (ALCOVE) 1570 9 115111 (ENSUTE) 0 (W.C) 190 (ALCOVE) 1570 9 115111 (ENSUTE) 1 (W) 90 (STAIR VOID) 1570 9 100 220 90 (STAIR VOID) 1570 9 820 2107X1450 570 -1020MM (H) **TIMBER** BALUSTRADE 3230 (LEISURE) 2750 (LEISURE) IOOOMM HIGH -DALUSTRADES 2750 6 DN 3960 Ľ £ мн 115,120 88 88 (P) (P) Ã. BED 1 10 90<sup>\*</sup> 205 | | 2065MM(H) ROBE 205 = W.C. 88 |||1 (P.) LINEN ŔOBE 18 BED 4 3720 265D. BULKHEAD-W.I.R. 15, -PLASTER LINED \_CEILING ENSUITE -2330MM (H), FRAMED MIRRORED ROBE SLIDING DOORS 1340 (RODE)o FW 🖶 RODE 1035  $\odot$  $\odot$ ROBE 115||| 90 115||| 90 DP 15-06 DF X. 600 430 470 205'(OPEN) (PIER) 1115 115||| 3970 90 180<sup>(DED 1)</sup> 115||| 900 || 250 90<sup>(OPEN)+</sup> (W.I.F 3970 390 2200 4300 90 (STAIR VOID) 1690 1740 560 1090 1 (V) 90 (W.C.) 90 (V)90(LINEN) 90 (LEISURE) 2500 3040 90 600 900 90 115 (BALC) 1500 (W.I.R.) (BED 4) 90 |500| 90<sup>11</sup> (R.) 190 115 3580 3380 3040 270 <sup>11</sup>90 (W.I.R.) (ENSUITE) (BED 4) 11360 12860


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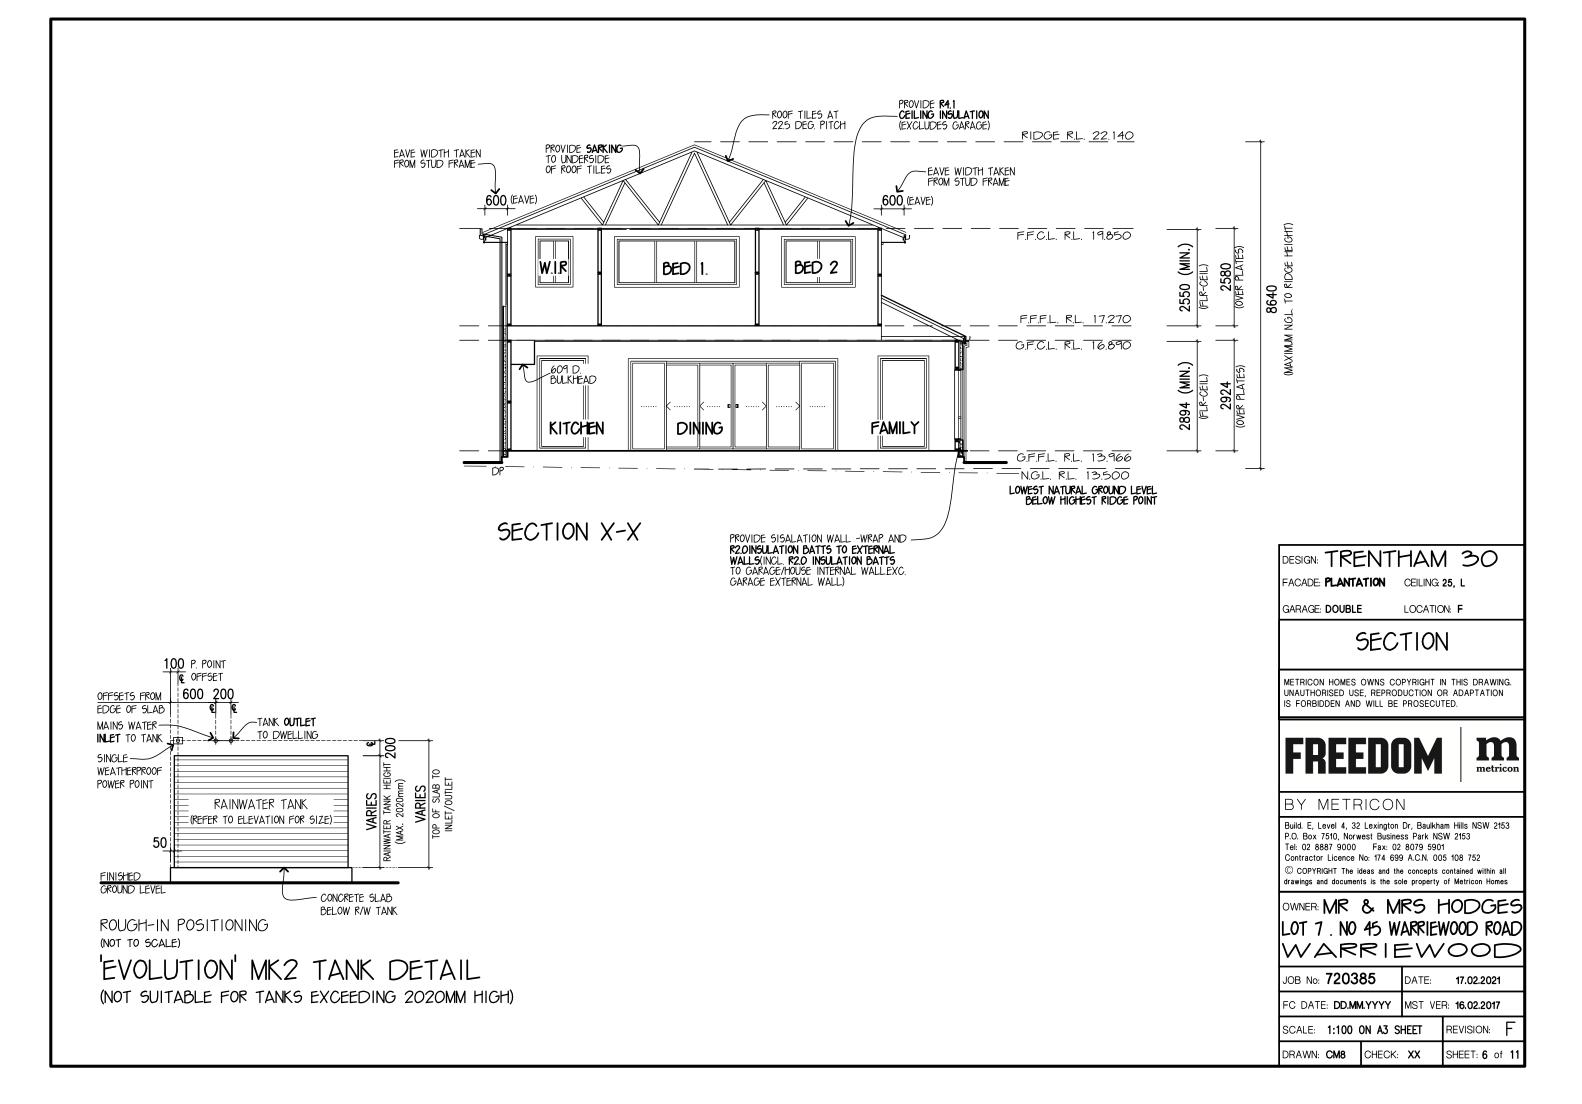
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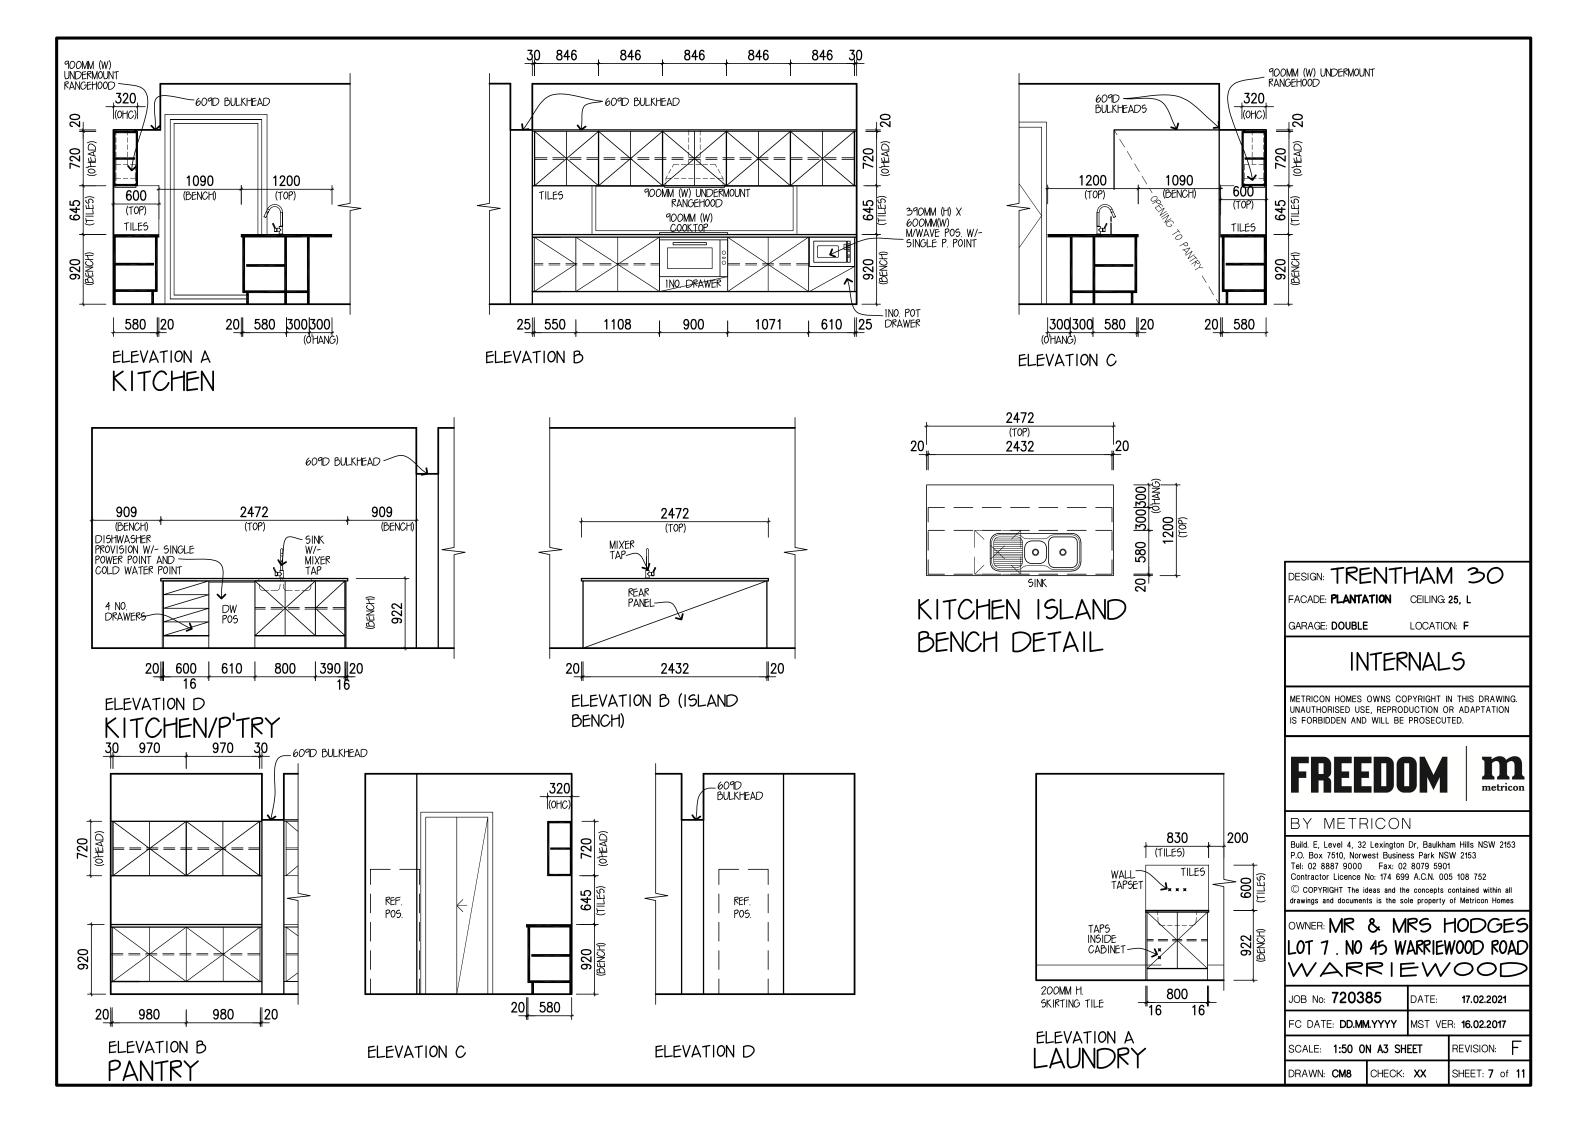
	<u>)</u> <u>Framing legen</u>	D
DP DOWNPIPE O 90mm ROUND PVC	LOAD BEARING WALL	
DP DOWNPIPE	70mm STUD WALL	
DP+SPR DOWNPIPE	/bond 120mm STUD WALL	
	SMOKE ALARM 💢	
WITH RAINWATER HEA SE GARDEN TAP		
<pre>4+ GAS BAYONET + COLD WATER PO</pre>	DINT EXHAUST FAN. 📿	)
FW 🖶 FLOOR WASTE	INSTALLED AS PER B.C.A. 3.8.5 & TO COMPLY WITH A.S.1668.2	
ELEC. METERBO	X	
AIR COND. UNIT	Г	
MH MANHOLE FOR CEILING ACCESS	3	
AJ WHERE ARTICULATION JU WHERE ARTICULATION JO REFER TO STRUCTURAL E	INTS ARE NOT SHOWN	
AREAS:	GARAGE: <b>38.94 50</b>	м
GRD FLR: 118.01 5QN	PORTICO: 7.49 50	М
FIRST FLR: 120.78 59	OUTDOOR: 0.00 50	М
SUBTOTAL: 238.79 59	TOTAL: 285.22 50	M
25.70 SQR		
23.10 54	30.70 50	Ж
DESIGN: TRENT		×
		*
DESIGN: TRENT	НАМ 30	×
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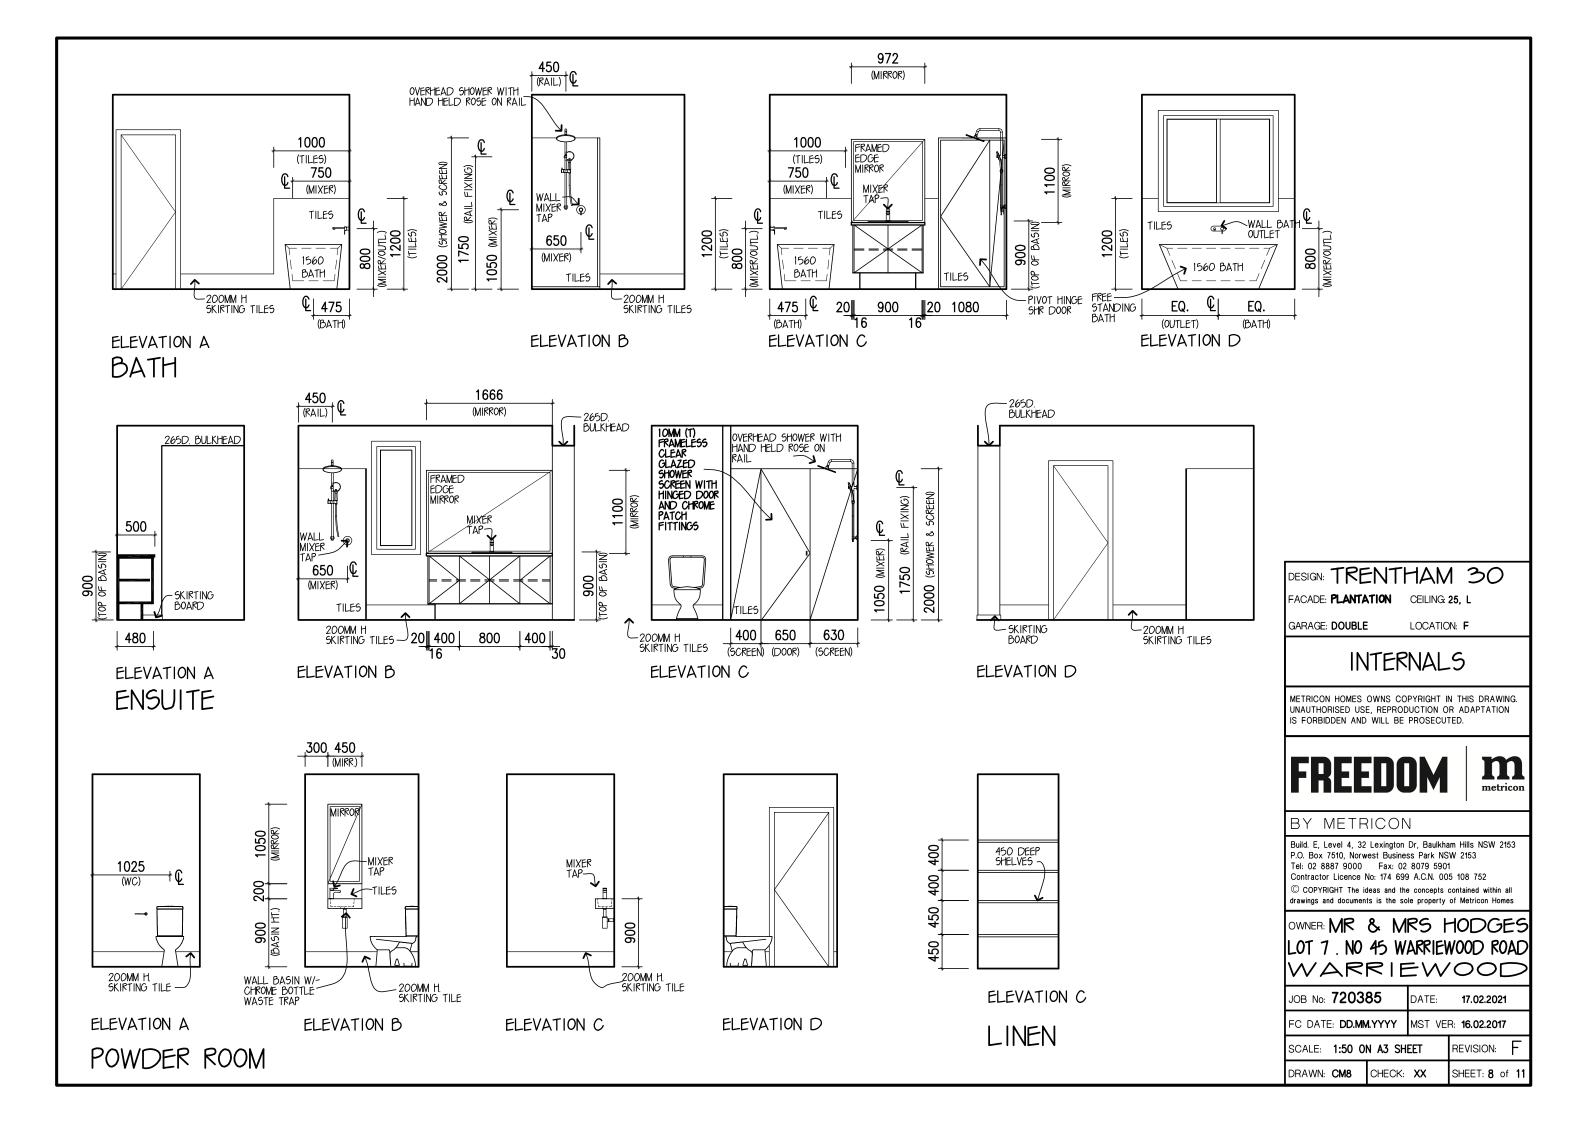



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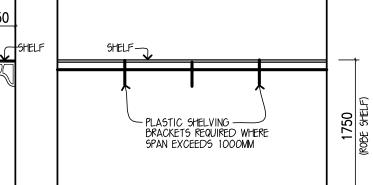





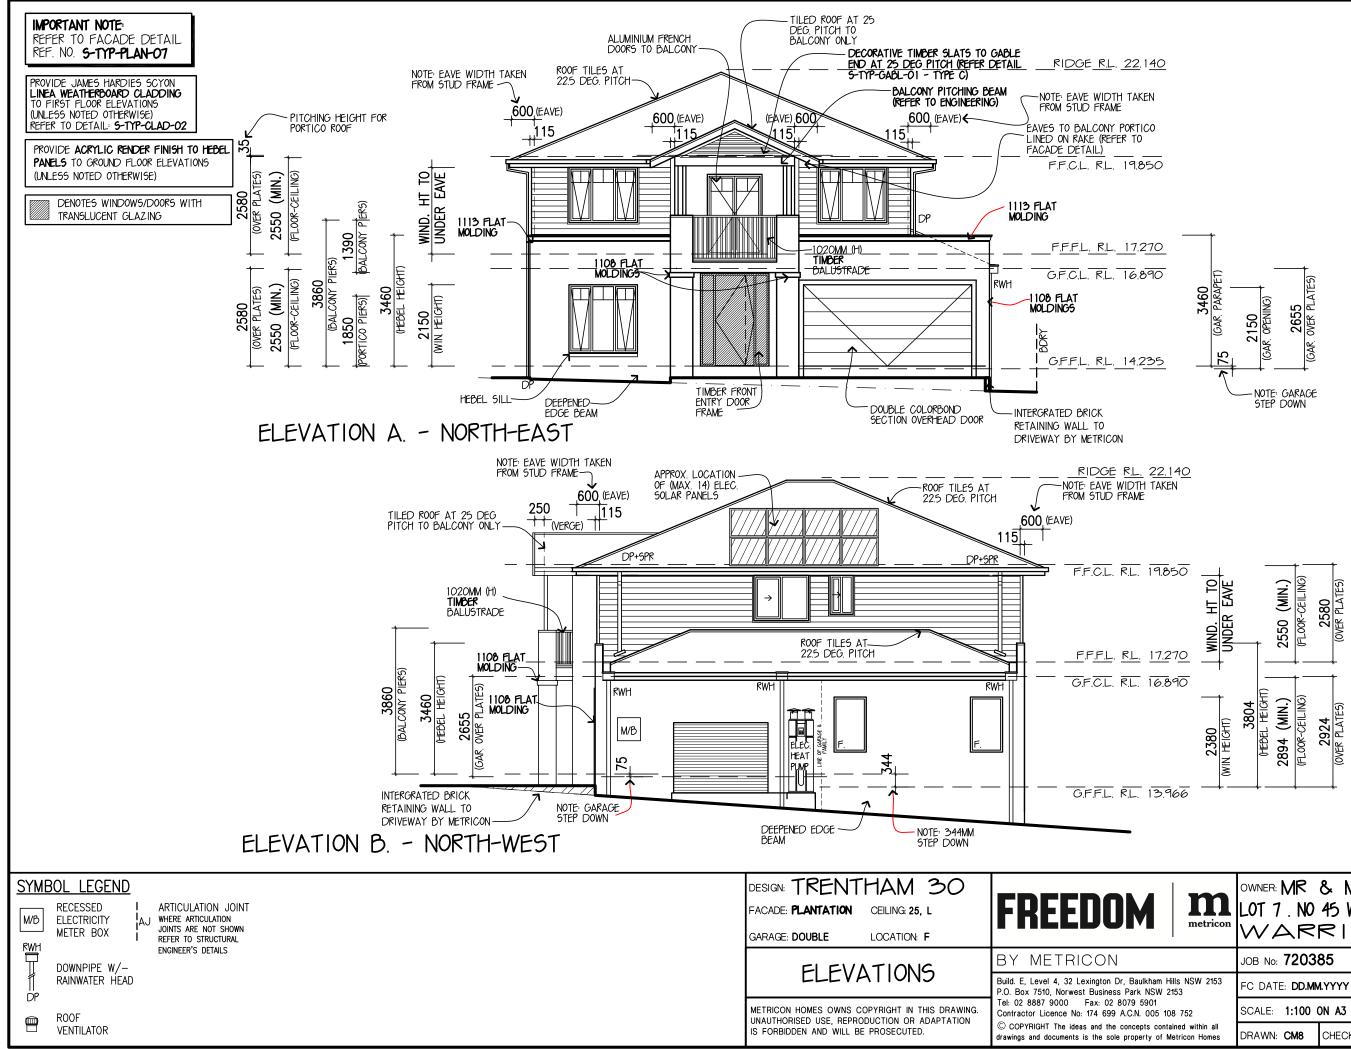




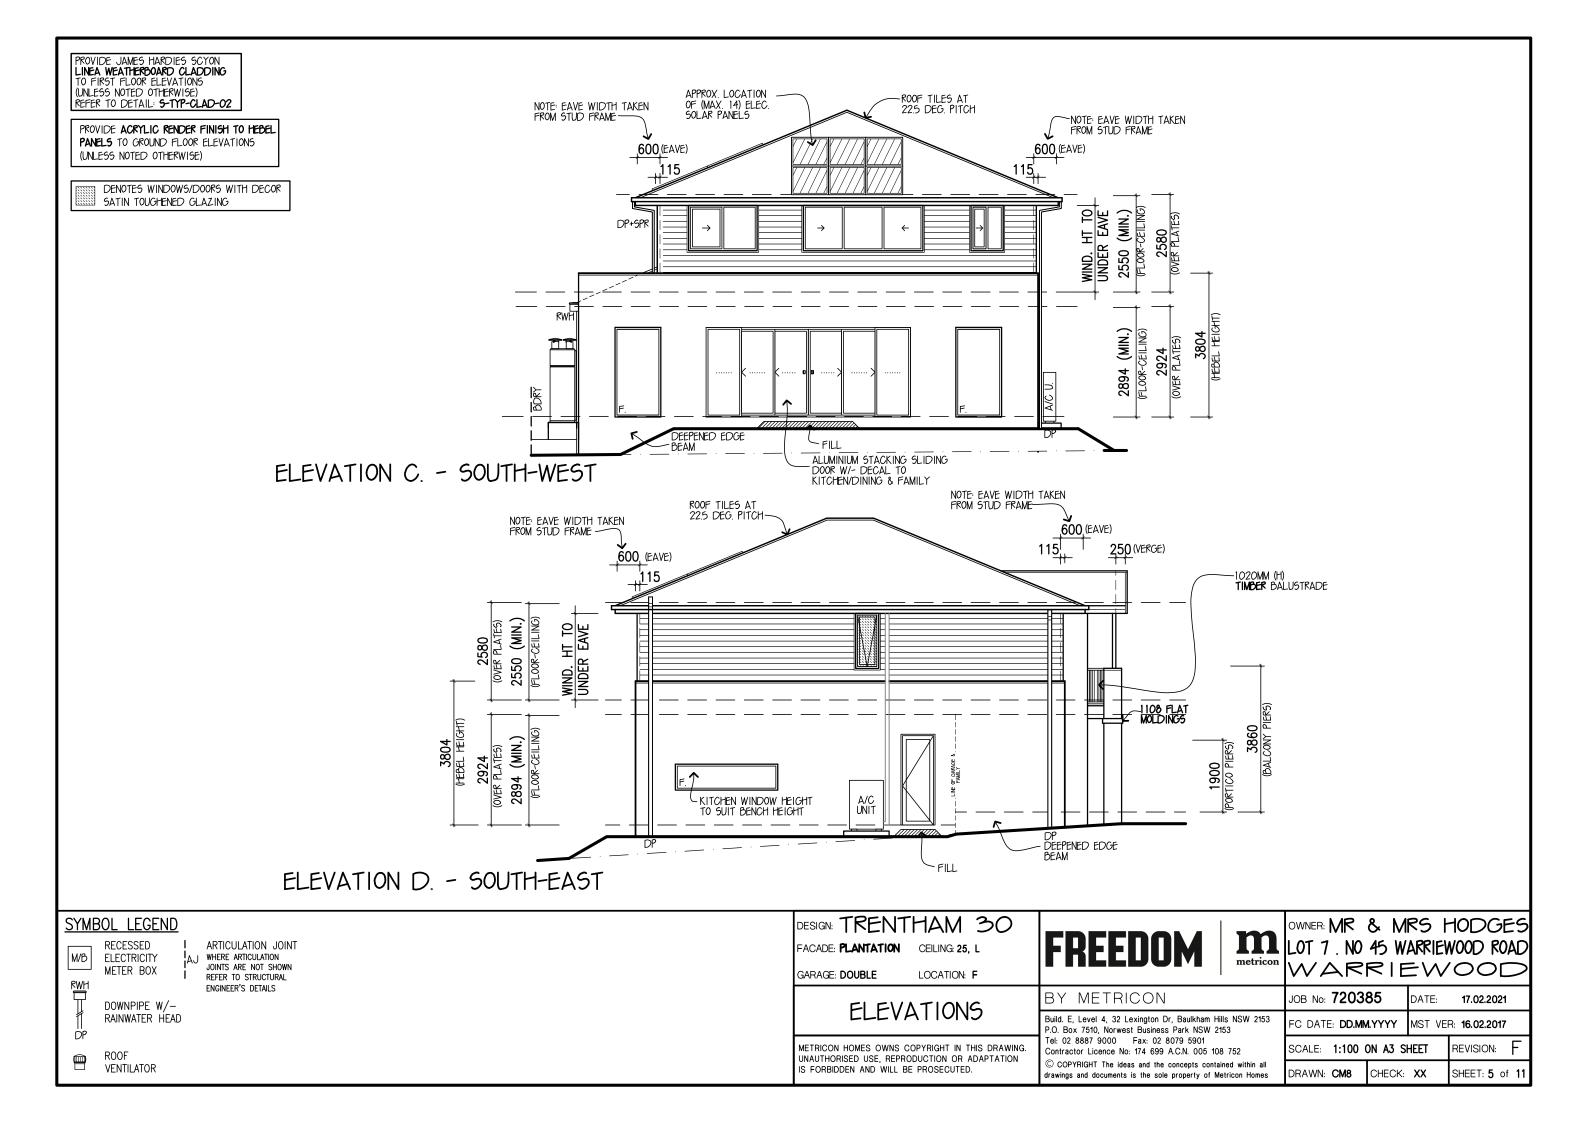

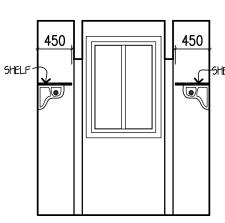

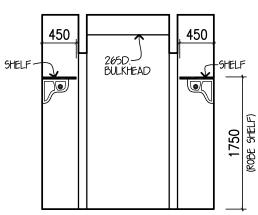

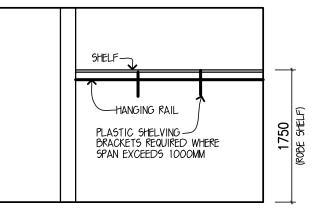



ELEVATION A

ELEVATION B

ELEVATION C


ELEVATION D

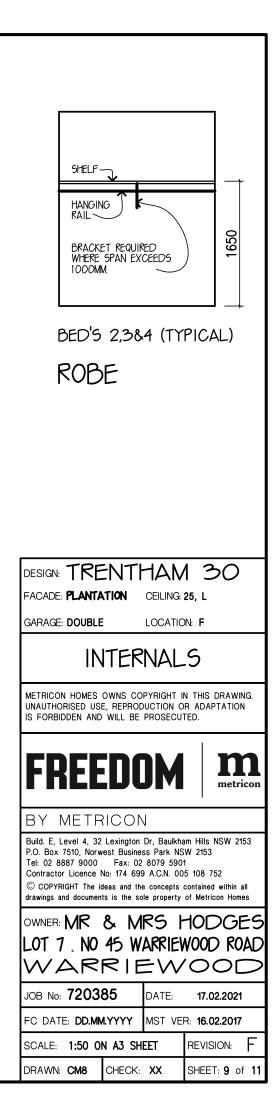

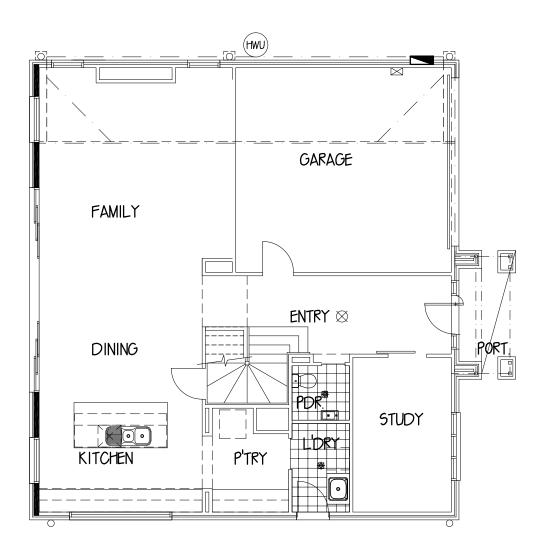

FLOOR COVERINGS LEGEND	TIMBER FLOOR AREAS TOTAL AREA: <b>**** SQM</b>	DESIGN: TRENTHAM 30 FACADE: PLANTATION CEILING: 25, L GARAGE: DOUBLE LOCATION: F	FREEDOM
		GROUND FLOOR	BY METRICON
CARPET FLOOR AREAS TOTAL AREA: <b>**** SQM</b>	TILED FLOOR AREAS TOTAL AREA: <b>**** SQM</b>	FLOOR COVERINGS	Build. E, Level 4, 32 Lexington Dr, Baulkha P.O. Box 7510, Norwest Business Park NS
		METRICON HOMES OWNS COPYRIGHT IN THIS DRAWING. UNAUTHORISED USE, REPRODUCTION OR ADAPTATION IS FORBIDDEN AND WILL BE PROSECUTED.	Tel: 02 8887 9000 Fax: 02 8079 5901 Contractor Licence No: 174 699 A.C.N. 009 © COPYRIGHT The ideas and the concepts of drawings and documents is the sole property

metricon	owner:MR LOT 7 . № WAR	& M 45 W R I E	RS H ARRIEV EVV	10DGES VOOD ROAD '00D
	JOB No: 7203	85	DATE:	17.02.2021
ham Hills NSW 2153 ISW 2153	FC DATE: DD.MN	I.YYYY	MST VE	R: <b>16.02.2017</b>
01 005 108 752	SCALE: 1:100 (	ON A3 SI	HEET	REVISION: F
s contained within all y of Metricon Homes	DRAWN: CM8	CHECK:	xx	SHEET:10 of 11

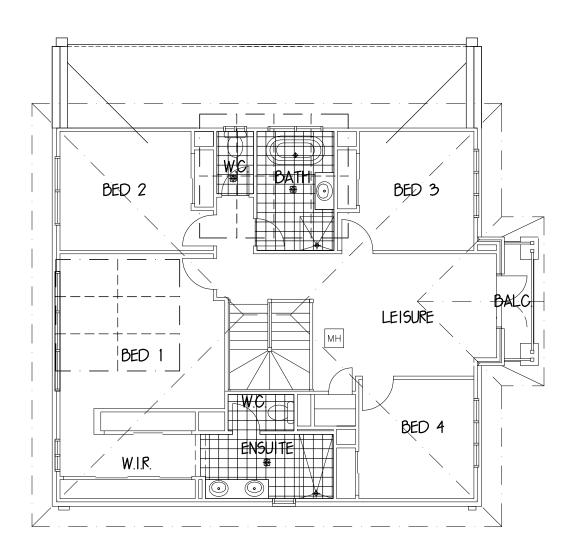

#### DESIGN: TRENTHAM 30 FREEDOM FACADE: **PLANTATION** CEILING: 25, L WET AREA FLOOR TILING TIMBER FLOOR AREAS GARAGE: DOUBLE LOCATION: F TOTAL AREA: 14.4 SQM TOTAL AREA: \*\*\*\* SQM FIRST FLOOR BY METRICON FLOOR COVERINGS Build. E, Level 4, 32 Lexington Dr, Baulkha CARPET FLOOR AREAS TILED FLOOR AREAS P.O. Box 7510, Norwest Business Park NS TOTAL AREA: \*\*\*\* SQM TOTAL AREA: \*\*\*\* SQM Tel: 02 8887 9000 Fax: 02 8079 590 METRICON HOMES OWNS COPYRIGHT IN THIS DRAWING. Contractor Licence No: 174 699 A.C.N. 00 UNAUTHORISED USE, REPRODUCTION OR ADAPTATION © COPYRIGHT The ideas and the concepts IS FORBIDDEN AND WILL BE PROSECUTED. drawings and documents is the sole property

## FLOOR COVERINGS LEGEND

metricon	owner:MR LOT 7 . № WAR	& M 45 W R I E	RS H ARRIEV = VV	10DGES VOOD ROAD '00D
	JOB No: 7203	85	DATE:	17.02.2021
ham Hills NSW 2153 ISW 2153	FC DATE: DD.MN	I.YYYY	MST VE	R: <b>16.02.2017</b>
01 005 108 752	SCALE: 1:100 (	ON A3 SI	HEET	REVISION: F
s contained within all y of Metricon Homes	DRAWN: CM8	CHECK:	xx	SHEET: 11 of 11

#### GENERAL DRAINAGE NOTES

- THE CONTRACTOR SHALL ADEQUATELY DRAIN THE SITE DURING ALL STAGES OF CONSTRUCTION
- CONTRACTOR SHALL VERIFY ALL LEVELS DIMENSIONS AND SERVICES PRIOR TO COMMENCEMENT OF WORK.
- ALL APPROPRIATE PERMITS SHALL BE OBTAINED AND FEES PAID FOR BY THE CONTRACTOR
- ANY PAVEMENT OR FEATURES DAMAGED DURING THE COURSE OF THIS CONTRACT SHALL BE REINSTATED TO THEIR FORMER CONDITION
- THE CONTRACTOR SHALL ARRANGE A SITE INSPECTION WITH THE CIVIL ENGINEERING SUPERVISING OFFICER PRIOR TO THE COMMENCEMENT OF WORK TO RECORD ANY DAMAGE TO EXISTING FEATURES.
- ALL EXISTING PIT COVERS, DOWNPIPE CONNECTIONS AND SIMILAR FEATURES IN CONSTRUCTION AREAS ARE TO BE ADJUSTED TO SUIT AS PART OF THIS CONTRACT
- ALL CONCRETE PAVEMENT SHALL BE FINISHED WITH A NON SKID FLOAT, (NO BROOMED FINISH)
- BEFORE COMMENCEMENT OF WORK A TEMPORARY BENCH MARK IS TO BE ESTABLISHED BY THE CONTRACTOR IN A POSITION ON SITE SAFE FROM DISTURBANCE
- ALL FILLING SHALL BE UNIFORMITY PLACED IN LAYERS NOT EXCEEDING 200mm LOOSE MEASUREMENT. EACH LAYER SHALL BE WITHIN 85% TO 115% OF OPTIMUM MOISTURE CONTENT AND BE PROPERLY COMPACTED, AS SPECIFIED, BASED ON THE STANDARD COMPACTION TEST AS OUTLINED IN AS 1289-1977.
- 10 CRUSHED ROCK PAVEMENT COMPACTIONS SHALL BE TO 100% STANDARD MAXIMUM 5. DRY DENSITY FOR BASE COARSE, AND 98% FOR SUB BASE COARSE.
- ANY SHORTFALL IN INDIGENOUS TOPSOIL REQUIRED TO BRING THE GARDEN AND GRASSED AREAS TO THE DESIGN LEVELS SHALL BE MADE UP WITH APPROVED IMPORTED TOPSOIL. NO ADDITIONAL PAYMENT WILL BE MADE FOR IMPORTED
- 12. EXCAVATED MATERIAL SHALL BE STOCKPILED ON SITE AS DIRECTED BY THE SUPERINTENDENT. EXCESS TO BE REMOVED FROM SITE AT CONTRACTORS EXPENSE
- 13 TOPSOIL TO BE STRIPPED TO A DEPTH OF 150mm UNDER FILL AREAS AND ALL OTHER AREAS. THIS TOPSOIL SHALL BE STOCKPILED ON SITE AS DIRECTED BY SUPERINTENDENT . EXCESS SOIL TO BE STOCKPILED ON SITE AS DIRECTED BY THE SUPERINTENDENT, OR REMOVED FROM THE SITE AT THE CONTRACTORS EXPENSE, IF SO DIRECTED
- ALL STORMWATER DRAINS SHALL BE BEDDED ON A MINIMUM OF 80mm COMPACTED 14 THICKNESS 20 N.S. CLASS 3 FINE CRUSHED ROCK, IN SOIL BASED TRENCHES . INCREASE TO 200mm THICKNESS IN ROCK BASED TRENCHES
- 15 100mm DIAMETER STORMWATER DRAINS SHALL BE LAID AT A MINIMUM GRADE OF 1:100 UNLESS OTHERWISE SHOWN.
- 150mm DIAMETER STORMWATER DRAINS SHALL BE LAID AT A MINIMUM GRADE OF 16 1:100. UNLESS OTHERWISE SHOWN.
- TRENCH EXCAVATIONS; WHERE ONE OR BOTH SIDES OF ANY TRENCH EXCEED 1.5 M 17 IN DEPTH, THE CONTRACTOR SHALL ENSURE THAT THE PROVISIONS OF MINES ACT 1958 AND THE MINES (TRENCHES) REGULATIONS 1979 ARE COMPLIED WITH.
- TRENCHES TRAVERSING EXISTING OR PROPOSED PAVEMENTS INCLUDING ASPHALT AND CONCRETE SHALL BE BACKFILLED WITH "FIRST CLASS MATERIAL" AND COMPACTED, PAVEMENT SHALL BE REINSTATED TO THE SATISFACTION OF THE SUPERINTENDENT.
- ALL SURPLUS EXCAVATED MATERIAL SHALL BE REMOVED FROM SITE.
- FOOTPATHS, DRIVEWAYS, ROADWAYS, KERBS, R.O.W.'S OR EXISTING FEATURES 20. DISTURBED, BROKEN OR AFFECTED BY THE WORKS ARE TO BE REINSTATED TO THE COMPLETE SATISFACTION OF THE CITY ENGINEER OR HIS REPRESENTATIVE.
- ALL CONCRETE TO BE SAW CUT AND BROKEN OUT TO THE NEAREST JOINT. 22. ALL NATURE STRIPS AND LAWN AREAS OUTSIDE PRIVATE PROPERTY TO BE
- REINSTATED WITH TOP SOIL AND SEEDED. 23. CONTRACTOR TO CONTACT LOCAL COUNCIL ENGINEERING DEPARTMENT AT LEAST
- 48 HOURS PRIOR TO THE COMMENCEMENT OF CONSTRUCTION OF OUTFALL DRAINAGE TO ARRANGE FOR COUNCIL SUPERVISION AND INSPECTION IF REQUIRED BY COUNCIL
- 24. THE CONTRACTOR IS TO VERIFY ALL LOCATIONS AND DEPTH OF SERVICES WITH THE RELEVANT AUTHORITIES FOR THE CONSTRUCTION OF DRAINS AND SERVICES OUTSIDE THE PROPERTY BOUNDARY PRIOR TO THE COMMENCEMENT OF WORK AND SHALL BE FULLY RESPONSIBLE FOR RECTIFICATION OF ANY DAMAGED SERVICE
- 25. ALL EXCESS TOPSOIL SHALL BE REMOVED OFF SITE AT THE CONTRACTOR'S EXPENSE.
- 26. ALL ADDITIONAL FILL MATERIAL REQUIRED DUE TO OVER EXCAVATION OR A SHORTFALL OF SUITABLE EXCAVATED MATERIAL SHALL BE IMPORTED AT THE CONTRACTORS EXPENSE.
- AT THE TIME OF THE PREPARATION OF THE DRAINAGE DESIGN, IF THE LANDSCAPING DESIGN WAS NOT SUPPLIED TO THIS OFFICE, THEN THE DRAINAGE SYSTEM MAY BE SUBJECT TO CHANGE. THIS OFFICE OR A QUALIFIED PRACTITIONER SHALL REVIEW THE DRAINAGE DESIGN WHEN LANDSCAPING DESIGN IS FINALISED.

#### DRAINAGE NOTES:

- ALL SURFACE DRAINAGE WORKS SHALL BE INSTALLED IN ACCORDANCE WITH CLAUSE 5.6.3 DRAINAGE REQUIREMENTS OF AS 2870-2011, WHEREIN FOR BUILDINGS ON MODERATELY, HIGHLY AND REACTIVE SITES
- SURFACE DRAINAGE SHALL BE CONTROLLED THROUGHOUT CONSTRUCTION AND BE COMPLETED BY THE FINISH OF CONSTRUCTION.
- THE BASE OF TRENCHES SHALL SLOPE AWAY FROM THE BUILDING. WHERE PIPES PASS UNDER THE FOOTING SYSTEMS, CLAY PLUGS ARE ADOPTED TO PREVENT THE INGRESS OF WATER.
- 2 FOR BUILDINGS ON HIGHLY AND REACTIVE SITES, DRAINER SHALL PROVIDE DRAINAGE ARTICULATION TO ALL STORMWATER, SANITARY PLUMBING DRAINS AND DISCHARGE PIPES IN ACCORDANCE WITH CLAUSE 5.6.4 PLUMBING REQUIREMENTS, WHEREIN FLEXIBLE JOINTS IMMEDIATELY OUTSIDE BUILDING AND COMMENCING WITHIN 1m OF THE BUILDING PERIMETER ARE REQUIRED TO ACCOMMODATE THE REQUIRED DIFFERENTIAL MOVEMENT BASE ON THE SOIL CLASSIFICATION. REFER TABLE 'MIN. REQUIREMENTS FOR EXPANSION AND ALLOWABLE IN FITTINGS
- З. SURFACE WATER MUST BE DIVERTED AWAY FROM THE DWELLING AND GRADED AWAY FROM ALL FOUNDATIONS TO GIVE A SLOPE OF NOT LESS THAN 50mm OVER THE FIRST 1000mm FROM THE DWELLING
- SUBSURFACE DRAINS TO REMOVE GROUND OR TABLE WATER SHALL BE DETAILED BY THE DESIGN ENGINEER. FURTHERMORE, DAMP-PROOF MEMBRANE IN ACCORDANCE WITH 5.3.3 SHALL BE INSTALLED FOR GROUNDWATER OR AGGRESSIVE SOILS.
- DRAINAGE DESIGN IS IN ACCORDANCE WITH AS3500.

#### MATERIALS

- 1. PROPOSED 1000 & 1500 STORMWATER DRAINS SHALL BE FORMED OF UNPLASTICISED POLYVINYL, CHLORIDE PIPES AND FITTINGS CLASS SH (SEWER CLASS) MANUFACTURED TO CONFORM TO AS.1260.
- 2. PROPOSED 225 DIAMETER AND LARGER STORMWATER DRAINS SHALL BE FORMED OF FIBRE REINFORCED CONCRETE CLASS 2, RUBBER RING JOINTED PIPE MANUFACTURED TO CONFORM TO AS 4058. (CLASS 3 WHERE INDICATED). USE UPVC TO AS1260. (CLASS SH) WHERE SHOWN ON THE DRAWINGS.

## SERVICE

- PRIOR TO THE COMMENCEMENT OF WORK THE CONTRACTOR SHALL LOCATE EXISTING SERVICES TO BE RETAINED WHERE PROPOSED SERVICES CROSS THEM, AND ASCERTAIN FOR HIMSELF THAT NO CLASHES OF SERVICES WILL OCCUR
- WHERE PROPOSED SERVICES TRAVERSE EXISTING ASPHALT AND 2. CONCRETE PAVEMENTS THE PAVEMENT IS TO BE SAW CUT TO FULL DEPTH OF PAVEMENT PRIOR TO EXCAVATION
- TRENCHES TRAVERSING EXISTING OR PROPOSED PAVEMENTS INCLUDING ASPHALT AND CONCRETE SHALL BE BACKFILLED WITH CLASS 2 FINE CRUSHED ROCK AND COMPACTED ALL TO THE SATISFACTION OF THE SUPERINTENDENT
- 1. THE CONTRACTOR SHALL CO-ORDINATE THE LAYING OF ALL SERVICES TO AVOID CLASHES
- LAY ALL SERVICES TO NOMINATED LEVELS WHERE GIVEN, OTHER SERVICES SHALL BE LAID TO COMPLY WITH MINIMUM COVER REQUIREMENTS
- DIFFERENT PARALLEL SERVICES THAT ARE IN CLOSE PROXIMITY TO EACH OTHER MAY BE LAID IN A COMMON TRENCH, SUBJECT TO THE APPROVAL OF THE RELEVANT AUTHORITY AND THE SUPERINTENDENT.

#### SITE DRAINAGE REQUIREMENTS - CONSTRUCTION STAGE:

THE GEOTECHNICAL REPORT HAS RECOMMENDED THE USE OF A CERTAIN FOOTING THAT IS APPROPRIATE FOR THIS SITE. WHILE MAKING THIS RECOMMENDATION IT HAS BEEN ASSUMED THAT CERTAIN SITE DRAINAGE REQUIREMENTS AS PER AS2870-2011 & BCA HAS BEEN MET. DURING THE CONSTRUCTION OF THE FOOTING THE FOLLOWING SITE DRAINAGE REQUIREMENTS ARE LISTED AS BEING PART OF THE FINAL FOOTING DESIGN BY INTRAX CONSULTING ENGINEERS.

- MUST PREVENT WATER PONDING AGAINST OR NEAR THE FOOTING
- THE GROUND IN THE IMMEDIATE VICINITY OF THE PERIMETER FOOTING 2. SHALL BE GRADED TO A FALL OF 50mm MIN. AWAY FROM THE FOOTING OVER A DISTANCE OF 1000mm (1:20) AND SHAPED TO PREVENT PONDING OF WATER (THIS INCLUDES THE GROUND UPHILL FROM THE FOOTING ON A CUT/FILL SITE) - WHERE FILLING IS PLACED ADJACENT TO THE BUILDING, THE FILLING SHALL BE COMPACTED AND GRADED TO ENSURE DRAINAGE OR WATER AWAY FROM THE BUILDING

ALL COLLECTED STORMWATER MUST BE DISCHARGED TO A LPOD SURFACE DRAINAGE OF THE SITE SHALL BE CONTROLLED FROM THE START OF THE SITE PREPARATION AND CONSTRUCTION; SURFACE

3. 4

> DRAINAGE INCLUDES SURFACE WATER RUN-OFF AND BUILDING WATER (ROOF/FLOOR/CONCRETE) RUN-OFF:

-ALL WATER RUN-OFF SHALL BE CONTROLLED AT ALL TIMES - USE TEMPORARY DOWNPIPES TO COLLECT WATER FROM THE ROOFED BUILDING FRAME

- WHEN SILT PITS ARE USED TO GATHER SURFACE WATER FROM AREAS ADJACENT TO THE FOOTINGS, THESE SILT PITS ARE TO BE AT LEAST 1000mm AWAY FROM THE FOOTING AND CONNECTED TO THE STORMWATER SYSTEM WITH SOLID PIPE;

- STORMWATER DRAINS SHALL BE AT LEAST 90mm AND HAVE A MINIMUM FALL OF 1:100 AND 100mm COVER UNDER THE SOIL AND/OR PAVED AREAS:

- INSPECTION OPENINGS SHOULD BE PROVIDED AT EACH PIPE CONNECTION POINT AND AT A NOMINAL SPACING OF 25m - AVOID UNDERMINING THE FOOTING WITH ANY TRENCHES OR PIPE OR PITS UNLESS THE FOOTING HAS BEEN DESIGNED TO ALLOW FOR SUCH SITUATION

- SUB-SURFACE DRAINAGE IS REQUIRED TO REMOVE ANY UNWANTED GROUND WATER BY MEANS 90mm SLOTTED PIPE IN A 300mm WIDE TRENCH (MIN. FALL OF 1:100), BASE OF THE TRENCH IS FILLED WITH 10mm CRUSHED ROCK OR SIMILAR COVERING THE SLOTTED PIPE - AG DRAINS MUST BE INSTALLED AT THE BASE OF ALL SITE CUTS THAT EXCEED 400mm IN HEIGHT, ALONG THE HIGH SIDE OF A SLOPING SITE AND POSSIBLY ALONG THE LOW SIDE OF A SLOPING SITE ALONG THE BOUNDARY. TO BE CONNECTED TO STORMWATER SYSTEM VIA A SILT PIT - AG DRAINS TO BE LAID APPROX. 200mm INTO UNDISTURBED CLAY OR ΓΩΜΡΑΓΤΕΣ ΓΙ ΑΥ
- AC CONDENSERS, HW OVERFLOW, WATER TANKS AND ADJOINING 6. PROPERTIES ARE ALL POTENTIAL SOURCES OF UNWANTED WATER. THIS WATER MUST BE CONTROLLED AND DIRECTED TO THE LPOD. POSSIBLE WATER IMPACTING THE SITE FROM AN ADJOINING PROPERTY ESPECIALLY IF THERE IS A FOOTING ON OR NEAR A BOUNDARY MUST BE ADDRESSED. LOCALISED FOOTING STRENGTHENING IS TO BE CONSIDERED DURING CONSTRUCTION ILO DRAINAGE THAT MAY JEOPARDISE THE FOOTINGS
- GRATED DRAINS MAY BE UTILISED IN A PAVED AREA (E.G. DRIVERWAY/GARAGE INTERFACE) WHERE THE PAVING NECESSARILY SLOPES TOWARDS THE HOUSE OR GARAGE. SPOON DRAINS MAY ALSO BE USED IN CONJUNCTION WITH A PAVED SURFACE.
- THE GROUND BENEATH A TIMBER DECK MUST BE GRADED SO THAT THE AREA BENEATH THE DECK IS ABOVE THE ADJACENT FINISHED GROUND LEVEL TO PREVENT PONDING.
- ALL TRENCHES MUST BE DUG AT A SIMILAR GRADE AS THE PIPES THE TRENCHES HOUSE.
- ALL TRENCHES MUST GENERALLY SLOPE AWAY FROM THE FOOTINGS - TRENCHES MUST BE 'CLAY PLUGGED' OR CONCRETED WHEN PASSING PERPENDICULARLY UNDER ANY PART OF THE FOOTING AND ON ANY SLOTTED PIPE SIDE OF A CONNECTION PIT

- ALL TRENCHES WITHIN 1500mm OF ANY FOOTING MUST BE EFFECTIVELY SEALED FROM SURFACE WATER, WITH AT LEAST THE TOP 300mm OF THE TRENCH FILLED WITH LOCAL CLAY COMPACTED TO AN IMPERMEABLE TOP LAYER. APPROVED MOISTURE BARRIER USE WITH TRENCHES IS AN OPTION

- CONCRETE PAVING IS ADVISED OVER ANY TRENCHES WITHIN 1000mm OF ANY FOOTING.

FLEXIBLE PLUMBING JOINTS ARE REQUIRED FOR H1/H2/E/P SITES TO 10 ALLOW FOR EXPECTED VERTICAL GROUND MOVEMENTS (REFER GEOTECHNICAL REPORT). THE JOINTS MUST BE SET AT THE MIDWAY POINT WHEN INSTALLED & MUST ALSO INCORPORATE SWIVEL JOINTS IN THE SYSTEM

- DRAINS EMERGING FROM UNDER THE FOOTING REQUIRE THE FLEXIBLE JOINT TO BE WITHIN 1000mm OF THE OUTSIDE OF THE PERIMETER FOOTING - INSTALLATION, LOCATION AND NUMBER OF JOINTS TO COMPLY WITH MANUFACTURER'S SPECS

PLUMBING PENETRATING THE FOOTING MUST BE AVOIDED WHERE 11. PRACTICABLE IF UNAVOIDABLE THEN THE PIPE MUST PASS THROUGH THE MIDDLE THIRD OF THE FOOTING DEPTH AND LAGGING TO THE PIPE PROVIDED

				X			PROJECT PROPOSED RESIDENCE - 720385	
						trax	LOT 7 NO. 45 WARRIEWOOD ROAD WARRIEWOOD	DRAWING
				$\sim$				GENERAL NOTES
				Melbourne	03 8371 0100	HOUSING	CLIENT METRICON HOMES PTY LTD - NSW	
01	CONSTRUCTION ISSUE	29.07.21	R.Y.	Sydney Brisbane	02 8355 1200 07 3067 0800	www.intrax.com.au		159253
REV.	REMARK/COMMENT	DATE:	APPR.	Adelaide Perth	08 8165 0122 08 9202 6825	VIC   NSW   SA   QLD   WA		
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## MAINTENANCE:

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- **ACTIVITIES**

INVESTMENT IS PROPERLY PROTECTED. LEAKING TAPS, DOWNPIPES, SEWERS, GUTTERS AND DRAINAGE CAN ALSO AFFECT THE MOISTURE CONTENT OF THE SOIL AND THESE MUST BE INSPECTED REGULARLY TO ENSURE AGAINST DAMAGE TO THE FOOTINGS. SIMILARLY, GUTTERS, DOWNPIPE AND COLLECTION POINTS CAN GET BLOCKED WITH LEAVES AND OTHER DEBRIS, PREVENTING THE EFFECTIVE DRAINAGE OF STORMWATER AWAY FROM THE HOUSE. AGAIN, REGULAR INSPECTIONS AND MAINTENANCE SHOULD BE CARRIED OUT TO PREVENT BLOCKAGES.


IT IS IMPORTANT FOR BUILDER TO MAKE THE HOMEOWNER AWARE OF THE MAINTENANCE ISSUES


THE MAINTENANCE OF THE SITE AROUND A NEW HOME IS AN IMPORTANT FACTOR IN THE LONG-TERM PERFORMANCE OF THE FOOTING SYSTEM


THE PRIMARY OB IFCTIVE OF THIS MAINTENANCE IS TO MINIMIZE THE VARIATION IN SOIL MOISTURE LEVELS AROUND THE FOOTING THAT COULD LEAD THE EXCESSIVE SOIL MOVEMENT AND POSSIBLE DISTRESS OF THE SUPERSTRUCTURE AND/OR FOOTING. WHEN THE SLAB FORMS PART OF THE TERMITE BARRIER SYSTEM FOR THE HOUSE, THEN IT IS ALSO NECESSARY TO MAINTAIN THE EFFECTIVENESS OF THAT BARRIER WITH APPROPRIATE MAINTENANCE

WHEN A CONCRETE SLAB-ON-GROUND IS USED AS PART OF THE TERMITE BARRIER SYSTEM AS OUTLINES IN AS3660.0, THEN IT CANNOT BE TOO HIGHLY STRESSED THAT REGULAR INSPECTION AND MAINTENANCE OF THE SLAB SURROUNDING BY A COMPETENT PROFESSIONAL IS REQUIRED TO ENSURE THAT ANY TERMITE INFESTATION IS DETECTED AND TREATED PROMPTLY. ONGOING MAINTENANCE AND INSPECTION ON A REGULAR BASIS IS A REQUIREMENT OF AS3660.1 AND OWNER SHOULD BE CLEARLY ADVISED IF THEIR RESPONSIBILITIES TO ENSURE THAT THEIR


ASSOCIATED WITH ENSURING THE LONG-TERM PERFORMANCE OF THE FOOTING SYSTEM.

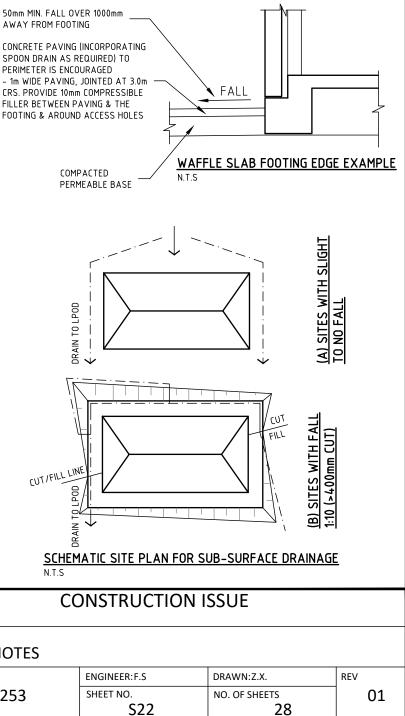

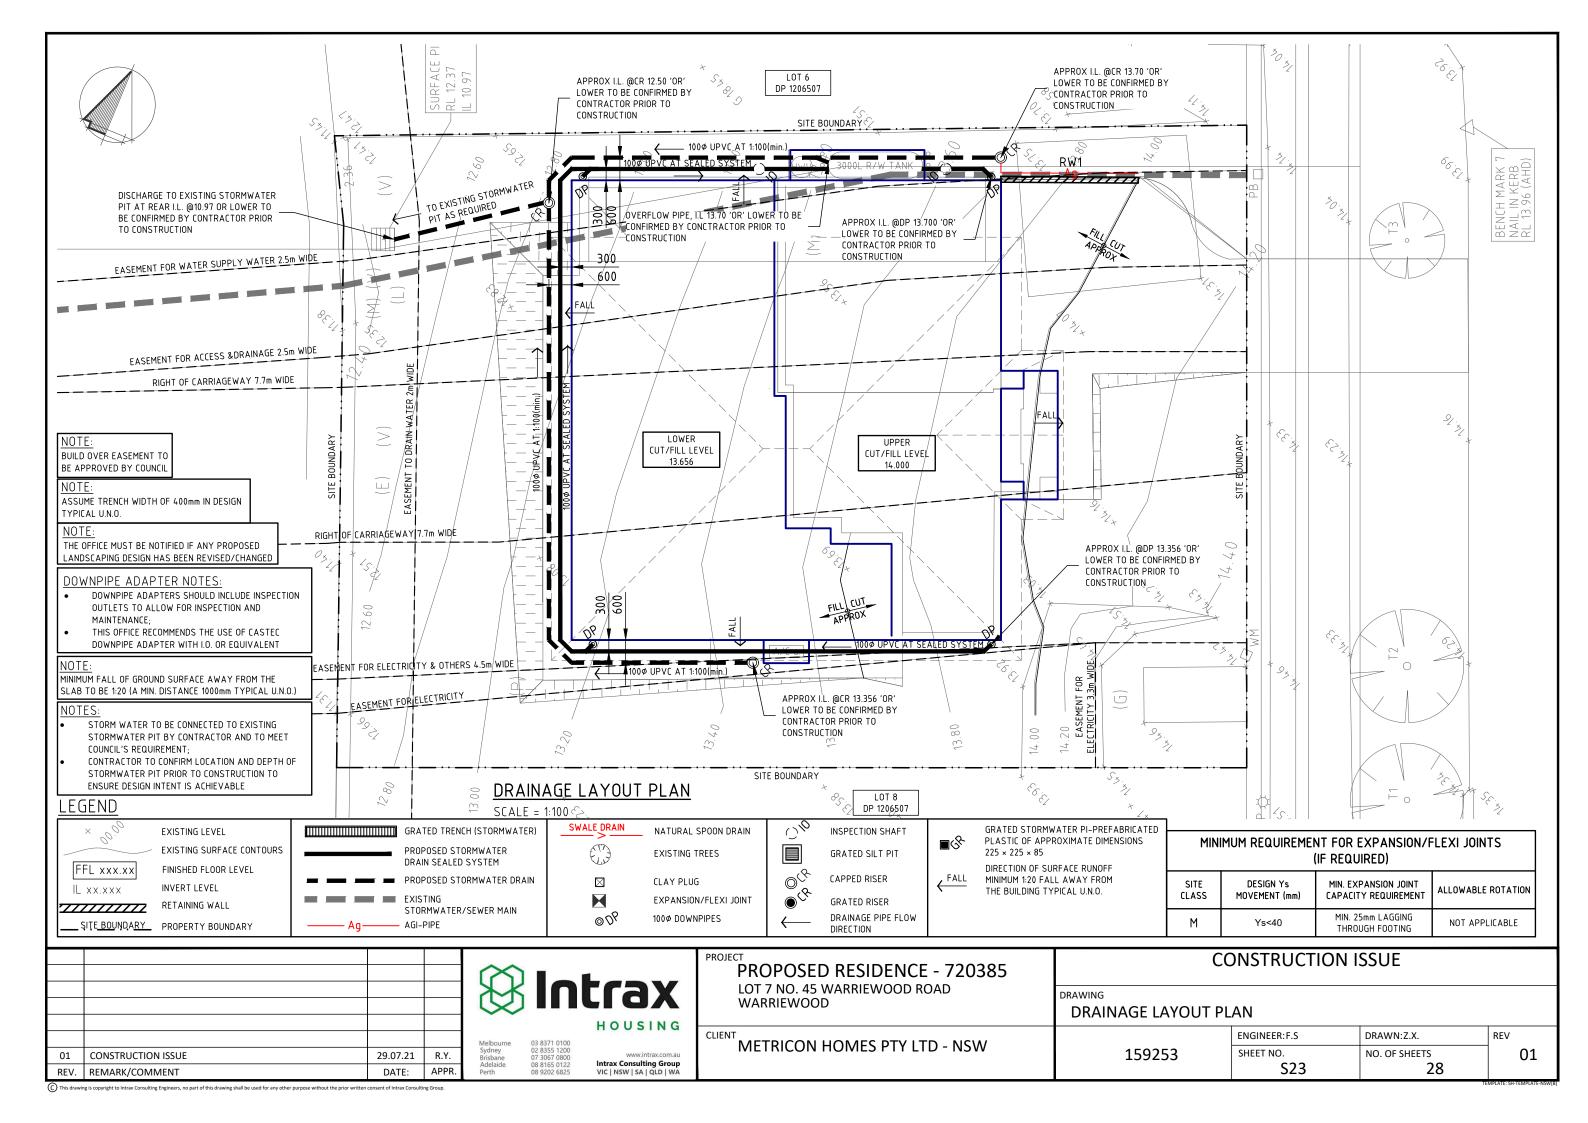

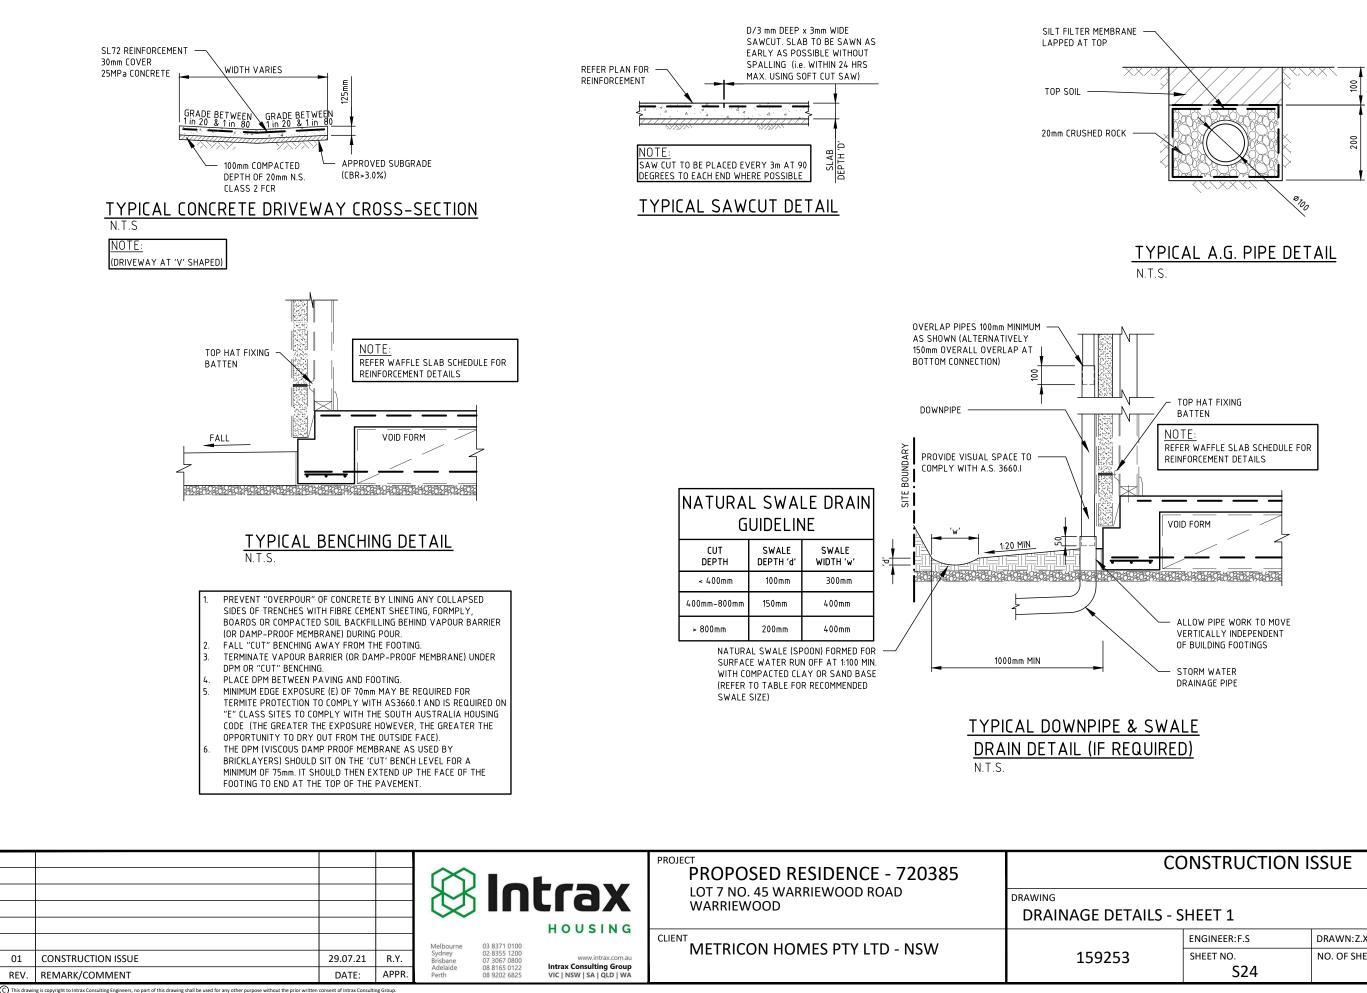


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SHEET NO.	NO. OF SHEETS	01
S24	28	

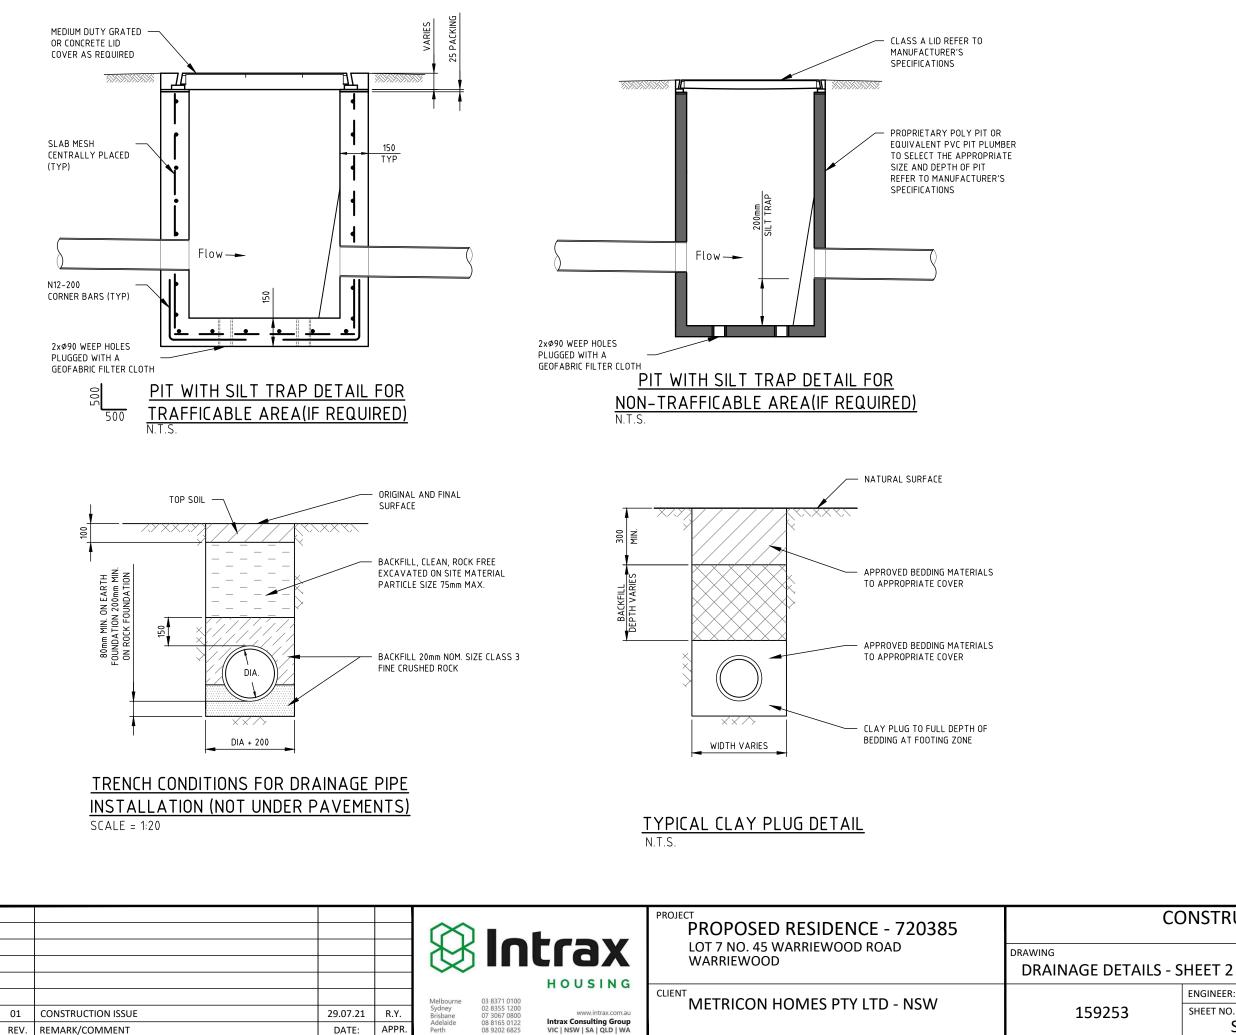

## CONSTRUCTION ISSUE

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MINIMUM REQUIREMENTS FOR SEWER ARTICULATION						
SITE	DESIGN Ys MOVEMENT (mm)	SEWER EXIT POINTS & ORG				
CLASS		SWIVEL	EXPANDER			
М	Ys<40	0	0			

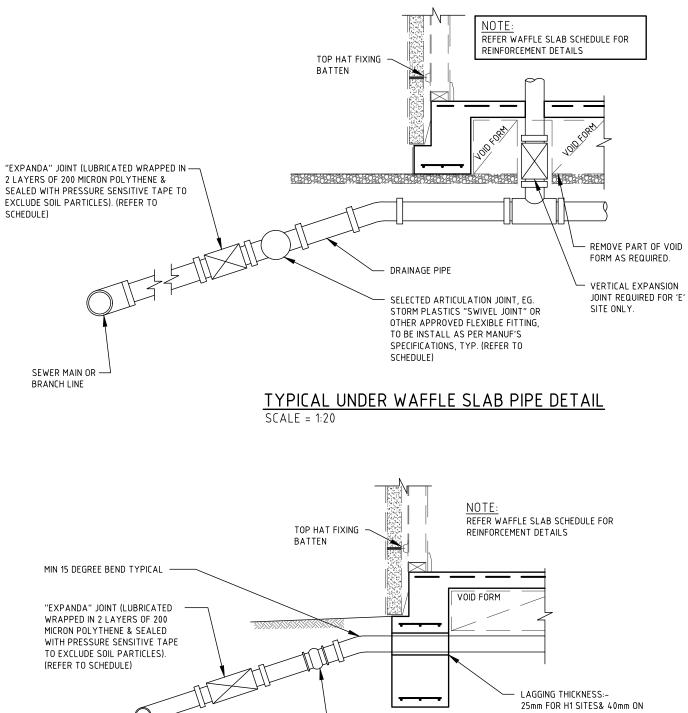NOTE: EXPANDER REQUIRED ON ALL RISERS FOR (CLASS E, Ys >75mm OR EQUIVALENT SITES

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							SCALE = 1:20	
				Ø	In	trax	PROJECT PROPOSED RESIDENCE - 720385 LOT 7 NO. 45 WARRIEWOOD ROAD WARRIEWOOD	DRAWING
01 REV.	CONSTRUCTION ISSUE REMARK/COMMENT	29.07.21 DATE:	R.Y. APPR.	Melbourne Sydney Brisbane Adelaide Perth	03 8371 0100 02 8355 1200 07 3067 0800 08 8165 0122 08 9202 6825	HOUSING www.intrax.com.au Intrax Consulting Group VIC   NSW   SA   QLD   WA	CLIENT METRICON HOMES PTY LTD - NSW	159253

"E" OR EQUIVALENT SITES UNLESS NOTED OTHERWISE


SELECTED ARTICULATION JOINT, EG. STORM PLASTICS "SWIVEL JOINT" OR OTHER APPROVED FLEXIBLE FITTING INSTALLED TO MANUFACTURES RECOMMENDATIONS. (REFER TO SCHEDULE)

## TYPICAL PIPE THROUGH FOOTING DETAIL - SECTION

## CONSTRUCTION ISSUE

## AILS - SHEET 3

ENGINEER: F.S	DRAWN:Z.X.	REV
SHEET NO.	NO. OF SHEETS	01
S26	28	

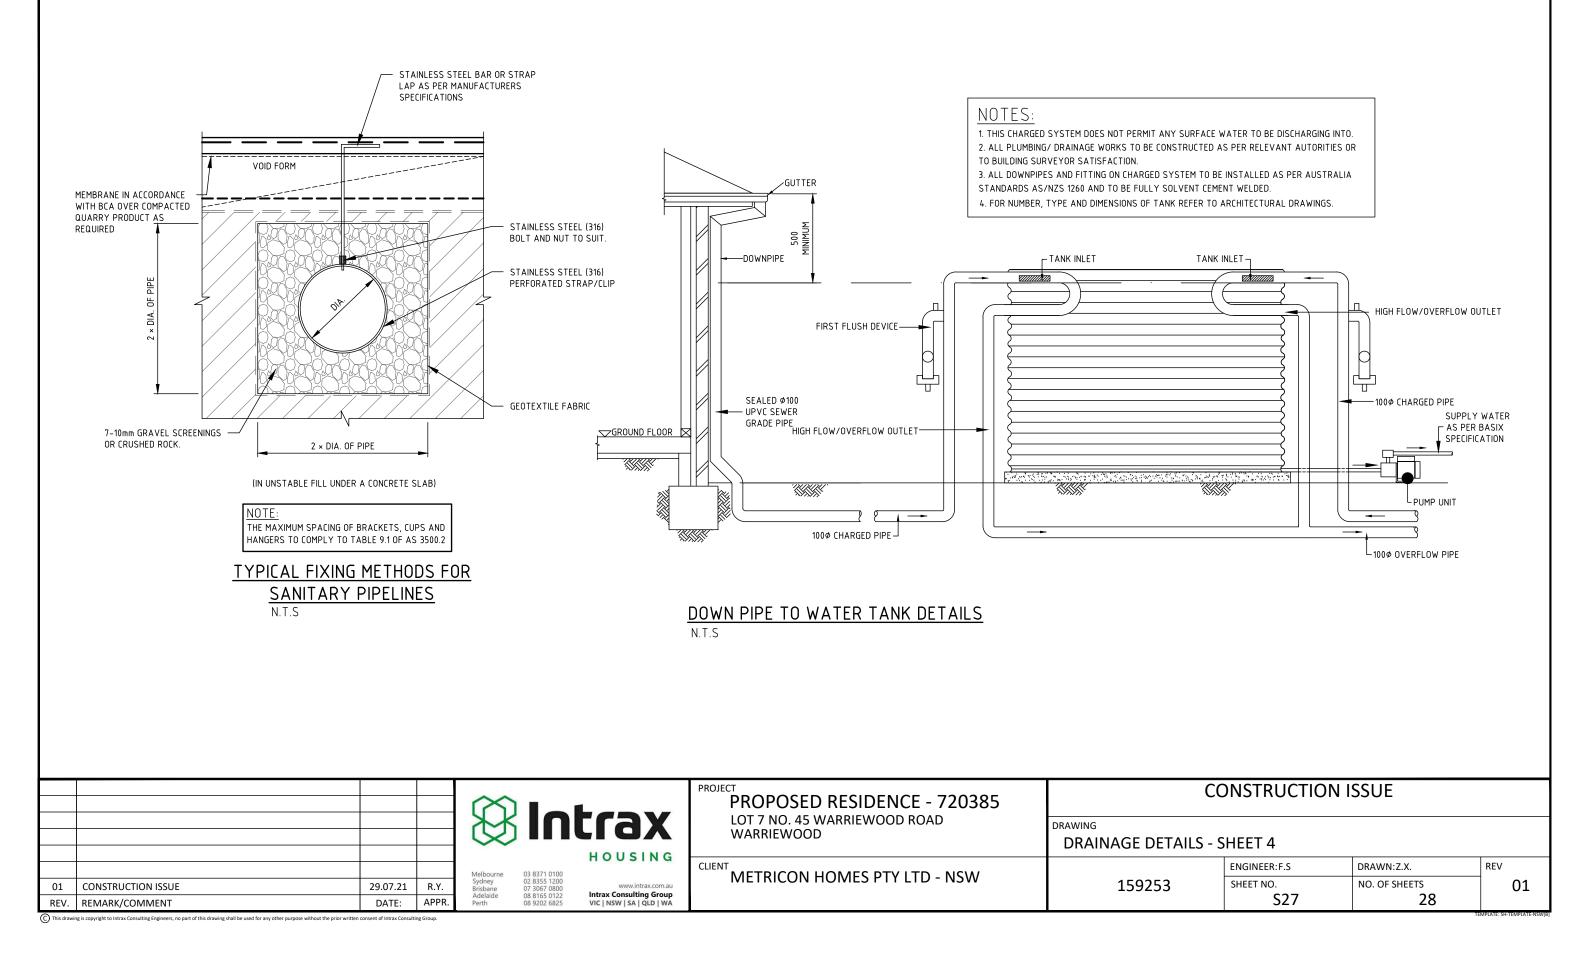

# PROPOSED DEVELOPMENT LOT 7 NO. 45 WARRIEWOOD ROAD, WARRIEWOOD

## GENERAL DRAINAGE NOTES

- THE CONTRACTOR SHALL ADEQUATELY DRAIN THE SITE DURING ALL STAGES OF CONSTRUCTION.
- CONTRACTOR SHALL VERIFY ALL LEVELS DIMENSIONS AND SERVICES EXISTING AND REPORT ANY DISCREPANCIES TO BUILDER WITHIN 5 DAYS OF MOBILISATION TO SITE.
- ALL APPROPRIATE PERMITS SHALL BE OBTAINED AND FEES PAID FOR BY THE CONTRACTOR
- 4. ANY PAVEMENT OR FEATURES DAMAGED DURING THE COURSE OF THIS CONTRACT SHALL BE REINSTATED TO THEIR FORMER CONDITION.
- THE CONTRACTOR SHALL ARRANGE A SITE INSPECTION WITH THE CIVIL ENGINEERING SUPERVISING OFFICER PRIOR TO THE COMMENCEMENT OF WORK TO RECORD ANY DAMAGE TO EXISTING FEATURES
- ALL EXISTING PIT COVERS, DOWNPIPE CONNECTIONS AND SIMILAR FEATURES IN CONSTRUCTION AREAS ARE TO BE ADJUSTED TO SUIT.
- 7. ALL CONCRETE PAVEMENT SHALL BE FINISHED WITH A NON SKID FLOAT, (NO **BROOMED FINISH**)
- BEFORE COMMENCEMENT OF WORK A TEMPORARY BENCH MARK IS TO BE ESTABLISHED BY THE CONTRACTOR IN A POSITION ON SITE SAFE FROM DISTURBANCE
- 9. ANY SHORTFALL IN INDIGENOUS TOPSOIL REQUIRED TO BRING THE GARDEN AND GRASSED AREAS TO THE DESIGN LEVELS SHALL BE MADE UP WITH APPROVED IMPORTED TOPSOIL. NO ADDITIONAL PAYMENT WILL BE MADE FOR IMPORTED TOPSOIL
- 10. EXCAVATED MATERIAL SHALL BE STOCKPILED ON SITE AS DIRECTED BY THE SUPERINTENDENT. EXCESS TO BE REMOVED FROM SITE AT CONTRACTORS EXPENSE
- TOPSOIL TO BE STRIPPED TO A DEPTH OF 150mm UNDER FILL AREAS AND ALL 11. OTHER AREAS. THIS TOPSOIL SHALL BE STOCKPILED ON SITE AS DIRECTED BY SUPERINTENDENT. EXCESS SOIL SHALL BE REMOVED FROM THE SITE AT THE CONTRACTORS EXPENSE.
- 12. ALL STORMWATER DRAINS SHALL BE BEDDED ON A MINIMUM OF 80mm COMPACTED THICKNESS 20 N.S. CLASS 3 FINE CRUSHED ROCK. IN SOIL BASED TRENCHES. INCREASE TO 200mm THICKNESS IN ROCK BASED TRENCHES.
- 13. 100mm AND 150mm DIAMETER STORMWATER DRAINS SHALL BE LAID AT A MINIMUM GRADE OF 1:100, UNLESS OTHERWISE SHOWN.
- 14. FOOTPATHS, DRIVEWAYS, ROADWAYS, KERBS, R.O.W.'S OR EXISTING FEATURES DISTURBED, BROKEN OR AFFECTED BY THE WORKS ARE TO BE REINSTATED TO THE COMPLETE SATISFACTION OF THE CITY ENGINEER OR HIS REPRESENTATIVE.
- 15. ALL CONCRETE TO BE SAW CUT AND BROKEN OUT TO THE NEAREST JOINT. 16. ALL NATURE STRIPS AND LAWN AREAS OUTSIDE PRIVATE PROPERTY TO BE
- REINSTATED WITH TOP SOIL AND SEEDED 17. CONTRACTOR TO CONTACT LOCAL COUNCIL ENGINEERING DEPARTMENT AT LEAST 4 48 HOURS PRIOR TO THE COMMENCEMENT OF CONSTRUCTION OF OUTFALL DRAINAGE TO ARRANGE FOR COUNCIL SUPERVISION AND INSPECTION IF REQUIRED BY COUNCIL
- 18. THE CONTRACTOR IS TO VERIFY ALL LOCATIONS AND DEPTH OF SERVICES WITH THE RELEVANT AUTHORITIES FOR THE CONSTRUCTION OF DRAINS AND SERVICES OUTSIDE THE PROPERTY BOUNDARY PRIOR TO THE COMMENCEMENT OF WORK. AND SHALL BE FULLY RESPONSIBLE FOR RECTIFICATION OF ANY DAMAGED SERVICE
- 19. ALL ADDITIONAL FILL MATERIAL REQUIRED DUE TO OVER EXCAVATION OR A SHORTFALL OF SUITABLE EXCAVATED MATERIAL SHALL BE IMPORTED AT THE CONTRACTORS EXPENSE.

	AND ALLOWABLE IN FITTINGS	
SITE CLASS	MIN. REQUIRED EXPANSION JOINT CAPACITY	ALLOWABLE ROTATION
Έ'	150mm	15°
Ή'	70mm	15°
Ϋ́Ρ'	70mm PLUS ADDITIONAL REQUIREMENTS IN THE CASE OF FILL (MIN. DEPENDENT ON SITE CONDITION)	15°
'M'	MIN. 25mm LAGGING THROUGH FOOTINGS	NOT APPLICABLE

THE CONTRACTOR TO REFER SOIL CLASSIFICATION REPORT TO DETERMINE THE TYPE OF EXPANSION JOINT TO BE USED

## DRAINAGE NOTES:

- HIGHLY AND REACTIVE SITES:
  - •SURFACE DRAINAGE SHALL BE CONTROLLED THROUGHOUT CONSTRUCTION AND BE COMPLETED BY THE FINISH OF CONSTRUCTION. •WHERE PIPES PASS UNDER THE FOOTING SYSTEMS, CLAY PLUGS ARE ADOPTED TO PREVENT THE INGRESS OF WATER.
- 2.FOR BUILDINGS ON HIGHLY AND REACTIVE SITES, DRAINER SHALL PROVIDE DRAINAGE ARTICULATION TO ALL STORMWATER, SANITARY PLUMBING DRAINS AND DISCHARGE PIPES IN ACCORDANCE WITH CLAUSE 5.6.4 PLUMBING REQUIREMENTS, WHEREIN FLEXIBLE JOINTS IMMEDIATELY OUTSIDE BUILDING AND COMMENCING WITHIN 1m OF THE BUILDING PERIMETER ARE REQUIRED TO ACCOMMODATE THE REQUIRED DIFFERENTIAL MOVEMENT BASE ON THE SOIL CLASSIFICATION, REFER TABLE 'MIN, REQUIREMENTS FOR
- EXPANSION AND ALLOWABLE IN FITTINGS. 3.DRAINAGE DESIGN IS IN ACCORDANCE WITH AS3500.

## MATERIALS

- PROPOSED 1000 AND 1500 STORMWATER DRAINS AND FITTINGS SHALL BE UPVC CLASS SN8/10- UNLESS OTHER WISED SPECIFIED ON PLANS.
- PROPOSED 225Ø AND 300Ø STORMWATER DRAINS, USE UPVC CLASS SH TO AS1260, UNLESS OTHERWISE SPECIFIED ON THE PLANS.
- PROPOSED 375Ø OR LARGER STORMWATER DRAINS, USE FRC RRJ JOINT CLASS 4 WHERE COVER EXCEEDS 600mm, UNLESS OTHERWISE SPECIFIED ON THE PLANS.
- PROPOSED 375Ø OR LARGER STORMWATER DRAINS, USE RCP RRJ JOINT CLASS 2 WHERE COVER IS 600mm OR LESS, UNLESS OTHERWISE SPECIFIED ON THE PLANS
- WHERE CONSTRUCTION LOADS CAN'T BE ACHIEVED. CONCRETE ENCASE THE PIPE OR IMPLEMENT LOW IMPACT CONSTRUCTION METHODS.
- IT IS THE CONTRACTORS RESPONSIBILITY TO CHECK PIPE TYPE AND CLASS REQUIREMENTS 6 PRIOR TO CONSTRUCTION. IF THERE ARE ANY CONCERNS THEY SHOULD BE RAISED WITH THE DESIGNER PRIOR TO COMMENCEMENT OF CONSTRUCTION.

## SERVICE

- WHERE PROPOSED SERVICES TRAVERSE EXISTING ASPHALT AND CONCRETE PAVEMENTS THE PAVEMENT IS TO BE SAW CUT TO FULL DEPTH OF PAVEMENT PRIOR TO EXCAVATION. THE INTERFACE BETWEEN EXISTING KERB AND CHANNEL (TO BE REMOVED) AND EXISTING ASPHALT SHALL BE SAWCUT
- THE CONTRACTOR SHALL CO-ORDINATE THE LAYING OF ALL SERVICES TO AVOID CLASHES. TO COMPLY WITH MINIMUM COVER REQUIREMENTS.
- 3. LAY ALL SERVICES TO NOMINATED LEVELS WHERE GIVEN, OTHER SERVICES SHALL BE LAID
- DIFFERENT PARALLEL SERVICES THAT ARE IN CLOSE PROXIMITY TO EACH OTHER MAY BE LAID IN A COMMON TRENCH, SUBJECT TO THE APPROVAL OF THE RELEVAN AND THE SUPERINTENDENT

# WARNING

THE BUILDER/CONTRACTOR SHALL PROVE ALL EXISTING SERVICES WITHIN 3 DAYS OF MOBILISATION OR ANY WORKS OCCURRING ON SITE.

THESE PLANS ARE TO BE READ IN CONJUNCTION WITH THE ARCHITECTURAL & LANDSCAPE PLANS FOR EXTERNAL WORKS

ALL UNDERGROUND & SURFACE DRAINAGE WORKS SHALL BE INSTALLED IN ACCORDANCE WITH CLAUSE 5.6.3 DRAINAGE REQUIREMENTS OF AS 2870-2011 & AS3500.3-2018. SURFACE DRAINAGE SHALL BE CONTROLLED THROUGHOUT CONSTRUCTION AND BE COMPLETED BY THE FINISH OF CONSTRUCTION



1.ALL SURFACE DRAINAGE WORKS SHALL BE INSTALLED IN ACCORDANCE WITH CLAUSE 5.6.3 DRAINAGE REQUIREMENTS OF AS 2870-2011, WHEREIN FOR BUILDINGS ON MODERATELY,

> ALL FINISHED SURF SLOPED AWAY FRO AND DRAIN TOWARD ALL INTERNAL CONSTRUCTED A STANDARD STORMWATER PIP CENTERS AWAY F UNLESS SPECIFIED U.N.U. KLI LK I IFICAL DETAIL AND NUTES BUILDER TO CONFIRM ALL PIT LEVELS PROVIDE 2-N12 BARS × 1200 AND COVERS PRIOR TO COMMENCEMENT LONG TOP FOR ALL RE-ENTRY CORNERS OF PITS. OF CONSTRUCTION (TYPICAL).


# SITE DRAINAGE REQUIREMENTS - CONSTRUCTION STAGE:


- PREVENT WATER PONDING AGAINST OR NEAR ANY EXISTING FOOTING
- THE GROUND IN THE IMMEDIATE VICINITY OF THE PERIMETER FOOTING SHALL BE GRADED TO A FALL OF 50mm MIN. AWAY FROM THE FOOTING OVER A DISTANCE OF 1000mm (1:20) AND SHAPED TO PREVENT PONDING OF WATER (THIS INCLUDES THE GROUND UPHILL FROM THE FOOTING ON A CUT/FILL SITE) - WHERE FILLING IS PLACED ADJACENT TO THE BUILDING. THE FILLING SHALL BE COMPACTED AND GRADED TO ENSURE DRAINAGE OR WATER AWAY FROM THE BUILDING
- ALL COLLECTED STORMWATER MUST BE DISCHARGED TO THE LPOD.
- INSTALL SUB-SURFACE DRAINAGE TO AS2439.1 100mm DIAMETER SN8 IN A 300mm WIDE TRENCH (MIN. FALL OF 1:100), BASE OF THE TRENCH IS FILLED WITH 12mm SINGLE SIZE AGGREGATE. - AG DRAINS MUST BE INSTALLED AT THE BASE OF ALL SITE CUTS THAT EXCEED 400mm IN HEIGHT, ALONG THE HIGH SIDE OF A SLOPING SITE AND POSSIBLY ALONG THE LOW SIDE OF A SLOPING SITE ALONG THE BOUNDARY. TO BE CONNECTED TO STORMWATER SYSTEM VIA A SILT PIT
- AG DRAINS TO BE LAID APPROX. 200mm INTO UNDISTURBED CLAY OR COMPACTED CLAY.
- TRENCHES MUST BE 'CLAY PLUGGED' OR CONCRETED WHEN PASSING PERPENDICULARLY UNDER ANY PART OF THE FOOTING AND ON ANY SLOTTED PIPE SIDE OF A CONNECTION PIT
- ALL TRENCHES WITHIN 1500mm OF ANY FOOTING MUST BE EFFECTIVELY SEALED FROM SURFACE WATER, WITH AT LEAST THE TOP 300mm OF THE TRENCH FILLED WITH LOCAL CLAY COMPACTED TO AN IMPERMEABLE TOP LAYER. APPROVED MOISTURE BARRIER USE WITH TRENCHES IS AN OPTION.
- 6. FLEXIBLE PLUMBING JOINTS ARE REQUIRED FOR H1/H2/E/P SITES TO ALLOW FOR EXPECTED VERTICAL GROUND MOVEMENTS (REFER GEOTECHNICAL REPORT). THE JOINTS MUST BE SET AT THE MIDWAY POINT WHEN INSTALLED & MUST ALSO INCORPORATE SWIVEL JOINTS IN THE SYSTEM

- DRAINS EMERGING FROM UNDER THE FOOTING REQUIRE THE FLEXIBLE JOINT TO BE WITHIN 1000mm OF THE OUTSIDE OF THE PERIMETER FOOTING - INSTALLATION, LOCATION AND NUMBER OF JOINTS TO COMPLY WITH MANUFACTURER'S SPECS.

HOTHER MAY BE NT AUTHORITY	SYSTEM, THIS OFFICE TO BE NOTIFIED IMMEDIATELY IF SHALLOW ROCK PRESENTED ON SITE DURING TRENCHING AND EXCAVATION	
FACE LEVEL TO BE OM FINISHED FLOOR LEVEL RDS STORMWATER PITS	IMPORTANT NOTES: AT NO TIME IS ANY EXISTING OR PROPOSED FOOTING TO BE UNDERMINED DURING CONSTRUCTION. BUILDER TO ENSURE AND CONFIRM	ALL DOWNPIPES LOCATION ARE PRELIMINARY ONLY. CONTRACTOR TO REFER LATEST ARCHITECT PLANS EXACT LOCATION OF ALL DOWNPIPES. CONNECTION T
	PRIOR TO COMMENCEMENT OF CONSTRUCTION. THIS	DONE ACCORDANCE TO PLUMBING STANDARD AS350
L DRAINAGE TO BE AS PER AUSTRALIAN	OFFICE TO BE CONTACTED IF ANY DISCPREPANCY	
D AS3500.3-2018	PROVIDE FLEXI JOINTS AND CLAY PLUGS AS PER	AUTHORITY APPROVAL REQUIRED PRIOR TO COMMENCEMENT OF CONSTRUCTION
	AS2870	
PE TO BE LAID 800mm FROM EDGE OF SLAB D OTHERWISE	NOTE: ALL CONCRETE JOINTS ARE SAWCUT JOINTS U.N.O. REFER TYPICAL DETAIL AND NOTES	ALL HWS AND AC UNIT OVERFLOWS TO BE CONNECTED TO THE PROPOSED STORMWATER DRAINAGE SYSTEM

FOR INFILTRATION, DISPERSION AND ABSORPTION

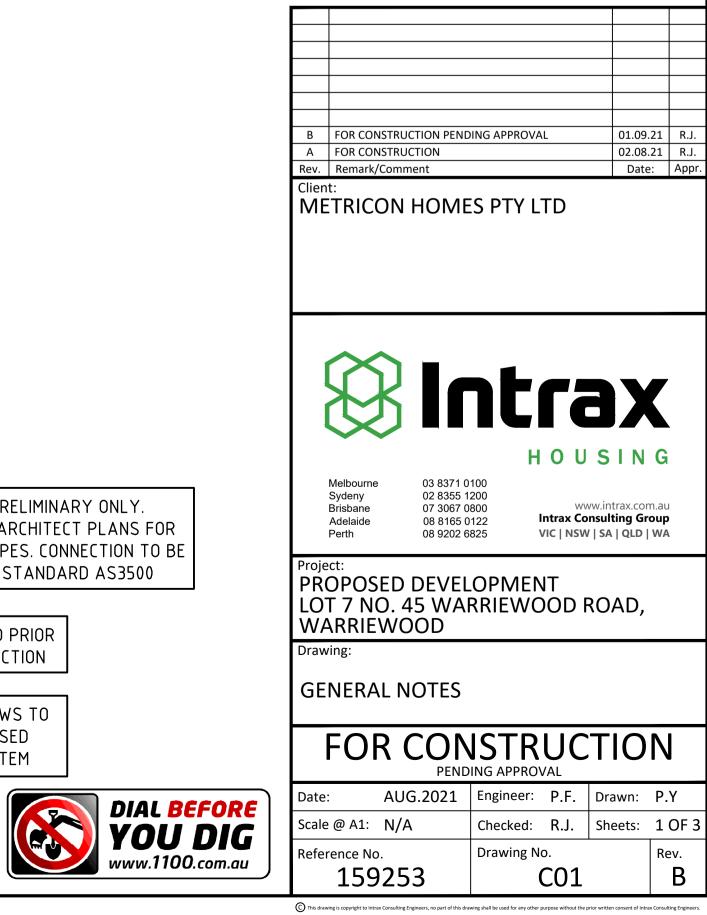

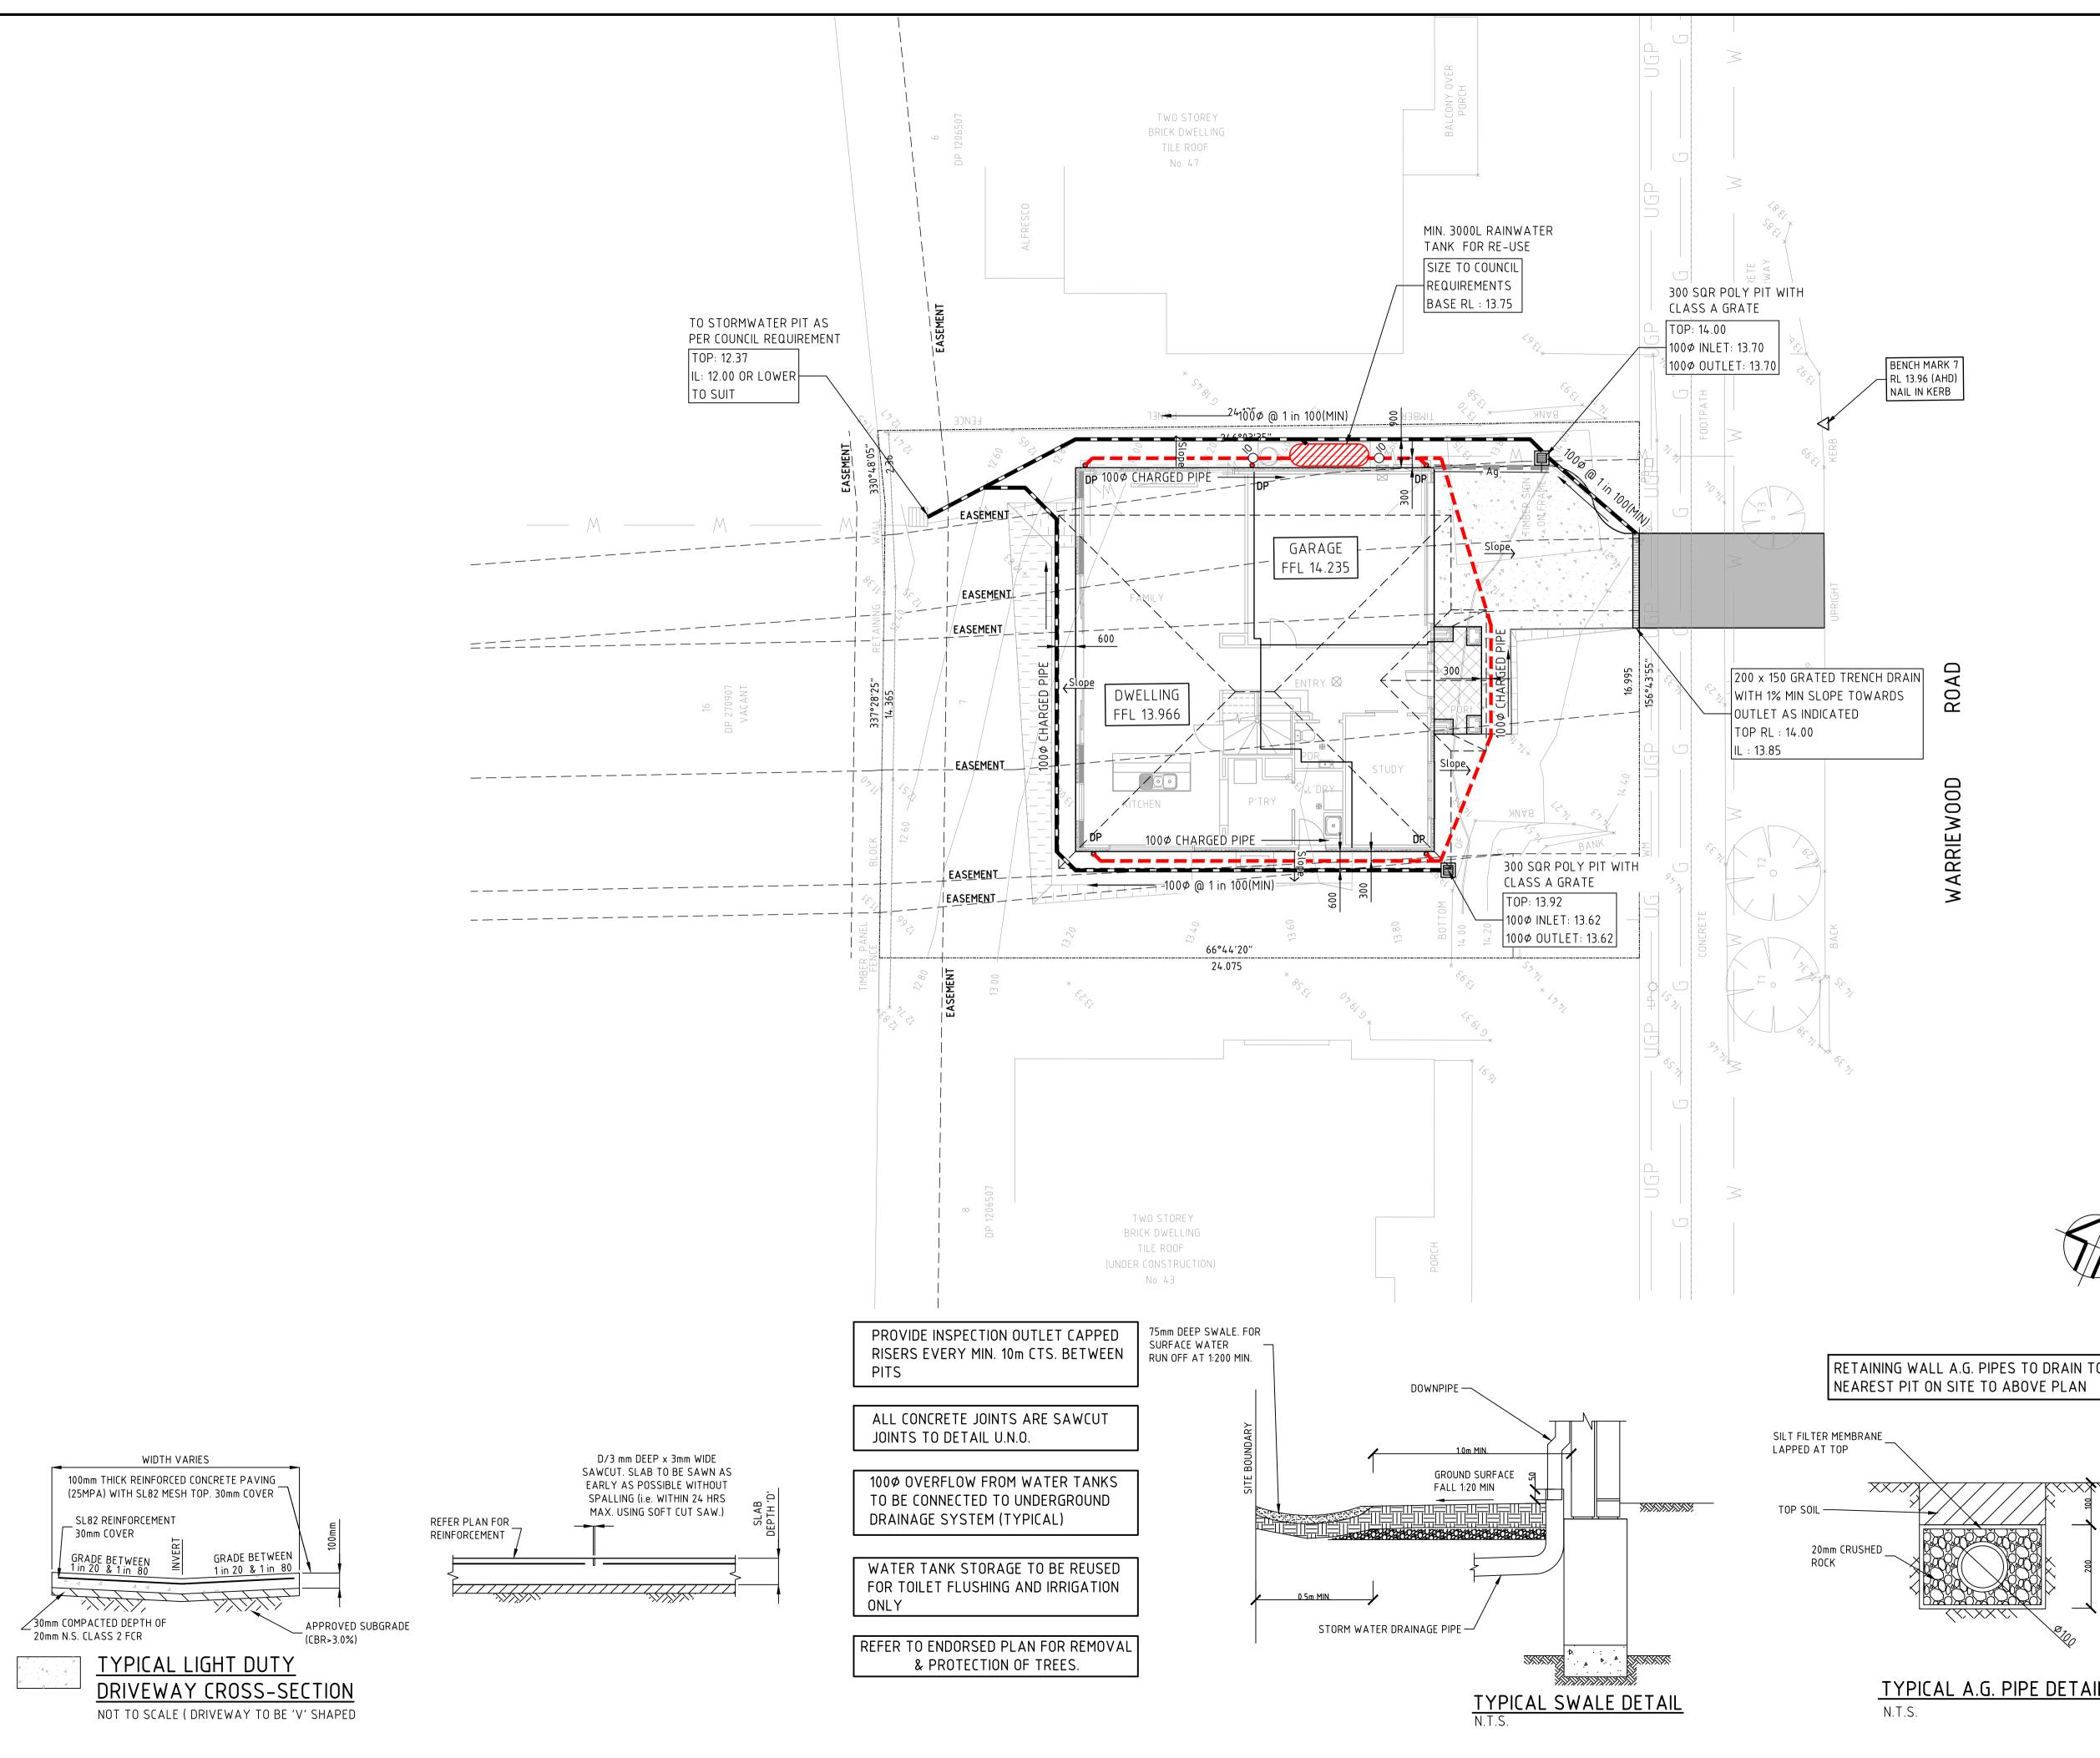

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	Project: PROPOSED DEVELOPMENT LOT 7 NO. 45 WARRIEWOOD ROAD, WARRIEWOOD								
	Drawing: STORMW	ATER HYDRAU	JLIC MANA	AGEME	INT PLAN	N			
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E DETAIL	Date:	AUG.2021	Engineer:	P.F.	Drawn:	P.Y			
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# LEGEND

PL. 0.00

TOP 0.000

INLET 0.000

OUTLET 0.000

FFL xx.xxx

● DP

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Slope,

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PAVEMENT LEVEL

TOP OF PIT

INVERT LEVEL OF INLET PIPE

OUTLET INVERT LEVEL

FINISHED FLOOR LEVEL

EXISTING STORMWATER DRAIN

STORMWATER DRAIN (100Ø AT 1 IN 100) GRATED PIT

DOWNPIPE (100Ø U.N.O.) DIRECTION OF SURFACE RUNOFF 1:20 MIN


CHARGED STORMWATER LINE


INSPECTION OPENING

CAPPED RISER

SWALE DRAIN

SUBSOIL DRAINAGE

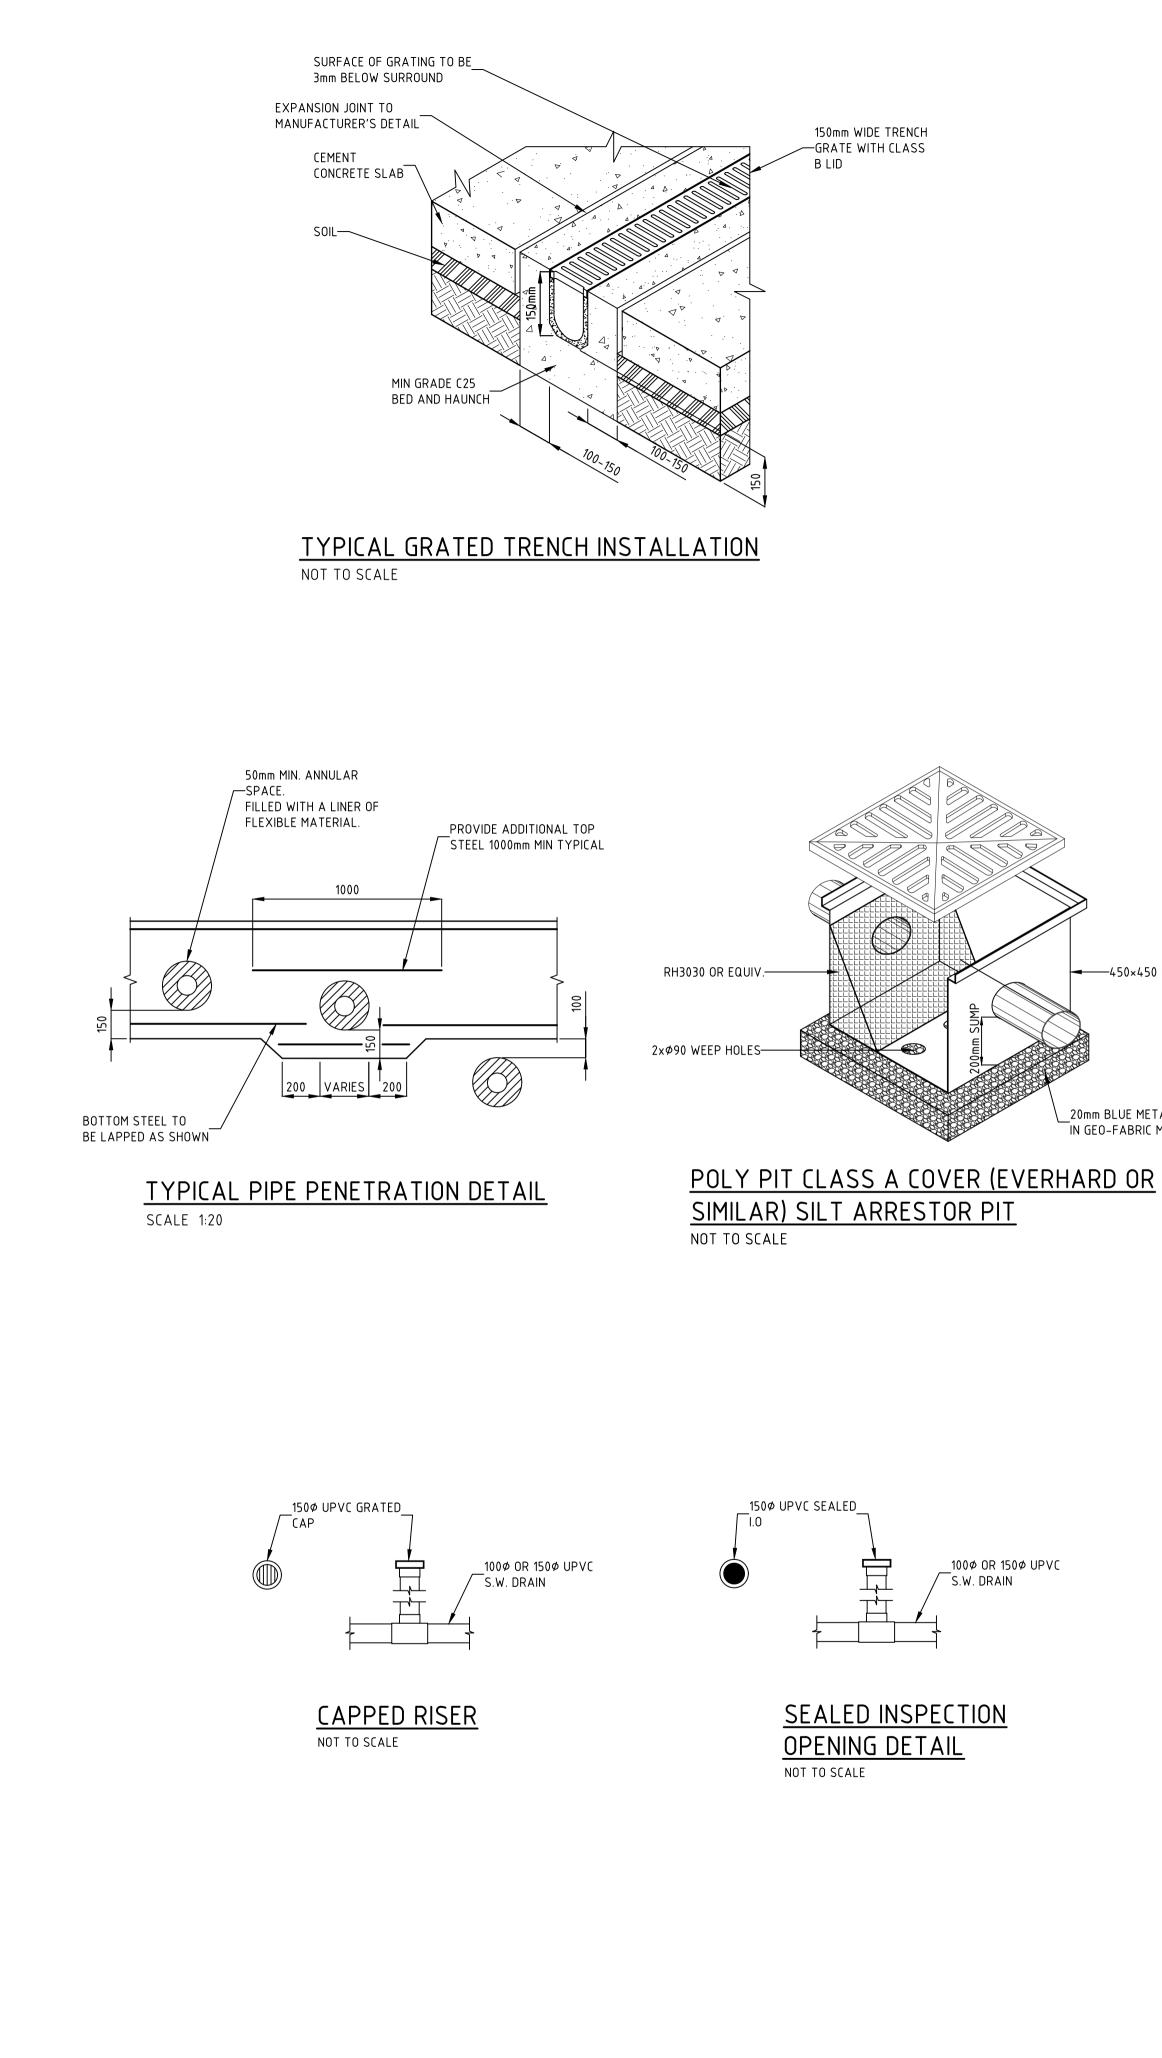

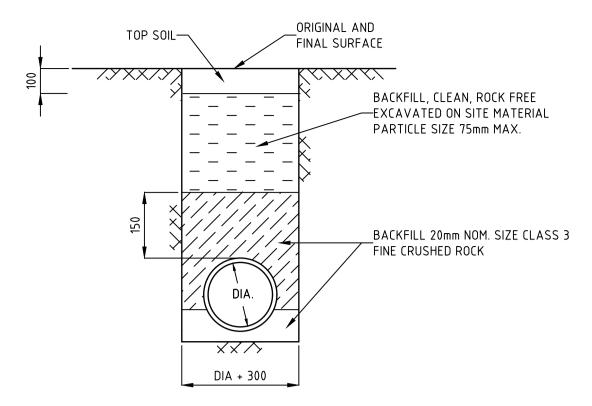


# TRENCH CONDITIONS FOR DRAINAGE PIPE **INSTALLATION (NOT UNDER PAVEMENTS)** NOT TO SCALE




SUBGRADE LEVEL-BACKFILL WITH COMPACTED 20mm NOMINAL SIZE FINE CRUSHED ROCK @ MAX. 150mm LAYERS.

> 20mm NOMINAL SIZE FINE CRUSHED ROCK COMPACTED BEDDING (CLASS 3 FCR)

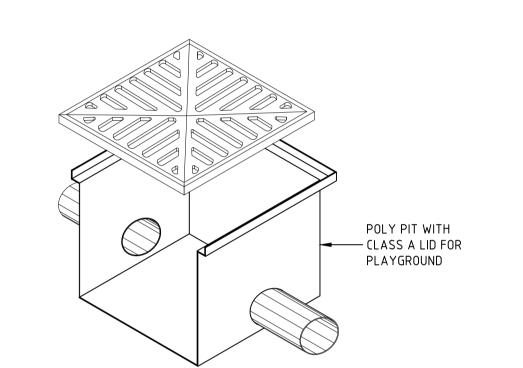


20mm BLUE METAL WRAPPED IN GEO-FABRIC MATERIAL


# POLY PIT CLASS A COVER

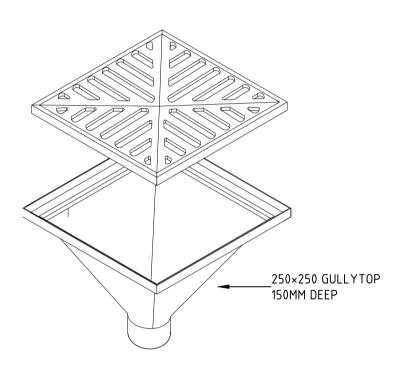




# GULLYTOP CLASS A COVER (EVERHARD OR

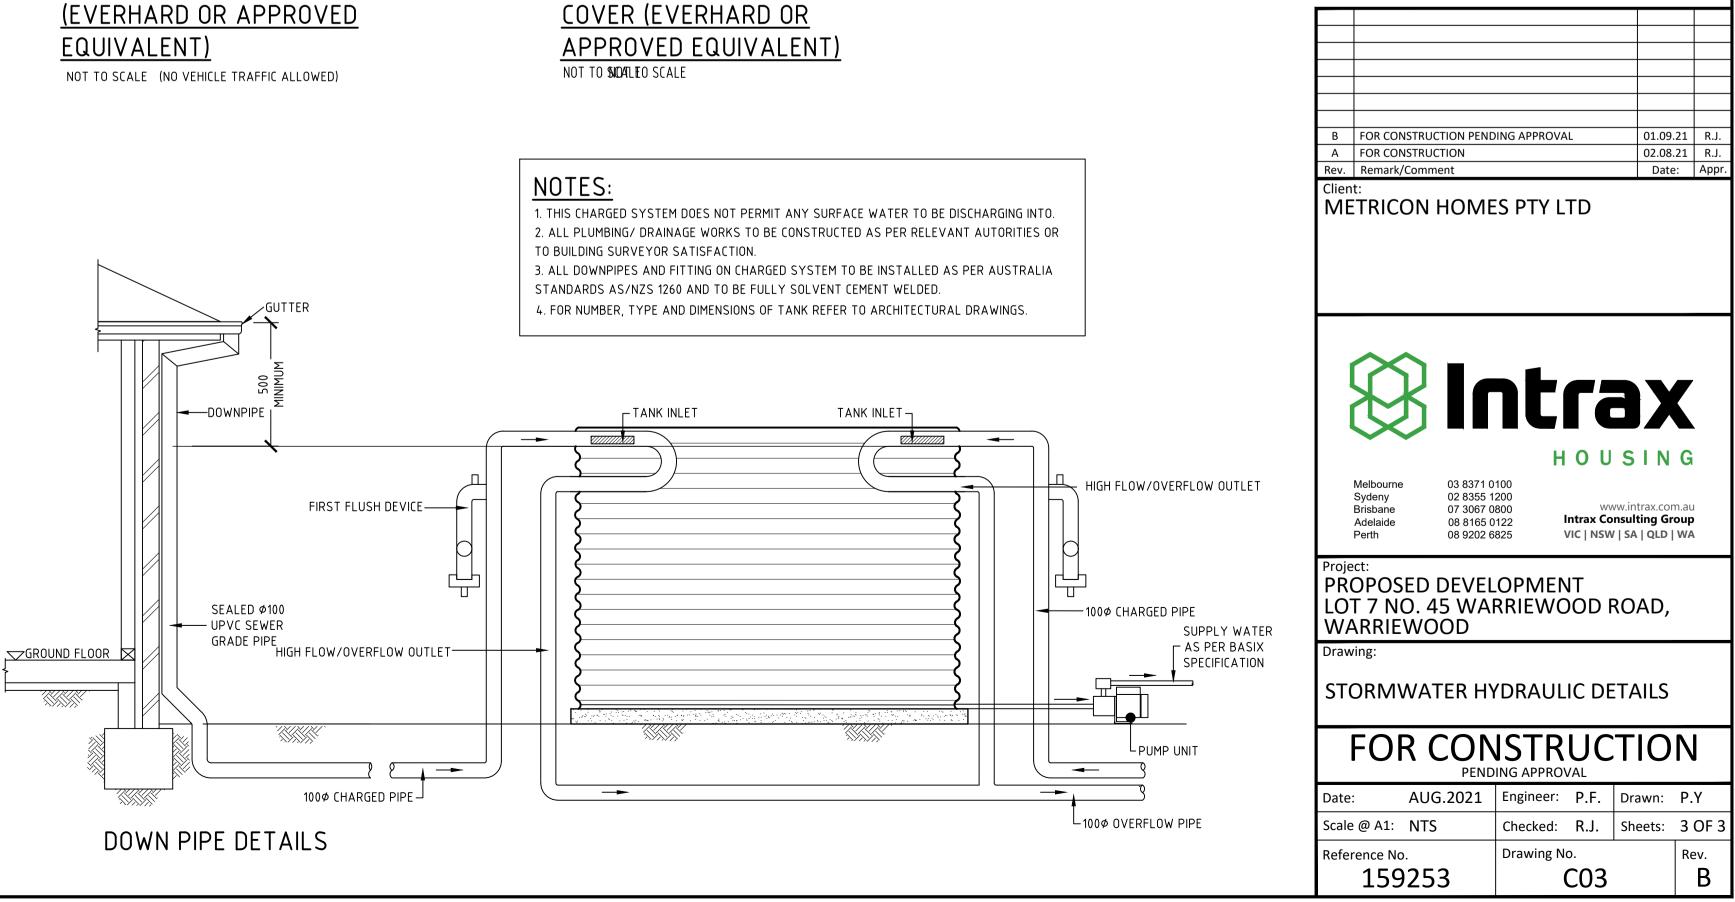

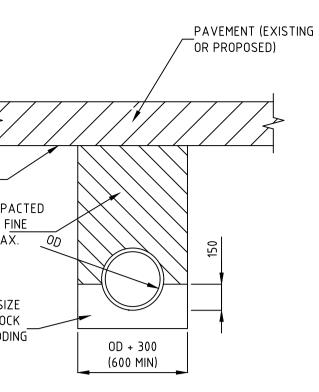

# PIPE TRENCH UNDER PAVEMENT

NOT TO SCALE

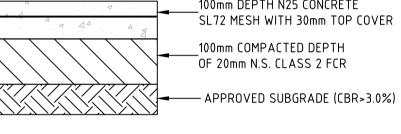


100mm DEPTH N25 CONCRETE SL72 MESH WITH 30mm TOP COVER 100mm COMPACTED DEPTH OF 20mm N.S. CLASS 2 FCR

# CONCRETE FOOTPATH PAVEMENT

NOT TO SCALE- PROVIDE 35mm DEEP SAWCUT FOR EVERY 1.5m SPACING AND CONSTRUCTION JOINT FOR EVERY NEW POUR REFER STRUCTURAL DRAWING FOR ISOLATION JOINT DETAILS

C This drawing is copyright to Intrax Consulting Engineers

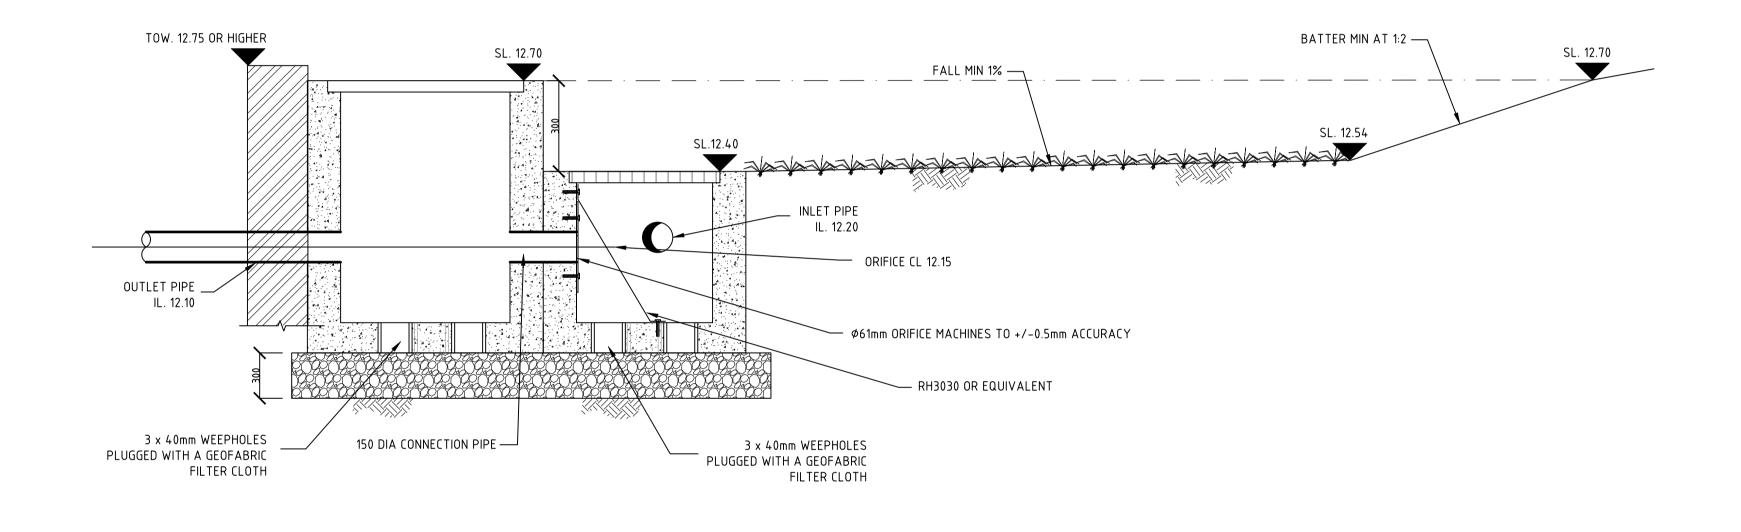

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DATE: 05/07/21

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ADDRESS: Lot 7, 45 Warriewood Road, Warriewood 2102.



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