


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Cut and Fill Plan 1:200

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9 9	В	19/05/2025	Changes as per Council Letter
DITED	Α	24/01/2025	Issue for DA
DESIGNER			

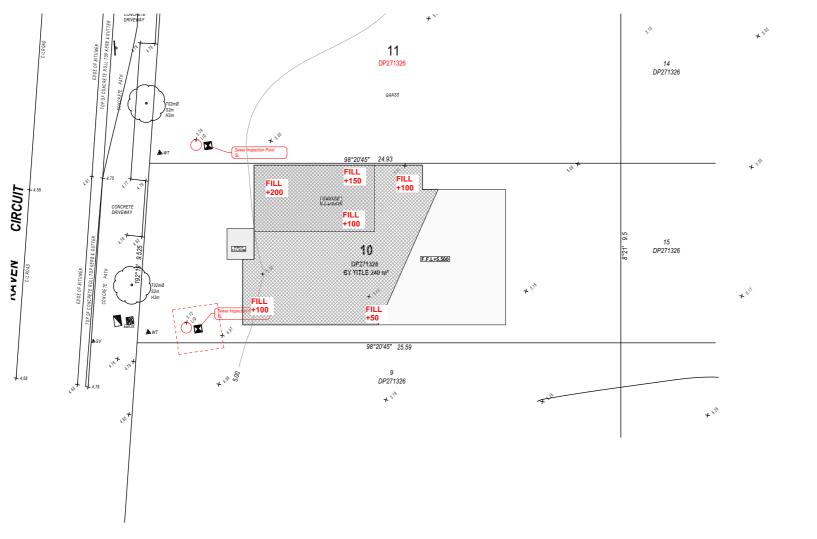

DRAWING : Cut and Fill Plan		
CLIENT:	Skymark Luxury Living Pty	
PROJECT :	DOUBLE STOREY DWELLIN	

CLIENT:	Skymark Luxury Living Pty Ltd
PROJECT :	DOUBLE STOREY DWELLING
	#10,Raven circuit,Warriewood
	Lot-10 D.P 271326

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PROJECT NO. 2411 791 ISSUE


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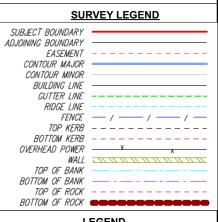
SITE CALCUALTIONS			 	1
Name	Area SQM	CROSSOVER	Driveway	GARAGE
te Area	240.00	-	5,522 11.3%	<u> </u>
andscape Area	84.81			+5,414
		,		624
		_ <u></u>	+4,790	
			Driveway gradient	
			1:100	



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SYMBOLS:		ABBREVIATIONS:
BENCHMARK	A	R - ROTTOM WINDOWS
ELECTRICITY BOX	e	BM - BENCHMARK
GATE	0-0	EL - ELECTRICAL POLE
		FF - FIRST FLOOR
SIGN	_	FL - FLOOR LEVEL
HYDRANT	Ø	G - GAS VALVE
	- T	GF - GROUND FLOOR
KERB OUTLET/IL	+	GM - GAS METER
MAIL	≥	GU - GUTTER RL
		H - HYDRANT
STOP VALVE	Δ	IL - INVERT LEVEL
WASTEWATER CONTROL PIT		KO – KERB OUTLET IP – LIGHT POLF
	60	LP - LIGHT POLE MB - MAII BOX
WASTEWATER CONTROL TANK		MB - MAIL BUX PP - POWFR POLF
WATER METER	MM.	R - ROOF LINE
WATER TAP	A	RL - REDUCED LEVEL
WATER TAP	A.	RR - ROOF RIDGE
POWER POLE		S - SEWER CONNECTION
SEWER MANHOLE		SF - SECOND FLOOR
SEWER MAINTULE	(8)	SL - SURFACE LEVEL
S/W GRATE		SV - STOP VALVE
TELSTRA PLT		SVP - SEWER VENT PIPE
IELSTRA PIT	-	I - TOP WINDOWS
UNCLASSIFIED PIT	U	TW - TOP OF WALL
	_	WT - WATER TAP
TREE & TRUNK	(\cdot)	WM - WATER METER

LEGEND				
Ref.img	Ref.img Mark Name			
0	S.A	Smoke Alarm (AS3786 Hard Wired to Mains)		
	R.W.T	Rain Water Tank		
	E.M	Electric Meter		
	A/C	Air Conditioner		
L NA/		Wall Mounted Hot water System		
	P.O.S	Private Open Space		
	FW	Floor Waste		
\boxtimes	MV	Mechanical Ventilation (All vent to exhaust outside).		
	ME	Mechanical Ventilation (All vent to exhaust outside).		

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Zero Damage - Zero Harm

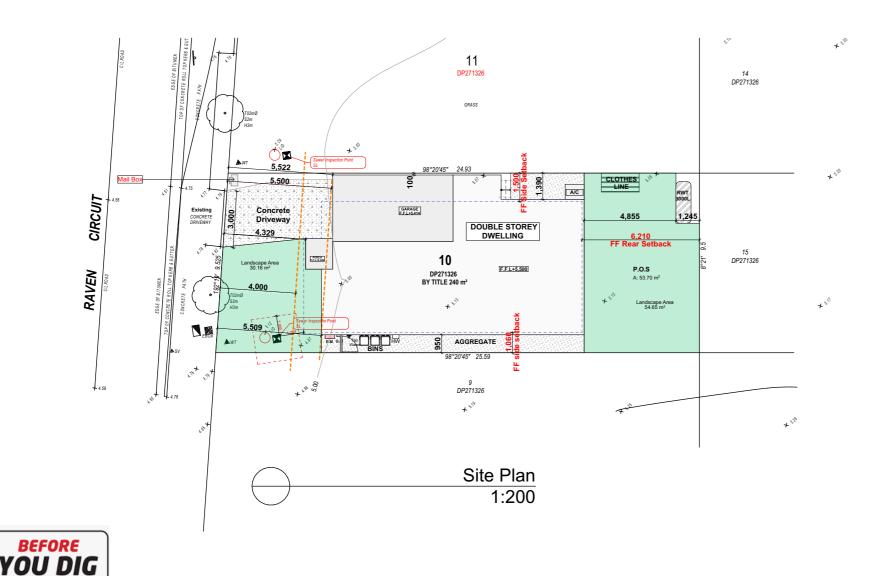Site Area

Landscape Area

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DRAWING	:Site Plan
CLIENT :	Skymark Luxury Living Pty Ltd

PROJECT: DOUBLE STOREY DWELLING #10,Raven circuit,Warriewood Lot-10 D.P 271326

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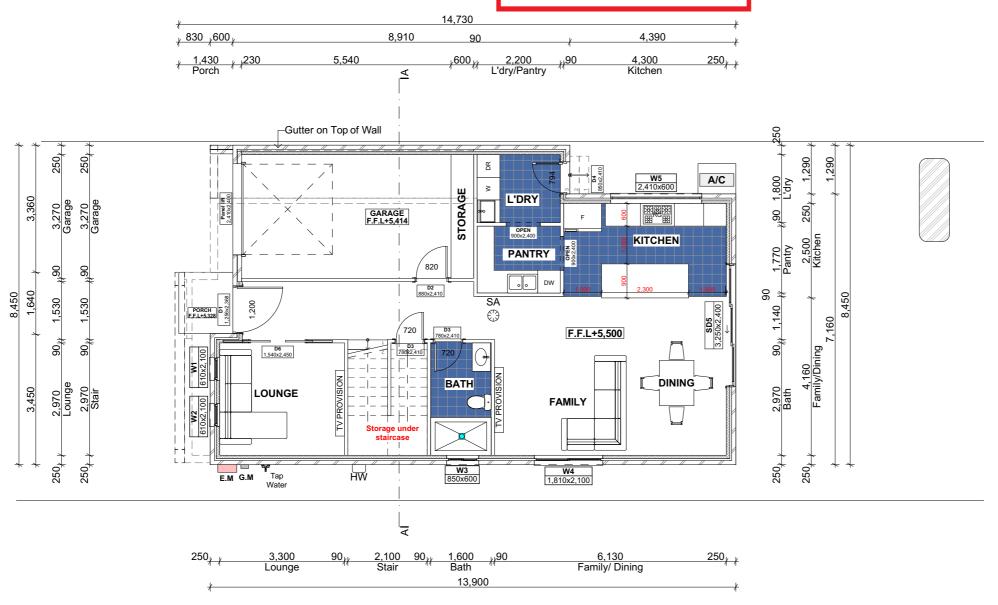
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PROJECT NO. 2411 791 ISSUE

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External Walls with vapour permeable membrane as per manufacturer detail.





LEGEND			
Ref.img	Mark	Name	
(3)	S.A	Smoke Alarm (AS3786 Hard Wired to Mains	
	R.W.T	Rain Water Tank	
	E.M	Electric Meter	
	A/C	Air Conditioner	
	HW	Wall Mounted Hot water System	
	P.O.S	Private Open Space	
	FW	Floor Waste	
\boxtimes	MV	Mechanical Ventilation (All vent to exhaust outside).	
\searrow	ME	Mechanical Ventilation (All vent to exhaust outside).	

5





Ground Floor

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DRAWING : Ground Floor Plan	
CLIENT: Skymark Luxury Living Pty Ltd	-
PROJECT: DOUBLE STOREY DWELLING	
#10 Payen circuit Warriewood	

Lot-10 D.P 271326

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Selected Cladding with vapour permeable membrane as per manufacturer detail.





250_{/ / /}200 4,030 90_{//} 2,100 90_{//} 3,230 /600_{//}90 3,300 /600_{//}140 M-bed-1 Stair Bed-2 Bed-4

2. First Floor 1:100

	LEGEND			
Ref.img	Mark	Name		
0	S.A	Smoke Alarm (AS3786 Hard Wired to Mains)		
	R.W.T	Rain Water Tank		
	E.M	Electric Meter		
	A/C	Air Conditioner		
	HW	Wall Mounted Hot water System		
	P.O.S	Private Open Space		
	FW	Floor Waste		
\bowtie	MV	Mechanical Ventilation (All vent to exhaust outside).		
	ME	Mechanical Ventilation (All vent to exhaust outside).		

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DRAWING : First Floor Plan	
CLIENT: Skymark Luxury Living Pty Ltd	
PROJECT: DOUBLE STOREY DWELLING	
#10 Rayon circuit Warriewood	

Lot-10 D.P 271326

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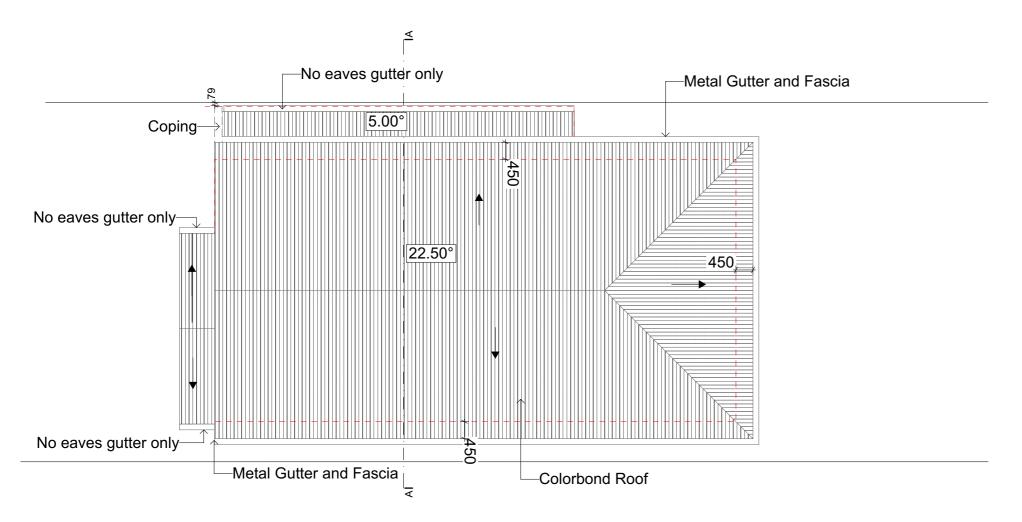
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PAGE NO: 6

PROJECT NO.


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DRAWING : Roof Plan	I
CLIENT: Skymark Luxury Living Pty Ltd	-
PROJECT: DOUBLE STOREY DWELLING	
#10,Raven circuit,Warriewood	

Lot-10 D.P 271326

Figure Notes


1. Min 20 mm gap maintained between insulation and sarking 2. Eave ventilation opening in accordance with Table 10.8.3.

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Fig. 10.8.3(explanatory)Example of roof space with low level ventilation
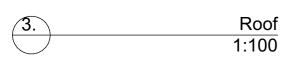
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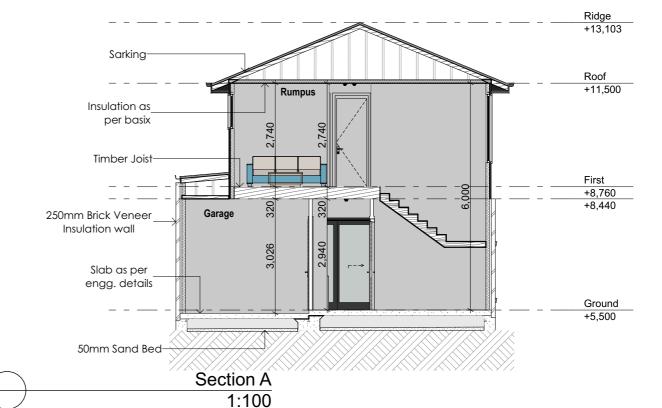
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West Elevation (Front) 1:100



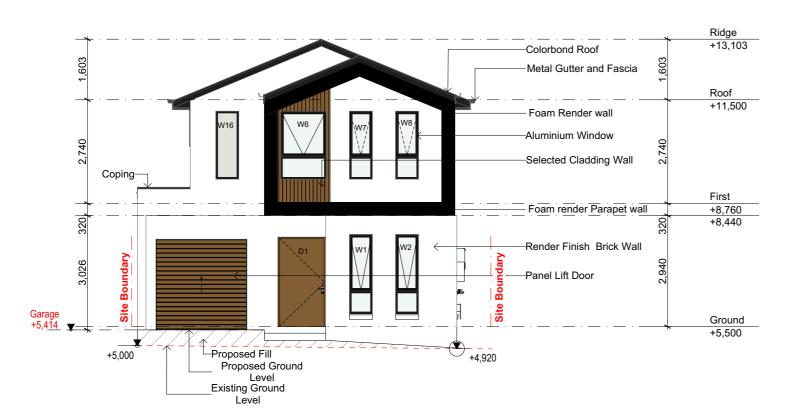

East Elevation (Rear)

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DRAWING : Elevations & Section	G
CLIENT: Skymark Luxury Living Pty Ltd	SCAL
PROJECT: DOUBLE STOREY DWELLING	1:100
#10,Raven circuit,Warriewood	PAGE

Lot-10 D.P 271326

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SCALE: 1:100	APPLICATION : DA	ISSUE
AGE SIZE A3	PAGE NO:	В

8.5m (max building height) Ridge -Colorbond Roof +13,103 22.50° 22.50° Metal Gutter and Fascia No eaves gutter only Roof +11,500 Aluminium Window -Selected Cladding Foam Rendered wall -Colorbond Roof -Gutter on Top of Wall First 8,096 Building height +8,760 -Face Brick Wall Ground +5,500 +5,110 Existing Ground +5,000 Level

North Elevation (left Side)

8.5m (max building height)





South Elevation (Right Side) 1:100

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JRAWING	:Side Elevations	GS
CLIENT:	Skymark Luxury Living Pty Ltd	SCALE:
PROJECT :	DOUBLE STOREY DWELLING	1:100
	#10,Raven circuit,Warriewood	PAGE SIZE
	Lot-10 D P 271326	A3

Lot-10 D.P 271326

Door Shedule								
Element ID	D1	D2	D3		D3/L.up	D6	OPEN	OPEN
Wallhole Dimensions (W x H)	1,256×2,368	880×2,410	780×2,410	780	0×2,410	1,540×2,450	800×2,400	900×2,400
Leaf Dimensions	1,200×2,340	820×2,340	720×2,340	72	0×2,340	1,440×2,340		
Elevation					<-¬			
Quantity	1	5	4		1	1	1	2
Position	Exterior	Interior	Interior		Interior	Interior	Interior	Interior
			Aluminium Door Schedule					
ID	D4		Panel lift			SD5		
Frame Dimensions (W X H)	850×2,410 2,410×2,400				3,250×2,400			
Elevation	t o					← 1		
QTY	1		1			1		
Position	Exterior	Exterior Exterior Exterior						



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DRAWING	Door Schedule & SOF	DR.
CLIENT:	Skymark Luxury Living Pty Ltd	SC
PROJECT :	DOUBLE STOREY DWELLING	

#10,Raven circuit,Warriewood A3 Lot-10 D.P 271326

RAWN BY: DATE: PROJECT NO. GS 19/05/2025 SCALE: APPLICATION DA PAGE SIZE PAGE NO:

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SCHEDULE OF FINISHES SPECIFICATION

ELEMENT

Feature Wall

F.F Walls

Render Color

Facade

Window

Roof

Gutter

Fascia

Walls

COLOUR

PGH Bricks-Botanicals-

Sandalwood

Dulux-Domino

James hardie-

Axon cladding 133mm smooth-Vivid white

Dulux-Vivid

White

Monument

Colorbond-


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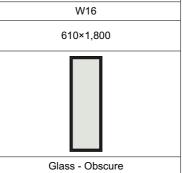
Monument

Monument

2411 791 ISSUE B

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Elevation

Glass

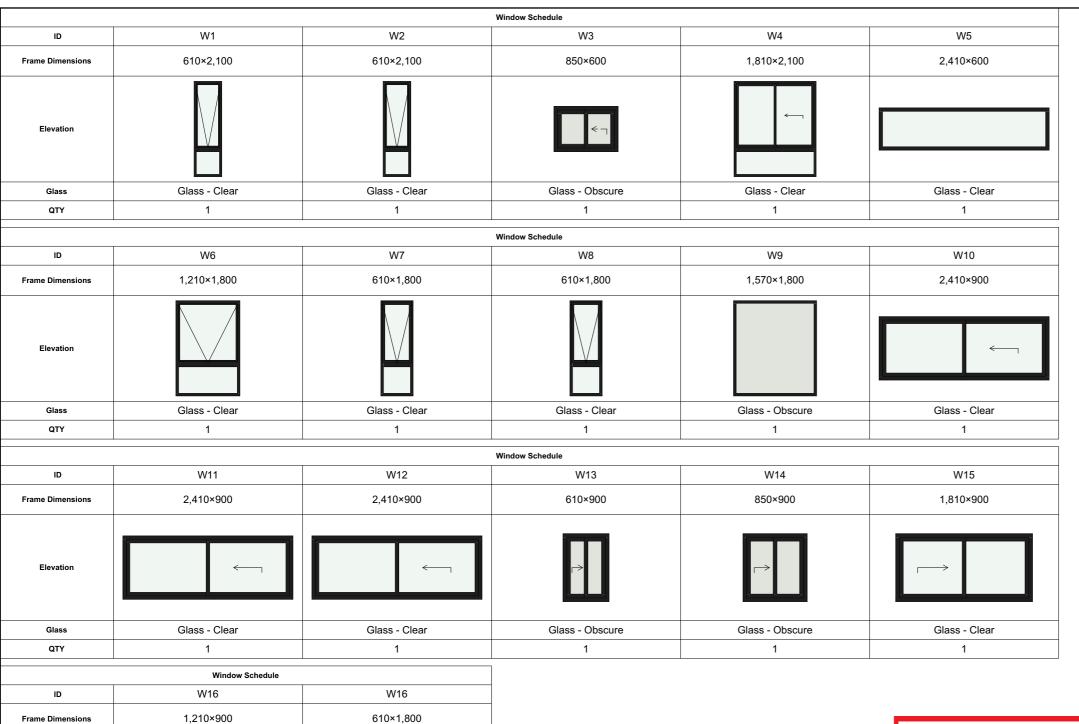QTY

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Glass - Obscure

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Α	24/01/2025	Issue for DA

DRAWING : Windows Schedule CLIENT: Skymark Luxury Living Pty Ltd

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A3

O BE CHECKED AND CONFIRMED BY BUILDER ON SITE BEFORE PLACING ORDER. ALL PREVENTION FROM WINDOWS

PRESENTATION FROM WINDOWS IN ACCORDANCE WITH REQUIREMENTS OF BCA CLAUSE 19.2.5

1.2.5 If Opening withing 1700mm above the floor; and climable elements between 150 and 750 mN ove the floor, opening must be permanently restricted to 125mm; or fitted within a non foodble robust screen. If opening between 865 and 1700mm above the floor; and no climable elements between 15d 760mm bove the floor, opening must be restricted to 125mm; or fitted with a removable of 150 mm.

bust screen.

If opening between 865 of the floor; and climable elements between 150 and 760mm above efforting within a non-removable robust screen.

If no opening within 1700mm of the floor. No restrictions apply.

Part 3.9.2.6 Protection of openable windows - bedrooms
(a) A window opening in a bedroom must be provided with protection, where the floor below the window is 2 m or more above the surface beneath.
(b) Where the lowest level of the window opening covered by (a) is less than 1.7 m above the floor, the window opening.

) Where the lowest level of the window opening covered by (a) is less than 1.7 m above to or, the window opening ust comply with the following:
The openable portion of the window must be protected with) a device capable of restricting the window opening; or
a screen with secure fittings.
A device or screen required by (i) must) not permit a 125 mm sphere to pass through the window opening or screen; and resist an outward horizontal action of 250 N against thea) window restrained by a device; or b) screen protecting the opening; and
) have a child resistant release mechanism if the screen or device is able to be removed, locked or

erridden. Where a device or screen provided in accordance with (b)(i) is able to be removed, unlocked or erridden, a barrier the height not less than 865 mm above the floor is required to the openable window in dition to window

otection.

) A barrier covered by (c) must notpermit a 125 mm sphere to pass through it; and
) have any horizontal or near horizontal elements between 150 mm and 760 mm above the floo

3.9.2.7 Protection of openable windows - rooms other than bedrooms
a) A window opening in a room other than a bedroom must be provided with protection where
he floor below the window
s 4 m or more above the surface beneath.
b) The openable part of the window covered by (a) must be protected with a barrier with a
neight of not less than 865
nm above the floor.
c) A barrier required by (b) must noti) permit a 125 mm sphere to pass through it; and
ii) have any horizontal or near horizontal elements between 150 mm and 760 mm above the floor
hat facilitate


PROJECT NO. 2411 791 ISSUE

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PROJECT: DOUBLE STOREY DWELLING #10,Raven circuit,Warriewood

Lot-10 D.P 271326

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SPECIFICATION NOTES PLANTING MATERIALS

Imported planting mix to planting beds is to comprise an approved soil mix of:

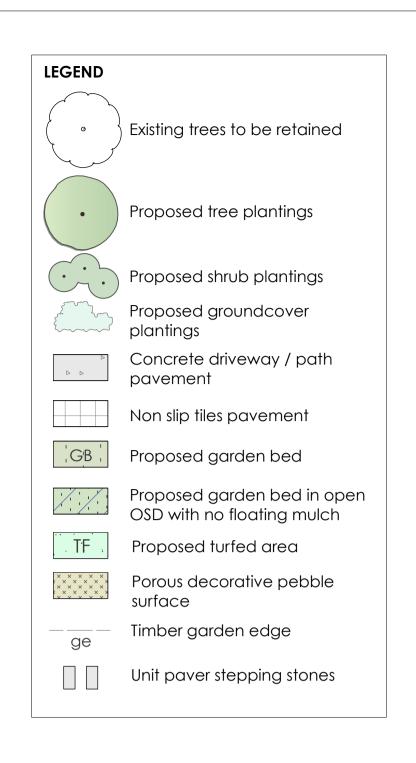- 60% Soil mix (75% coarse sand and 25% blacksoil)
- 10% Mushroom compost
- 10% Composted sawdust
- 10% Pine bark fines
- 10% Composted manure

Mulch shall mean hardwood (25mm grade), free from material derived from Privet, Willow, Poplar, Coral trees, or other noxious weeds. Any mulch exceeding the 25mm grade shall be rejected / removed from the site. Graded hardwood mulch to be supplied by Australian Native Landscapes Pty Ltd Phone (02) 9450 1444, or approved equivalent.

Plant Material: All plant material must be true to the species. No substitutes will be allowed. All plants shall be free of fungus and insect damage. All plants shall be healthy, well shaped, not soft or force grown and not

root bound. Plants are available from **Andreasens Green** wholesale nursery, contact Darren (02) 8777 4713, email darren@andreasensgreen.com.au or approved equivalent.

prior to turfing.

Turfed areas:

with staggered joins, flush with adjacent surfaces and have even running falls to all drainage points. All new turfed area shall have a minimum 150mm depth of weed free top soil, placed and levelled

All new turfed areas are to be selected weed free Soft Leaf Buffalo. Turf shall be laid neatly butted

PREPARATION AND HARDWORKS **Excavating for Spot Planting**

To planting areas, excavate a hole for each plant large enough to provide not less than twice the depth and twice the diameter than the root ball of species to be planted.

Use durable hardwood, straight, free from knots or twists, pointed at one end. Drive stakes into the ground a minimum one third of their length, avoiding damage to the root system.

• 45 Litre trees in 2 x 38x38x1800mm Hardwood Stake with double Nylon tie

TIES: Provide a 50mm wide Nylon webbing tie per stake, fixed securely to the stakes, one tie at half the height of the main stem and the other as necessary to stabilise the plant. Loose Nepean River Pebble

MATERIAL: Nepean river pebble gravel to be of uniform size or graded material in the size 20mm grade to nominal 75mm thickness as available from Australian Native Landscapes. Ph: (02) 9450

Timber Edge

MATERIAL: Timber edging shall consist of:

Edging: 100 x 50mm hardwood Pegs: 50 x 50 x 400mm hardwood.

Fastenings: to be 75x3.75mm diam. galvanised nails


INSTALLATION: Setout alignment of timber edges on site for approval of Superintendent. Excavate to approved alignment and place edge band within trench to confirm peg locations. Install pegs and affix timber edge in accordance with details. All timber edging to finish flush with adjoining turf.

MAINTENANCE / PLANT ESTABLISHMENT

- Landscape Contractors to provide 12 months for maintenance / plant establishment period. Carry out recurrent works of a maintenance nature including, but not limited to, watering, mowing, weeding, rubbish removal, fertilising, pest and disease control, returfing, staking and tying, replanting, cultivating, pruning, hedge clipping, top dressing, and keeping the site neat and tidy.

- NOTE: - All finished levels are to be verified by Contractor on site.
- All landscape works be in strict accordance with Council's landscape code and guidelines
- This plan to be used in conjunction with all other submitted architectural, hydraulics and


engineering drawing where applicable.

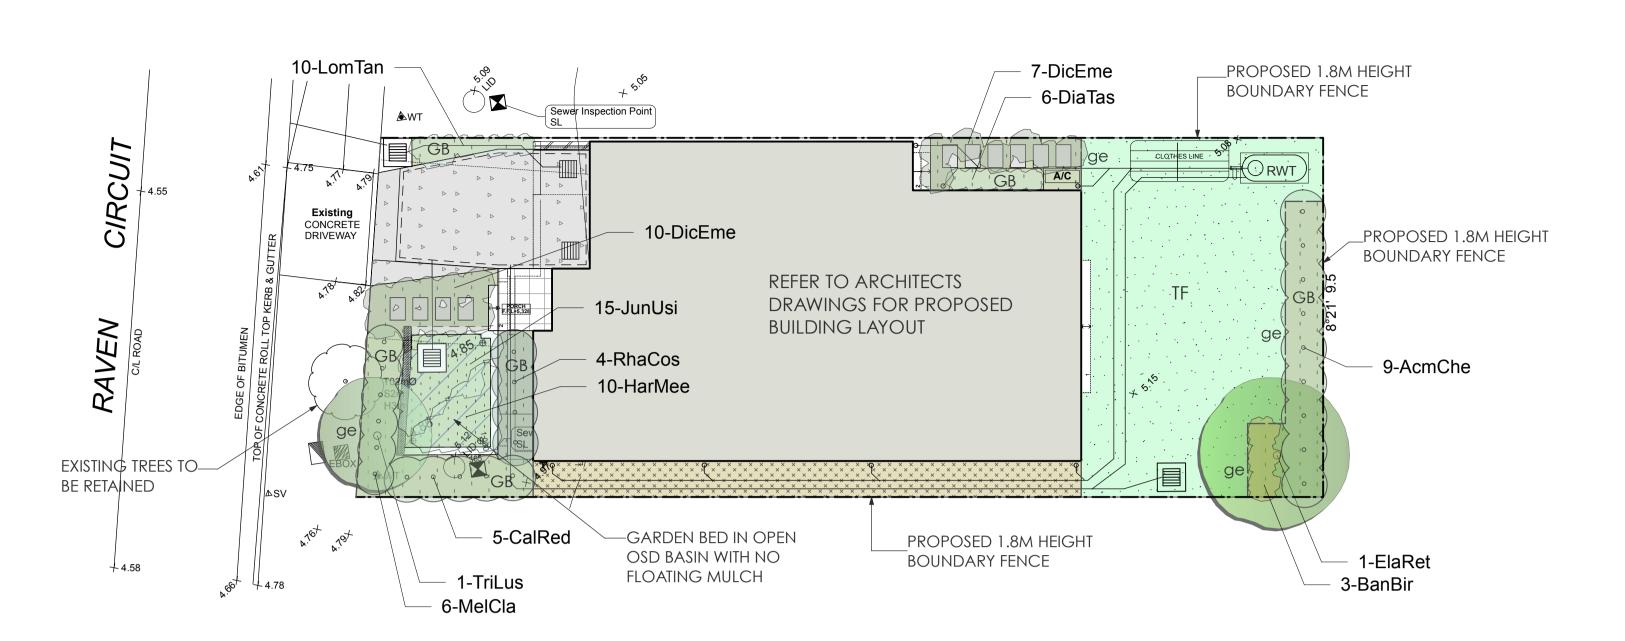



Plant Sche	edule						
ID Qty		Common Name	Botanical Name	Size	Mature Height	Mature Spread	Native (N)
Trees							
ElaRet	1	Blueberry Ash	Elaeocarpus reticulatus	45Litre	8 - 10m	3 - 4m	N
TriLus	1	Water Gum	Tristaniopsis laurina 'Luscious'	45Litre	6 - 8m	3.5 - 6m	N
Shrubs							
AcmChe	9	Forest Flame	Acmena 'Cherry Surprise'	200mm	3.0 - 5.0m	1.2 - 1.5m	N
CalRed	5	Red Alert Bottle Brush	Callistemon 'Red Alert'	200mm	1.0 - 1.5m	2.0 - 3.0m	N
MelCla	6	Claret Tops Honey Myrtle	Melaleuca 'Claret Tops'	200mm	0.9 - 1.1m	0.6- 1.0m	N
RhaCos	4	Cosmic White Rhaphiolepis	Rhaphiolepis indica 'Cosmic White'	200mm	1.5 - 2.0m	1.2 - 1.5m	
Ground C	overs						
JunUsi	15	Tussock Rush	Juncus usitatus	150mm	0.5 - 0.7m	0.8 - 1.0m	N
HarMee	10	Meema	Hardenbergia violacea "Meema"	150mm	0.4 - 0.6m	1.5 - 2.0m	N
DicEme	17	Emerald Falls Dichondra	Dichondra 'Emerald Falls'	150mm	0.0 - 0.3m	0.9 - 1.2m	N
DiaTas	6	Flax Lily	Dianella tasmanica 'Tasred'	150mm	0.4 - 0.5m	0.4 - 0.5m	N
LomTan	10	Spiny-headed mat rush	Lomandra longifolia 'Tanika'	150mm	0.45 - 0.6m	0.6 - 0.9m	N
BanBir	3	Birthday Candle	Banksia spinulosa 'Birthday Candle'	150mm	0.45 - 0.6m	0.9 - 1.2m	N

LANDSCAPED AREA CALCULATIONS				
Total site area	240m2 (approx.)			
Total building area	111m2 (approx.)			
Total paved area	18m2 (approx.)			
(including driveway and patios)				
Total landscaped area	88m2 (approx.)			
(36.7% of site area)				

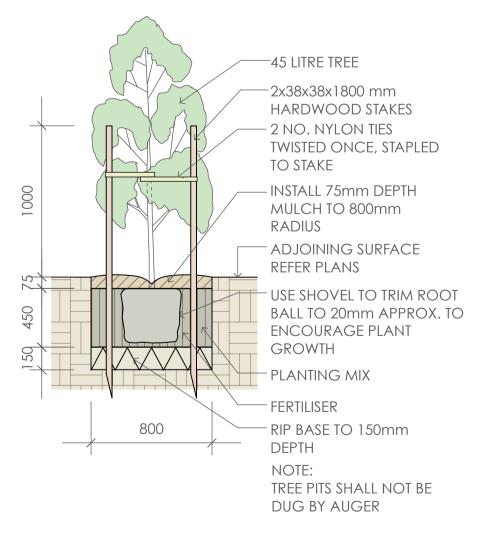



45 Litre Tree Planting
scale 1:25



- GARDEN BED

-300mm DEPTH

PLANTING MIX

SPECIFIED

RIP BASE TO

FERTILISER

150mm DEPTH

MAX 1:4 FALL

-75 mm MULCH AS

PLANS

PLANTING - REFER

GENERAL NOTES:

Do not scale of drawings. Follow written dimensions. If in doubt obtain written

from the Superintendent.

2. Verify all dimensions on site. 3. Refer to legend for all symbol and

code keys.

Read in conjunction with the specifications 5. Read in conjunction with all associated drawings

FOR DA CL 01.05.25 DRAWN DATE ISSUE AMENDMENT

GD D PROJECTS PTY LTD DRAWN:

DESIGNED: PREPARED FOR:



Greenland Design Pty Ltd ABN 73 139 152 855 Registered Landsc. Architect: Bao Ly Cecil Hills NSW 2171

PROJECT: PROPOSED RESIDENCE

Landscape Plan

DRAWING TITLE:

SCALE: 1:200 @ A3 | ISSUE:



DRAWING NO: 2953A.GD.01

MAY 2025

PROJECT ADDRESS: NO. 10 RAVEN CIRCUIT WARRIEWOOD



AUSTRAX STRUCTURAL CIVIL ENGINEERS STORMWATER MANAGEMENT PLAN AND DETAIL

10 RAVEN CIRUIT, WARRIEWOOD NSW


LEGEND:

<u>LLOLIND.</u>			
	STORMWATER LINE		
	CHARGED LINE		
SSD SSD	SUBSOIL LINE	ARRE	REVIATIONS:
330 330	STORMWATER RISING MAIN	7001	CL VIA HONS.
— SWKM SWKM SWKM SWKM	STORMWATER RISING MAIN	ø or DIA	DIAMETER
OF OF OF	OVERFLOW LINE	CL CO	CENTER LINE CLEAR OUT
swswswsw	AUTHORITY STORMWATER LINE	DGS DP e	DENSE GRADED SUB-BASE DOWNPIPE EXISTING
— s — s — s — s —	AUTHORITY SEWER LINE	FFL GTD	FINISHED FLOOR LEVEL GRATED TRENCH DRAIN
	AUTHORITY WATER LINE EXISTING STORMWATER LINE AUTHORITY ELECTRICITY LINE	GSIP IL K&G OFP OSD	GRATED SURFACE INLET PIT INVERT LEVEL KERB & GUTTER OVERLAND FLOW PATH ON—SITE DETENTION
——————————————————————————————————————	AUTHORITY UNDERGROUND ELECTRICITY LINE AUTHORITY COMMS LINE	R RCP RL RW	RADIUS REINFORCED CONCRETE PIPE REDUCED LEVEL RETAINING WALL
	FENCE LINE	RWT SMH	RAINWATER TANK SEWER MAN HOLE
	GRATED SURFACE INLET PIT	SW SV TOK	STORMWATER STOP VALVE TOP OF KERB
	GRATED SURFACE INLET PIT WITH ENVIROPOD INSERT	TOW TWL UPVC	TOP OF WALL TOP WATER LEVEL UNPLASTICISED POLYVINYL CHLORIDE
	JUNCTION PIT	UNO FF TYP	UNLESS NOTED OTHERWISE FIRST FLUSH DEVICE TYPICAL
	KERB INLET PIT	OFP RWO	OVERLAND FLOW PATH
	EXISTING GRATED SURFACE INLET PIT	© CO Ø	RAINWATER OUTLET CLEAR OUT POINT
	EXISTING JUNCTION PIT	FF Ø DDO	FIRST FLUSH
		0	DISH DRAIN OUTLET
eTEL	EXISTING KERB INLET PIT	PD Ø ØFW	PLANTER DRAIN FLOOR WASTE
e i cl	EXISTING TELSTRA PIT		CAPPING
eHYD ⊞	EXISTING HYDRANT	1.01	PIT TAG/NUMBER
eSV		⊚ RH ●	RAINHEAD DOWNPIPE DROP
	EXISTING STOP VALVE	● ●	DOWNPIPE
eGAS □	EXISTING GAS VALVE	X)-(NON RETURN VALVE WALL PENETRATION
ePP O	EXISTING POWER POLE	DP L	DOWNPIPE SPREADER
eBT		⊚ RH	RAINHEAD
eSMH	EXISTING BOUNDARY TRAP		WARNING LIGHT
	EXISTING SEWER MANHOLE	♥ 0.00	SPOT LEVELS
_		Δ	BENCHMARK

DIAL BEFORE YOU DIG SHOULD BE CONTACTED PRIOR TO ANY EXCAVATION ON SITE


TM: TRADE MARK OF THE ASSOCIATION OF DIAL BEFORE YOU DIG SERVICES LTD. USED UNDER LICENSE.

SERVICES SHOWN ON PLAN ARE INDICATIVE, EXACT DEPTH AND LOCATION TO BE CONFIRMED ONSITE. CONTRACTOR TO CARRY OUT DIAL BEFORE YOU DIG APPLICATION AND ENGAGE A REGISTERED SURVEYOR TO PEG OUT ALL EXISTING SERVICES PRIOR TO ANY WORK COMMENCING ONSITE.

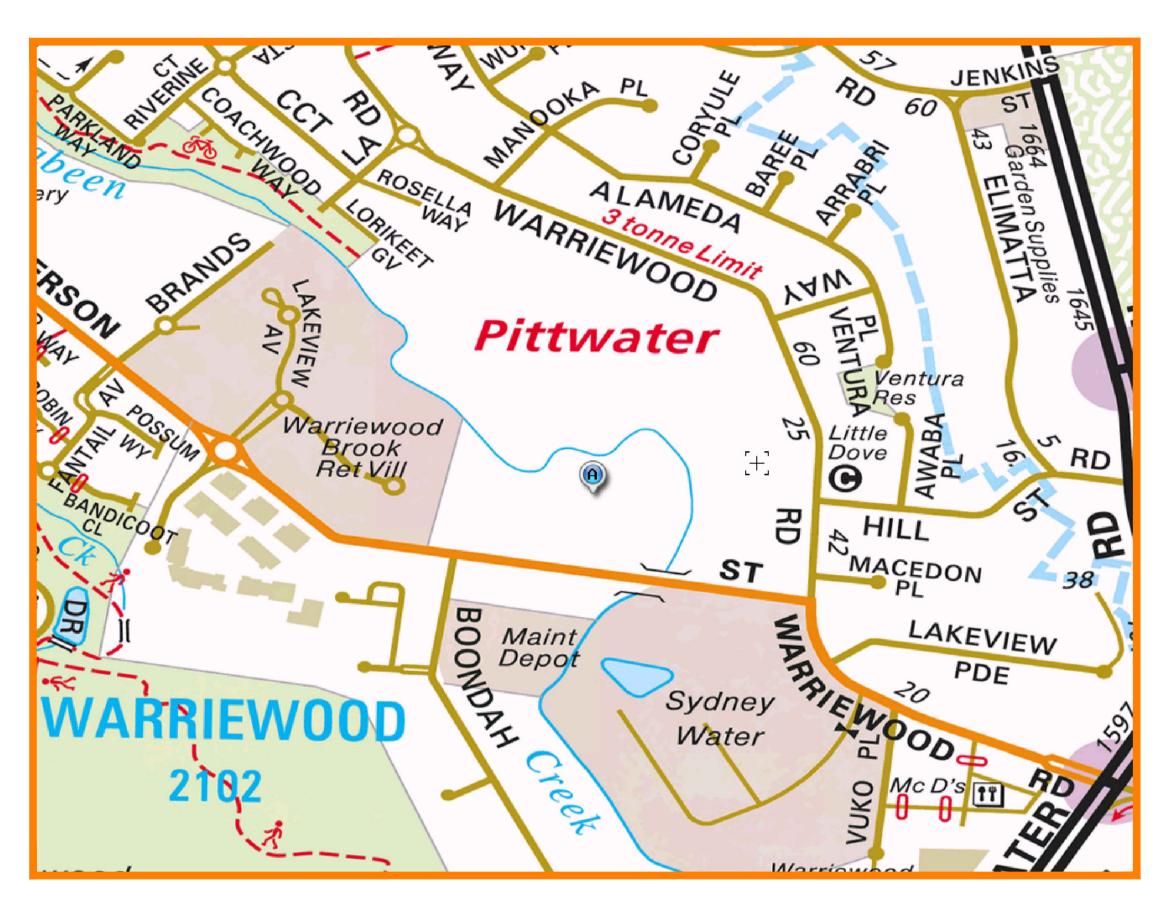

SITE LOCATION

	DRAWING REGISTER					
NUMBER	NUMBER NAME					
SWDP01	COVER SHEET	В				
SWDP02	EROSION SEDIMENT CONTROL PLAN	В				
SWDP03	STORMWATER MANAGEMENT PLAN	В				
SWDP04	STORMWATER DRAINAGE DETAILS	В				

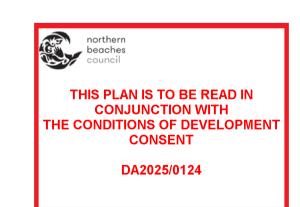

DRAINAGE NOTES:

ALL PIPES TO BE LAID ON 75mm SAND BED WITH THE BARRELS FULLY

100mm AND 150mm DIAMETER PIPES TO BE LAID ON MINIMUM 1%

MINIMUM DEPTH OF COVER FOR PIPES NOT SUBJECT TO VEHICULAR

ALL DRAINAGE PIPES LAID UNDER PAVEMENT SHALL BE REINFORCED CONCRETE WITH RUBBER RING JOINTS

BACKFILL TRENCHES WITH COMPACTED SAND OR APPROVED AGGREGATE

ALL PITS TO HAVE 600x600mm INTERNAL DIMENSIONS (U.N.O.)

SILT ARRESTORS TO HAVE 900x900mm INTERNAL DIMENSIONS

HEAVY DUTY GRATES AND COVERS ARE TO BE PROVIDED IN TRAFFICABLE AREAS

PIT GRATE TO BE TYPE WELDLOK OR APPROVED EQUIVALENT

ALL PITS SHALL BE PROVIDED WITH A LOCKING CLIP

ALL PITS SHALL BE MAINTAINED REGULARLY

TOP OF BENCHING SHALL BE TO THE HALF OF THE OUTLET PIPE

MAXIMUM FRONT ENTRY PIPE: -STRAIGHT ENTRY - Ø750 SKEW ENTRY 45° - Ø525

Ø100 SUBSOIL DRAINAGE PIPE 3000mm LONG WRAPPED IN FABRIC SOCK TO BE PROVIDED ADJACENT TO INLET PIPES

COMPRESSIVE STRENGTH f'e FOR CAST IN SITU CONCRETE TO BE A MINIMUM OF 20MPa AT 28 DAYS

PROVIDE CLEANING EYES TO ALL DOWNPIPES NOT DIRECTLY CONNECTED TO PITS

ISOLATED JOINTS TO BE PROVIDED TO ISOLATE CONCRETE PAVEMENTS

ALL TRENCH GRATES PROVIDED SHALL HAVE A MINIMUM CLEAR WIDTH

STORMWATER DRAINAGE CONNECTIONS TO THE MAIN SYSTEM SHALL BE

TO THE REQUIREMENTS AND THE SATISFACTION OF LOCAL COUNCIL

STORMWATER PIPE BEDDING/PAVING NOTES:

WHERE TRENCH BASE IS ROCK A MINIMUM OF 75mm BEDDING TO BE PROVIDED UNDER PIPE COLLARS.

STORMWATER PIPE BEDDING DETAIL TO BE IN ACCORDANCE WITH LOCAL COUNCIL REQUIREMENTS. BEDDING DETAILS TO BE CONFIRMED UPON EXCAVATION & PRIOR TO INSTALLATION OF PIPEWORK.

FOOTPATH REINSTATEMENT NOTES:

REMOVE ALL SAND FILL WITHIN THE FOOTPATH AREA TO THE EXISTING

SUPPORT ALL AUTHORITY SERVICES TO STRUCTURAL ENGINEERS DETAILS DURING EXCAVATION.

REINSTATE FOOTPATH SUBGRADE.

THE CONTRACTOR SHALL PROVIDE CERTIFICATION OF COMPACTION FROM A NATA REGISTERED TESTING AUTHORITY. MINIMUM THREE TESTS PER LAYER AS FOLLOWS:

SELECT FILL

95% MODIFIED 98% MODIFIED

SELECT FILL (LESS THAN 300mm BELOW BASE COURSE) BASE COURSE

100% MODIFIED

D	FOR CONSTRUCTION	15.05.2025	G.K.	
С	FOR CONSTRUCTION	21.04.2025	G.K.	
В	FOR CONSTRUCTION	05.04.2025	G.K.	
А	FOR CONSTRUCTION	11.01.2025	G.K.	
REV	DESCRIPTION	DATE	APP	0

Structural · Civil · Hydraulic · Flooding · Residential · Commercial

Industrial Land Development

AUSTRAX STRUCTURAL CIVIL ENGINEERS

PH: 0423095373 2/4 COLONY CLOSE, TUGGERAH NSW 671 HUNTER STREET, NEWCASTLE NSW 38 STATION STREET, BONNELLS BAY NSW

Industrial Land Development

E: info@globalceng.com.au

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D PROJECTS PROJECT

CLIENT


10 RAVEN CIRCUIT WARRIEWOOD NSW



NORTHERN

COVER SHEET FOR APPROVAL

ON APPROVI	F\L				
DATE	DESIGNED:	ENGINEER:	CHECK	KED:	
15.05.2025	G.K	G.K.	G.K.		
SCALE	PROJECT NO.	DRAWING NO.		REVISION	Ν
1:200-A3	GCE.24478	SWDP01		A	

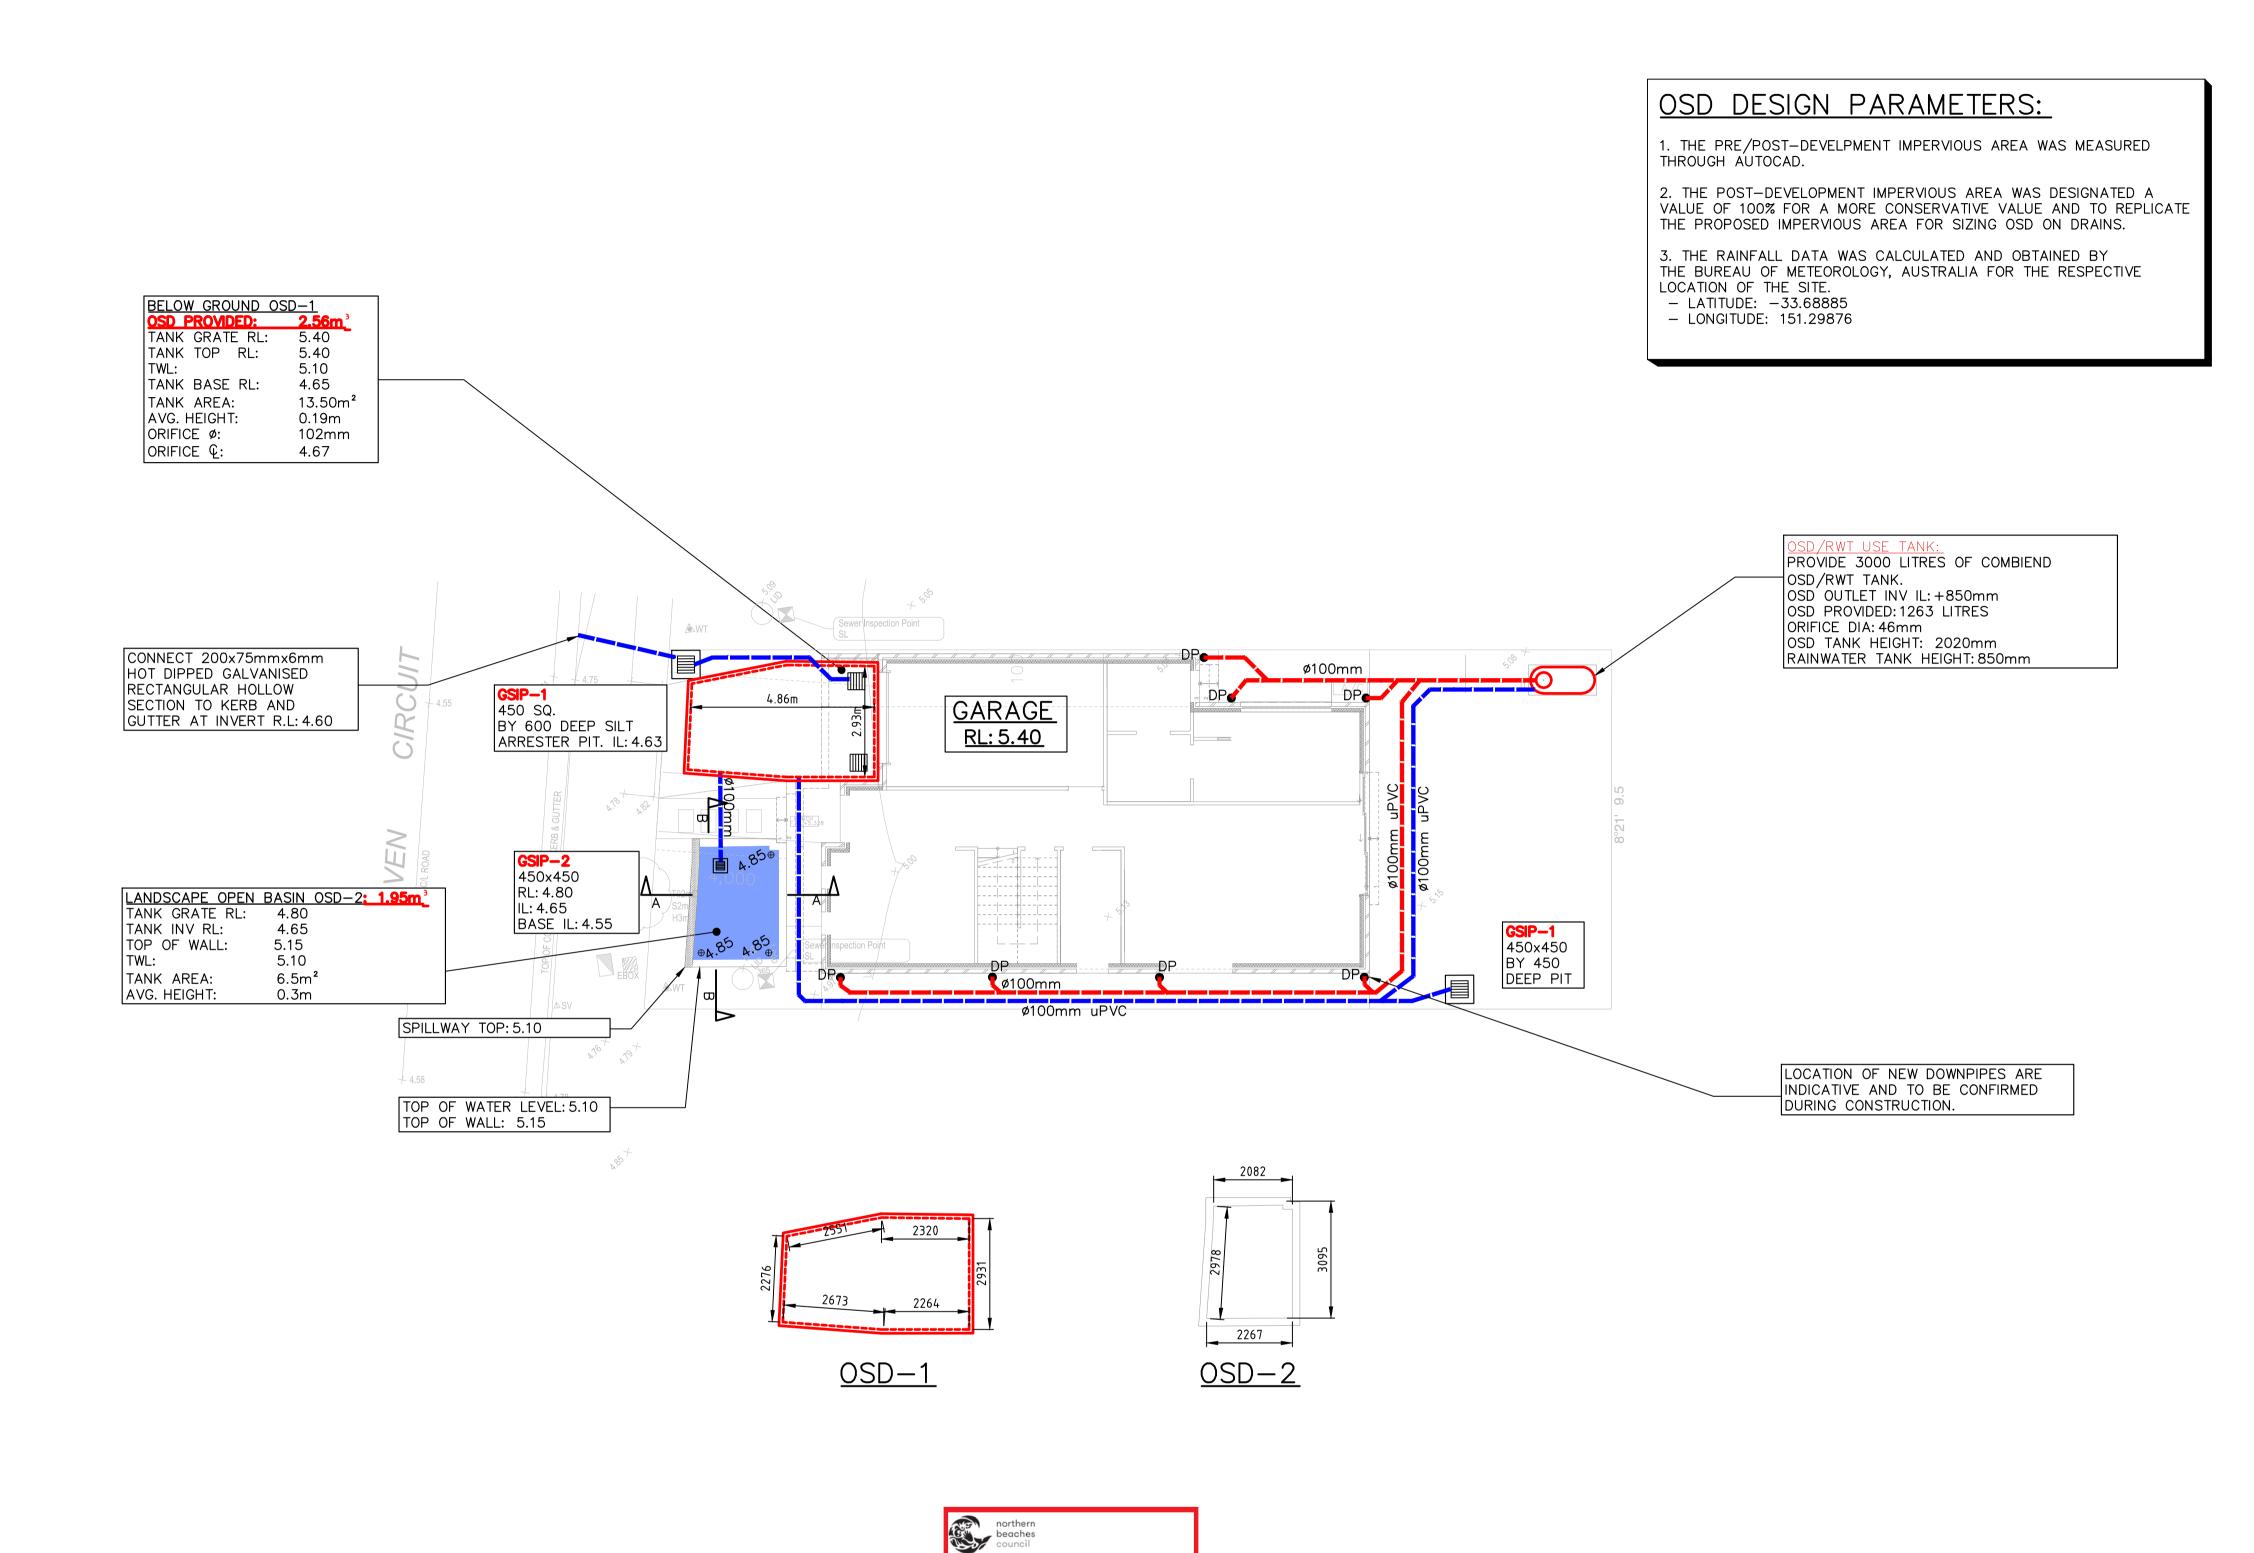

DESIGN NOTES:

THE SITE IS LOCATED IN NORTHERN BEACHES COUNCIL.

THE OSD STORAGE SYSTEM WILL BE BELOW GROUND.

OSD WAS DESIGNED USING DRAINS. THE RESULTS ARE SHOWN BELOW:

DRAINS MODELLING PARAMETERS:

THE STORAGE CAPACITY AND PERMISSIBLE SITE DISCHARGE OF THE OSD WAS CALCULATED THROUGH A DRAINS MODEL WITH REGARDS TO NORTHERN BEACHES COUNCIL DCP REQUIREMENTS LISTED BELOW;

100YR POST-DEVELOPMENT FLOWS RESTRICTED TO THE 20YR(5%AEP) PRE-DEVELOPMENT FLOWS.

PRE-DEVELOPMENT CATCHMENT = 0% IMPERVIOUS, 100% PERVIOUS. POST-DEVELOPMENT CATCHMENT = 60% IMPERVIOUS, 40% PERVIOUS.

TIME OF CONCENTRATION = 5min(s)

DRAINAGE NOTES:

ALL DOWNPIPES AND STORMWATER PIPES SHOWN ON PLAN ARE ø100mm uPVC AND SLOPE AT 1% U.N.O (TYP).

PROPOSED DOWNPIPE LOCATIONS ARE NOMINAL AND TO BE CONFIRMED DURING CONSTRUCTION (TYP).

ALL STORMWATER OSD/PITS AND PIPES TO BE A MINIMUM OF 0.6m CLEAR FROM EXISTING SEWER LINE IF PRESENT ON SITE (TYP).

INSTALL CLEAR OUT FOR INSPECTION AND MAINTENANCE PURPOSES WHERE REQUIRED (TYP).

ALL DOWNPIPES AND STORMWATER PIPES SHOWN ON PLAN ARE ø100mm uPVC AND SLOPE AT 1% U.N.O (TYP).

MINIMUM 0.6m CLEAR DISTANCE FORM EXISTING SEWER PIPE. EXISTING SERVICES SHOWN ON PLAN ARE INDICATIVE ONLY.

ALL PROPOSED STORMWATER SERVICES TO BE CONSTRUCTED AT

CONTRACTOR TO DETERMINE EXACT SIZE, LOCATION AND DEPTH BEFORE COMMENCING ANY WORKS (TYP).

CONSTRUCTION OVER EASEMENTS LOCATED ON SITE IS PROHIBITED. CONTRACTOR TO ENSURE THERE ARE NO OBSTRUCTIONS (TYP).

PROVIDE SUBSOIL DRAINAGE WITHIN LANDSCAPED AREAS & BEHIND RETAINING WALLS TO PREVENT LONG TERM SATURATION DURING PROLONGED WET WEATHER.

OSD CALCULATIONS SUMMARY. SSR = 8.8m3 OR AS CLOSE AS POSSIBLE

PSD = 3.31L/s (VALUES TO BE CONFIRMED BY COUNCIL)

SITE AREA SUMMARY: TOTAL SITE AREA = $240m^2$

TOTAL INTO OSD = $236.5m^2$ TOTAL BYPASS = $3.5m^2$

(1.45% OF TOTAL SITE AREA) VOLUME CALCULATIONS:

OSD 1 VOLUME PROVIDED = 2.56m³ OSD 2 VOLUME PROVIDED = 1.95m³ OSD 3 VOLUME PROVIDED = 1.75m³

TOTAL VOLUME PROVIDED = 6.26m³

ORIFICE SIZING CALCULATIONS:

USING ORIFICE EQUATION

ORIFICE ϕ = 21.9 x (PSD/(H)0.5)0.5 = 102mm WHERE PSD = 3.31L/s, DEPTH TO ORIFICE CL = 0.5 (H), THEREFORE PROVIDE 46mm SHARP EDGED OPENING IN

ORIEICE BLATE

D	FOR CONSTRUCTION	15.05.2025	G.K.
С	FOR CONSTRUCTION	21.04.2025	G.K.
В	FOR CONSTRUCTION	05.04.2025	G.K.
Α	FOR CONSTRUCTION	11.01.2025	G.K.
REV	DESCRIPTION	DATE	APP

AUSTRAX STRUCTURAL CIVIL ENGINEERS

THIS PLAN IS TO BE READ IN **CONJUNCTION WITH** THE CONDITIONS OF DEVELOPMENT CONSENT

DA2025/0124

PH: 0423095373 2/4 COLONY CLOSE, TUGGERAH NSW

671 HUNTER STREET, NEWCASTLE NSW 38 STATION STREET, BONNELLS BAY NSW

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CLIENT D PROJECTS

PROJECT

10 RAVEN CIRCUIT WARRIEWOOD NSW NORTHERN **BEACHES** COUNCIL

STORMWATER DRAINAGE PLAN FOR APPROVAL DESIGNED:

DATE 15.05.2025 G.K SCALE PROJECT NO.

ENGINEER: CHECKED: G.K. G.K. REVISION NO. DRAWING NO. GCE.24478 1:200-A3 SWDP03

