

ACTION PLANS

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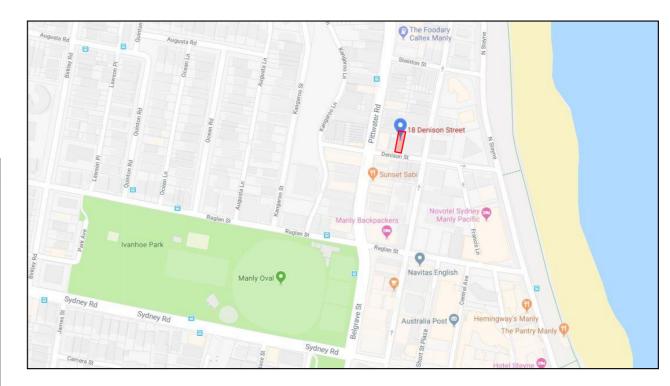
DEVELOPMENT APPLICATION

These plans are for Development Approval only.

SHEET NUMBER	SHEET NAME	DATE PUBLISHED
DA00	COVER	9/12/2019
DA01	SITE ANALYSIS	9/12/2019
DA02	SITE / ROOF / SEDIMENT EROSION / WASTE MANAGEMENT / STORMWATER CONCEPT PLAN	9/12/2019
DA03	EXISTING GROUND FLOOR PLAN	9/12/2019
DA04	EXISTING FIRST FLOOR PLAN	9/12/2019
DA05	PROPOSED GROUND FLOOR PLAN	9/12/2019
DA06	PROPOSED FIRST FLOOR PLAN	9/12/2019
DA07	NORTH / SOUTH ELEVATION	9/12/2019
DA08	EAST ELEVATION	9/12/2019
DA09	WEST ELEVATION	9/12/2019
DA10	LONG / CROSS SECTION	9/12/2019
DA11	AREA CALCULATIONS / SAMPLE BOARD	9/12/2019
DA12	WINTER SOLSTICE 9 AM	9/12/2019
DA13	WINTER SOLSTICE 12 PM	9/12/2019
DA14	WINTER SOLSTICE 3 PM	9/12/2019
DA15	BASIX COMMITMENTS	9/12/2019

ITEM DETAILS	DEVELOPMENT APPLICATION			
ADDRESS	18-20 DENISON STREET, MANLY NSW,	2095		
LOT & DP/SP	SP 85482			
COUNCIL	NORTHERN BEACHES COUNCIL (MANI	LY)		
SITE AREA	331.4m²			
FRONTAGE	10.69m			
CONTROLS	PERMISSIBLE / REQUIRED	EXISTING	PROPOSED	COMPLIANCE
CONTROLS	m / m² / %	m / m² / %	m / m² / %	
<u>LEP</u>				
LAND ZONING	R3 – MEDIUM DENSITY RESIDENTIAL	R3	R3	YES
MINIMUM LOT SIZE	250m²	331.4m²	UNCHANGED	YES
FLOOR SPACE RATIO	0.75 : 1 (248.55m²)	0.71 : 1 (227.92m²)	0.74 : 1 (242.03m²)	YES
MAXIMUM BUILDING HEIGHT	11m	7.45m	UNCHANGED	YES
HAZARDS				
ACID SULFATE SOILS	CLASS 4			
FORSHORE SCENIC PROTECTION AREA	YES			
HERITAGE CONSERVATION AREA	YES			
DCP				
RESIDENTIAL OPEN SPACE	AREA OS2			
TOTAL OPEN SPACE (TOS)	50% (165.70m²)	22.55% (74.75m²)	22.46% (74.45m²)	NO
LANDSCAPED AREA	30% OF TOS (50%): 49.71m ²	39.1 % (64.84m²)	UNCHANGED	YES
OPEN SPACE ABOVE GROUND	MAX. 40% OF TOS (50%): 66.28m ²	N/A	N/A	YES
PRINCIPAL PRIVATE OPEN SPACE	12m² per dwelling	34.45m² / 34.68m²	UNCHANGED	YES
FRONT SETBACK	PREVALING BULDING LINE (1.43m)	1.46m	UNCHANGED	YES
REAR SETBACK	8.0m	7.475m	UNCHANGED	NO
SIDE SETBACKS	1/3 WALL HEIGHT Wall 7.175/3= 2.39m	No. 18 E: 1.007m No. 20 W: 0.32m	UNCHANGED	NO
CAR PARKING SPACES	Required: 1	1	UNCHANGED	YES

18-20 DENISON STREET MANLY NSW 2095



NCC & AS COMPLIANCES SPECIFICATIONS

- EARTHWORKS: METHOD OF EXCAVATIONAND FILL - PART 3.1.1 OF NCC - SURFACE SUBSOIL-STORMWATER DRAINAGE - PART 3.1.2 OF NCC

- TERMITE-RISK MANAGEMENT - PART 3.1.3 OF NCC

- FOOTINGS & SLAB - PART 3.2 OF NCC INCLUDING AS2870 - MASONRY CONSTRUCTION - PART 3.3 OF NCC INCLUDING AS3700

- SUB FLOOR VENTILATION - PART 3.4.1 OF NCC

- FRAMING - PART 3.4 OF NCC

- ROOF, WALL-CLADDING, GUTTERS & DOWNPIPES - PART 3.5 OF NCC - GLAZING - PART 3.6 OF NCC INCLUDING AS1288

FIRE SEPARATION - PART 3.7.1 OF NCC

- SMOKE ALARMS - PART 3.7.2 OF NCC

- HEATING APPLIANCES - PART 3.7.3 OF NCC

- WET AREAS-PROTECTION OF WALLS & FLOORS - PART 3.8.1 OF NCC

- MINIMUM ROOF HEIGHTS - PART 3.8.3 OF NCC

- FACILITIES REQUIRRED & SANITARY DOOR CONSTRUCTION - PART 3.8.3 OF NCC

- LIGHT: NATURAL AND ARTIFICIAL - PART 3.8.4 OF NCC

- VENTILATION & LOCATION OF TOILETS - PART 3.8.5 OF NCC

- SOUND INSULATION - PART 3.8.6 OF NCC

- STAIR CONSTRUCTION INCLUDING DIMENSIONS - PART 3.9.1 OF NCC

- BALUSTRADES & OTHER BARRIERS - PART 3.9.2 OF NCC

- FENCING & OTHER PROVISIONS - REGS & AS1926

- DEMOLITION WORKS - AS2601-1991 THE DEMOLITION OF STRUCTURES.

- ALL WATERPROOF MEMBRANES TO COMPLY WITH WITH AS 3740-2004

- ALL PLUMBING & DRAINAGE WORK TO COMPLY WITH AS 3500 - SITE CLASSIFICATION AS TO AS 2870

- ALL PLASTERBOARD WORK TO COMPLY WITH AS 2588-1998

- ALL STRUCTURAL STEEL WORK TO COMPLY WITH AS 2500-1990

- ALL CONCRETE WORK TO COMPLY WITH AS 3600

- ALL ROOF SHEETING WORK TO COMPLY WITH AS 1562-1992


- ALL SKYLIGHTS TO COMPLY WITH WITH AS 4285-2007


ALL CERAMIC TILING TO COMPLY WITH AS 3958.1-2007 & 3958.2-1992
 ALL GLAZING ASSEMBLIES TO COMPLY WITH AS2047 & 1288


- ALL TIMBER RETAINING WALLS ARE TO COMPLY WITH AS 1720.1-2010.


AS 1720.2-2006, AS 1720.4-2006, AS 1170.1-1989 & AS 1170.4-1993

- ALL RETAINING WALLS ARE TO COMPLY WITH 3700 - 2011 & AS 3600 -2001 - ALL CONSTRUCTION TO COMPLY TO AS3959- 1991

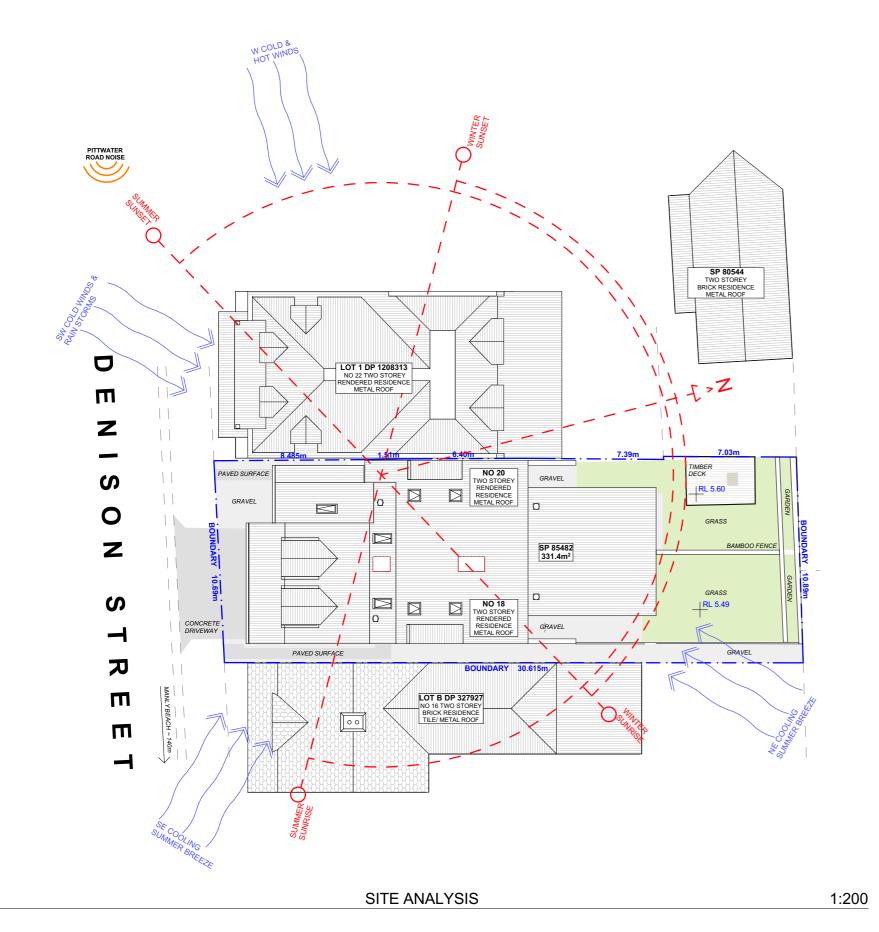

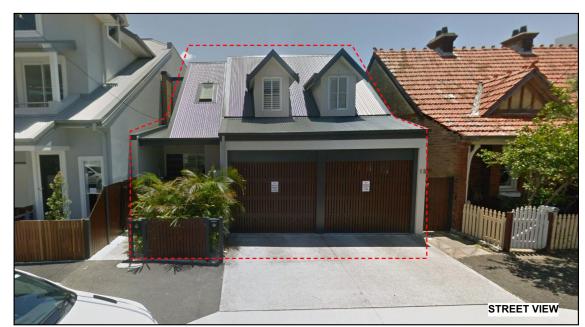

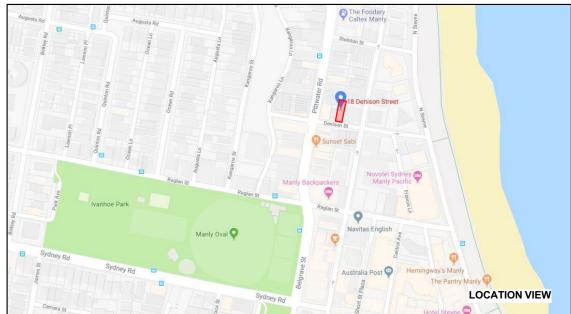


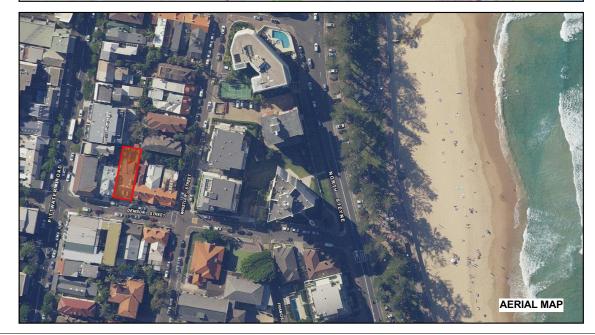

NOTE: ALL DEMOLISHED ELEMENTS TO ENG. SPECIFICATIONS AND AS. 2601 - 2001



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А	30/08/19	DEVELOPMENT APPLICATION	AL	This drawing is the copyright of Action Plans and not be altered, reproduced or transmitted in any form or by any means in part or in whole with the written permission of
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				All errors and omissions are to be verified by the Builder/Contractor and referred to the designer prior to the

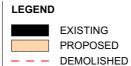

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PROJECT ADDRESS

18-20 DENISON STREET MANLY NSW 2095

DRAWING NO.


DA01


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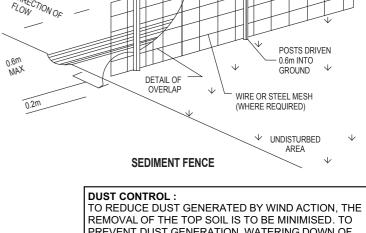
Monday, 9 December 2019

DRAWING NAME SITE ANALYSIS

SCALE 1:200 @A3



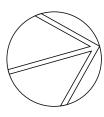

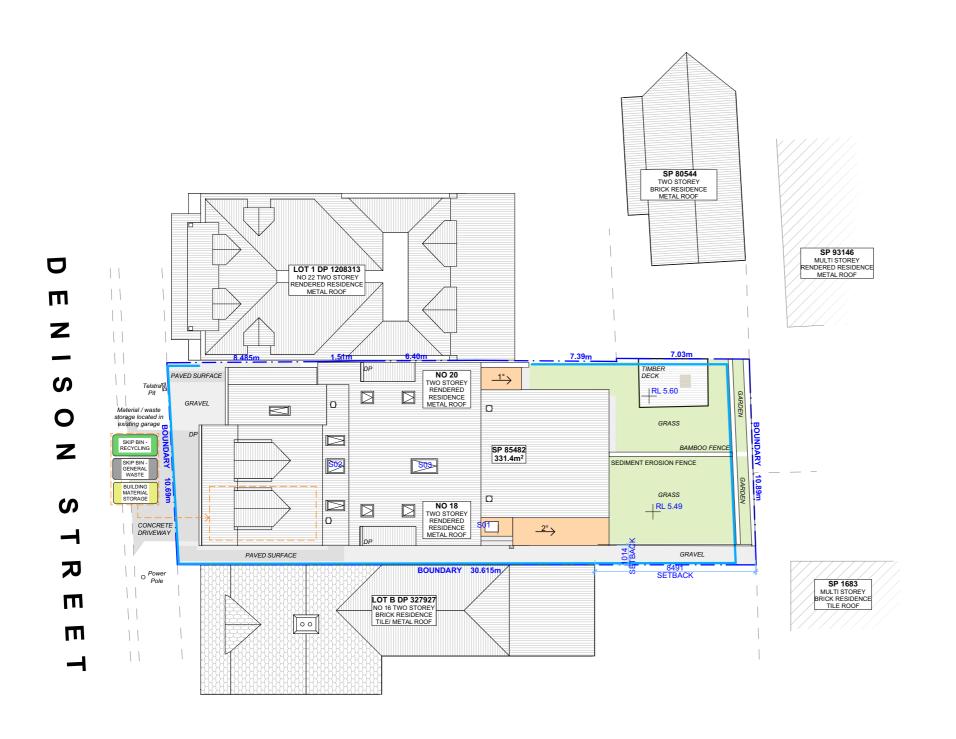

3m MAX

DISTURBED AREA

PREVENT DUST GENERATION, WATERING DOWN OF THE SITE, ESPECIALLY DURING THE MOVEMENT OF MACHINERY IS REQUIRED. WHERE EXCAVATING INTO ROCK, KEEP THE SURFACE MOIST TO MINIMISE DUST. CONSTRUCT A GRAVEL ENTRY/EXIT POINT USING BLUE METAL AND RESTRICT ALL VEHICLE MOVEMENTS WITHIN THE SITE TO A MINIMUM. ENSURE WIND BREAKS, SUCH AS EXISTING FENCES ARE MAINTAINED DURING THE CONSTRUCTION PHASE UNTIL NEW LANDSCAPING IS PROVIDED OR REINSTATED. PREVENT DUST BY COVERING STOCKPILES

SEDIMENT NOTE:

1. ALL EROSION AND SEDIMENT CONTROL MEASURES TO BE INSPECTED AND MAINTAINED DAILY BY THE SITE MANAGER.

2. MINIMISE DISTURBED AREAS, REMOVE EXCESS SOIL FROM EXCAVATEDAREA AS SOON AS POSSIBLE. 3. ALL MATERIAL STOCKPILE TO BE CLEAR FROM DRAINS, GUTTERS AND FOOTPATHS, OR WITHIN SEDIMENT FENCE AREA.

4. DRAINAGE TO BE CONNECTED TO STORMWATER AS SOON AS POSSIBLE. IF STORED ON SITE, IT MUST BE FILTERED BEFORE RELEASING INTO STORMWATER SYSTEM OR WATERWAYS.

5. ROADS AND FOOTPATHS TO BE SWEPT DAILY.

STOCKPILES:

ALL STOCKPILES ARE TO BE KEPT ON-SITE WHERE POSSIBLE. ANY MATERIALS PLACED ON THE FOOTPATHS OR NATURE STRIPS REQUIRE COUNCIL'S PERMISSION

ALL STOCKPILES ARE TO BE PLACED AWAY FROM THE DRAINAGE LINES AND STREET GUTTERS. IT IS BEST TO LOCATE THESE ON THE HIGHEST PART OF THE SITE IF POSSIBLE. PLACE WATERPROOF COVERING OVER STOCKPILES.

IF REQUIRED PROVIDE DIVERSION DRAIN & BANK AROUND STOCKPILES.

GUTTER PROTECTION:

PROVIDE PROTECTION TO DOWNHILL GRATE IN GUTTER BY MEANS OF SAND BAGS OR BLUE METAL WRAPPED IN GEOTEXTILE FABRIC. WHEN SOIL OR SAND BUILDS UP AROUND THIS SEDIMENT BARRIER, THE MATERIAL SHOULD BE RELOCATED BACK TO THE SITE FOR DISPOSAL.

NOTE: ALL PROPOSED STORMWATER TO CONNECT WITH EXISTING


SITE / ROOF / SEDIMENT EROSION / WASTE MANAGEMENT / STORMWATER CONCEPT PLAN


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LEGEND

EXISTING

PROPOSED

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DRAWING NO.

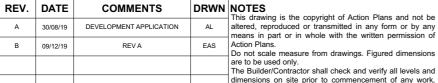DA02

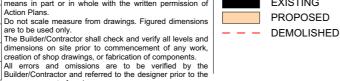DATE


Monday, 9 December 2019


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SITE / ROOF / SEDIMENT EROSION / WASTE MANAGEMENT / STORMWATER CONCEPT PLAN

SCALE

1:200 @A3



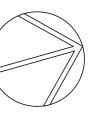

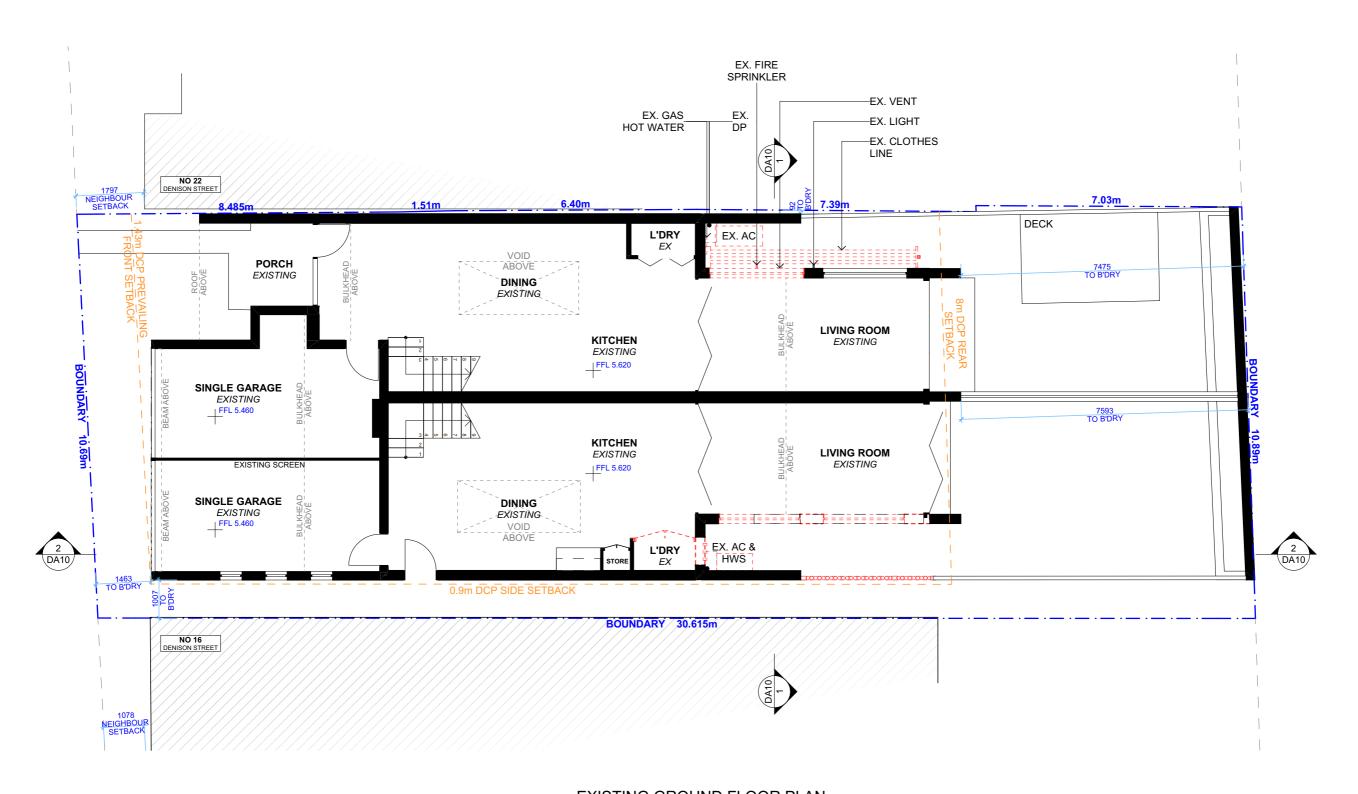1 EXISTING GROUND FLOOR PLAN 1:100

NOTE: ALL DEMOLISHED ELEMENTS TO ENG. SPECIFICATIONS AND AS. 2601 - 2001


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COMMENTS



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DRWN NOTES



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PROJECT ADDRESS 18-20 DENISON STREET MANLY NSW 2095 DA03

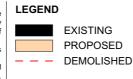
2019


EXISTING GROUND FLOOR PLAN

DATE
Monday, 9 December SCALE

DRAWING NAME

1:100 @A3

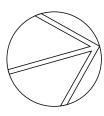

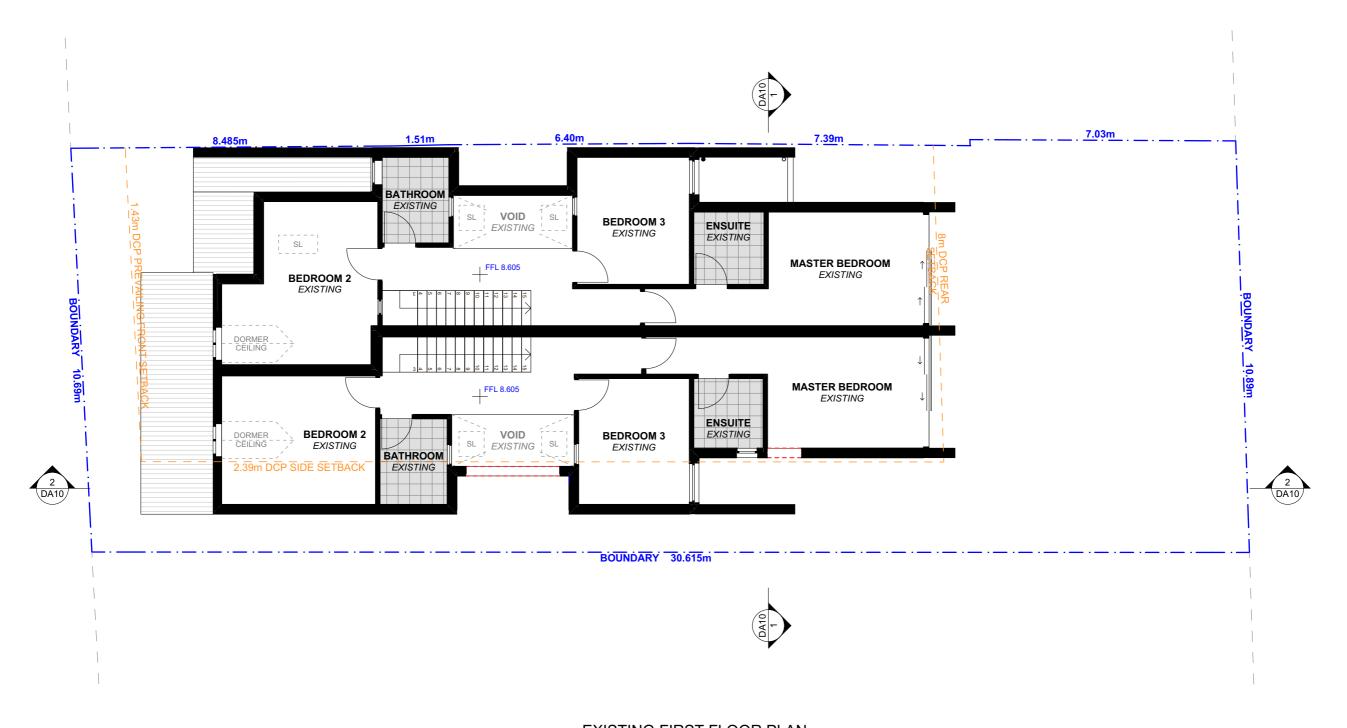

EXISTING FIRST FLOOR PLAN 1:100

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DRWN NOTES



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DA04


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Monday, 9 December 2019 SCALE 1:100 @A3

EXISTING FIRST FLOOR PLAN

DRAWING NAME




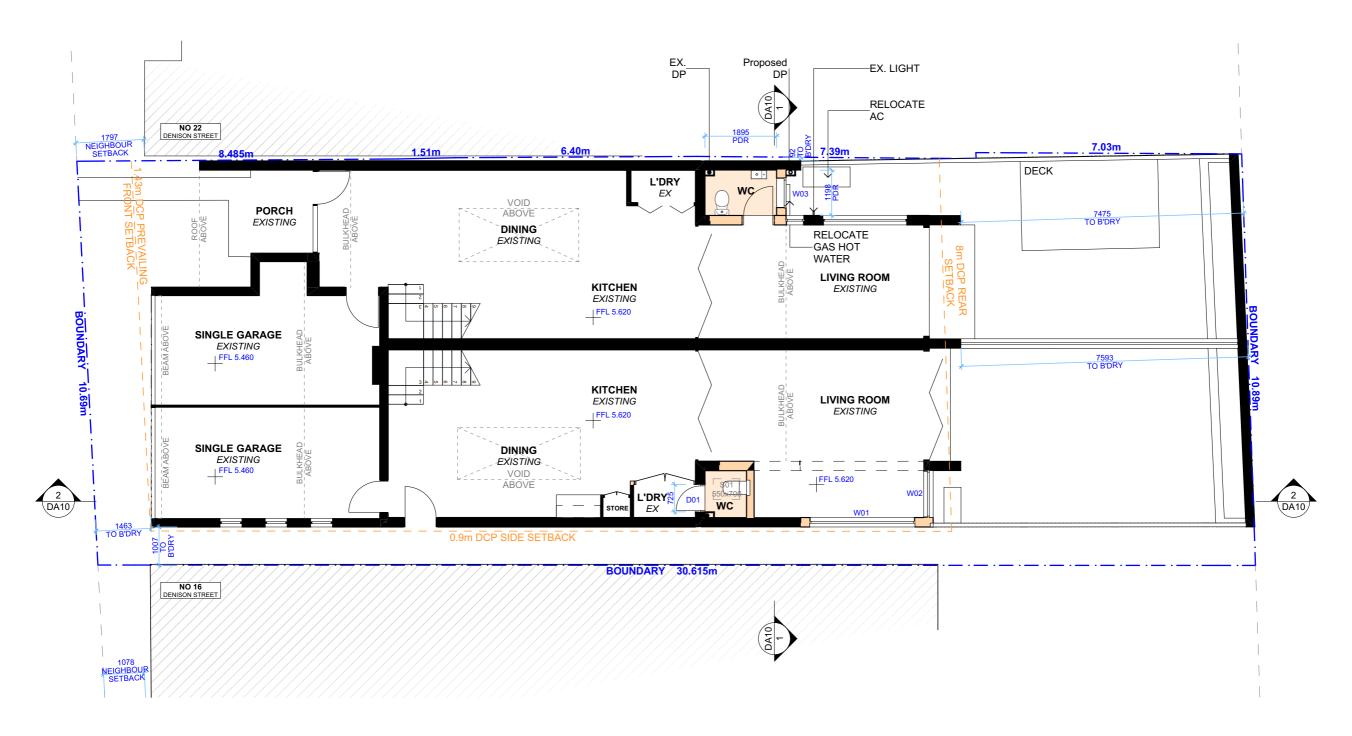


PROPOSED GROUND FLOOR PLAN 1:100



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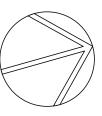
Monday, 9 December

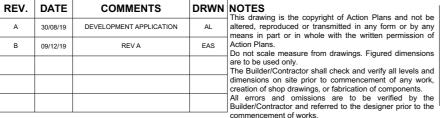
2019

PROPOSED GROUND FLOOR PLAN DATE

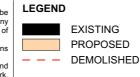DRAWING NAME

SCALE 1:100 @A3



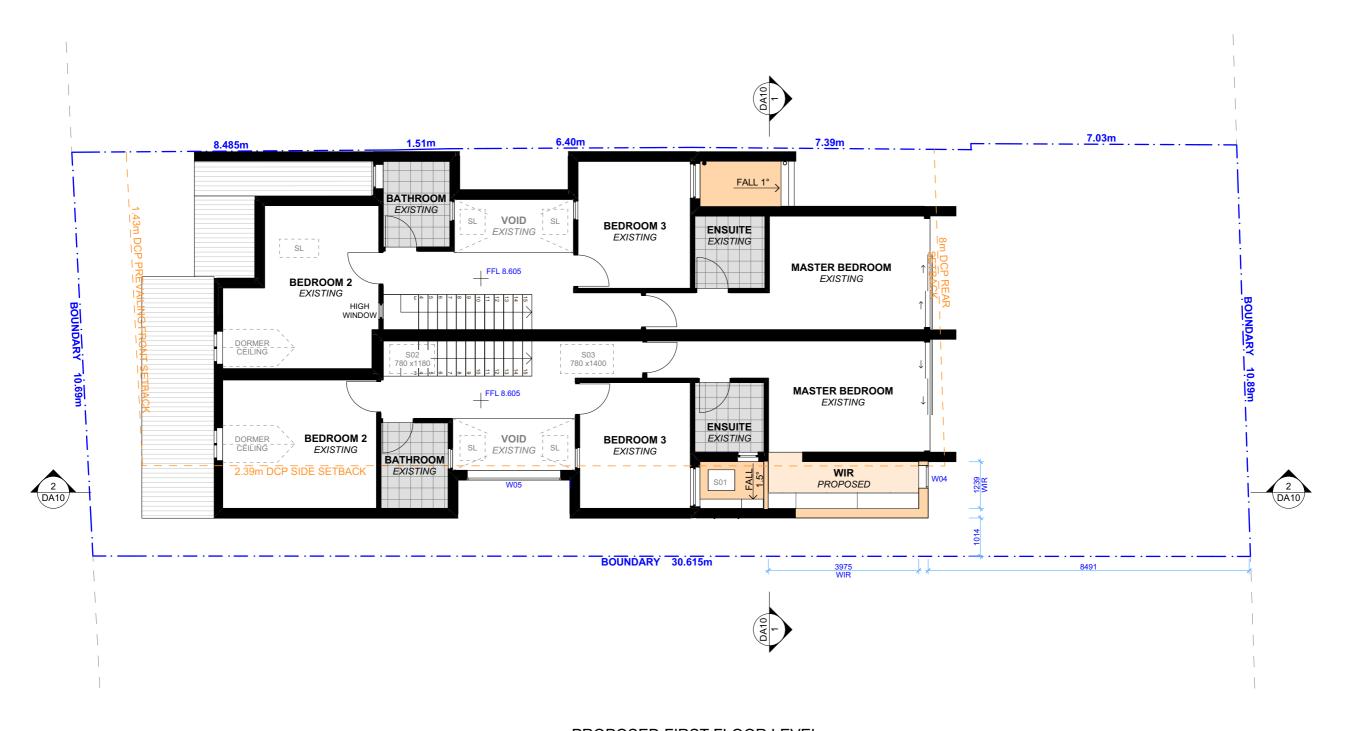


PROPOSED FIRST FLOOR LEVEL 1:100



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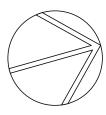
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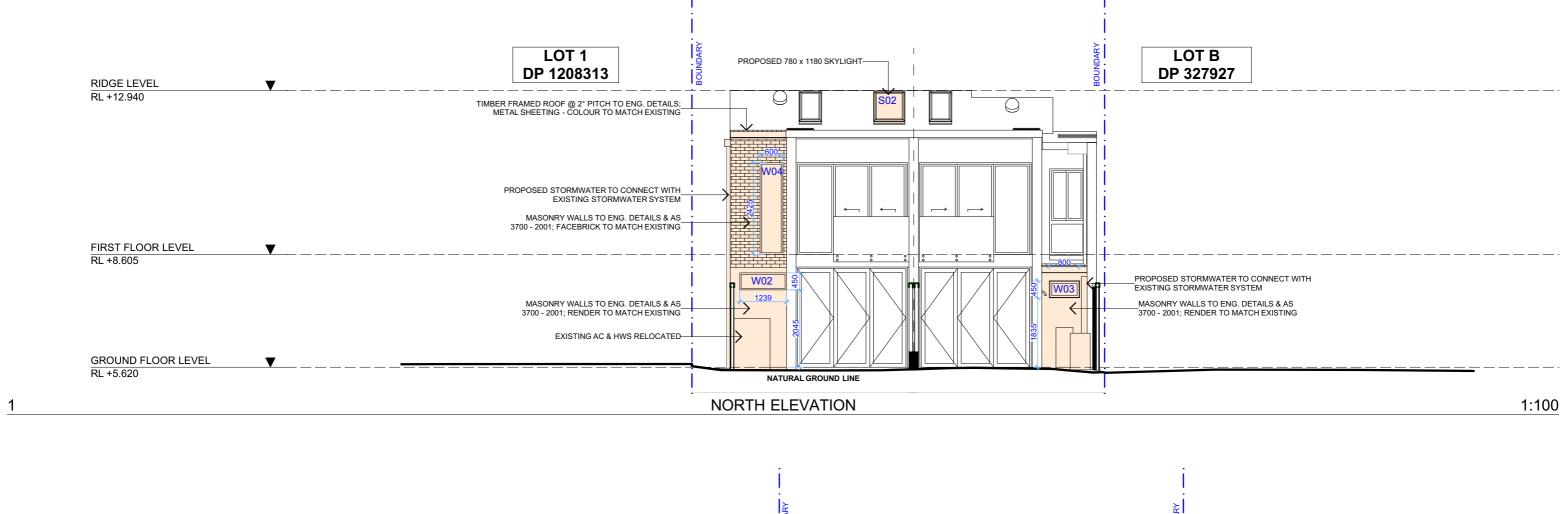
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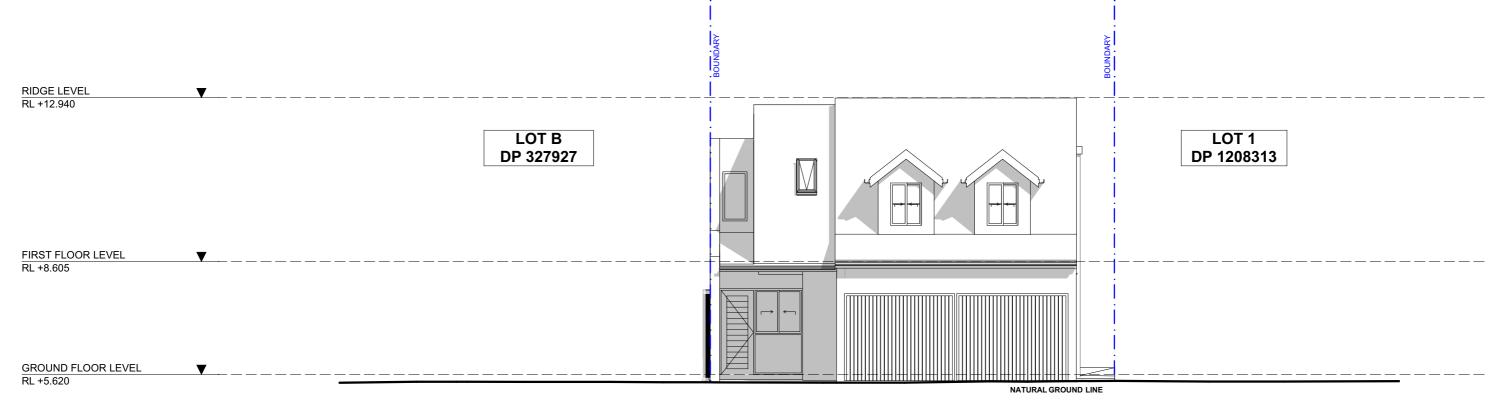
PROPOSED FIRST FLOOR PLAN DATE

DRAWING NAME
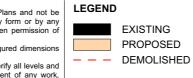
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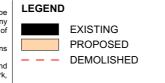


2 SOUTH ELEVATION 1:100

NOTE: NO CHANGES TO THE SOUTH ELEVATION



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2095

DRAWING NO.
DA07


DRAWING NAME

NORTH / SOUTH ELEVATION

DATE Monday, 9 December 2019


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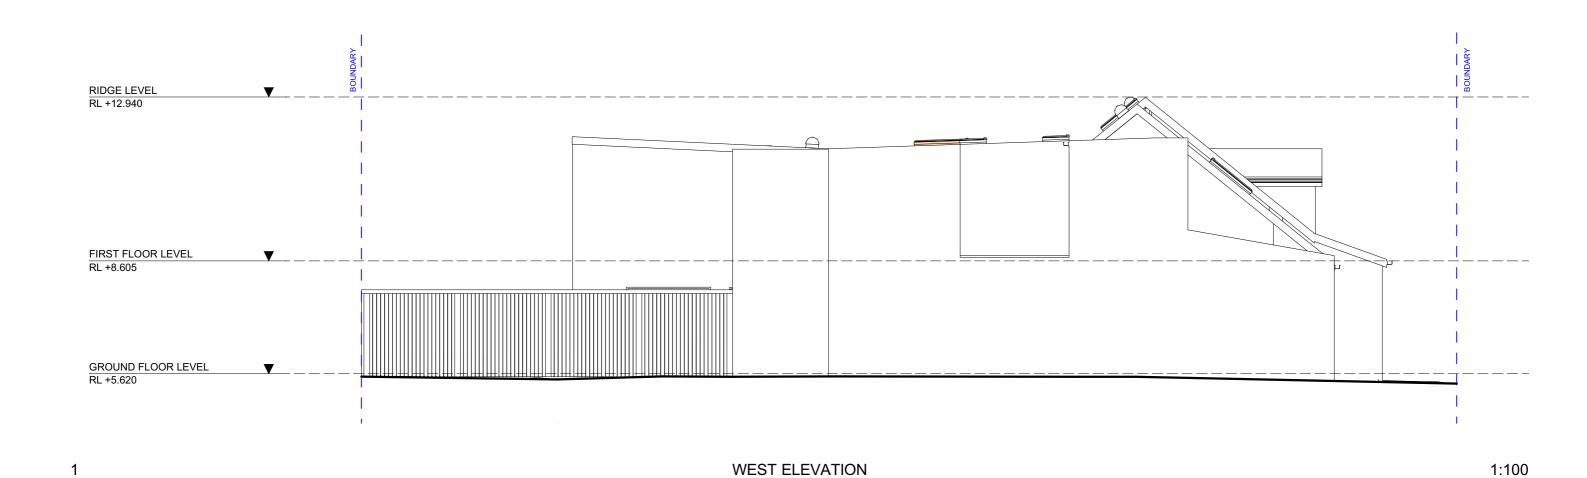
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18-20 DENISON STREET MANLY NSW 2095
2033

DRAWING NO.	DRAWING NAME
DA08	EAST ELEVATION
DATE	

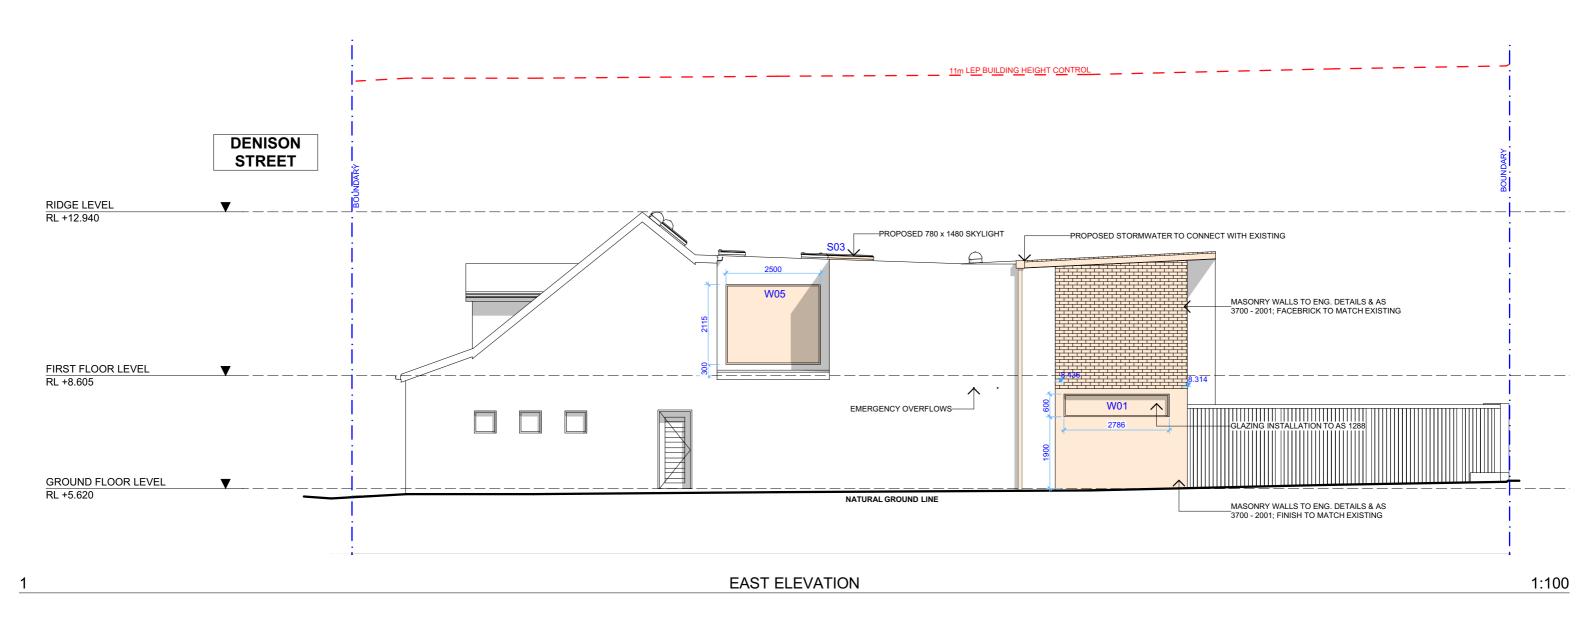AST ELEVATION Monday, 9 December 2019 SCALE 1:100 @A3



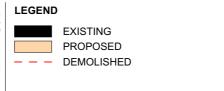

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18-20 DENISON
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2095

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DA09 WEST ELEVATION

DATE

DRAWING NAME


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DATEMonday, 9 December 2019


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18-20 DENISON STREET MANLY NSW

2095

DA10

DRAWING NO.

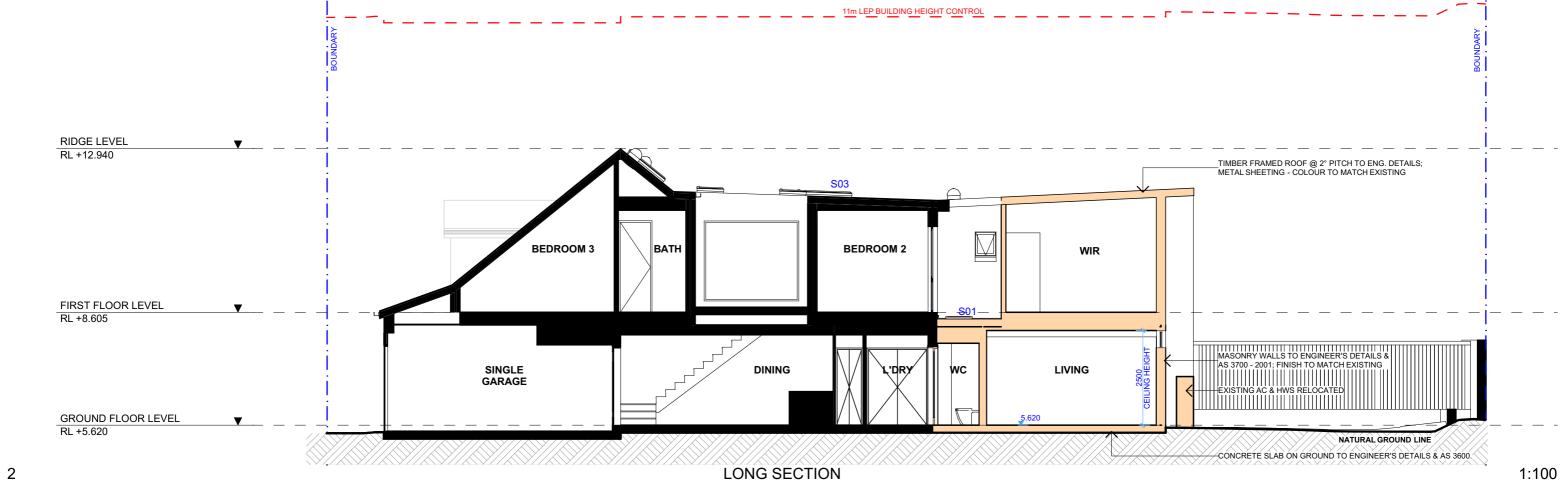
DRAWING NAME LONG / CROSS SECTION

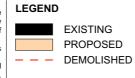DATE

Monday, 9 December 2019


SCALE

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AREA CALCULATIONS EXISTING

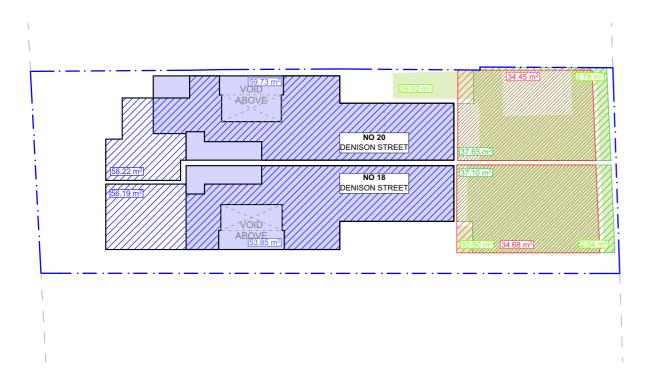AREA CALCULATIONS TABLE SITE AREA EXISTING: 331.4m² **TOTAL OPEN SPACE (TOS)** CONTROL: 50% of site (165.70m²) TOTAL SITE: EXISTING: 37.65m² EXISTING: 37.10m² EXISTING: 22.55% (74.75m²) PROPOSED: UNCHANGED PROPOSED: 36.80m² PROPOSED: 22.46% (74.45m²) LANDSCAPED AREA CONTROL: 30% of TOS (49.71m²) TOTAL SITE: NO 20: EXISTING: 29.70m² EXISTING: <u>35.14m²</u> EXISTING: 39.1% (64.84m²) PROPOSED: UNCHANGED PROPOSED: UNCHANGED PROPOSED: UNCHANGED PRIVATE OPEN SPACE CONTROL: 12m² Per Dwelling NO 20: NO 18: EXISTING: 34.68m² EXISTING: 34.45m² PROPOSED: UNCHANGED PROPOSED: UNCHANGED NO 20: FLOOR SPACE RATIO TOTAL SITE: GROUND FLOOR LEVEL CONTROL: 0.75:1 (248.55m²) EXISTING: 177.88m² PROPOSED: 120.99m² EXISTING: 0.71:1 (227.92m²) NO 18: PROPOSED: 0.74:1 (242.03m²) FLOOR SPACE RATIO EXISTING: 110.04m² FIRST FLOOR LEVEL PROPOSED: 121.04m²



COLORBOND METAL ROOF COLOUR TO MATCH EXISTING

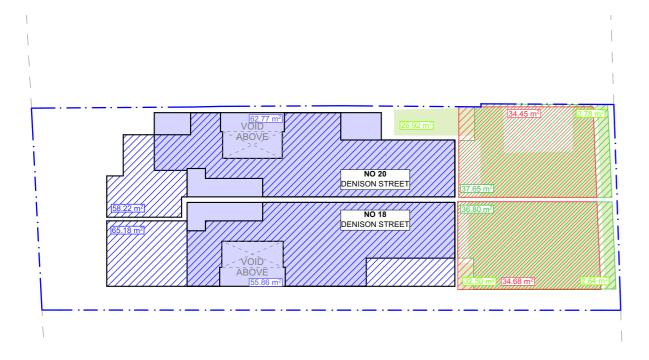FIXED SKYLIGHT WINDOWS BY VELUX



RENDERED BRICK COLOUR TO MATCH EXISTING

AREA CALCULATIONS PROPOSED

3 MATERIAL SAMPLE BOARD

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				are to be used only. The Builder/Contractor shall check and verify all levels an dimensions on site prior to commencement of any worl
				creation of shop drawings, or fabrication of components. All errors and omissions are to be verified by th Builder/Contractor and referred to the designer prior to th
				commencement of works.

LEGEND

1:200

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PROJECT ADDRESS 18-20 DENISON

STREET MANLY NSW 2095

DRAWING NO.


AREA CALCULATIONS / **DA11**


SAMPLE BOARD

DRAWING NAME

DATE Monday, 9 December 2019

SCALE 1:200 @A3

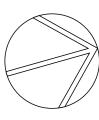


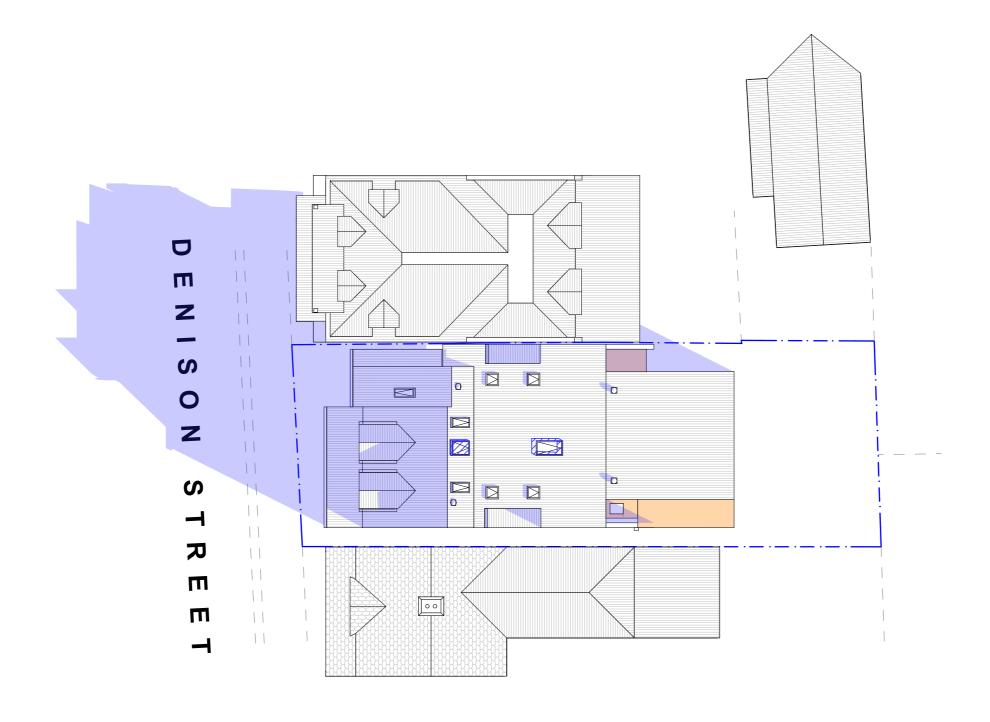

WINTER SOLSTICE 9AM 1:200



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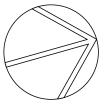
18-20 DENISON STREET MANLY NSW 2095

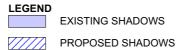
DRAWING NO. **DA12**

WINTER SOLSTICE 9 AM DATE

DRAWING NAME

Monday, 9 December 2019 SCALE 1:200 @A3




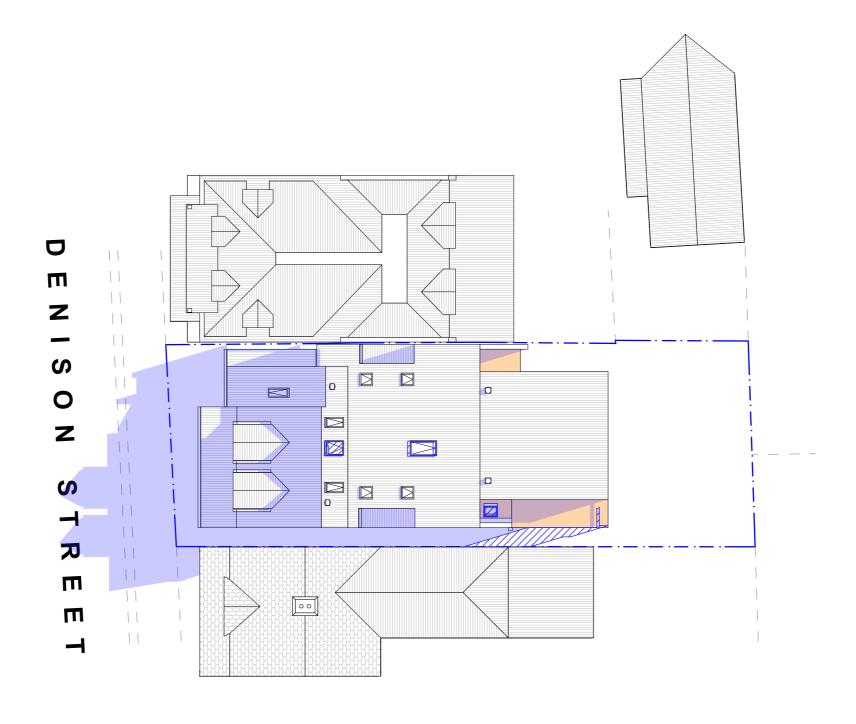

WINTER SOLSTICE 12PM 1:200



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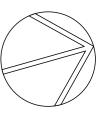
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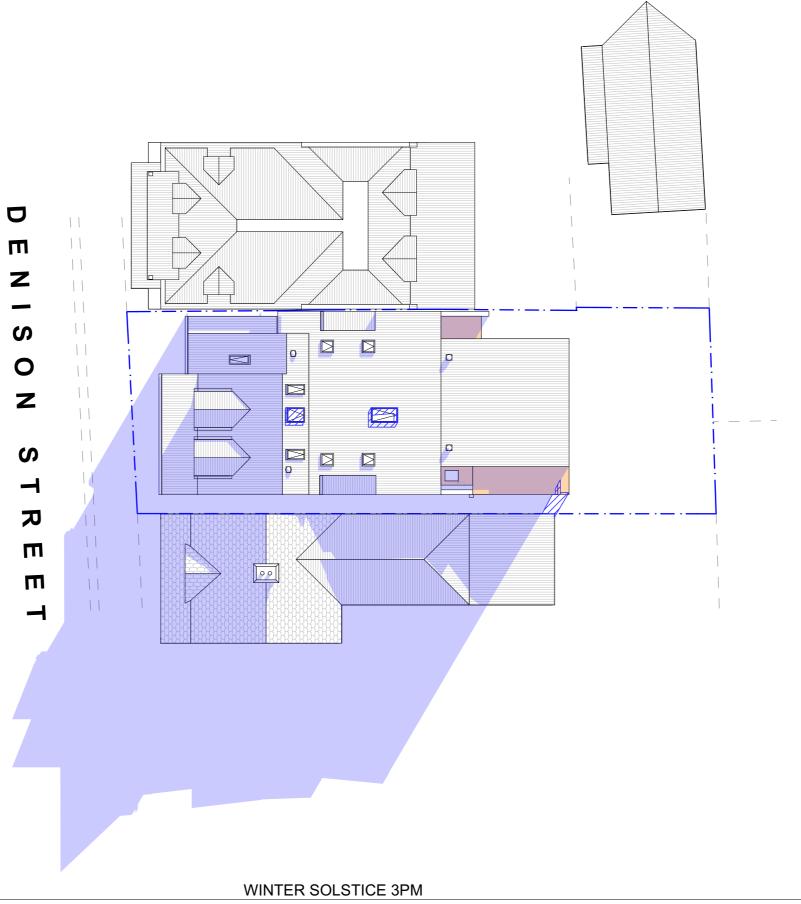
Monday, 9 December 2019

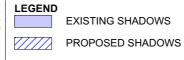WINTER SOLSTICE 12 PM DATE

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EXISTING SHADOWS

ADAM & SABINE MOORE and IAN & PROPOSED SHADOWS RHONDAH MCKELLAR

PROJECT ADDRESS 18-20 DENISON STREET MANLY NSW

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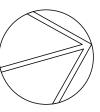
2095

DA14

DRAWING NO.

DATE Monday, 9 December 2019 DRAWING NAME WINTER SOLSTICE 3 PM

SCALE 1:200 @A3



BASIX Certificate

Building Sustainability Index www.basix.nsw.gov.au

Alterations and Additions

Certificate number: A345441_02

This certificate confirms that the proposed development will meet the NSW government's requirements for sustainability, if it is built in accordance with the commitments set out below. Terms used in this certificate, or in the commitments, have the meaning given by the document entitled "BASIX Alterations and Additions Definitions" dated 06/10/2017 published by the Department. This document is available at www.basix.nsw.gov.au

Secretary

Date of issue: Friday, 16, August 2019
To be valid, this certificate must be lodged within 3 months of the date of issue.



Project address ĕ 18-20 DENISON STREET 02 Project name 0 Street address 18-20 DENISON Street MANLY 2095 Local Government Area Northern Beaches Council pr Plan type and number Strata Plan 85482 Lot number N/A of Section number Project type criptio Dwelling type Attached dwelling house Type of alteration and My renovation work is valued at \$50,000 or more, and does not include a pool (and/or spa). addition es

Certificate Prepared by (please complete before submitting to Council or PCA)

Name / Company Name: Action Plans
ABN (if applicable): 17118297587

Windows and glazed doors

The applicant must install the windows, glazed doors and shading devices, in accordance with the specifications listed in the table below. Relevant overshadowing specifications must be satisfied for each window and glazed door.

The following requirements must also be satisfied in relation to each window and glazed door:

Each window or glazed door with standard aluminium or timber frames and single clear or toned glass may either match the description, or, have a U-value and a Solar Heat Gain Coefficient (SHGC) no greater than that listed in the table below. Total system U-values and SHGCs must be calculated in accordance with National Fenestration Rating Council (NFRC) conditions.

For projections described in millimetres, the leading edge of each eave, pergola, verandah, balcony or awning must be no more than 500 mm above the head of the window or glazed door and no more than 2400 mm above the sill.

Pergolas with polycarbonate roof or similar translucent material must have a shading coefficient of less than 0.35.

Pergolas with fixed battens must have battens parallel to the window or glazed door above which they are situated, unless the pergola also shades a perpendicular window. The spacing between battens must not be more than 50 mm.

Overshadowing buildings or vegetation must be of the height and distance from the centre and the base of the window and glazed door, as specified in the 'overshadowing' column in the table below.

Windows and glazed doors glazing requirements

Glazing requirements

Glazing requirements

Skylights

windows and glazed doors glazing requirements								
Window / door			Shading device	Frame and glass type				
no.		glass inc. frame (m2)	Height (m)	Distance (m)				
W01	E	1.67	1.178	1.03	none	standard aluminium, single clear, (or U-value: 7.63, SHGC: 0.75)		
W02	N	0.55	0	0	eave/verandah/pergola/balcony >=750 mm	standard aluminium, single clear, (or U-value: 7.63, SHGC: 0.75)		
W03	N	0.36	0	0	none	standard aluminium, single clear, (or U-value: 7.63, SHGC: 0.75)		
W04	N	1.44	0	0	eave/verandah/pergola/balcony >=750 mm	standard aluminium, single clear, (or U-value: 7.63, SHGC: 0.75)		

Fixtures and systems Lighting The applicant must ensure a minimum of 40% of new or altered light fixtures are fitted with fluorescent, compact fluorescent, or \checkmark \checkmark light-emitting-diode (LED) lamps. Fixtures The applicant must ensure new or altered showerheads have a flow rate no greater than 9 litres per minute or a 3 star water rating. The applicant must ensure new or altered toilets have a flow rate no greater than 4 litres per average flush or a minimum 3 star water rating. The applicant must ensure new or altered taps have a flow rate no greater than 9 litres per minute or minimum 3 star water rating Show on DA Plans Construction Show on CC/CDC Insulation requirements The applicant must construct the new or altered construction (floor(s), walls, and ceilings/roofs) in accordance with the specifications listed in the table below, except that a) additional insulation is not required where the area of new construction is less than 2m2, b) insulation specified is not required for parts of altered construction where insulation already exists. Additional insulation required (R-value) Other specifications concrete slab on ground floor. external wall: brick veneer R1.16 (or R1.70 including construction) external wall: framed (weatherboard, fibro, R1.30 (or R1.70 including construction) metal clad) ceiling: R2.50 (up), roof: foil/sarking flat ceiling, pitched roof medium (solar absorptance 0.475 - 0.70)

I							
The following r	The following requirements must also be satisfied in relation to each skylight: Each skylight may either match the description, or, have a U-value and a Solar Heat Gain Coefficient (SHGC) no greater than that listed in the table below.						
External awnin	gs and louvres must f	fully shade the skylight above which the	y are situated when fully drawn or closed.		,		
Skylights g	Skylights glazing requirements						
Skylight numb	er Area of glazing inc. frame (m2)	Shading device	Frame and glass type				
S1	0.38	no shading	aluminium, moulded plastic single clear, (or U-value: 6.21, SHGC: 0.808)				
S2	0.92	external fixed awning or blind	aluminium, moulded plastic single clear, (or U-value: 6.21, SHGC: 0.808)				
S3	1.09	external fixed awning or blind	aluminium, moulded plastic single clear, (or U-value: 6.21, SHGC: 0.808)				

NOTE: All window & door dimensions, orientation, glazing materials, opening types, frame types are to be confirmed by a suitably qualified person prior to the ordering of any such materials are to take place.

U value takes precedence over glazing type/colour in all cases.

All new glazing must meet the BASIX specified frame and glass type, OR meet the specified U value and SHGC value.

M: 0426 957 518
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				person prior to the ordering of any such materials are to take place. U value takes precedence over glazing type/colour in all cases.
				all new glazing must meet the BASIX specified frame and glass type, <u>QR</u> meet the ecified U value and SHGC value.

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The applicant must install the skylights in accordance with the specifications listed in the table below.

ADAM & SABINE MOORE and IAN & RHONDAH MCKELLAR PROJECT ADDRESS

PROJECT ADDRESS 18-20 DENISON STREET MANLY NSW DRAWING NO.

DA15

DRAWING NAMEBASIX COMMITMENTS

Show on CC/CDC

DATE
Monday, 9 December 2019