CHECK ALL DIMENSIONS PRIOR TO COMMENCEMENT OF WORKS FIGURED DIMENSIONS TO BE TAKEN IN PREFERENCE TO SCALE CONFIRM ALL DIMENSIONS ON SITE

#### GENERAL NOTES;

1 THESE DRAWINGS SHOULD BE READ IN CONJUNCTION WITH THE MANUFACTUERS SPECIFICATION AND OTHER INSTRUCTIONS THAT SHOULD BE ISSUED DURING THE COURSE OF CONSTRUCTION

2 DATUM ASSUMED (AUSTRALIAN HEIGHT DATUM) ALL LEVELS TAKEN FROM INFORMATION SUPPLIED BY GEMS ONLINE MAPPING SERVICE

3 BOUNDARY DIMENSIONS IN DP 1032966 HAVE BEEN ADOPTED THE BOUNDARIES HAVE NOT BE REDEFINED

4 IT IS RECOMMENDED TO USE "DIAL BEFORE YOU DIG" SERVICE BEFORE ANY EXCAVATION

5 THE STORMWATER IS TO BE CONNECTED TO THE MAIN RESIDENCES EXISTING STORMWATER

ROOFING & RAIN WATER

1 ALL ROOFING TO BE FIXED IN ACCORDANCE WITH MANUFACTUERS SPECIFICATIONS STORMWATER TO BE CONVEYED BY MEANS OF SEALED PVC PIPE

SITE COVERAGE: EXISTING RESIDENCE: 233m2


PROPOSED AWNING: m2

TOTAL AREA m2

FLOOR SPACE RATIO :1

#### NOTES:

All work to be carried out strictly in accordance with the BCA, Australian standards and all relevant Statutory Authorities All levels, dimensions, areas etc to be verified by the builder prior to preparation of any contracts and the commencement of any building works. Any discrepancies are to be brought to the attention of the owner prior to commencement of any building works. Where engineering details are required they take preference over these drawings. Levels shown are approximate and may vary plus or minus 200mm Do not scale this drawing use figured dimensions. All boundary clearances to be verified by registered surveyor Stormwafer to be discharged to Local Authority Regulations and guidelines. All existing services to be located by builder prior to commencement of any building works.

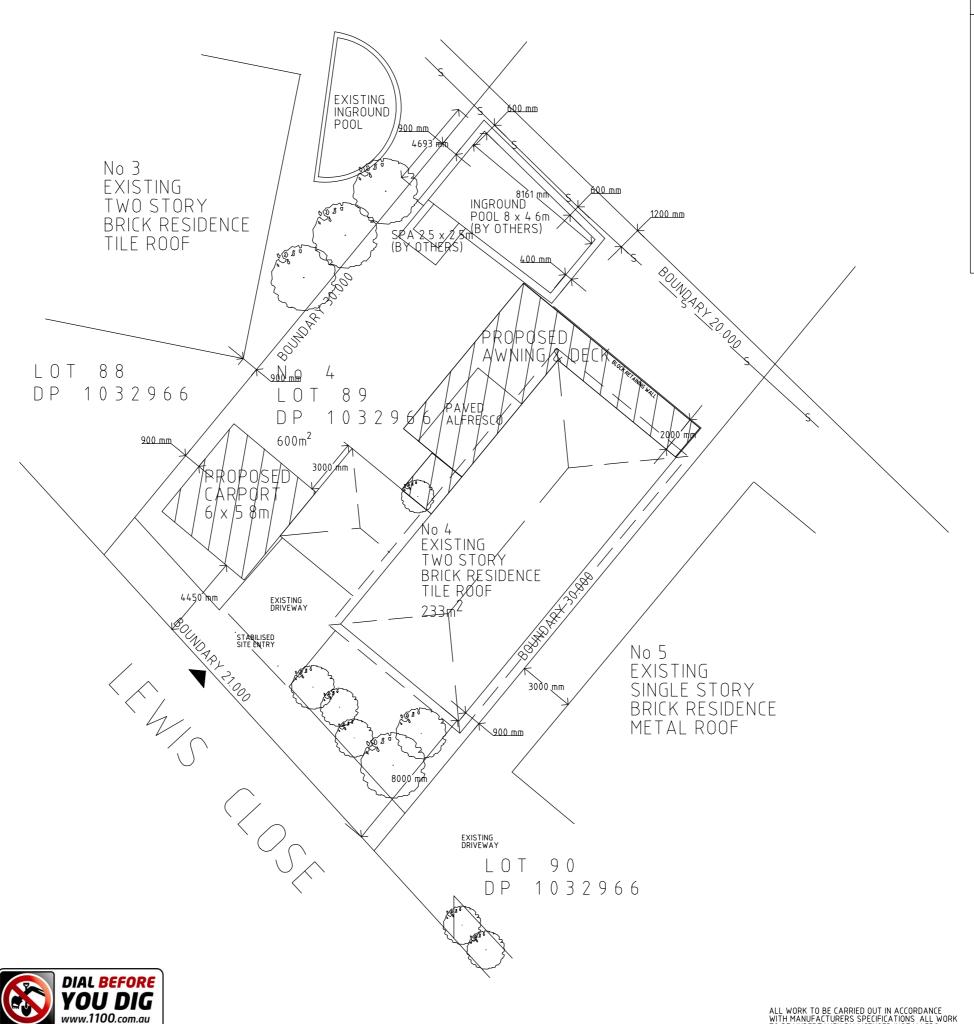





VEHICULAR & PEDESTRIAN SITE ACCESS



PROPOSED AWNINGS



**EXISTING TREES** 




PROPOSED STORMWATER



STABILISED SITE ENTRY



SEWER LINE

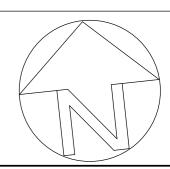

# PROJECT

PROPOSED SKYVIEW AWNING

# CLIENT

M Peralta Revilla & T De Arauj

# ADDRESS

No 4 LEWIS CLOSE WARRIEWOOD, NSW 2102

### LOT/DP No

LOT 89 DEPOSIT PLAN 1032966



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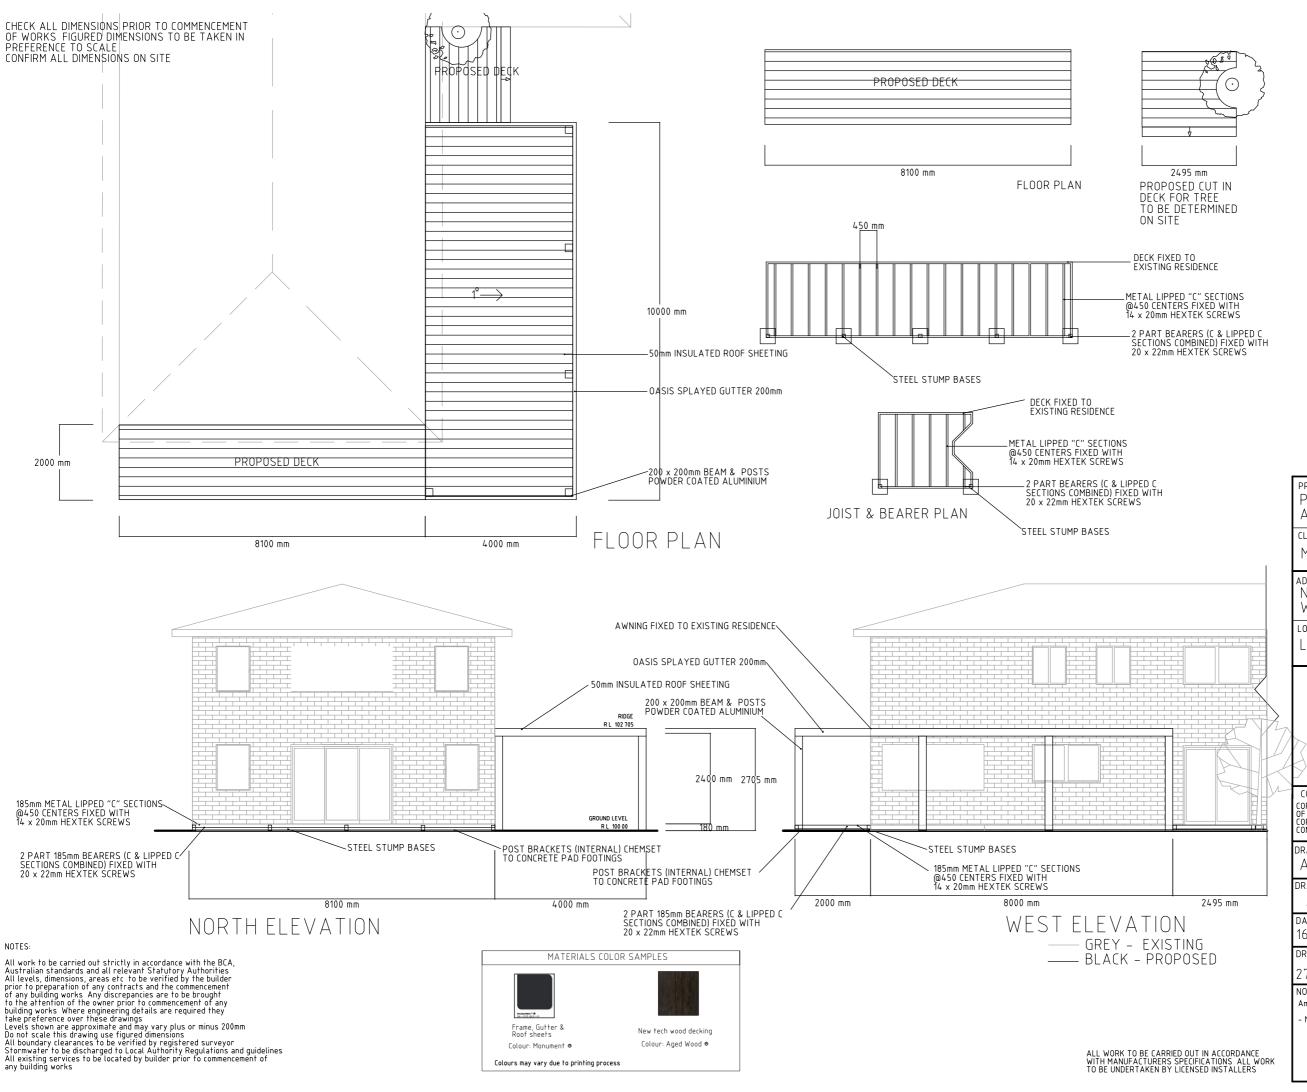
# DRAWING TITLE

SITE PLAN

DRAWN BY  JTP	CHECKED	SCALE 1:200	SHEET SIZE A3
DATE 16/08/2	REVISION		
DRAWING No			SHEET
27102020 - 01			1 OF 3

NOTES:

ALL WORK TO BE CARRIED OUT IN ACCORDANCE WITH MANUFACTURERS SPECIFICATIONS ALL WORK TO BE UNDERTAKEN BY LICENSED INSTALLERS



SPECIFICATION & CONSTRUCTION NOTES;

FOOTING DETAILS; 300x300x500mm CONCRETE FOOTINGS 60mm CORBEL

BEAM TYPE COLUMN SIZE

200mm ALUMINIUM 200 x 200mm ALUMINIUM

ROOFING & RAIN WATER

ALL ROOF TO BE FIXED IN ACCORDANCE WITH MANUFACTURERS SPECIFICATIONS STORMWATER TO BE CONVEYED BY MEANS OF SEALED PVC PIPE

ROOF SHEETING BARGE CAPPING RIDGE CAPPING GUTTER DOWN PIPES

50mm Insulated sheeting 0 55 moulded flashing 0 55 moulded flashing OUTBACK GUTTER 65MM PVC

GUTTERING AND DOWNPIPE INSTALLATION TO COMPLY WITH THE BUILDING CODE OF AUSTRALIA AND AUSTRALIAN STANDARDS AS/NZS 3500 3 PLUMBING AND DRAINAGE, STORMWATER DRAINAGE AND AS/NZS 3500 3 NATIONAL PLUMBING AND DRAINAGE DOMESTIC INSTALLATIONS

PROPOSED CARPORT & AWNING/DECK

CLIENT

M Peralta Revilla & T De Arauj

ADDRESS

No 4 LEWIS CLOSE WARRIEWOOD, NSW 2102

OT/DP N

LOT 89 DEPOSIT PLAN 1032966



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### RAWING TITLE


AWNING PLAN & ELEVATIONS


JTP	CHECKED	1:100	A3
DATE 16/08/2	REVISION		
DRAWING N	SHEET		
2710202	3 OF 3		

### NOTES:

Amended Plan- 16/08/2021

- Material colour samples added

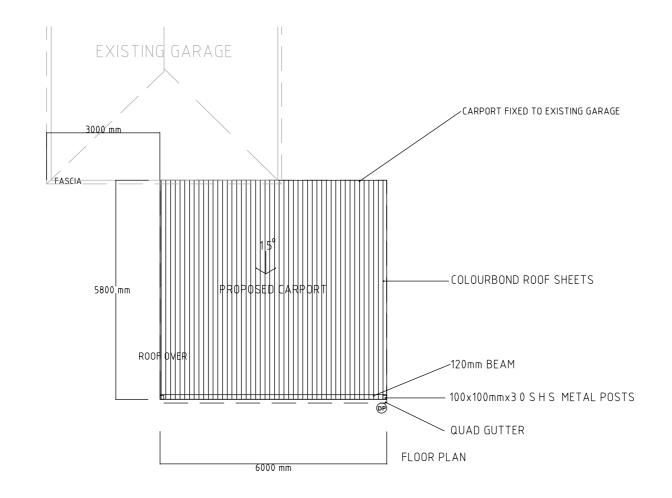

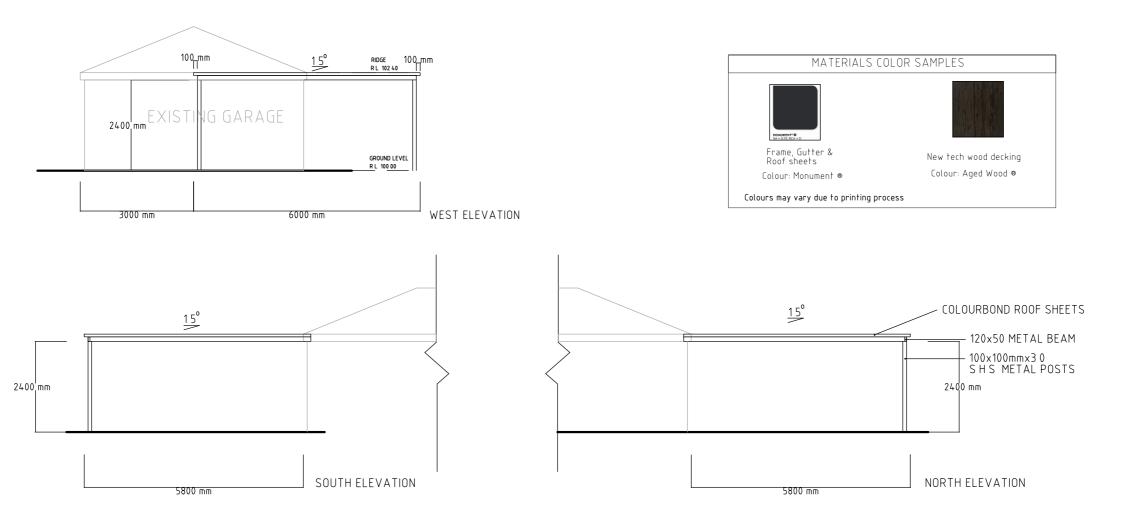

CHECK ALL DIMENSIONS PRIOR TO COMMENCEMENT OF WORKS FIGURED DIMENSIONS TO BE TAKEN IN PREFERENCE TO SCALE CONFIRM ALL DIMENSIONS ON SITE

ALL WORK TO BE CARRIED OUT IN ACCORDANCE WITH MANUFACTURERS SPECIFICATIONS ALL WORK TO BE UNDERTAKEN BY LICENSED INSTALLERS

SPECIFICATION & CONSTRUCTION NOTES;

FOOTING DETAILS; 300x300x500mm CONCRETE FOOTINGS 60mm CORBEL

BEAM TYPE 120mm OUTBACK COLUMN SIZE 100 X 100 X3 0mm SHS HEADER BEAM 150mm OUTBACK

ROOFING & RAIN WATER

ALL ROOF TO BE FIXED IN ACCORDANCE WITH MANUFACTURERS SPECIFICATIONS STORMWATER TO BE CONVEYED BY MEANS OF SEALED PVC PIPE

ROOF SHEETING
BARGE CAPPING
RIDGE CAPPING
GUTTER
DOWN PIPES

OUTBACK DECK
0 55 moulded flashing
0 55 moulded flashing
0 UTBACK GUTTER
65MM PVC

GUTTERING AND DOWNPIPE INSTALLATION TO COMPLY WITH THE BUILDING CODE OF AUSTRALIA AND AUSTRALIAN STANDARDS AS/NZS 3500 3 PLUMBING AND DRAINAGE, STORMWATER DRAINAGE AND AS/NZS 3500 3 NATIONAL PLUMBING AND DRAINAGE DOMESTIC INSTALLATIONS

PROPOSED CARPORT & AWNING/DECK

CLIENT

M Peralta Revilla & T De Arauj

\nnpecc

No 4 LEWIS CLOSE WARRIEWOOD, NSW 2102

OT/DP No

LOT 89 DEPOSIT PLAN 1032966



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# DRAWING TITLE

CARPORT PLAN & ELEVATIONS

DRAWN BY	CHECKED	SCALE	SHEET SIZE	
JTP		1:100	Α3	
DATE 16/08/2	REVISION			
DRAWING No			SHEET	
27102020 - 02			2 OF 3	

## NOTES:

Amended Plan- 16/08/2021

- Material colour samples added